




ST. ALOYSIUS CATHOLIC ELEMENTARY SCHOOL ADDITION

504 CONNAUGHT STREET, KITCHENER, ON.



**Waterloo Catholic
District School Board**
Quality, Inclusive, Faith Based Education

**GRGURIC
ARCHITECTS
INCORPORATED**

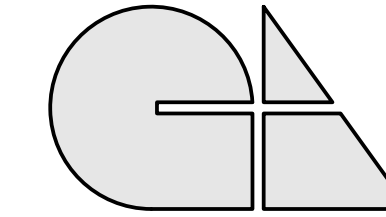

28 KING STREET EAST, UNIT B
STONEY CREEK, ONTARIO, L8G 1J8
Tel. 905-664-8735 Fax. 905-664-8737
Web: www.2gai.com

EXP Services Inc.

t: 905.525.6068 | f: 905.526.7310
1266 South Service Road,
Suite C1-1, Stoney Creek,
ON, L8E 5R9
Canada

www.exp.com




• BUILDINGS • EARTH & ENVIRONMENT • ENERGY •
• INDUSTRIAL • INFRASTRUCTURE • SUSTAINABILITY •

DFE

DOYCH & FILO ENGINEERING INC.
Structural Engineers

Phones: (647) 836-4805 ; (905) 719-1482

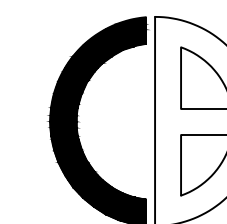

**J.H. COHOON
ENGINEERING
LIMITED**
CONSULTING ENGINEERS

440 HARDY ROAD, UNIT #1, BRANTFORD - ONTARIO, N3T 5L8
TEL. (519) 753-2656 FAX. (519) 753-4263 www.cohooneng.com

DRAWING LIST:

ARCHITECTURAL, CIVIL & LANDSCAPE

A 0.00	COVER SHEET
A 0.10	OBC MATRIX, FIRE & LIFE SAFETY PLANS
34277-25	LEGAL SURVEY
17488-1	GRADING PLAN
17488-2	SERVICING PLAN
17488-3	EROSION SEDIMENT CONTROL PLAN
17488-4	EXISTING CONDITIONS & REMOVALS PLAN
A 1.00	SITE PLAN
A 1.10	SITE DETAILS
A 1.20	LANDSCAPE & TREE MANAGEMENT PLAN
A 2.00	PARTIAL GROUND FLOOR PLAN ADDITION
A 2.10	SECOND FLOOR PLAN ADDITION
A 2.20	PARTIAL ROOF PLAN ADDITION
A 2.30	PARTIAL GROUND FLOOR REFLECTED CEILING PLAN
A 2.40	SECOND FLOOR REFLECTED CEILING PLAN
A 3.00	BUILDING ELEVATIONS
A 4.00	BUILDING SECTIONS
A 4.10	WALL SECTIONS
A 4.20	WALL SECTION DETAILS
A 4.30	WALL SECTIONS
A 5.00	STAIR SECTIONS
A 5.10	STAIR PLANS & DETAILS
A 5.20	ELEVATOR & ROOF LADDER DETAILS
A 5.30	EXTERIOR STAIR & RAMP DETAILS
A 6.00	PLAN DETAILS
A 7.00	DOOR, WINDOW & ROOM FINISH SCHEDULES
A 8.00	ENLARGED WASHROOM PLANS & INTERIOR ELEVATIONS

STRUCTURAL

S 0.0	GENERAL NOTES
S 0.1	GENERAL NOTES
S 0.2	TYPICAL DETAILS
S 0.3	TYPICAL DETAILS
S 1.0	FOUNDATION PLAN AND SECTIONS
S 1.1	FOUNDATION, STAIR & RAMP DETAILS
S 2.0	SECOND FLOOR FRAMING PLAN, SCHEDULES AND DETAILS
S 3.0	ROOF FRAMING PLAN, SCHEDULES AND DETAILS

MECHANICAL

M1.00	MECHANICAL SITE PLAN, KEY PLAN AND DRAWING LIST
M1.01	MECHANICAL LEGEND AND ROOM INDEX
M2.00	UNDERGROUND PLUMBING PLAN
M2.01	GROUND FLOOR PLUMBING PLAN
M2.02	SECOND FLOOR PLUMBING PLAN
M3.00	GROUND FLOOR HVAC PLAN
M3.01	SECOND FLOOR HVAC PLAN
M3.02	MECHANICAL ROOF PLAN
M4.00	GROUND FLOOR HYDRONIC HEATING PLAN
M4.01	SECOND FLOOR HYDRONIC HEATING PLAN
M5.00	GROUND FLOOR FIRE PROTECTION PLAN
M5.01	SECOND FLOOR FIRE PROTECTION PLAN
M6.00	DOMESTIC WATER PLUMBING SCHEMATIC
M6.01	HOT WATER HEATING AND DOMESTIC HOT WATER SCHEMATICS
M6.02	SPRINKLER SCHEMATIC
M7.00	MECHANICAL DETAILS
M7.01	MECHANICAL DETAILS
M7.02	MECHANICAL DETAILS
M8.00	MECHANICAL SCHEDULES
ME-1.0	MECHANICAL AND ELECTRICAL SCHEDULES

ELECTRICAL

E0.01	LEGEND, DRAWING LIST & GENERAL NOTES
E1.01	DEMOLITION ELECTRICAL SITE PLAN
E1.02	PROPOSED ELECTRICAL SITE PLAN
E1.03	SITE PLAN ELECTRICAL DETAILS
E2.01	GROUND FLOOR & EXTERIOR - EXISTING & DEMOLITION PLANS
E3.01	GROUND FLOOR - PROPOSED CONDUIT RUN
E4.01	PARTIAL GROUND FLOOR PLAN ADDITION - LIGHTING PLAN
E4.02	PARTIAL SECOND FLOOR PLAN ADDITION - LIGHTING PLAN
E5.01	PARTIAL GROUND FLOOR PLAN ADDITION - POWER & SYSTEMS PLAN (1 OF 2)
E5.02	PARTIAL GROUND FLOOR PLAN ADDITION - POWER & SYSTEMS PLAN (2 OF 2)
E5.03	PARTIAL SECOND FLOOR PLAN ADDITION - POWER & SYSTEMS PLAN
E5.04	PARTIAL ROOF PLAN ADDITION - POWER & SYSTEMS
E6.01	FIRE ALARM ZONING PLAN
E7.01	DEMO & PROPOSED SINGLE LINE DIAGRAM
E8.01	ELECTRICAL SCHEDULES & DETAILS
E9.01	PANEL SCHEDULES

ISSUED FOR TENDER

2026-03-20

PROJECT NUMBER

2025-06

SHEET NUMBER

A 0.00

CALL BEFORE YOU DIG

THE LOCATION OF SERVICES ON THIS DRAWING ARE ONLY APPROXIMATE AND BASED ON SURFACE FEATURES LOCATED AT THE TIME OF THE TOPOGRAPHIC SURVEY. PRIOR TO ANY CONSTRUCTION IT IS THE RESPONSIBILITY OF THE CONTRACTOR/BUILDER TO ENSURE THE EXACT LOCATION OF ALL UTILITIES.

BENCHMARK:

ELEVATIONS ARE BASED ON GPS OBSERVATIONS TO PERMANENT REFERENCE STATIONS IN THE NAD83 (CSRS-2010) COORDINATE SYSTEM AND HAVE BEEN CORRECTED TO ORTHOMETRIC ELEVATIONS ON THE CGVD28 DATUM (1978 ADJUSTMENT) WITH GEOID MODEL HTV2.0, AS SUPPLIED BY NATURAL RESOURCES CANADA.

SITE BM1: CUT CROSS IN CURB ON THE SOUTH SIDE OF CONNAUGHT STREET, SOUTH OF THE SOUTH EAST CORNER OF THE SUBJECT PROPERTY, WITH AN ELEVATION OF 327.13 METRES.

SITE BM2: NAIL IN THE ASPHALT OF A WALKWAY ALONG THE EAST SIDE OF THE SUBJECT PROPERTY, NEAR THE NORTH EAST CORNER OF THE SUBJECT PROPERTY, WITH AN ELEVATION OF 327.15 METRES.

METRIC:

DISTANCES ON THIS PLAN ARE MEASURED IN METRES AND CAN BE CONVERTED TO FEET BY DIVIDING BY 0.3048.

NOTES:

- BEARINGS ARE GRID BEARINGS AND ARE DERIVED FROM GNSS OBSERVATIONS AND ARE REFERRED TO THE UTM PROJECTION, ZONE 17. NAD 83-CSR5 (2010) ADJUSTMENT.
- DISTANCES SHOWN ON THE PLAN ARE ADJUSTED GROUND DISTANCES AND CAN BE CONVERTED TO UTM GRID DISTANCES BY MULTIPLYING BY AN AVERAGED COMBINED SCALE FACTOR OF 0.999579.
- THE ORIGINAL VERSION OF THIS PLAN WAS PREPARED IN COLOUR.

BEARING COMPARISONS:

FOR THE PURPOSES OF BEARING COMPARISONS, PREVIOUS SURVEYS HAVE BEEN ROTATED TO UTM BEARINGS BY THE ANGLES SHOWN BELOW.

PLAN	ROTATION FOR NORTHEAST BEARINGS
P2	+0°28'30"
P3, P4	-0°22'40"

SUMMARY REPORT

CLIENT:

THIS PLAN WAS PREPARED FOR THE WATERLOO CATHOLIC DISTRICT SCHOOL BOARD AND THE UNDERSIGNED ACCEPTS NO RESPONSIBILITY FOR USE BY OTHER PARTIES.

DESCRIPTION OF LAND:

ALL OF PIN 22590-0020 (LT)
ALL OF LOTS 178, 179, 180, 181,
& PART OF LOT 182, REGISTERED PLAN 254
GEOGRAPHIC TOWNSHIP OF WATERLOO
& ALL OF BLOCK K, REGISTERED PLAN 1383
CITY OF KITCHENER, REGIONAL MUNICIPALITY OF WATERLOO
AREA = 2.085 Ha.

REGISTERED EASEMENTS AND/OR RIGHTS-OF-WAY:

NONE FOUND IN REGISTRY OFFICE

BOUNDARY FEATURES:

A BUS STOP OCCUPYING PART 1 OF PLAN 588-18206 IS LOCATED ON THE SUBJECT PROPERTY ALONG CONNAUGHT STREET BY THE AMOUNT SHOWN ON THE FACE OF THE PLAN.

COMPLIANCE WITH MUNICIPAL ZONING BY-LAWS:
NOT CERTIFIED BY THIS REPORT

**PLAN OF SURVEY OF
ALL OF LOTS 178, 179, 180, 181,
PART OF LOT 182
REGISTERED PLAN 254
GEOGRAPHIC TOWNSHIP OF WATERLOO
ALL OF BLOCK K,
REGISTERED PLAN 1383
CITY OF KITCHENER
REGIONAL MUNICIPALITY OF WATERLOO**

SCALE 1 : 300

0 5 10 15 metres

VAN HARTEN SURVEYING INC.

THE INTENDED PLOT SIZE OF THIS PLAN IS 915mm IN WIDTH BY 610mm IN HEIGHT WHEN PLOTTED AT A SCALE OF 1:300

LEGEND:

- SURVEY MONUMENT SET
- SURVEY MONUMENT FOUND
- SIB .025 X .025 X 1.20 STANDARD IRON BAR
- IB .015 X .015 X 0.60 IRON BAR
- SSIB .025 X .025 X 0.60 SHORT STANDARD IRON BAR
- CC CUT CROSS
- CM CONCRETE MONUMENT
- OU ORIGINAL UNKNOWN
- VH VAN HARTEN SURVEYING INC., O.L.S.'S
- AGI AUER CAMPBELL & SERAK LTD., O.L.S.'S
- B17 BERT J. ROE, O.L.S.
- L114 METZ & LORENTZ LTD., O.L.S.'S
- L348 WAINIE D. TURFEL, O.L.S.
- N.E.S.W. NORTH, EAST, SOUTH, WEST
- P1 DEPOSITED PLAN 588-18206
- P2 WATERLOO STANDARD CONDOMINIUM PLAN 493
- P3 REGISTERED PLAN 1383
- P4 SURVEY BY 1114, FILE NO. K1-122-30, DATED NOV. 9, 1981
- FIBRE OPTICS
- UNDERGROUND CABLE
- UNDERGROUND TEL
- GAS LINE
- SANITARY SEWER
- WATERMAIN
- STORM SEWER
- OVERHEAD HYDRO
- UNDERGROUND HYDRO
- FENCELINE
- DITCH/SWALE
- CENTRELINE OF ROAD
- EDGE OF BUSH
- TOP OF BANK
- FINISHED FLOOR ELEVATION F.F.=206.33
- EXISTING ELEVATION x206.55
- BELL PEDESTAL
- UTILITY POLE
- HYDRO POLE
- GUY WIRE
- LIGHT STANDARD
- HYDRO METER
- HYDRO VAULT
- CATCHBASIN
- MANHOLE
- DECIDUOUS TREE
- CONCRETE
- GRAVEL
- BELL
- UP
- HP
- GUY
- LS
- HM
- VAULT
- LS
- MH
- CONIFEROUS TREE
- ASPHALT
- TV PEDESTAL
- BOLLARD
- FIRE HYDRANT
- WATER VALVE
- GATE
- SIGN
- GAS VALVE
- GAS METER
- SAMPLING
- SAPC or SAPD

SURVEYOR'S CERTIFICATE

I CERTIFY THAT:
1. THIS SURVEY AND PLAN ARE CORRECT AND IN ACCORDANCE WITH THE SURVEYS ACT, THE SURVEYORS ACT AND THE REGULATIONS MADE UNDER THEM.
2. THIS SURVEY WAS COMPLETED ON THE 17th OF APRIL, 2025

DATE: MAY 13, 2025

MACKENZIE STREUTKER
ONTARIO LAND SURVEYOR

THIS PLAN OF SURVEY RELATES TO AOLS PLAN SUBMISSION NUMBER V-99387.




Kitchener/Waterloo Ph: 519-742-8371 Guelph Ph: 519-821-2763 Orangeville Ph: 519-940-4110

www.vanharten.com info@vanharten.com


DRAWN BY: SS CHECKED BY: MS PROJECT No. 34277-25
May 13, 2025-1:15:37 PM
M:\Geographic\KW\Kitchener\1383\ACAD\SRP-TOPO LOT 178-182 (34277-25)
UTM 2010.0mgs

© 2025, VAN HARTEN SURVEYING INC. NO PERSON MAY COPY, REPRODUCE, DISTRIBUTE OR ALTER THIS PLAN IN WHOLE OR IN PART WITHOUT THE WRITTEN PERMISSION OF VAN HARTEN SURVEYING INC.



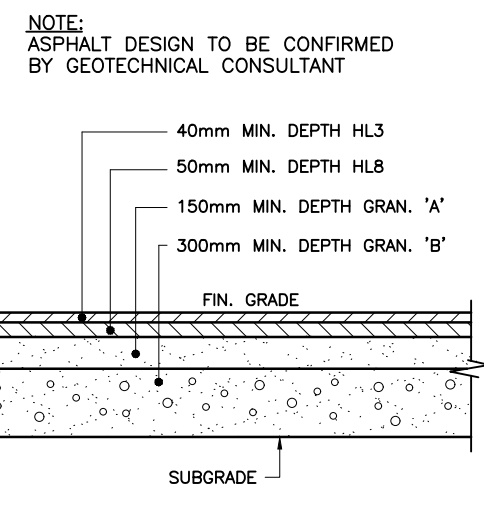




TYPICAL ASPHALT DESIGN
N.T.S.

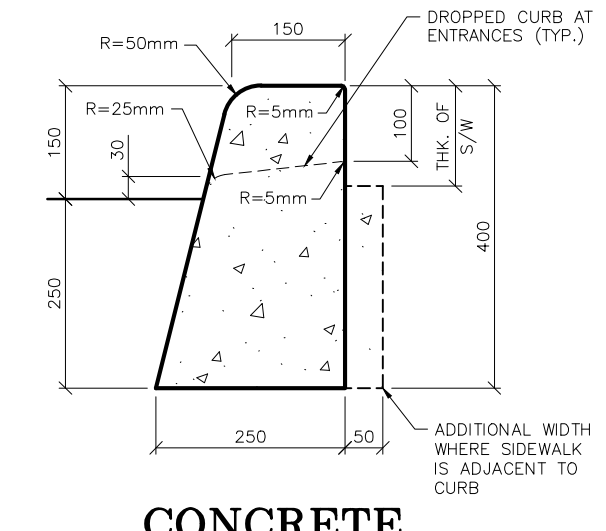

CONCRETE BARRIER CURB
O.P.S.D. - 600.110
N.T.S.

GENERAL NOTES:

- ALL ELEVATIONS SHOWN IN METRIC.
- BUILDER/OWNER TO VERIFY COMPLIANCE WITH ZONING BYLAWS (i.e. SIDEYARDS, SETBACKS, REARYARDS ETC.)
- BUILDER TO VERIFY SERVICE AT THE PROPERTY LINE WILL ACCOMMODATE U/S OF FOOTING.
- THE PROPERTY OWNER IS RESPONSIBLE FOR RESTORATION OF ALL DAMAGED AND/OR DISTURBED PROPERTY WITHIN THE MUNICIPAL RIGHT-OF-WAY TO CITY OF KITCHENER STANDARDS.
- IF, FOR UNFORESEEN REASON, THE OWNER AND/OR HIS/HER REPRESENTATIVE MUST ENCRUCH ONTO PRIVATE LAND TO UNDERTAKE ANY WORKS, HE/SHE MUST OBTAIN WRITTEN PERMISSION FROM THE ADJACENT PROPERTY OWNERS PRIOR TO ENTERING UPON THE PRIVATE PROPERTY TO PERFORM ANY WORKS. COPIES OF THESE LETTERS OF CONSENT MUST BE SUBMITTED TO THE DEVELOPMENT & TECHNICAL SERVICES-ENGINEERING DEVELOPMENT DIVISION, PRIOR TO ANY WORK BEING PERFORMED. FAILURE TO COMPLY WITH THE ABOVE IS AT THE PROPERTY OWNERS OWN RISK.
- THIS PLAN TO BE READ IN CONJUNCTION WITH THE SERVICING PLAN & SEDIMENT EROSION CONTROL PLAN.

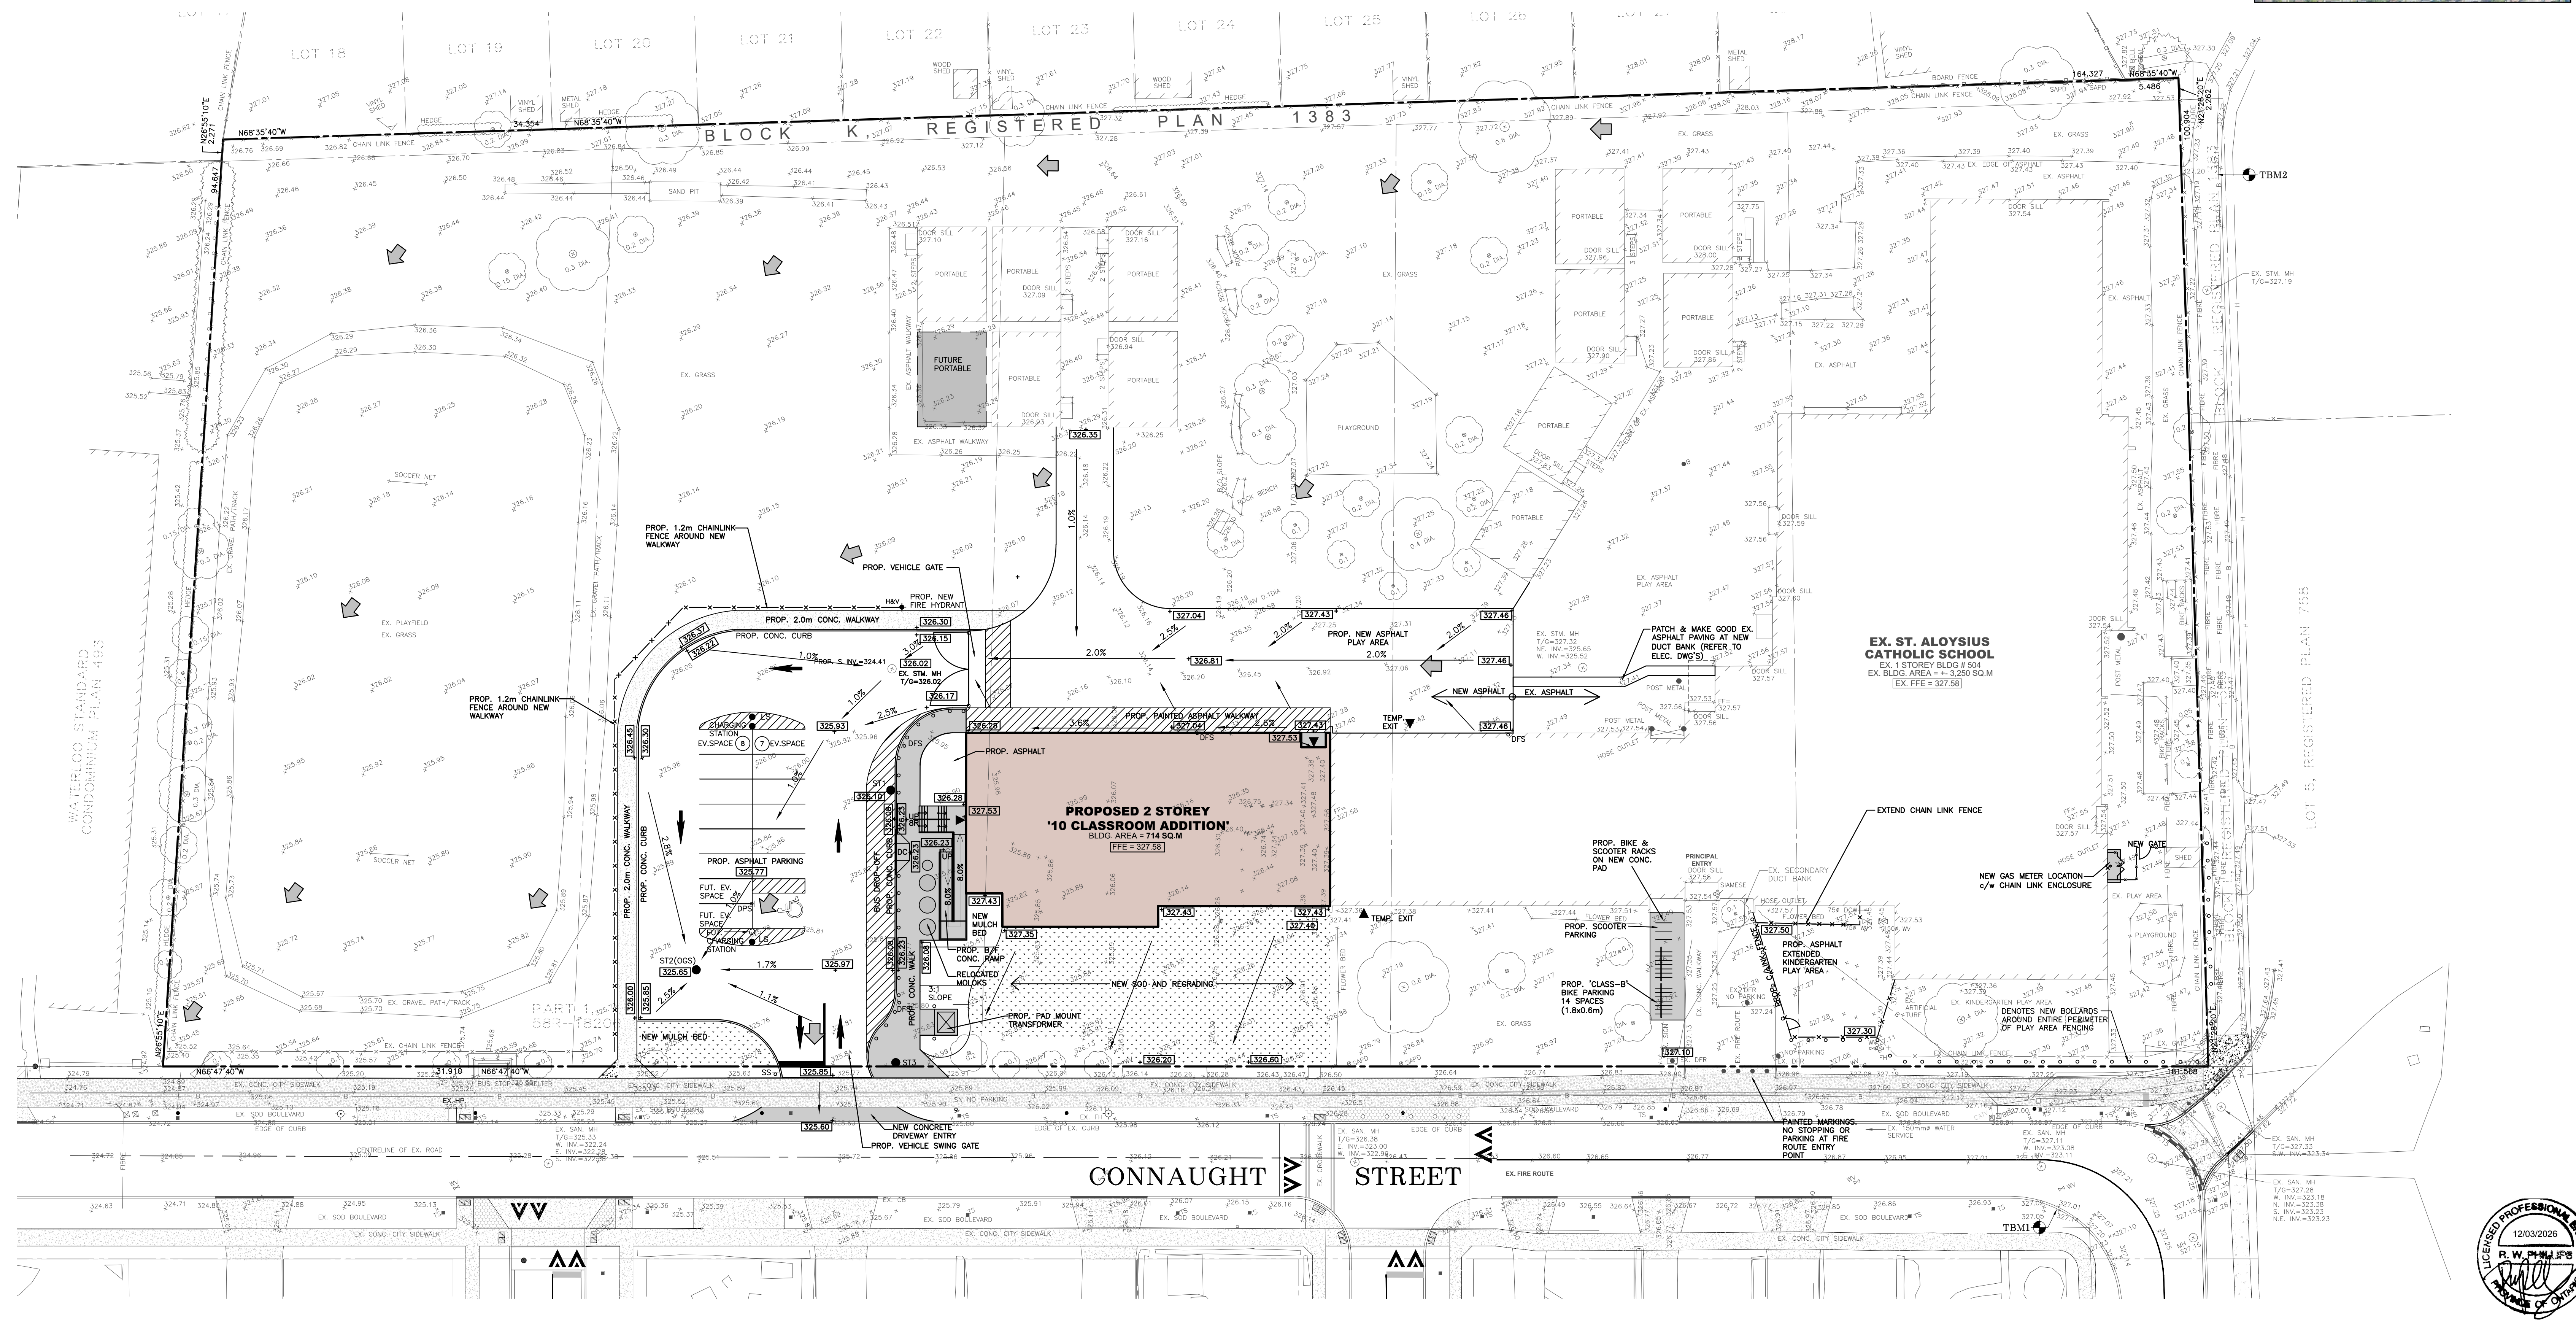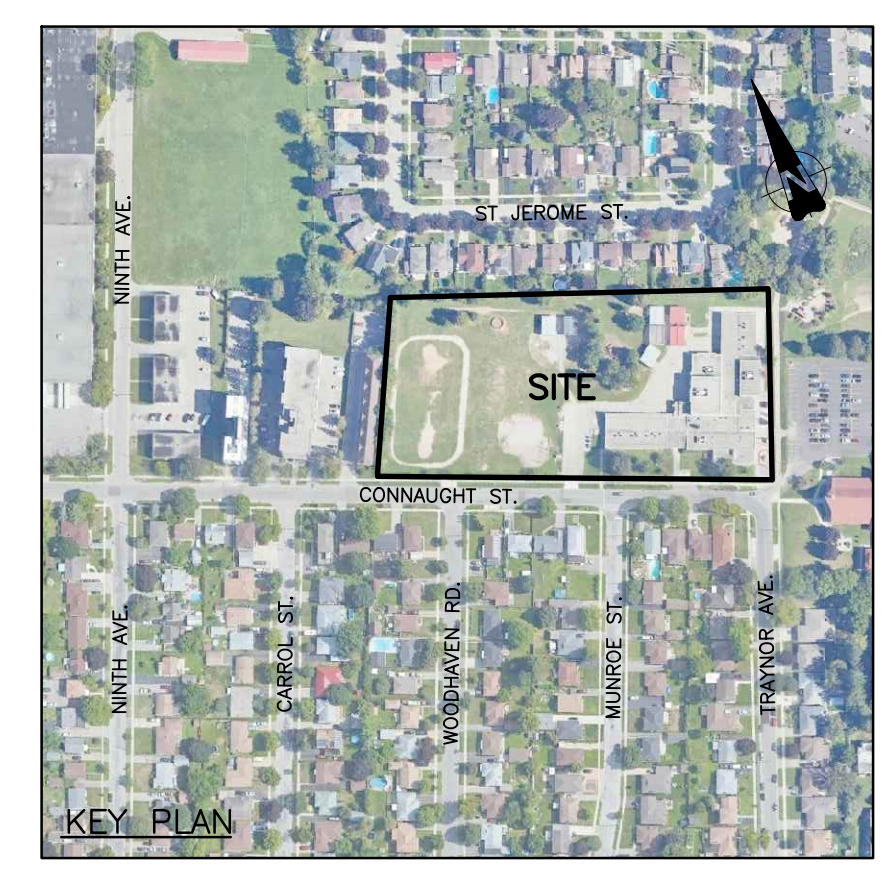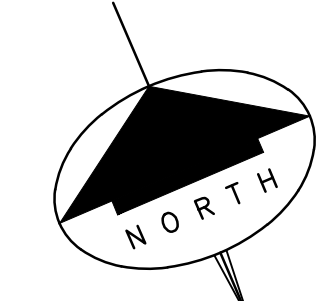

LEGEND:

	EXISTING ELEVATIONS
	PROPOSED ELEVATIONS
	PROPOSED SWALE ELEVATIONS
	PROPOSED SWALE
	GENERAL DRAINAGE
	DENOTES PROPOSED ENTRY TO BUILDING
	PROPOSED CHAINLINK FENCE
	EXISTING ASPHALT PAVING
	EXISTING CONCRETE WALKWAY
	DENOTES NEW SOD
	DENOTES LINE PAINTING
	EXISTING DECIDUOUS TREES
	EXISTING CONIFEROUS TREES
	EXISTING TEMPORARY BENCHMARK
	EXISTING MANHOLE
	EXISTING CATCHBASIN
	EXISTING CATCHBASIN MANHOLE
	EXISTING HYDRO POLE
	EXISTING LIGHT STANDARD
	EXISTING GAS VALVE
	EXISTING WATER VALVE
	EXISTING FIRE HYDRANT
	TRAFFIC FLOW DIRECTION ARROW
	PROPOSED DESIGNATED STOP SIGN
	PROPOSED DESIGNATED PARKING SIGN
	PROPOSED DESIGNATED FIRE ROUTE SIGN
	PROPOSED BOLLARDS (TYP.)
	OVERLAND FLOW ROUTE DIRECTION

ELEVATIONS ARE BASED ON GPS OBSERVATIONS TO PERMANENT REFERENCE STATIONS IN THE NAD83 (CSRS-2010) COORDINATE SYSTEM AND HAVE BEEN CORRECTED TO ORTHOMETRIC ELEVATIONS ON THE CGVD28 DATUM (1978 ADJUSTMENT) WITH GEOID MODEL HTV2.0, AS SUPPLIED BY NATURAL RESOURCES CANADA.

T.B.M. No. 1 ELEV. = 327.13m (GEO)
CUT CROSS ON THE SOUTH SIDE OF CONNAUGHT STREET, SOUTH OF THE SOUTH EAST CORNER OF THE SUBJECT PROPERTY AS SHOWN.

T.B.M. No. 2 ELEV. = 327.15m (GEO)
NAIL IN THE ASPHALT OF A WALKWAY ALONG THE EAST SIDE OF THE SUBJECT PROPERTY, NEAR THE NORTH EAST CORNER OF THE SUBJECT PROPERTY AS SHOWN.

NO.	REVISION	DATE (MM/DD/YY)	BY
5	AS PER CITY COMMENTS	03/12/26	S.L.M.
4	CO-ORDINATION (DUCT BANKS)	01/30/26	S.L.M.
3	COMMENTS/CO-ORDINATION	12/17/25	S.L.M.
2	ISSUED FOR BUILDING PERMIT	10/15/25	S.L.M.
1	CO-ORDINATION	08/14/25	S.L.M.


J.H. COHOON ENGINEERING LIMITED CONSULTING ENGINEERS
440 HARDY ROAD, UNIT #1, BRANTFORD - ONTARIO, N3T 5J8
TEL. (519) 753-2656 FAX. (519) 753-4263 www.cohooneg.com

PROJECT:
ST. ALOYSIUS CATHOLIC ELEMENTARY SCHOOL ADDITION
504 CONNAUGHT STREET
KITCHENER, ON.

CLIENT:
GRGURIC ARCHITECTS

GRADING PLAN

DESIGN:	R.W.P.	SCALE:	1:300
DRAWN:	K.P.B./S.L.M.	JOB No:	
CHECKED:	R.W.P.	17488	
SHEET:	1 of 4	DWG. No:	
DATE:	JUNE 16, 2025	17488-1	

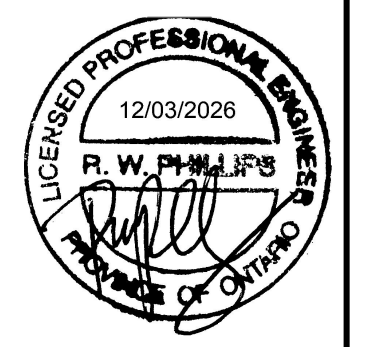




SEWER CROSSINGS				
LOCATION	SAN. INV.	SAN. OBV.	W/M INV.	W/M OBV.
1	325.45	325.60	324.85	325.00
2	324.33	324.48	325.28	325.40

DUCT CROSSINGS				
LOCATION	DUCT INV.	DUCT OBV.	W/M INV.	W/M OBV.
3	326.65	326.75	325.20	325.35

150mm PVC DR18 WATERMAIN - JOINT RESTRAINT SUMMARY	
LOCATION / DESCRIPTION	LENGTH TO BE RESTRAINED (L _R)
150mm DIA. - W.V./DEAD END/HYDRANT	15.0m MIN.
150mm DIA. - 11.25' HORZ. BEND	1.0m MIN.
150mm DIA. - 22.5' HORZ. BEND	1.25m MIN.
150mm DIA. - 45' HORZ. BEND	2.45m MIN.

SANITARY SYSTEM				
MH No.	DESCRIPTION	T/G	INVERTS	
S1	1.2m ϕ P/C MH	327.10	N 325.88 SE 325.80	
S2	1.2m ϕ P/C MH	326.85	NW 324.27 E 324.19	
S3	1.2m ϕ P/C MH	327.40	W 323.26 S 323.18	

STORM SYSTEM				
MH No.	DESCRIPTION	T/G	INVERTS	
EX	1.2m ϕ P/C MH	326.02	S 324.41 E 324.48 W 324.29	
ST1	1.2m ϕ P/C MH	326.10	N 324.27 S 324.25 E 324.30 W 324.22	
ST2	OGS UNIT (STC EF06) c/w GRATE	325.65	N 324.25	
ST3	1.2m ϕ P/C MH	325.95	N 324.08 S 324.05	

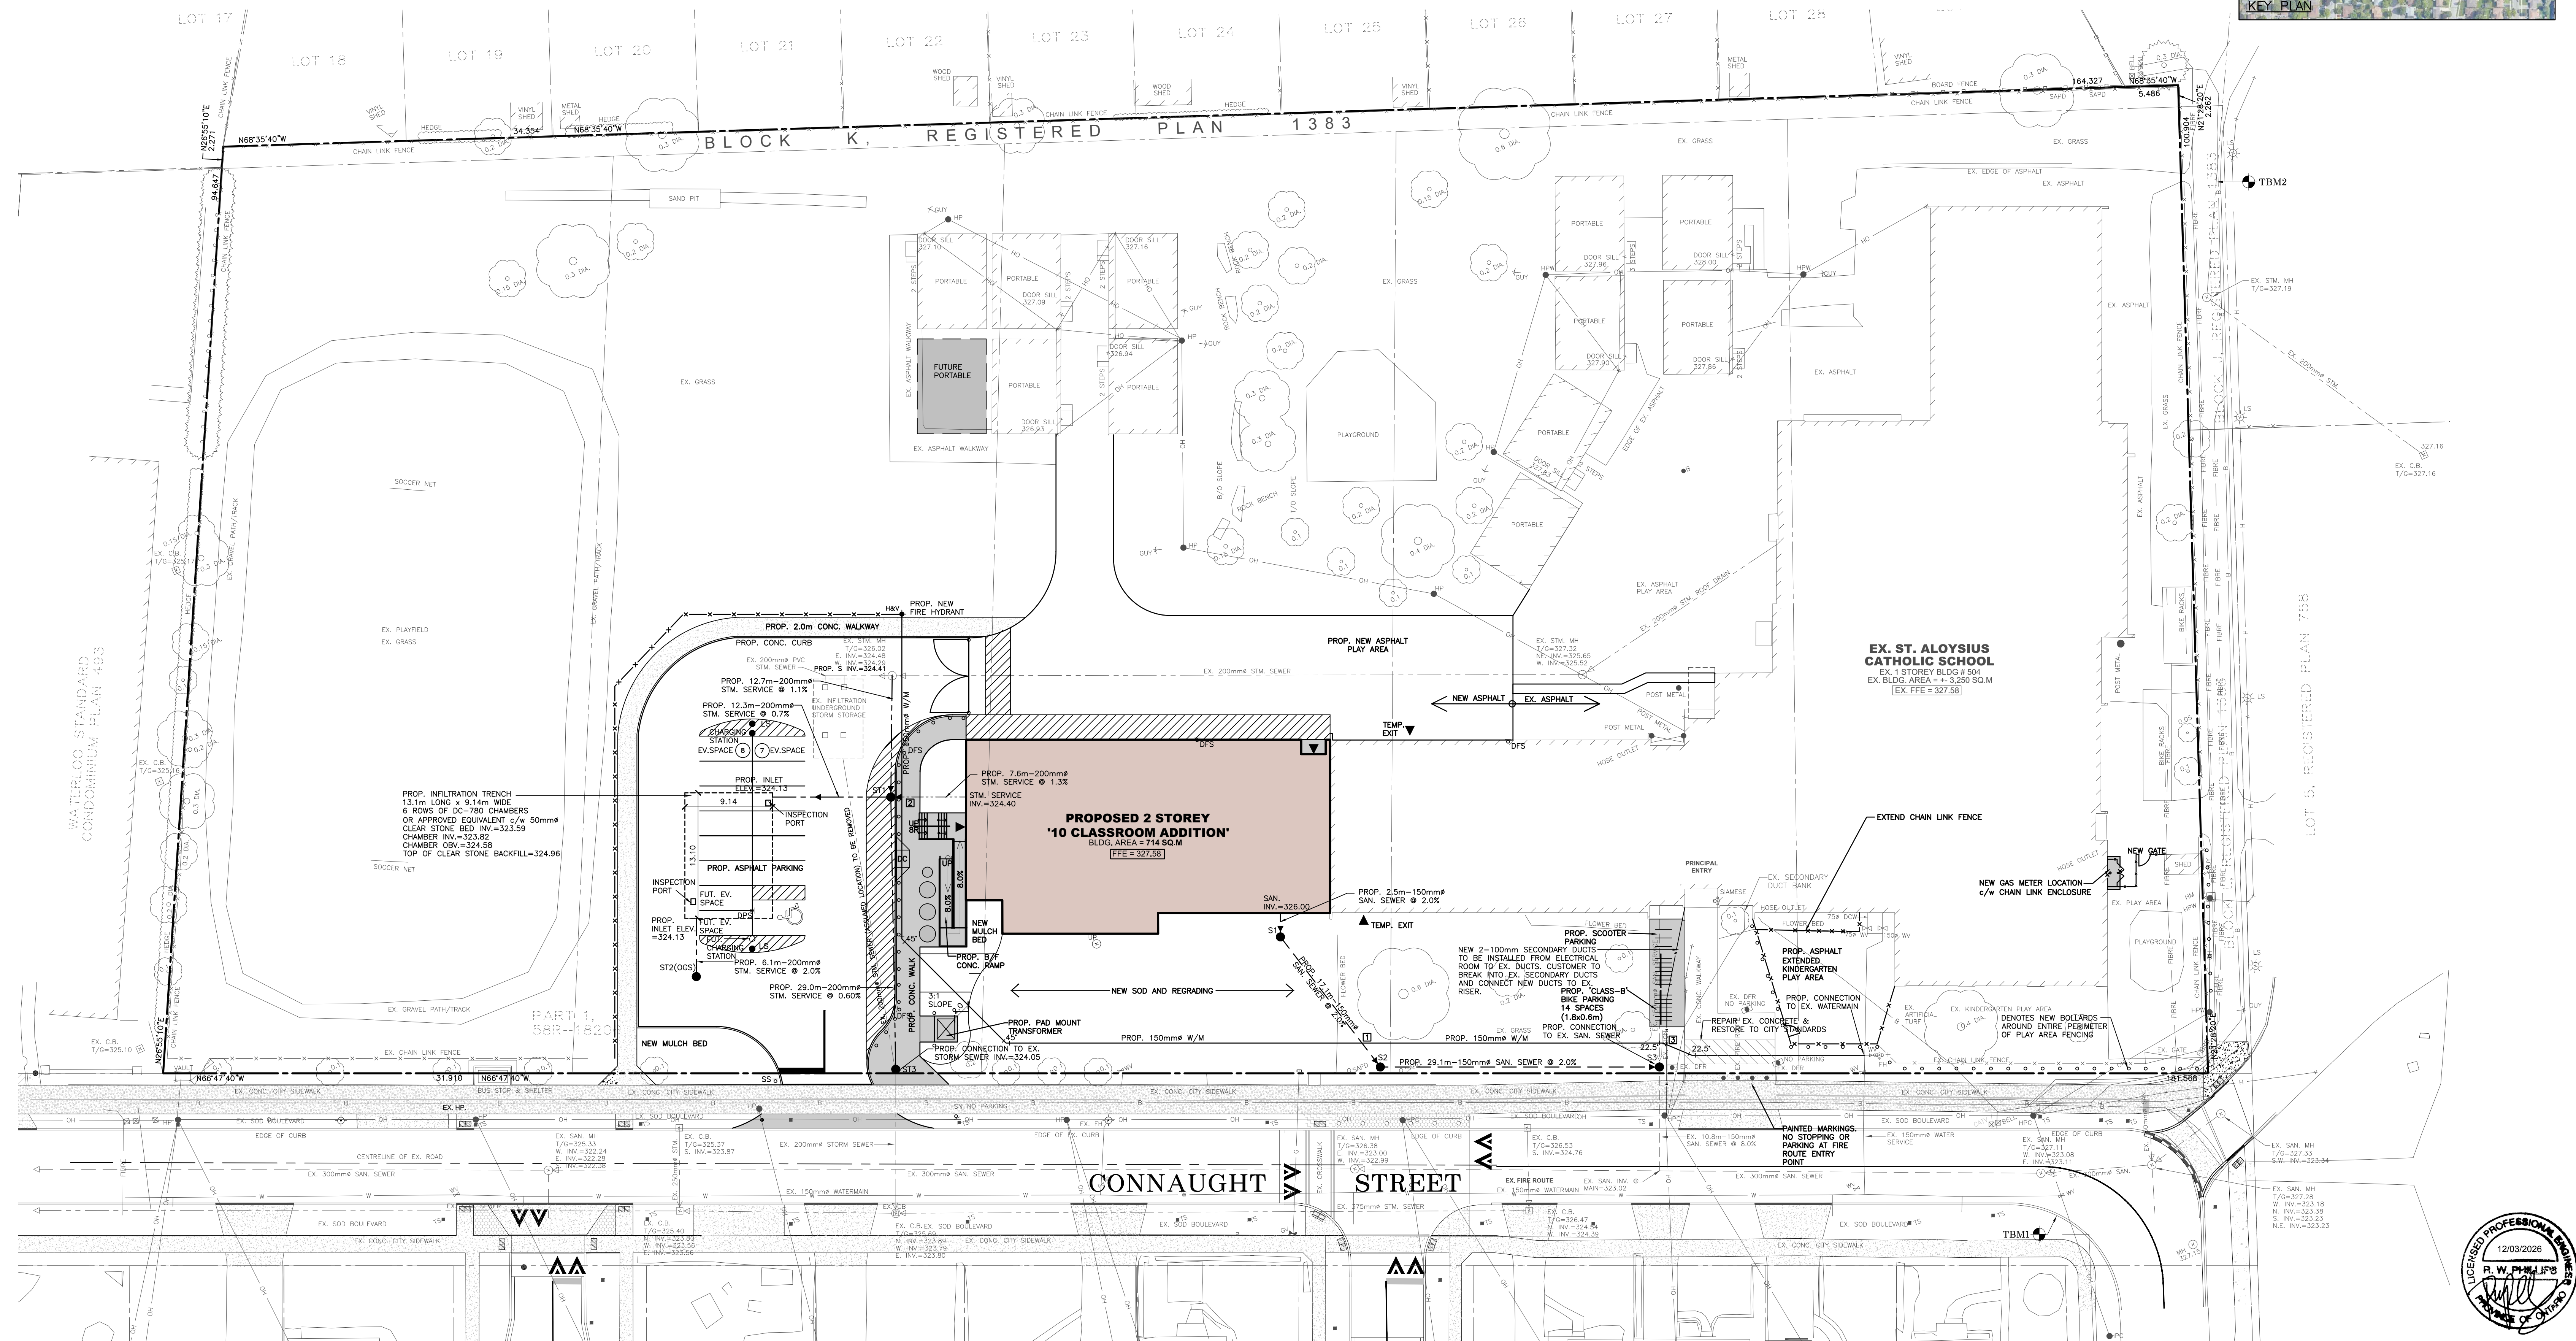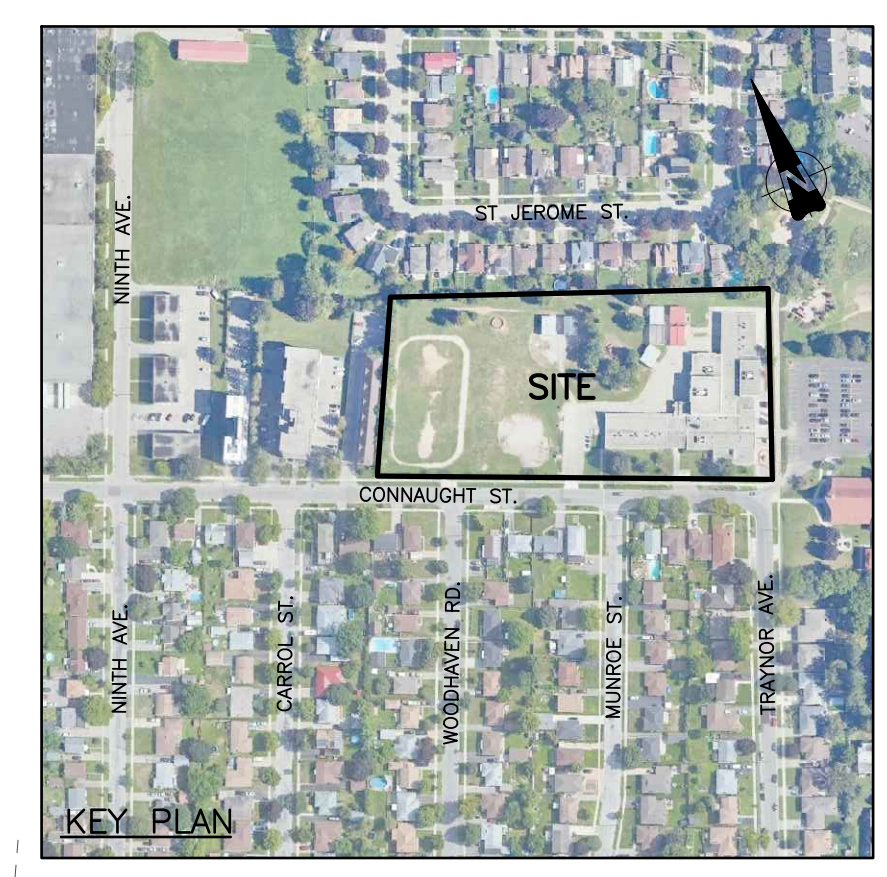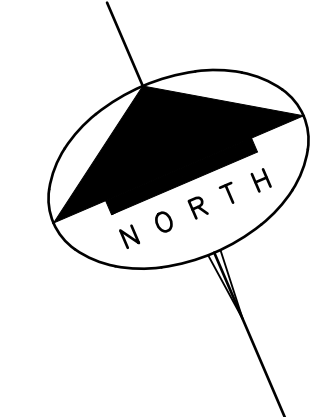

LEGEND:

- EXISTING ELEVATIONS
- EXISTING DECIDUOUS TREES
- EXISTING CONIFEROUS TREES
- EXISTING TEMPORARY BENCHMARK
- EXISTING MANHOLE
- EXISTING CATCHBASIN
- EXISTING CATCHBASIN MANHOLE
- EXISTING HYDRO POLE
- EXISTING LIGHT STANDARD
- EXISTING GAS VALVE
- EXISTING GAS METER
- EXISTING WATER VALVE
- EXISTING FIRE HYDRANT
- EXISTING CHAIN LINK FENCE
- EXISTING WOOD FENCE
- EXISTING WATERMAIN
- EXISTING SANITARY SEWER
- EXISTING STORM SEWER
- EXISTING U/G BELL
- EXISTING U/G CABLE TV
- EXISTING U/G FIBRE OPTICS
- EXISTING U/G GAS
- EXISTING U/G HYDRO
- EXISTING OVERHEAD HYDRO

GENERAL NOTES:

- ALL ELEVATIONS SHOWN IN METRIC.
- BUILDER/OWNER TO VERIFY COMPLIANCE WITH ZONING BYLAWS (i.e. SIDEYARDS, SETBACKS, REARYARDS ETC.)
- BUILDER TO VERIFY SERVICE AT THE PROPERTY LINE WILL ACCOMMODATE U/S OF FOOTING.
- THE PROPERTY OWNER IS RESPONSIBLE FOR RESTORATION OF ALL DAMAGED AND/OR DISTURBED PROPERTY WITHIN THE MUNICIPAL RIGHT-OF-WAY TO CITY OF KITCHENER STANDARDS.
- IF, FOR UNFORESEEN REASON, THE OWNER AND/OR HIS/HER REPRESENTATIVE MUST ENCROACH ONTO PRIVATE LAND TO UNDERTAKE ANY WORKS, HE/SHE MUST OBTAIN WRITTEN PERMISSION FROM THE ADJACENT PROPERTY OWNERS PRIOR TO ENTERING UPON THE PRIVATE PROPERTY TO PERFORM ANY WORKS. COPIES OF THESE LETTERS OF CONSENT MUST BE SUBMITTED TO THE DEVELOPMENT & TECHNICAL SERVICES-ENGINEERING DEVELOPMENT DIVISION, PRIOR TO ANY WORK BEING PERFORMED. FAILURE TO COMPLY WITH THE ABOVE IS AT THE PROPERTY OWNERS OWN RISK.
- THIS PLAN TO BE READ IN CONJUNCTION WITH THE GRADING PLAN & SEDIMENT EROSION CONTROL PLAN.

ELEVATIONS ARE BASED ON GPS OBSERVATIONS TO PERMANENT REFERENCE STATIONS IN THE NAD83 (CRS-2011) COORDINATE SYSTEM AND HAVE BEEN CORRECTED TO ORTHOMETRIC ELEVATIONS ON THE CGVD28 DATUM (1978 ADJUSTMENT) WITH GEOID MODEL HTV2.0, AS SUPPLIED BY NATURAL RESOURCES CANADA.

T.B.M. No. 1 ELEV. = 327.13m (GEO)
CUT CROSS ON THE SOUTH SIDE OF CONNAUGHT STREET, SOUTH OF THE SOUTH EAST CORNER OF THE SUBJECT PROPERTY AS SHOWN.

T.B.M. No. 2 ELEV. = 327.15m (GEO)
NAIL IN THE ASPHALT OF A WALKWAY ALONG THE EAST SIDE OF THE SUBJECT PROPERTY, NEAR THE NORTH EAST CORNER OF THE SUBJECT PROPERTY AS SHOWN.

NO.	REVISION	DATE (MM/DD/YY)	BY
5	AS PER CITY COMMENTS	03/12/26	S.L.M.
4	CO-ORDINATION (DUCT BANKS)	01/30/26	S.L.M.
3	COMMENTS/CO-ORDINATION	12/17/25	S.L.M.
2	ISSUED FOR BUILDING PERMIT	10/15/25	S.L.M.
1	CO-ORDINATION	08/14/25	S.L.M.

J.H. COHOON ENGINEERING LIMITED
CONSULTING ENGINEERS

440 HARDY ROAD, UNIT #1, BRANTFORD - ONTARIO, N3T 5J8
TEL. (519) 753-2656 FAX (519) 753-4263 www.cohooneg.com

PROJECT:
ST. ALOYSIUS CATHOLIC ELEMENTARY SCHOOL ADDITION
504 CONNAUGHT STREET
KITCHENER, ON.

CLIENT:
GRGURIC ARCHITECTS

SERVICING PLAN

DESIGN:	R.W.P.	SCALE:	1:300
DRAWN:	K.P.B./S.L.M.	JOB No:	
CHECKED:	R.W.P.		17488
SHEET:	2 of 4	DWG. No:	
DATE:	JUNE 16, 2025		17488-2

