

PROJECT: MILTON #13 ELEMENTARY SCHOOL
AND CHILDCARE FACILITY
HDSB PROJECT NO. RFT 26-031

CLIENT: HALTON DISTRICT SCHOOL BOARD

PROJECT No.: 22124

DATE: JANUARY 2026

BINDER: **C** ARCHITECTURAL DETAILS &
GEOTECHNICAL REPORT



ARCHITECT & CONSULTANTS:

H HOSSACK
ARCHITECTURE

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S4 Strategy 4
• Development Consulting
• Urban Transformation
• Urban Design
• Urban Engineering

MGM
CONSULTING INC

DEI Consulting
Engineers
MECHANICAL | ELECTRICAL | AQUATIC

KE KALOS
ENGINEERING

No. of Pages

SPECIFICATIONS BINDER “C”

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Detail No. Title

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No. of Pages


SKA 1 Partial Site Plan for Alternate Price Information for Synthetic Grass
SKA 2 Library Roof Patio for Alternate Price Information

PMP-101 and
PMP-102 PAVEMENT MARKING & SIGNAGE PLAN
(to be read in conjunction with Site Plan and Site Plan Details)
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| | <p>PROJECT ADDRESS OAKVILLE #3 OAKVILLE, ON</p> | <p>DATE SEPTEMBER 2022</p> | <p>THIS DRAWING IS THE PROPERTY OF TRI-TECH PINNACLE GROUP INC. AND MAY NOT BE REPRODUCED WITHOUT CONSENT</p> | |
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INSTALL NEW CONTINUOUS FOAM GASKET BETWEEN METAL FLASHINGS AND MECH.

GRANULATED MODIFIED BITUMEN CAP FLASHING TO EXTEND OVER TOP OF THE CURB

NEW METAL FLASHING

2 PLY MODIFIED BITUMEN FLASHING MEMBRANES TO BE EXTENDED TO THE TOP OF THE CURB AND ONTO THE FIELD OF THE ROOF

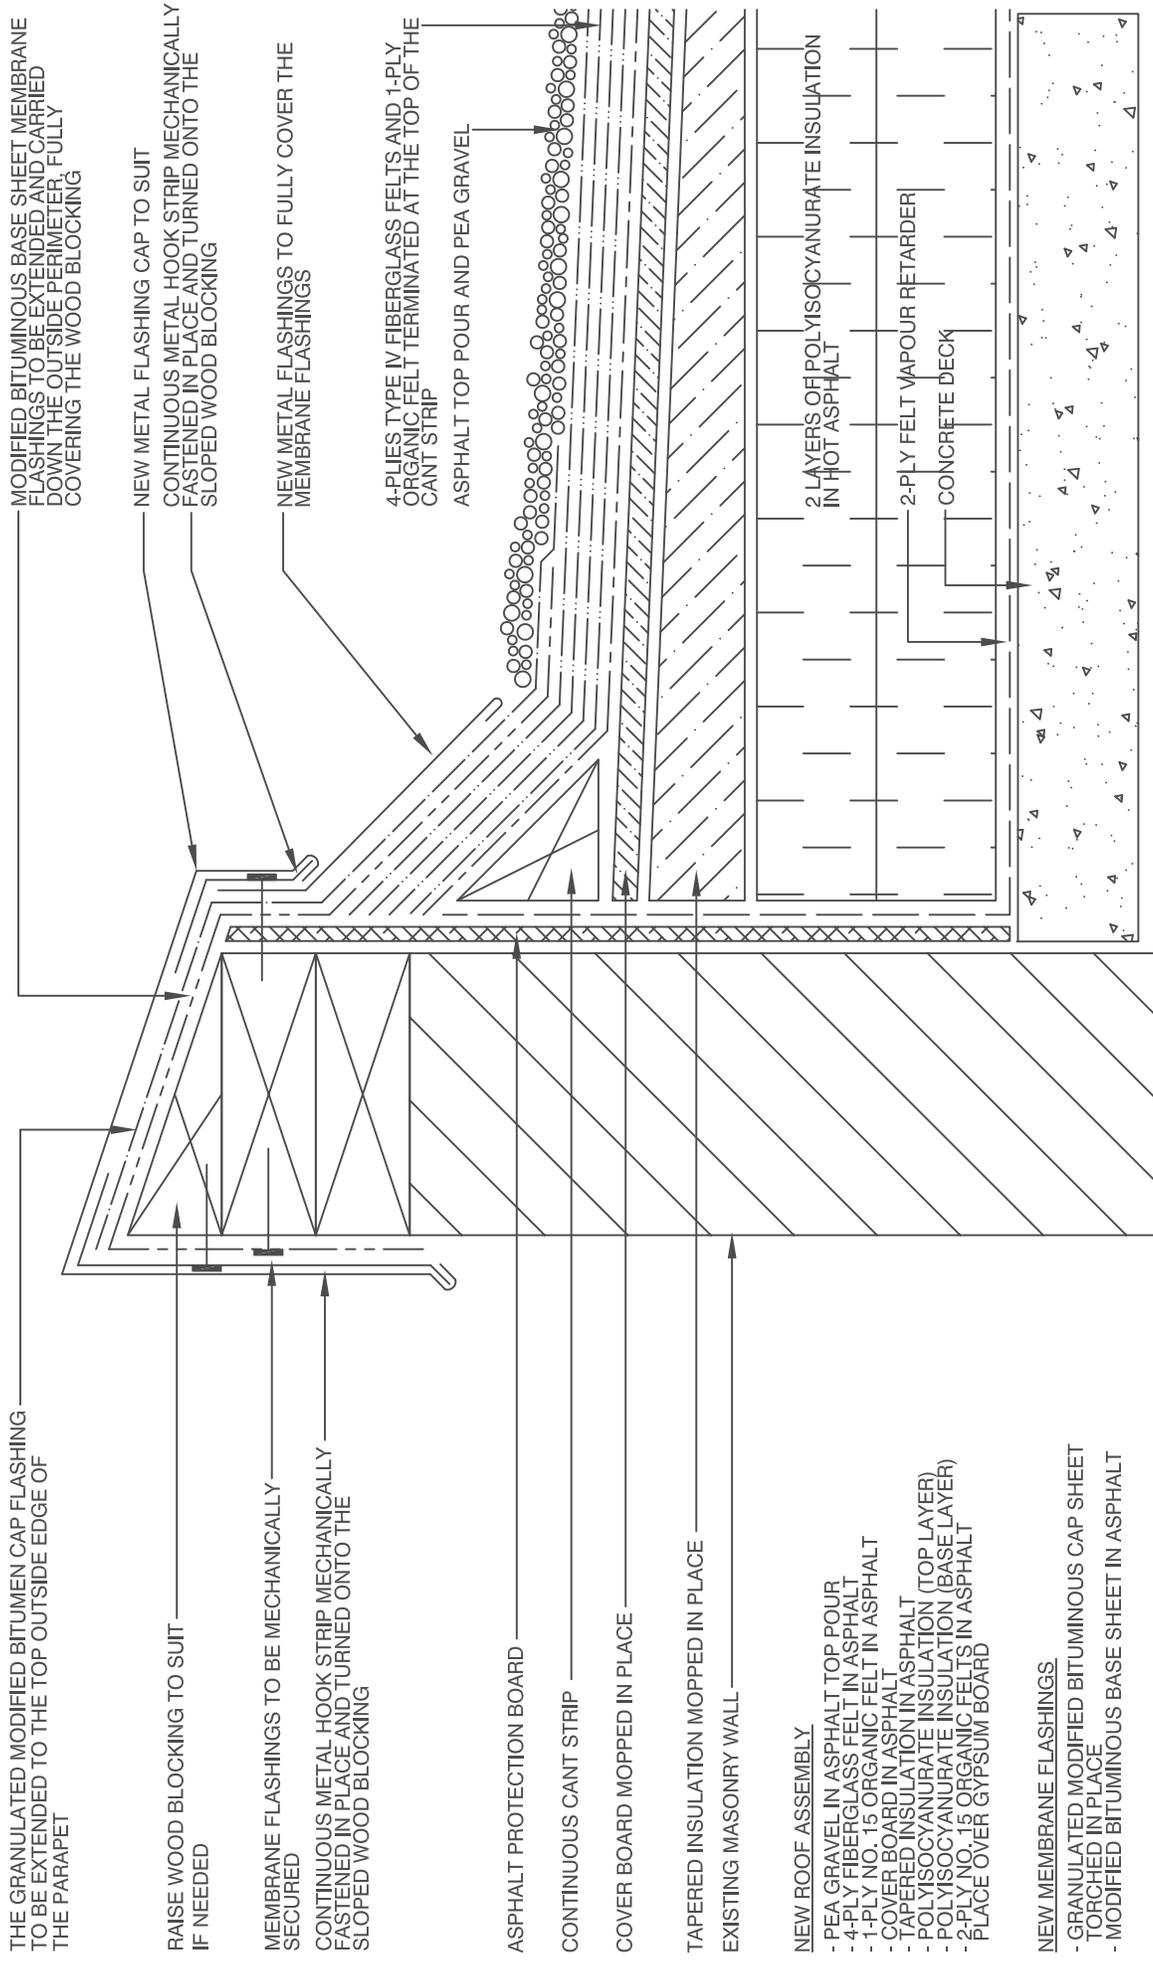CONTINUOUS CANT STRIP

4-PLIES TYPE IV FIBERGLASS FELTS AND 1-PLY ORGANIC FELT TERMINATED AT THE TOP OF THE CANT STRIP

ASPHALT TOP POUR AND PEA GRAVEL

COVER BOARD MOPPED IN PLACE


TAPERED INSULATION MOPPED IN PLACE

4 LAYERS OF POLYISOCYANURATE INSULATION IN HOT ASPHALT

VAPOUR RETARDER

WOOD BLOCKING

CONCRETE DECK

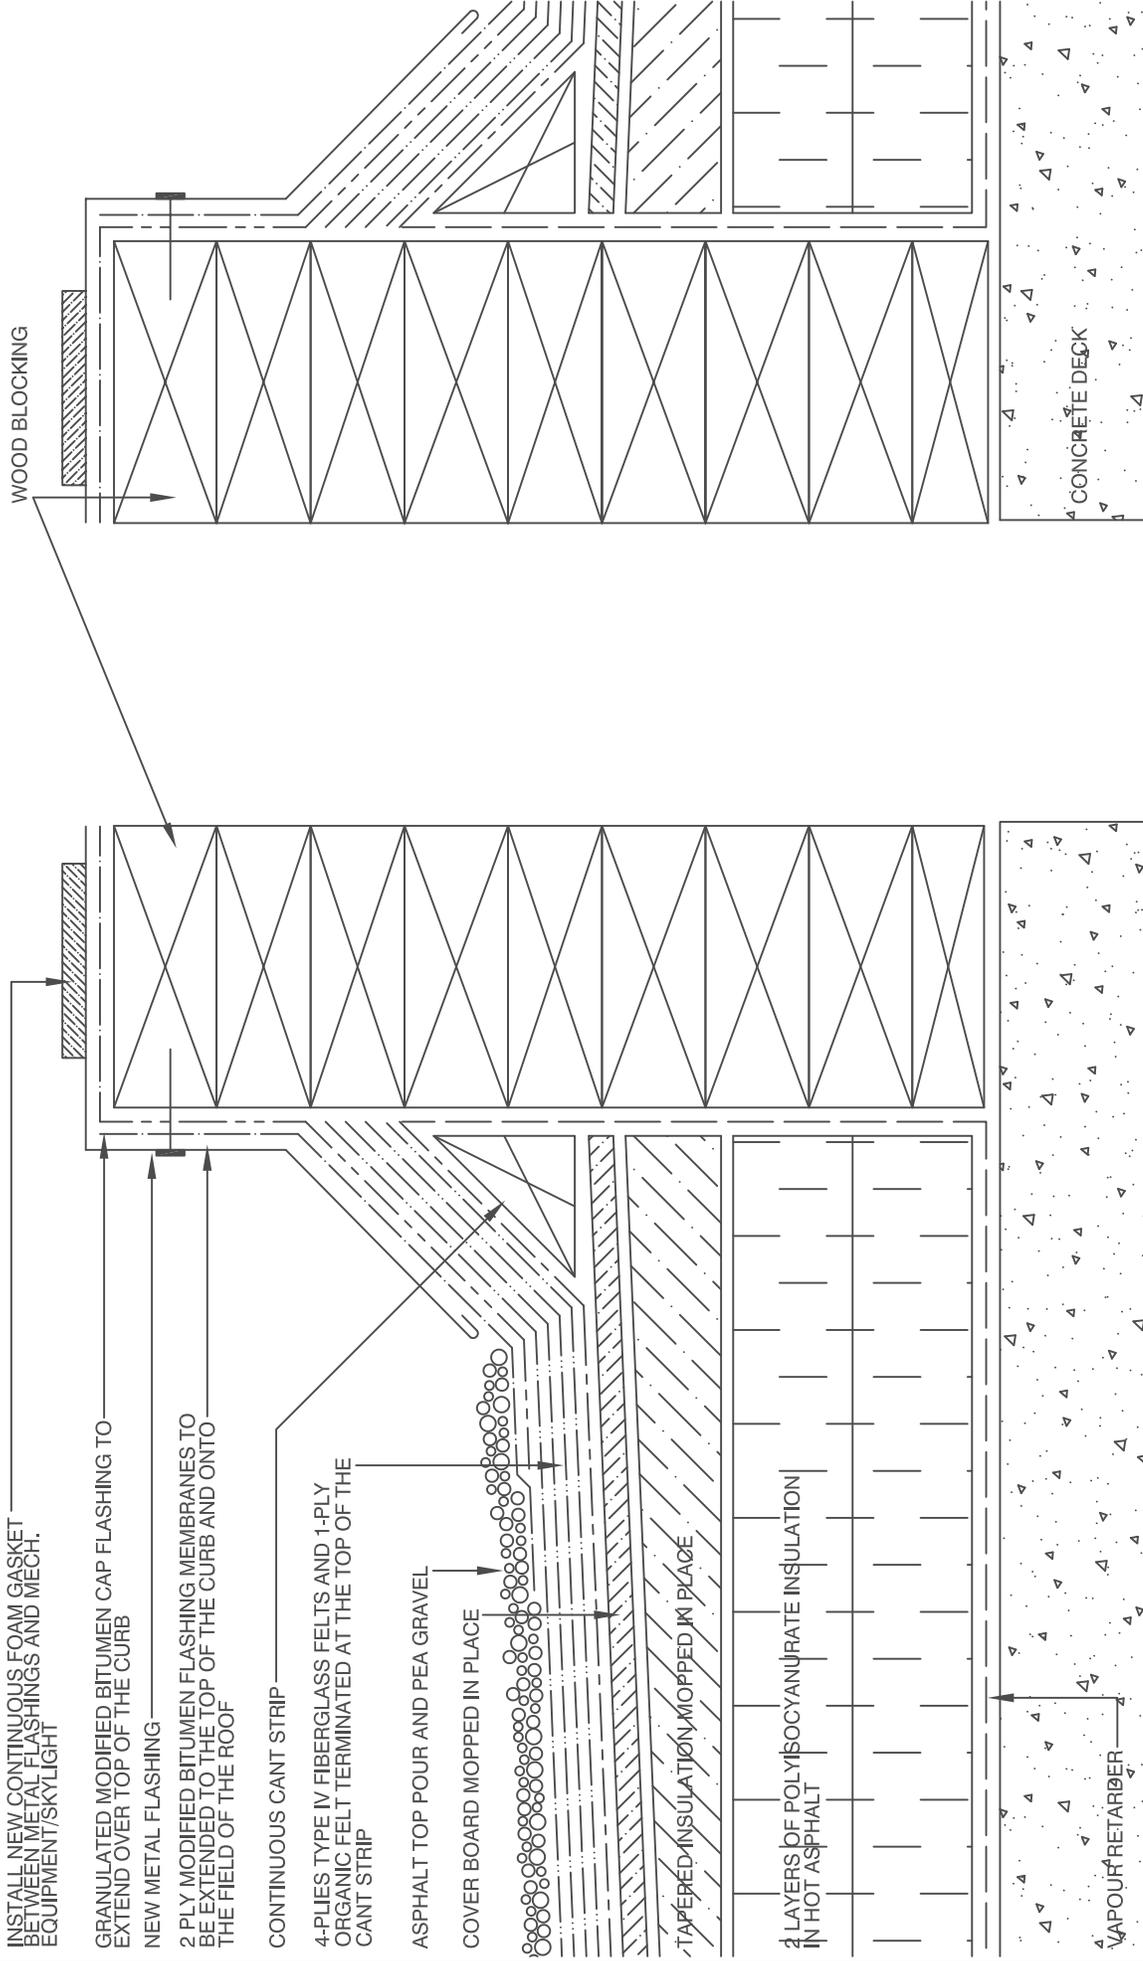

TRI-TECH PINNACLE
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DRAWING TITLE
CURB DETAIL

FILE NO. **22-0802**

SCALE **N.T.S.**

DATE **SEPTEMBER 2022**

DRAWING NUMBER
2A

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INSTALL NEW CONTINUOUS FOAM GASKET BETWEEN METAL FLASHINGS AND MECH. EQUIPMENT

GRANULATED MODIFIED BITUMEN CAP FLASHING TO EXTEND OVER TOP OF THE CURB

NEW METAL FLASHING

2 PLY MODIFIED BITUMEN FLASHING MEMBRANES TO BE EXTENDED TO THE TOP OF THE CURB AND ONTO THE FIELD OF THE ROOF

CONTINUOUS CANT STRIP


4-PLIES TYPE IV FIBERGLASS FELTS AND 1-PLY ORGANIC FELT TERMINATED AT THE TOP OF THE CANT STRIP

ASPHALT TOP POUR AND PEA GRAVEL

COVER BOARD MOPPED IN PLACE

TAPERED INSULATION MOPPED IN PLACE

4 LAYERS OF POLYISOCYANURATE INSULATION MOPPED IN PLACE

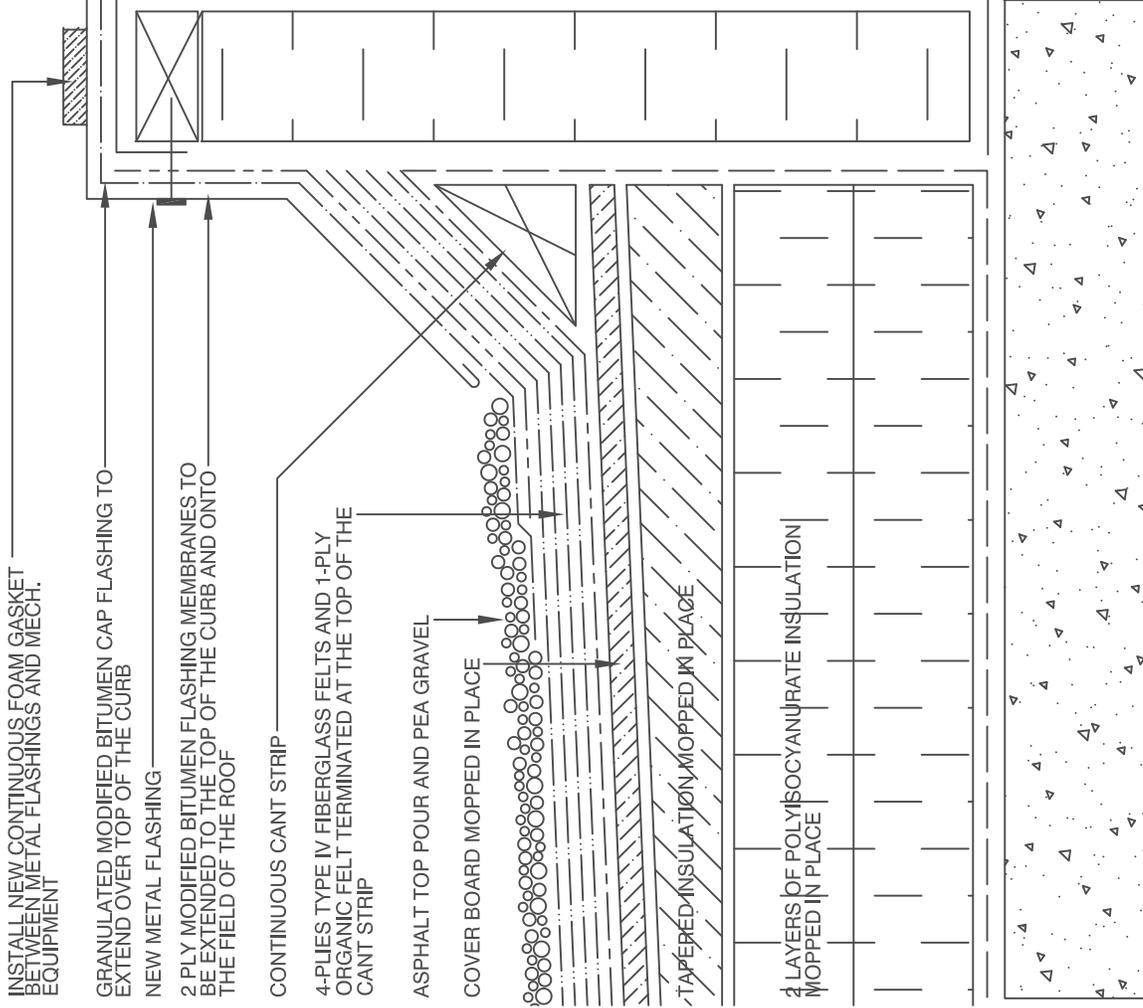

CONCRETE DECK


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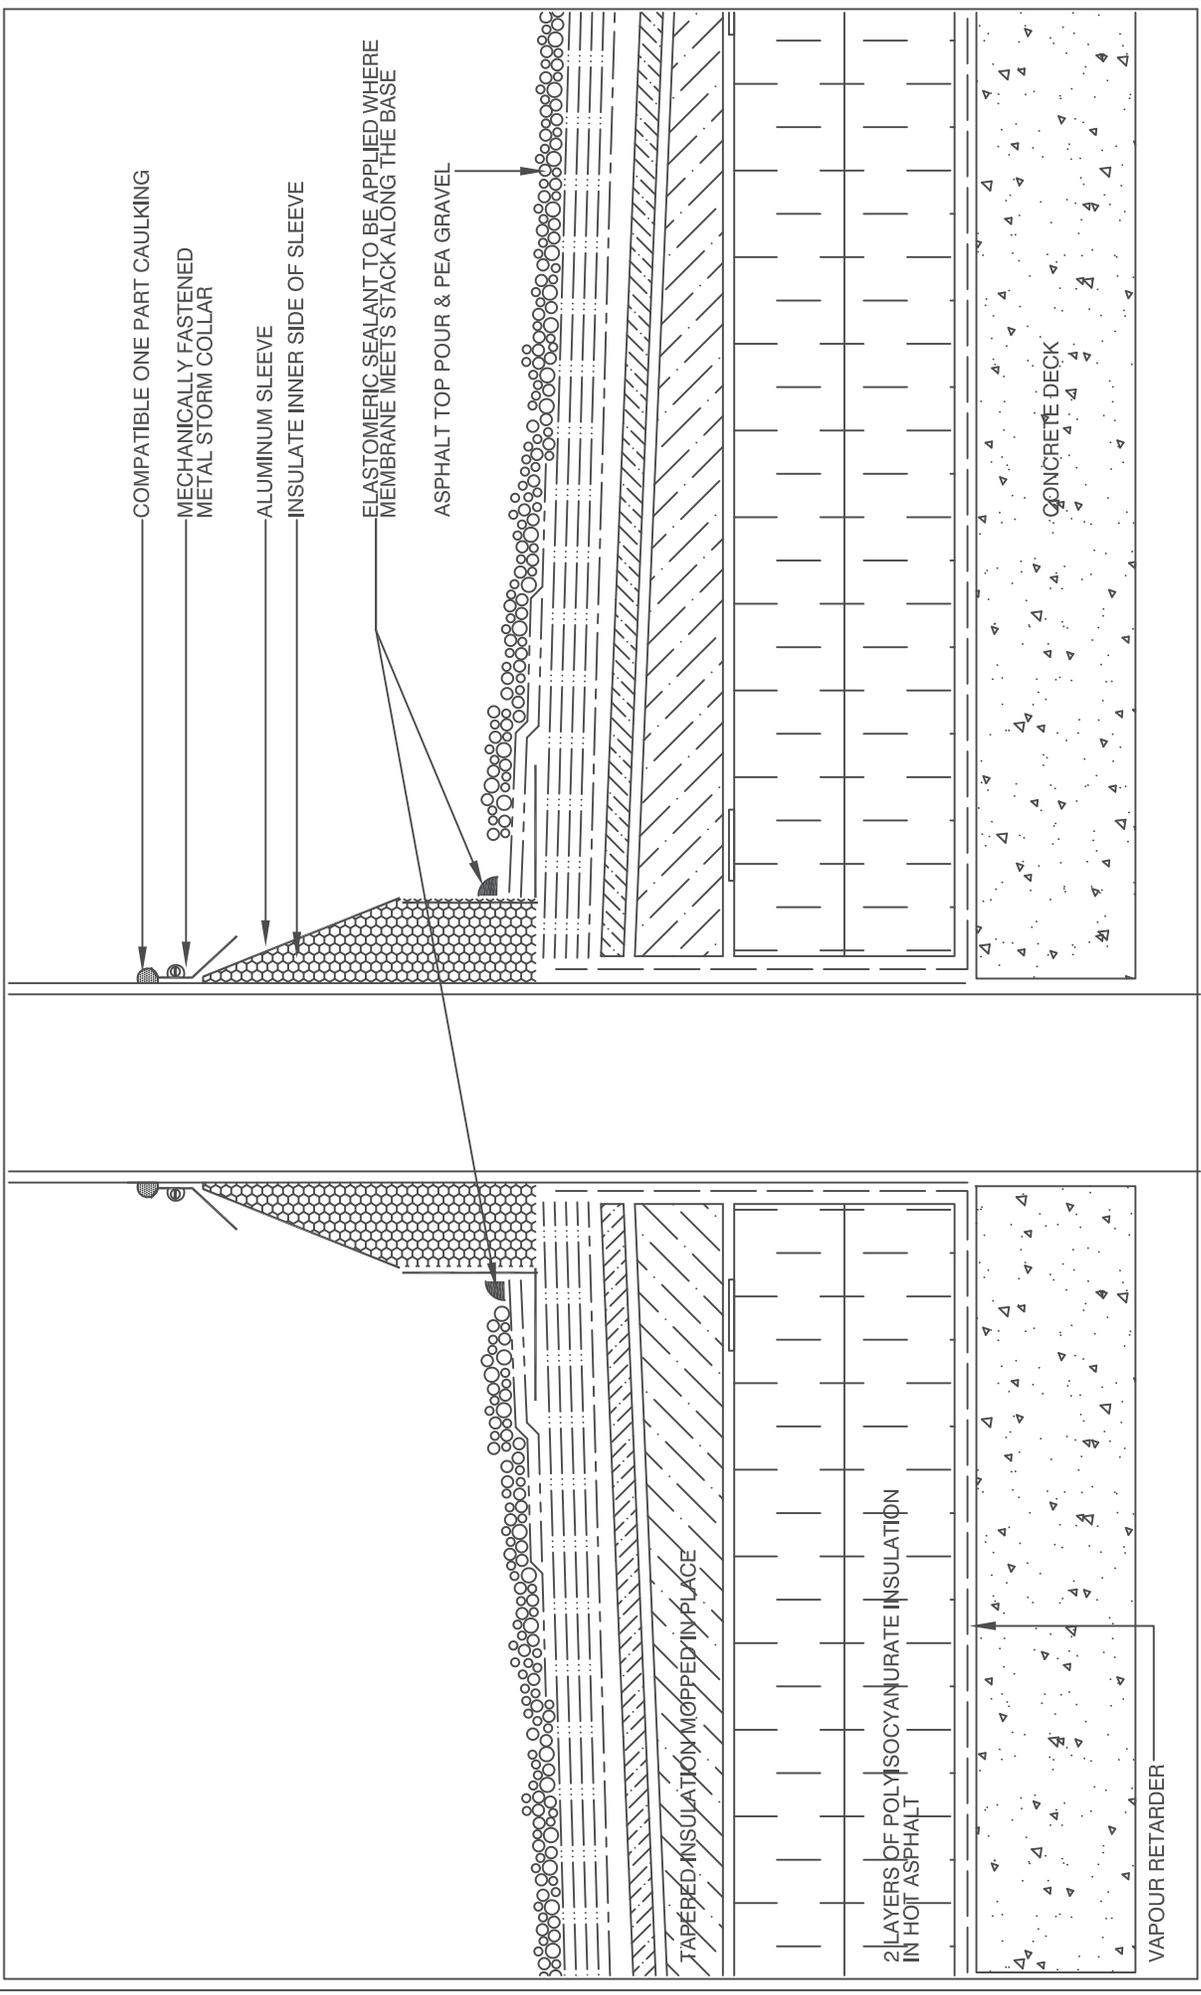
PROJECT ADDRESS
OAKVILLE #3
OAKVILLE, ON

DRAWING TITLE
MECHANICAL CURB DETAIL


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2B

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REMOVE ALL PREVIOUSLY APPLIED CAULKING, MASTIC, CEMENT, ASPHALT AND ANY OTHER CONTAMINANTS FROM PENETRATIONS USING A WIRE BRUSH

APPLY PITCH PAN SEALANT OVER ALL SURFACES WITHIN THE PITCH PAN. PITCH PAN SEALANT SHOULD EXTEND AT LEAST 1" (25mm) ABOVE THE PENETRATION

NEW FULLY SOLDERED COPPER PITCH PAN TO BE SET IN A FULL BED OF M1 SEALANT AND THE FLANGE IS TO BE PRIMED TO ACCEPT THE FLASHING MEMBRANES

COVER BOARD MOPPED IN PLACE

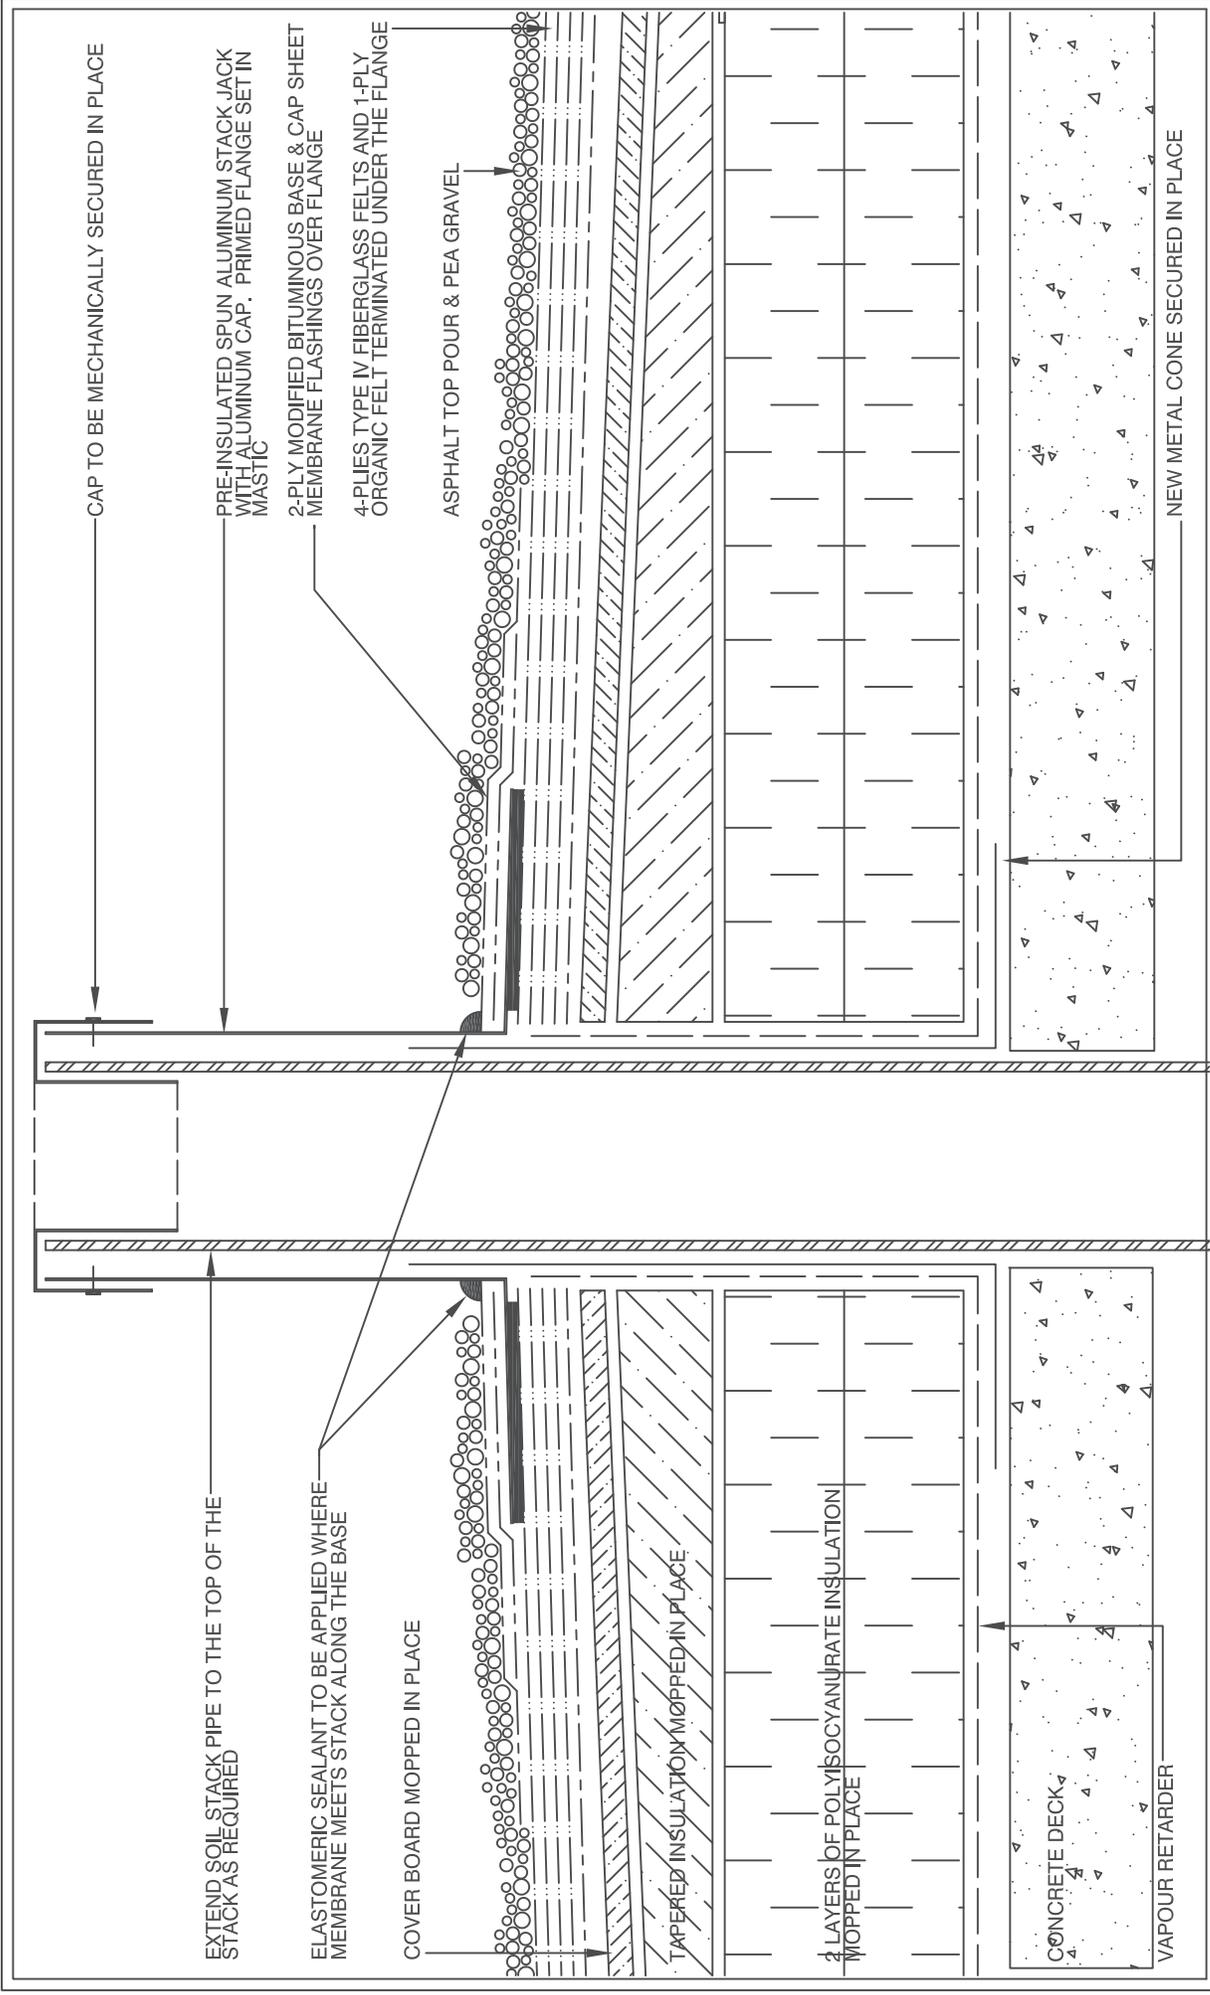TAPERED INSULATION MOPPED IN PLACE

2 LAYERS OF POLYISOCYANURATE INSULATION MOPPED IN PLACE

VAPOUR RETARDER

ONCE THE PITCH PAN HAS BEEN FILLED, INSTALL COPPER CAP AND SEALANT TO SUIT

PITCH PAN TO BE FILLED WITH POURABLE SEALER



ELASTOMERIC SEALANT TO BE APPLIED WHERE MEMBRANE MEETS PITCH PAN ALONG THE BASE

2-PLY MODIFIED BITUMINOUS BASE & CAP SHEET MEMBRANE FLASHINGS OVER FLANGE


4-PLIES TYPE IV FIBERGLASS FELTS AND 1-PLY ORGANIC FELT TERMINATED AT THE TOP OF THE CANT STRIP

ASPHALT TOP POUR AND PEA GRAVEL


METAL CONE SECURED IN PLACE

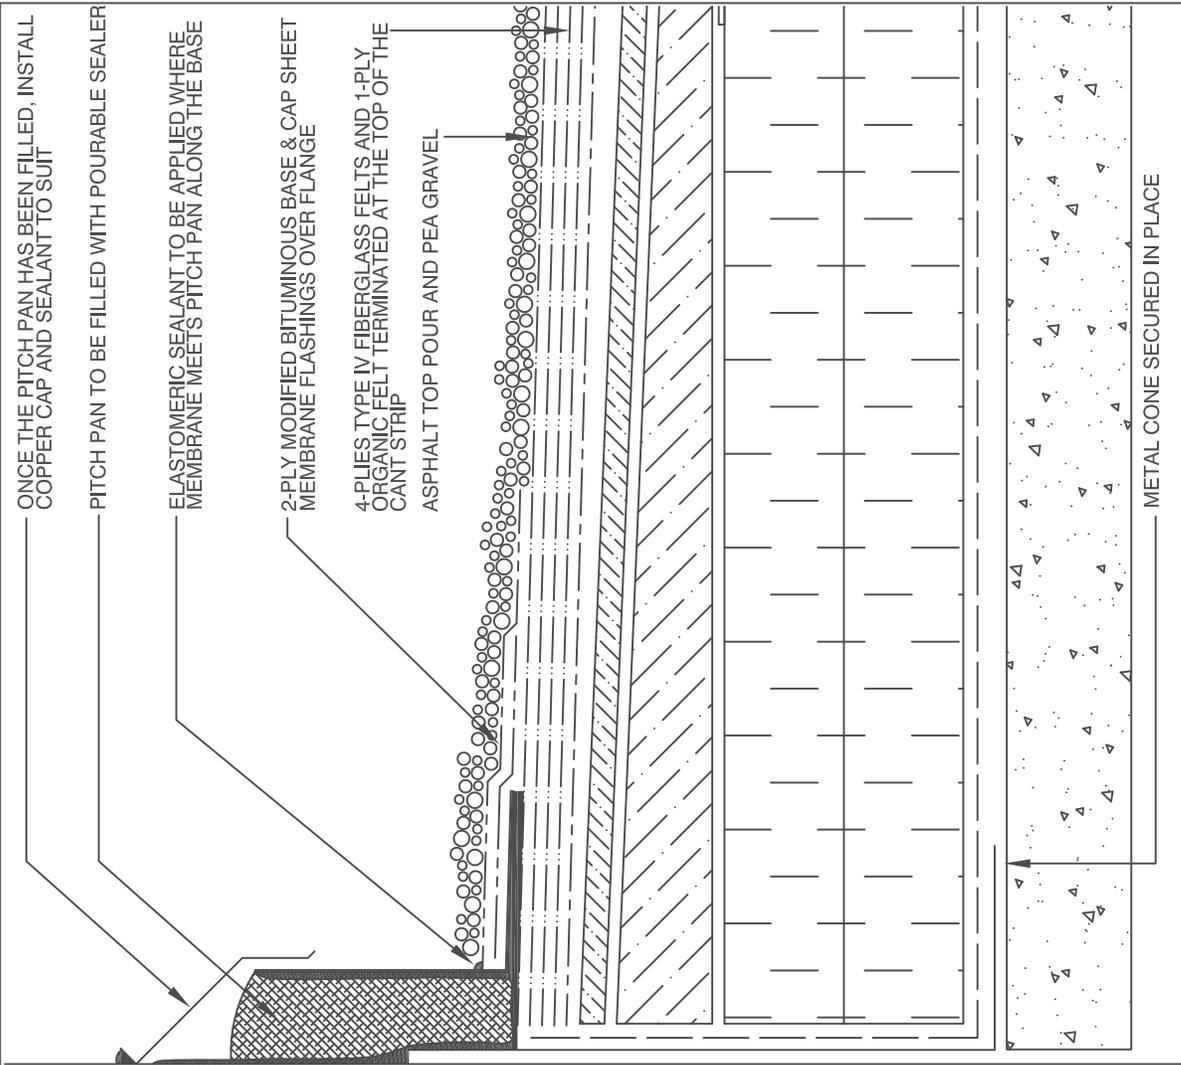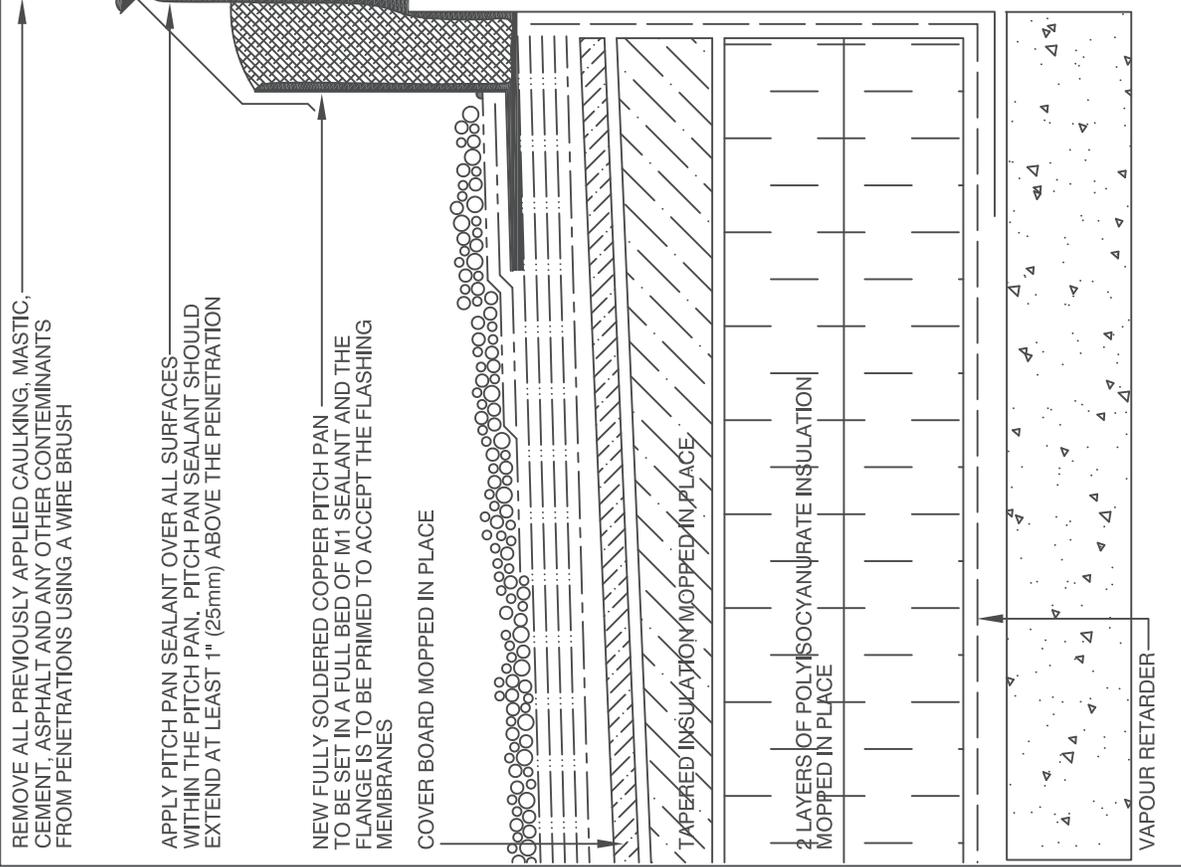


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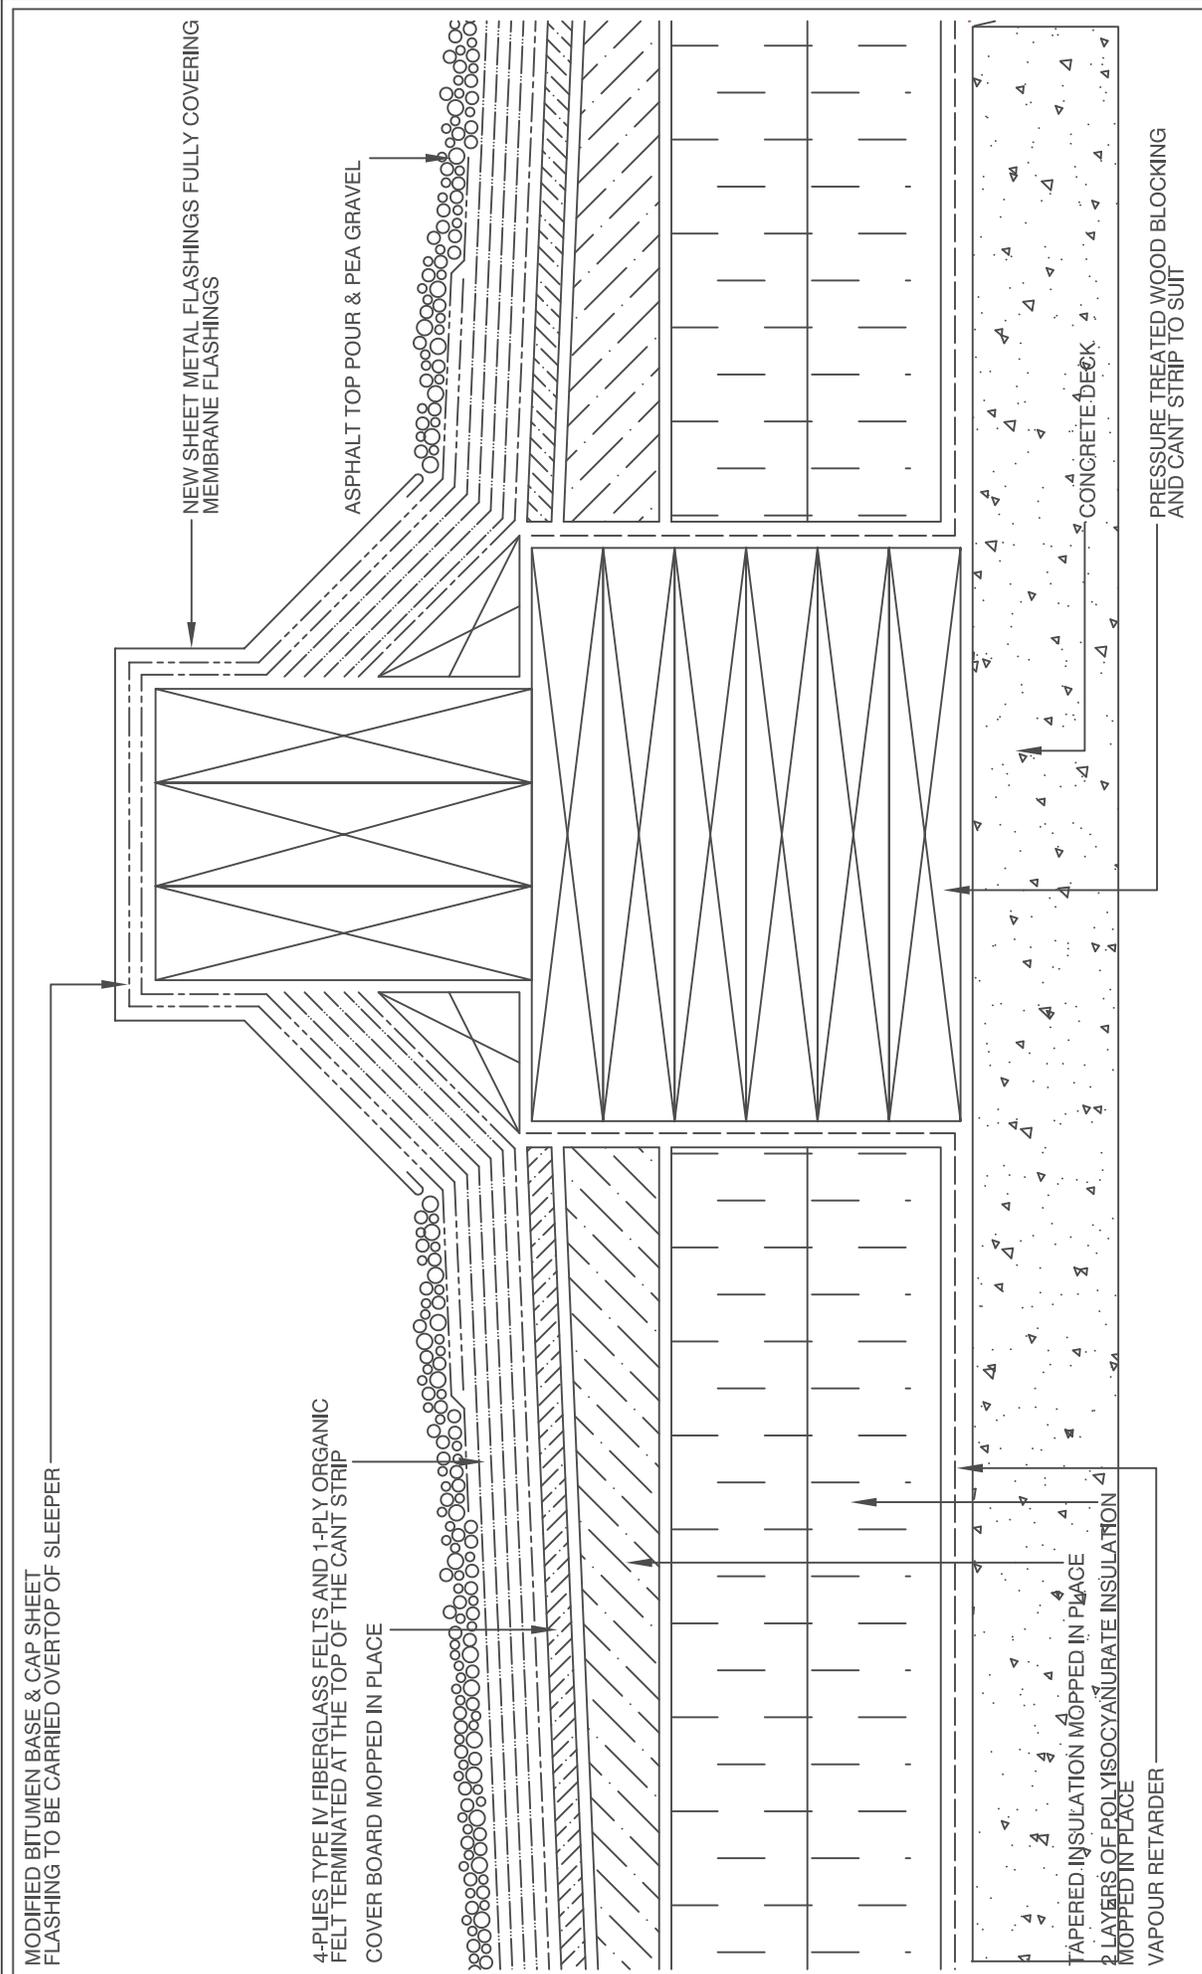
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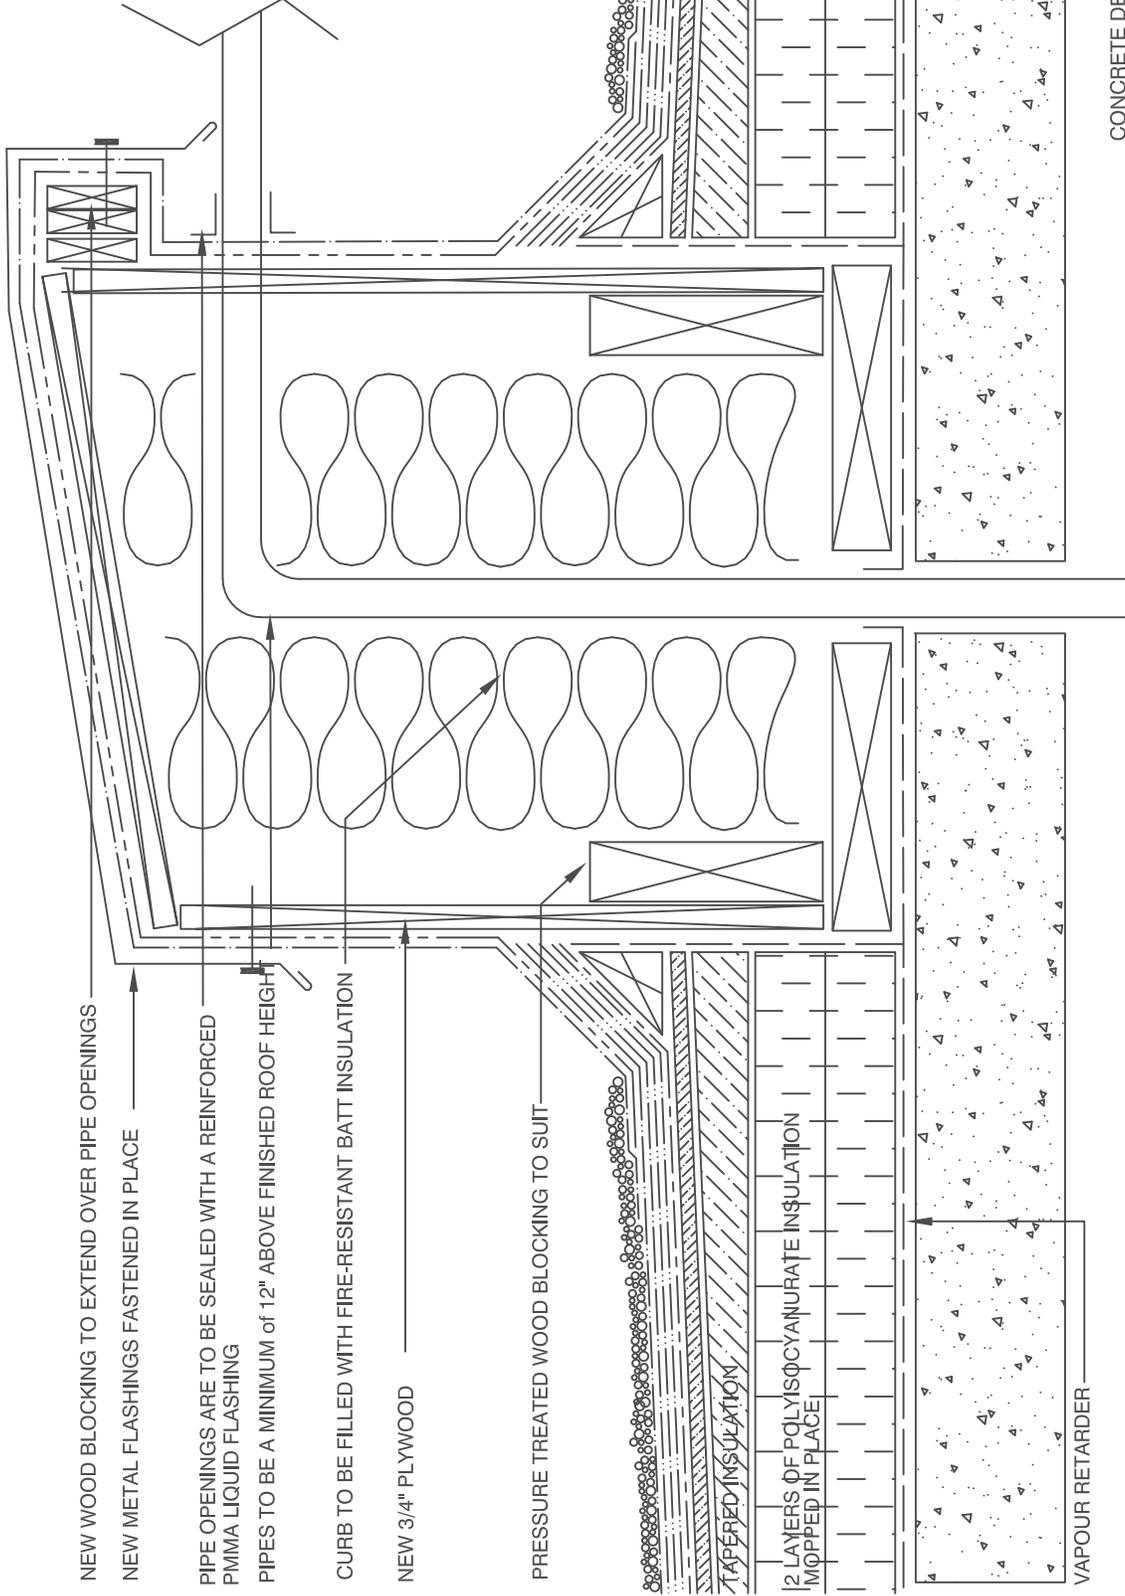
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|  TRI-TECH PINNACLE ROOF & BUILDING ENVELOPE CONSULTANTS | CLIENT HOSSACK & ASSOCIATES ARCHITECTS INC. | | FILE NO. 22-0802 | SCALE N.T.S. | DRAWING NUMBER 7 |
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| DRAWING TITLE METAL SIDING DETAIL | | 73 INDUSTRIAL PARKWAY NORTH - UNIT #3 AURORA - ONTARIO - L4G 4C4 TEL (905) 503-1300 - FAX (905) 503-2002 | | |

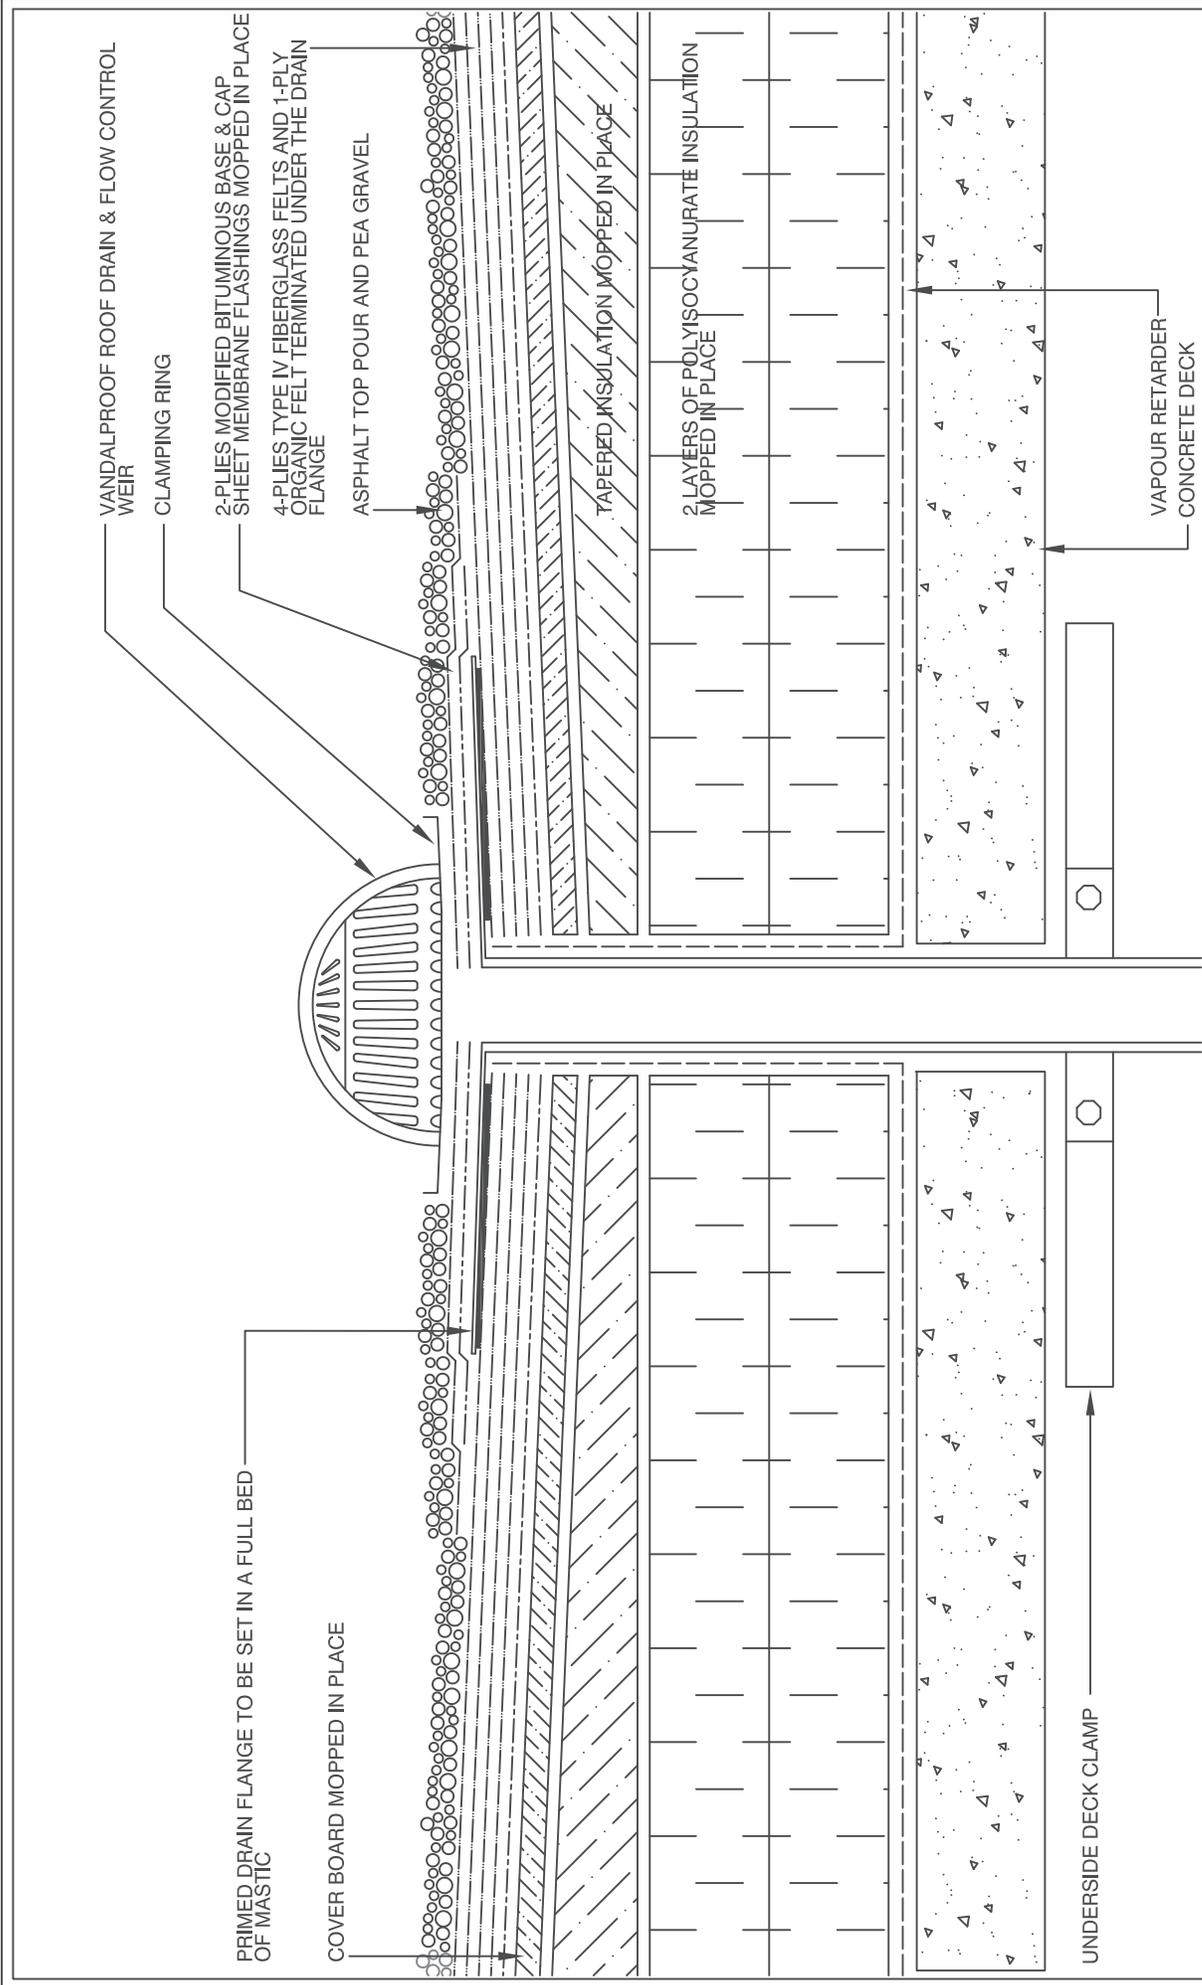

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CONCRETE DECK

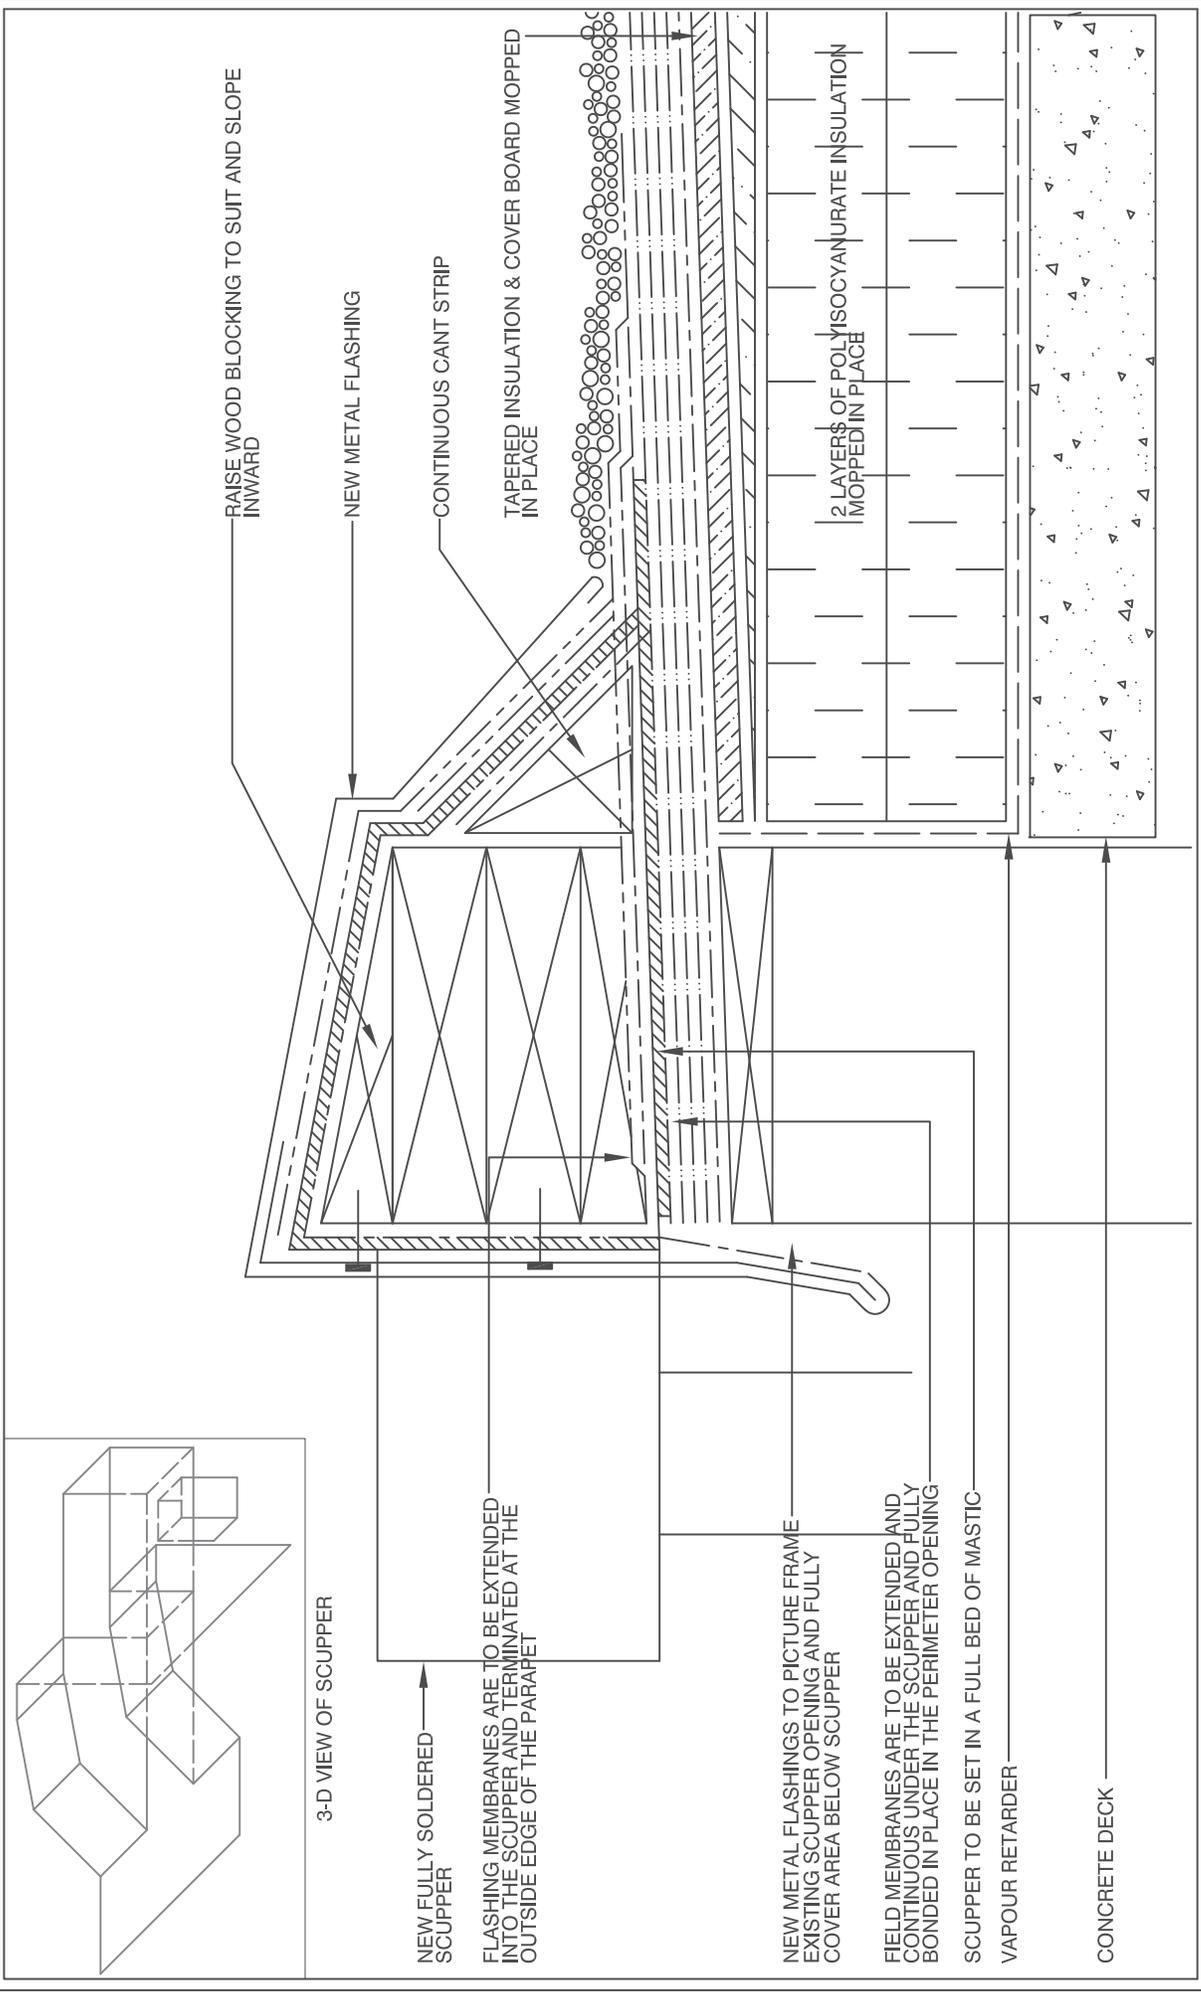VAPOUR RETARDER

NEW WOOD BLOCKING TO EXTEND OVER PIPE OPENINGS

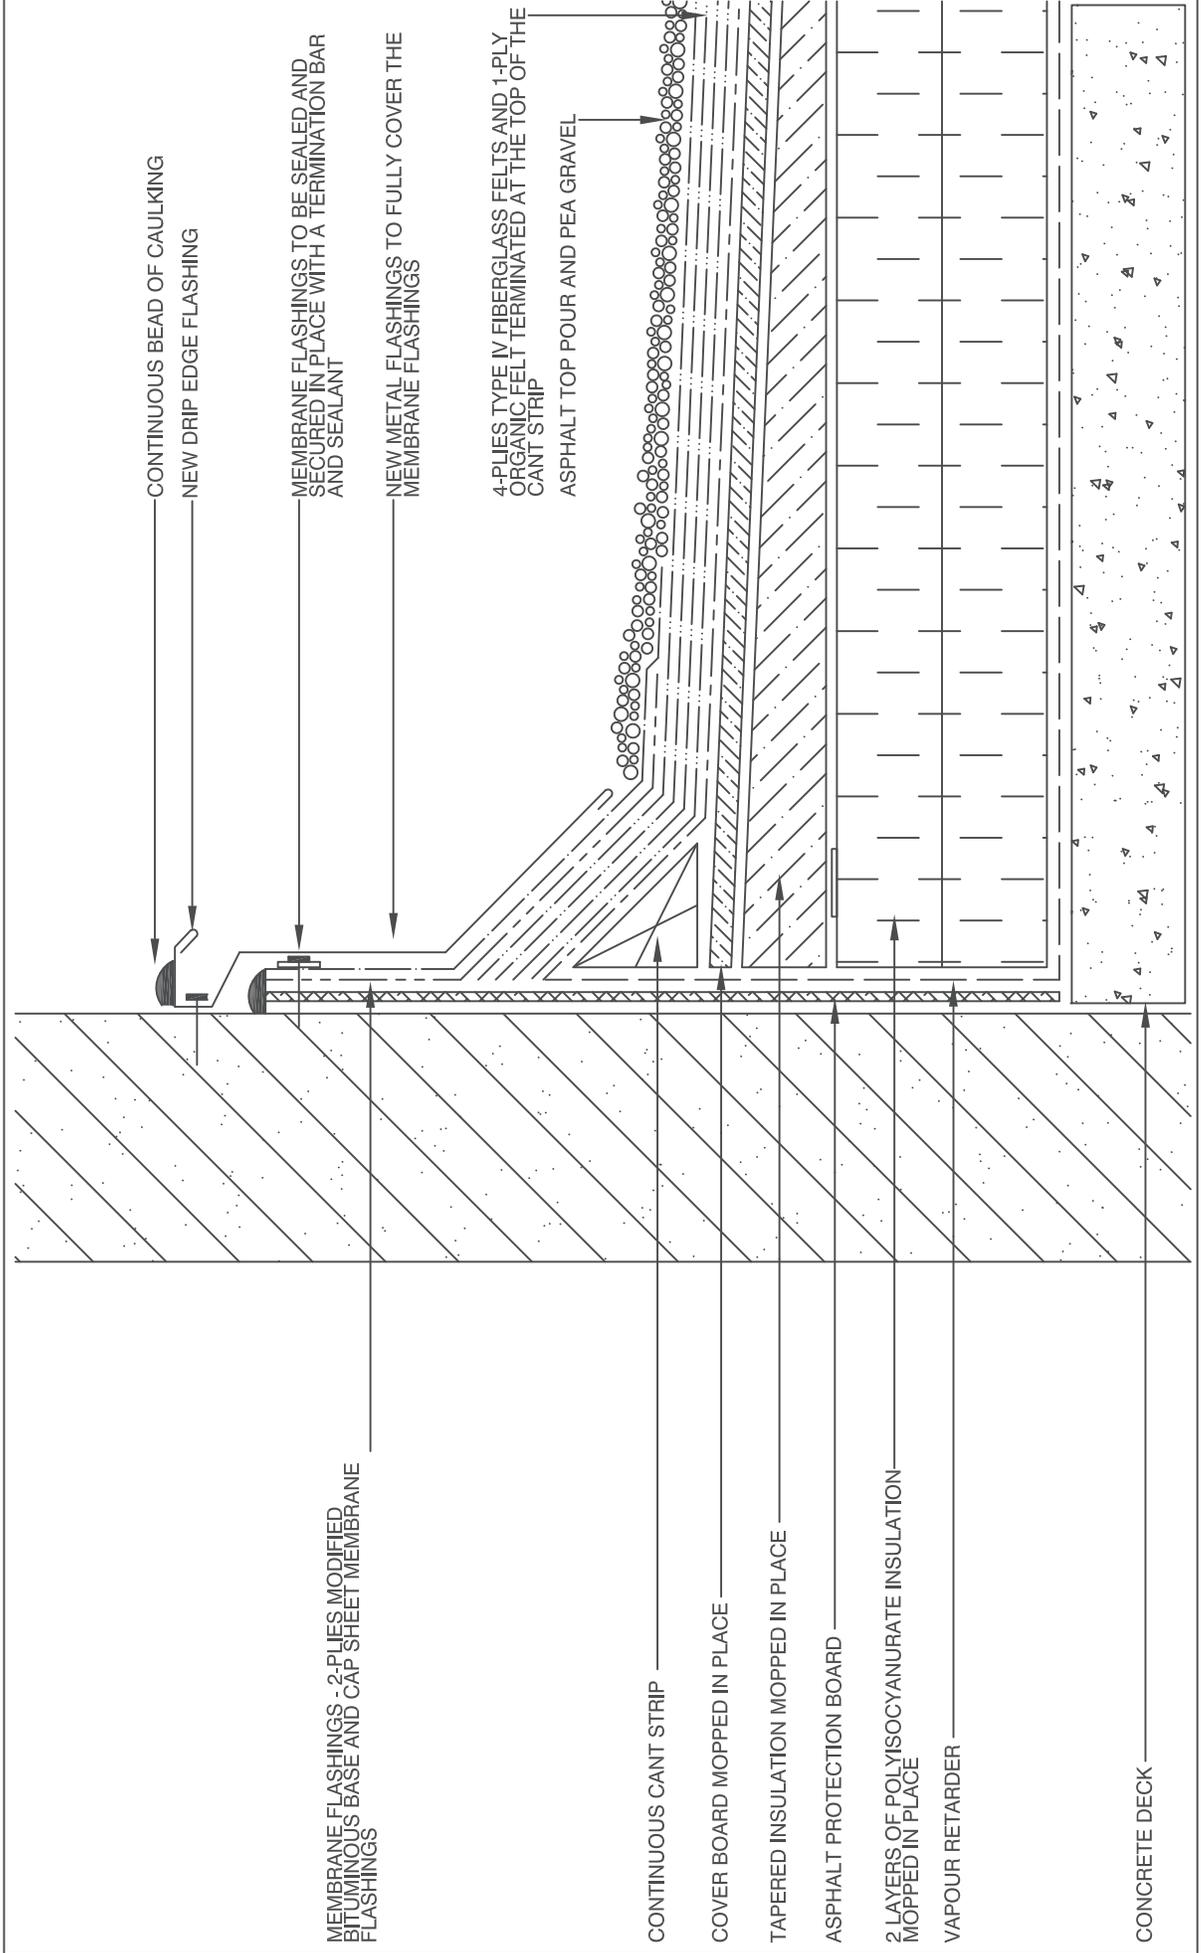NEW METAL FLASHINGS FASTENED IN PLACE

PIPE OPENINGS ARE TO BE SEALED WITH A REINFORCED PMMA LIQUID FLASHING

PIPES TO BE A MINIMUM of 12" ABOVE FINISHED ROOF HEIGHT

CURB TO BE FILLED WITH FIRE-RESISTANT BATT INSULATION

NEW 3/4" PLYWOOD

PRESSURE TREATED WOOD BLOCKING TO SUIT

TAPERED INSULATION

12 LAYERS OF POLYISOCYANURATE INSULATION MAPPED IN PLACE

TRI-TECH PINNACLE
 ROOF & BUILDING ENVELOPE CONSULTANTS

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 AURORA - ONTARIO - L4G 4C4
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CLIENT
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PROJECT ADDRESS
**OAKVILLE #3
 OAKVILLE, ON**

DRAWING TITLE
DOGHOUSE DETAIL


FILE NO. **22-0802**

SCALE **N.T.S.**

DATE **SEPTEMBER 2022**

DRAWING NUMBER
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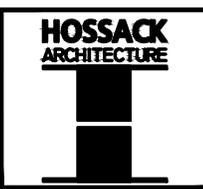


CONNECT TO
WEEPERS PLUG
AS PER
DRAWING CV-1


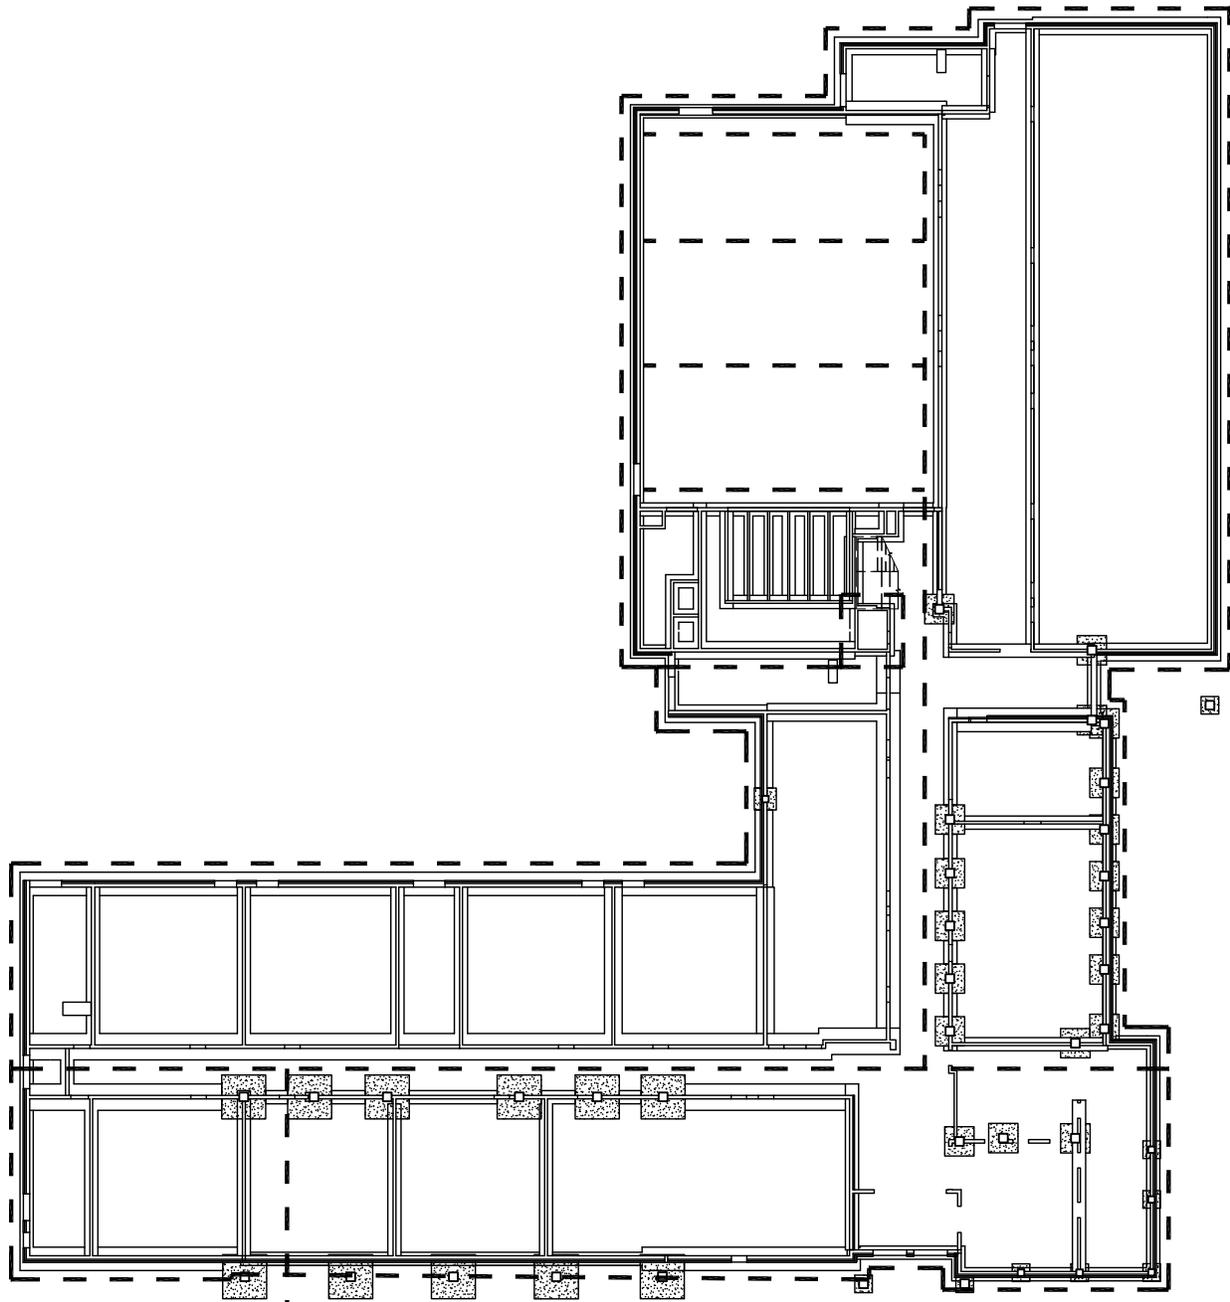
--- WEEPING TILE

**BUILDING WEEPING TILE
LOCATION PLAN**

PROJ: 22124
SCALE: 1:500
DRAWN: KB
DATE: 260105



ISSUE/REV.
00
**AD
100**

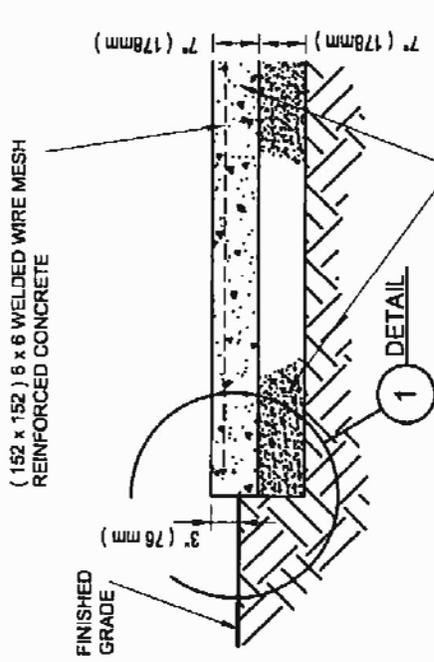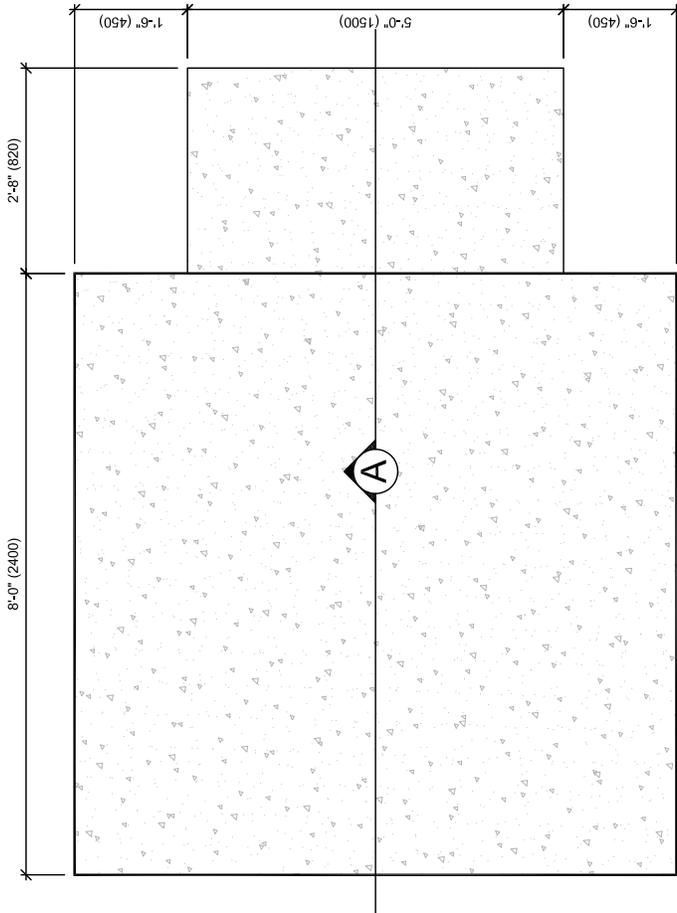

- POURED CONCRETE SLAB
 - 6" (152mm) 6% AIR, 75mm SLUMP.
 MIN COMPRESSIVE STRENGTH AT 28 DAYS 32 MPa. UNDER ALL
 CONDITIONS EXCAVATE TO A MIN. DEPTH OF 9" (228mm) TO
 PROVIDE FOR 6" GRANULAR BASE 19mm CRUSHES RUN LIMESTONE
 UNDER CONCRETE SLAB.

SECTION DETAIL 1


NOT TO SCALE

HEIGHT WITH CONC.
 STORAGE UNIT.
 REFER TO SPECS.

NOTE:
 TYPICAL AT ALL CONCRETE
 STORAGE BUNKERS. REFER TO
 SITE PLAN FOR LOCATIONS

PLAN OF SHED PAD

NOT TO SCALE

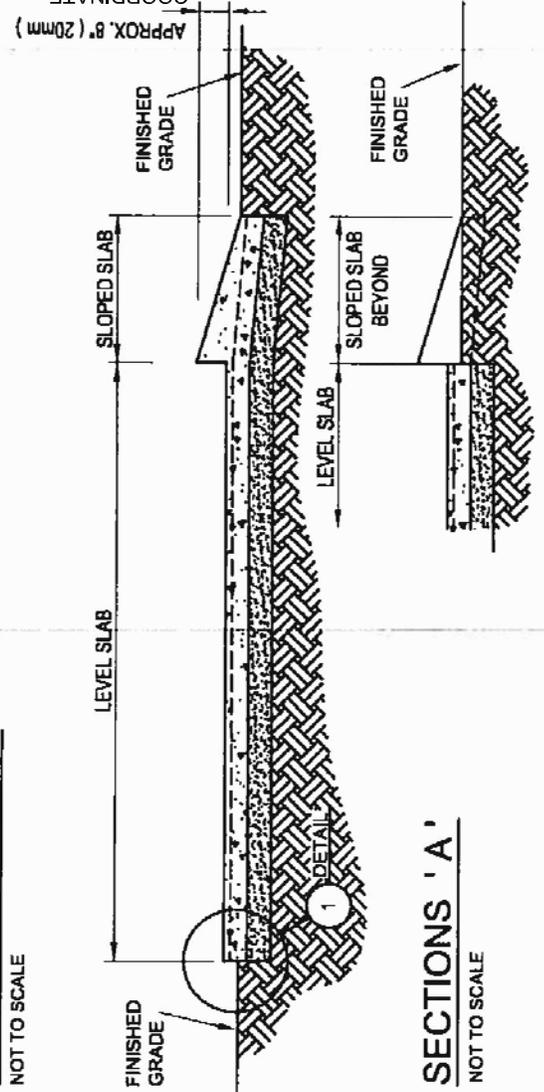

SECTIONS 'A'

NOT TO SCALE


CONCRETE STORAGE UNIT CONCRETE PAD
 TYPICAL AT ALL CONCRETE STORAGE BUNKERS.
 REFER TO SITE PLAN FOR LOCATIONS

| | |
|--------|--------|
| PROJ: | 22124 |
| SCALE: | N.T.S. |
| DRAWN: | KB |
| DATE: | 260105 |




ISSUE/REV. 00

AD 208

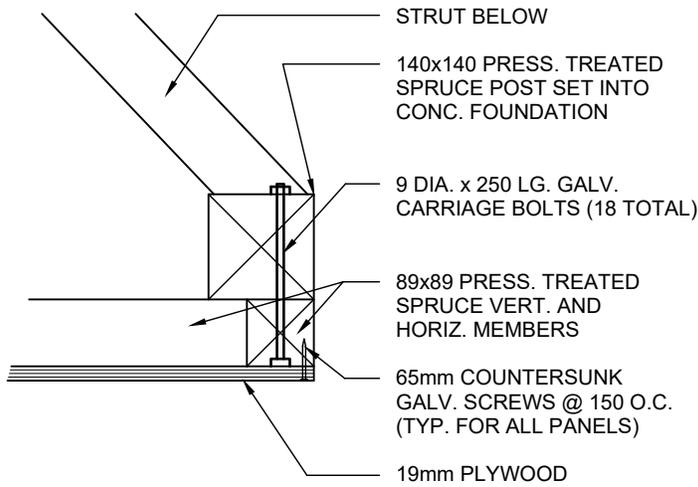

SECTION 1

SCALE: 1:5

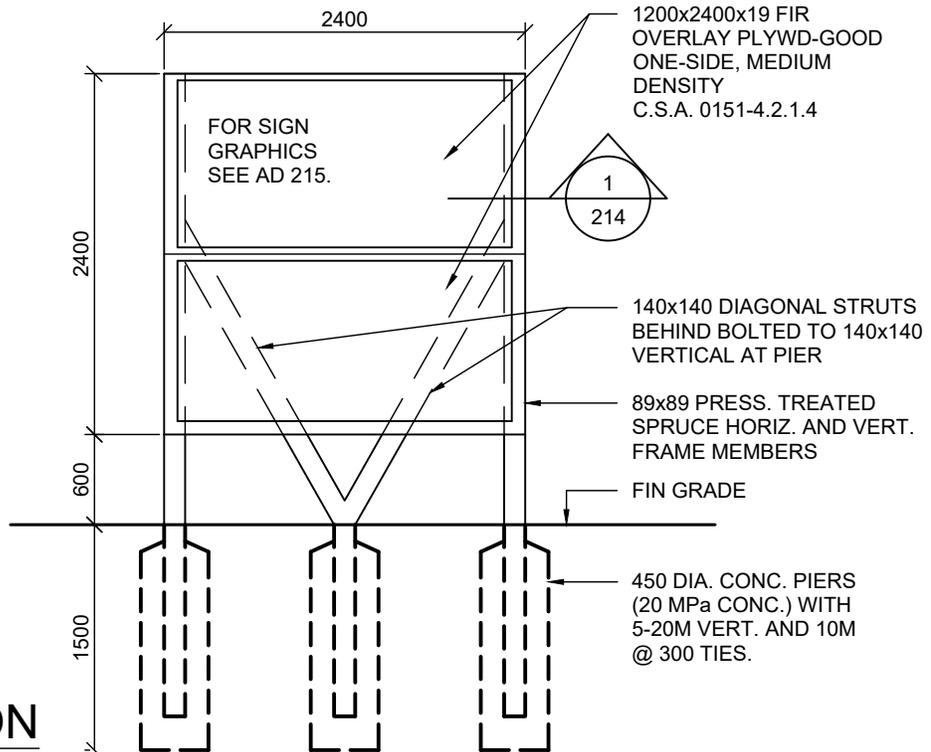

ELEVATION

SCALE: 1:50


JOB SITE SIGN

PROJ: 22124
SCALE: NOTED
DRAWN: GB
DATE: 260105




ISSUE/REV.

AD
214

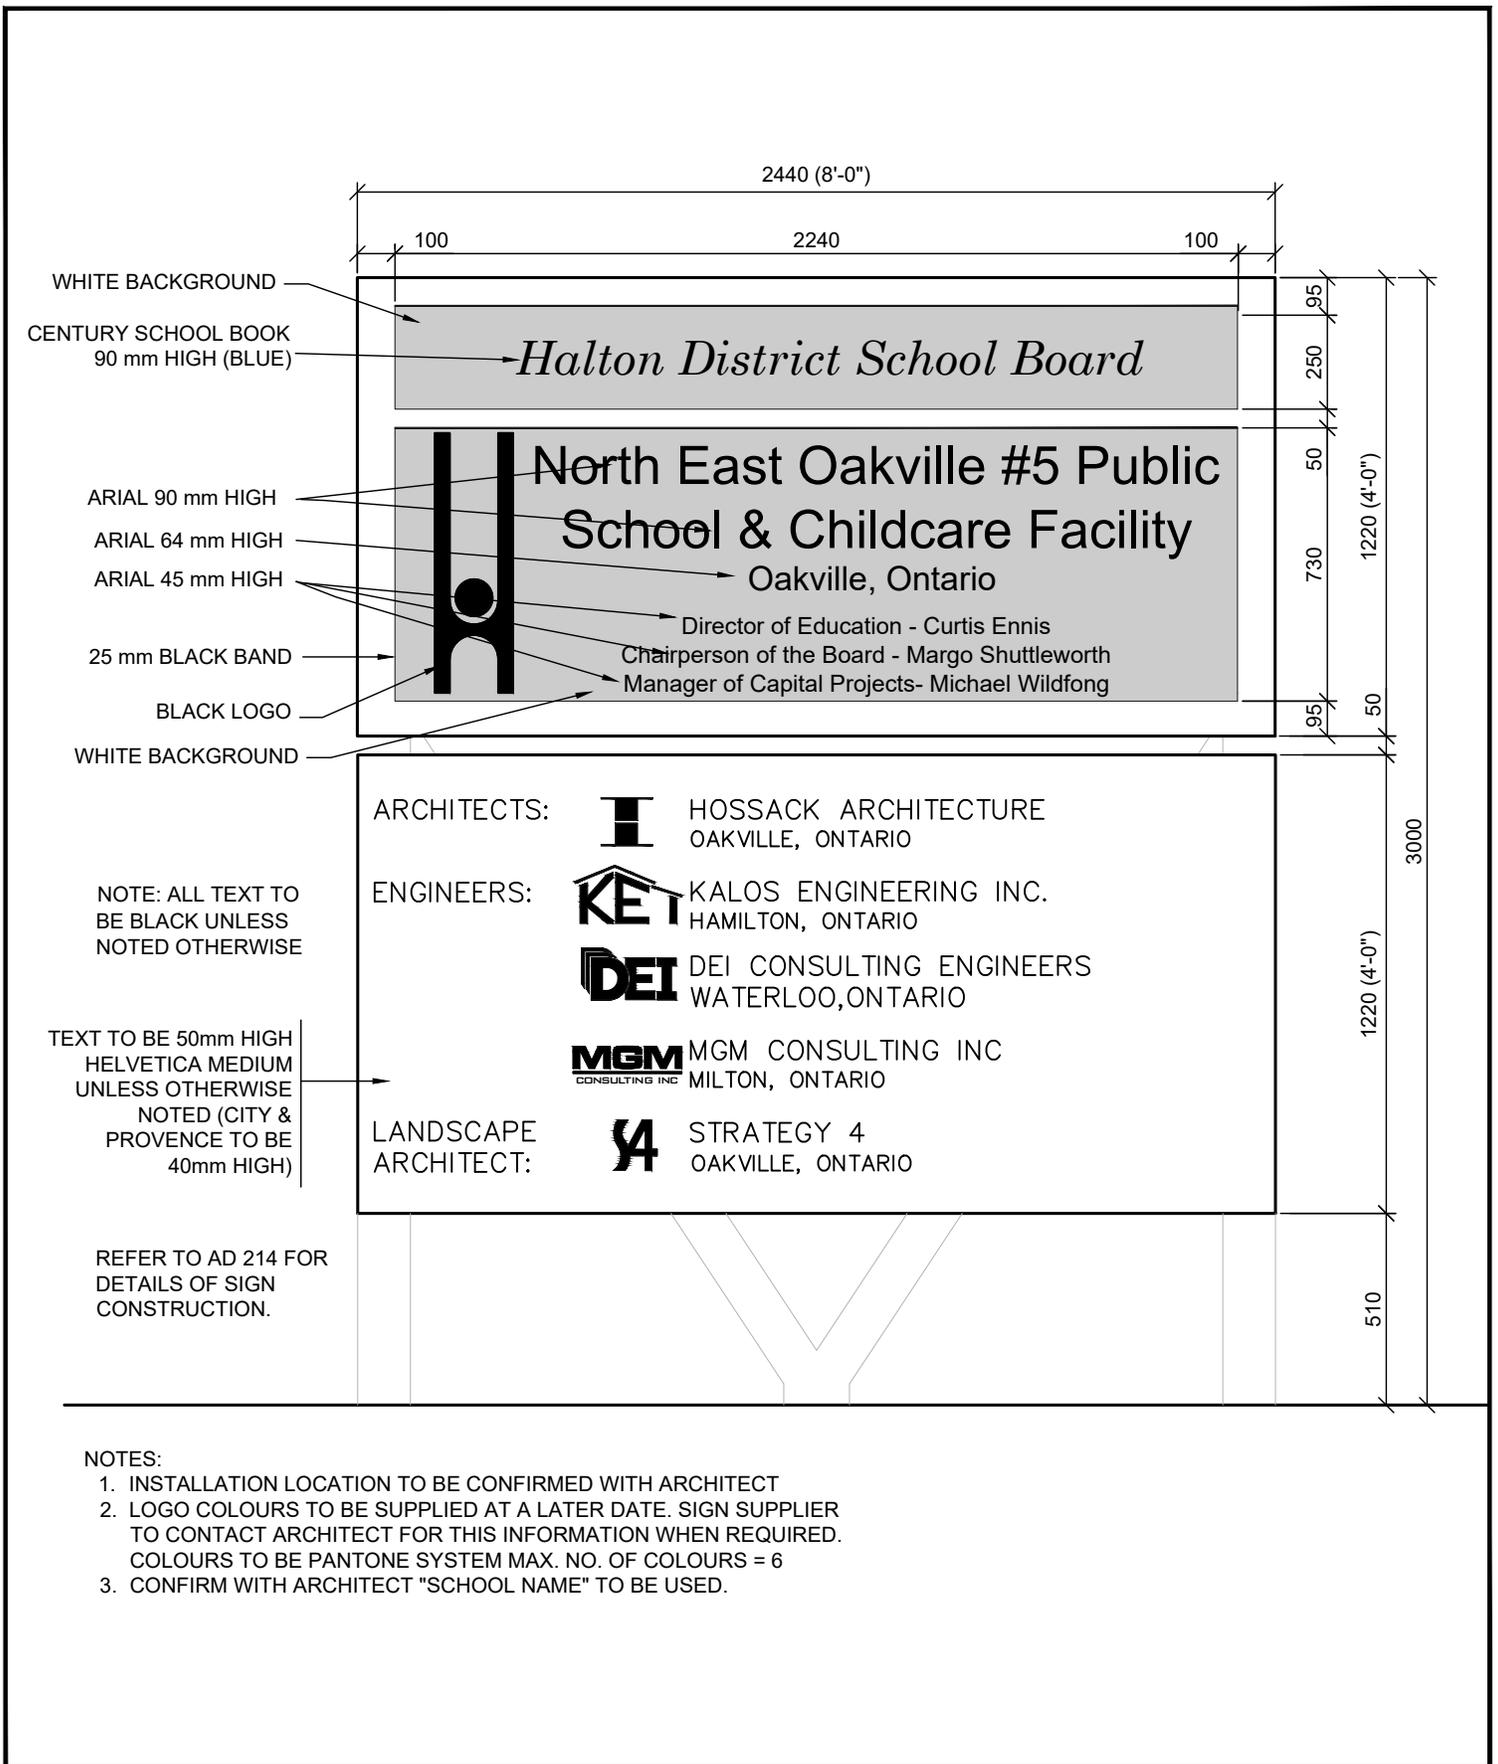

| | | | |
|----------------------|--------------|---|-------------------|
| JOB SITE SIGN | PROJ: 22124 |  | ISSUE/REV. |
| | SCALE: 1:20 | | AD 215 |
| | DRAWN: AM | | |
| | DATE: 260105 | | |

A

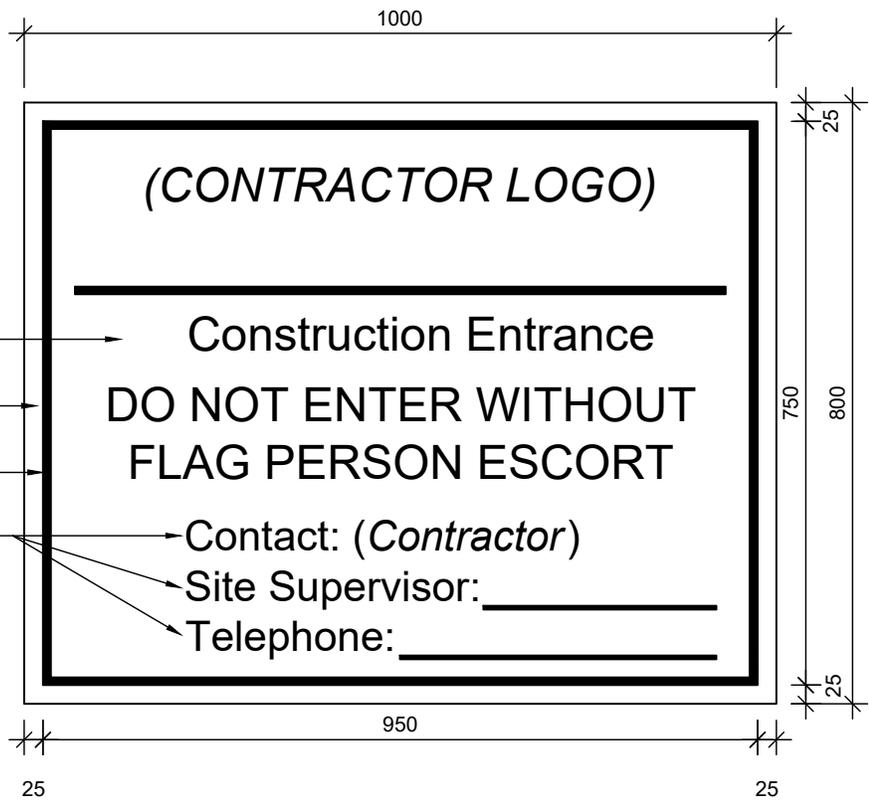

Arial 45 mm high (black)

Arial 45 mm high

15mm black band

Arial 40 mm high

Construction Entrance


DO NOT ENTER WITHOUT
FLAG PERSON ESCORT

Contact: (Contractor)

Site Supervisor: _____

Telephone: _____

B

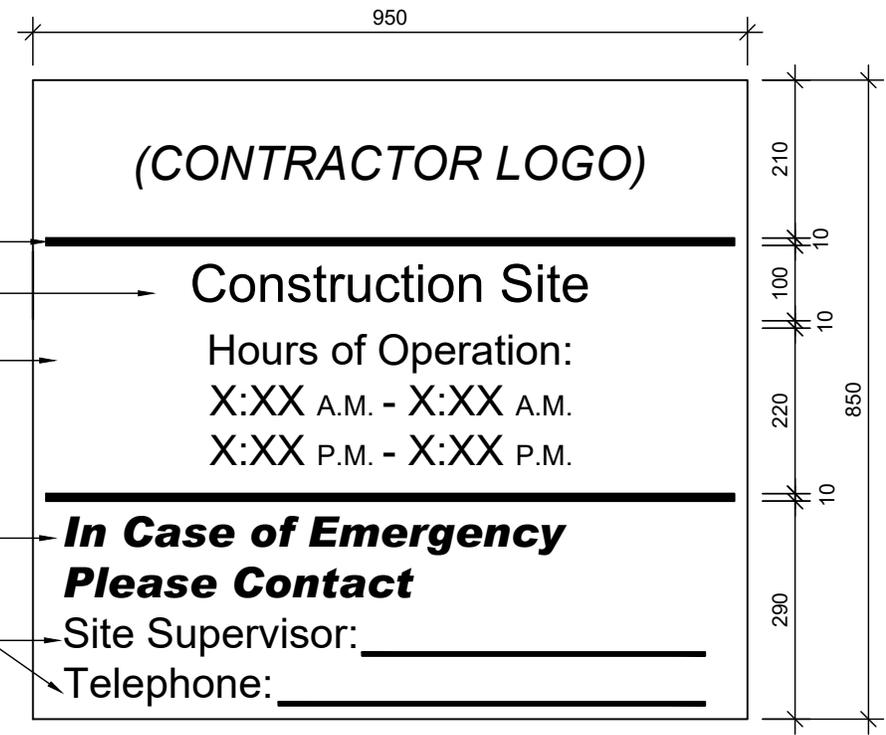

10mm black band

Arial 50 mm high

Arial 40 mm
high (black)

Arial 40 mm
high (black)

Arial 40 mm high

Construction Site

Hours of Operation:
X:XX A.M. - X:XX A.M.
X:XX P.M. - X:XX P.M.

**In Case of Emergency
Please Contact**

Site Supervisor: _____

Telephone: _____


JOB SITE SIGNAGE

| | |
|--------|--------|
| PROJ: | 22124 |
| SCALE: | 1:10 |
| DRAWN: | GB |
| DATE: | 260105 |





ISSUE/REV.
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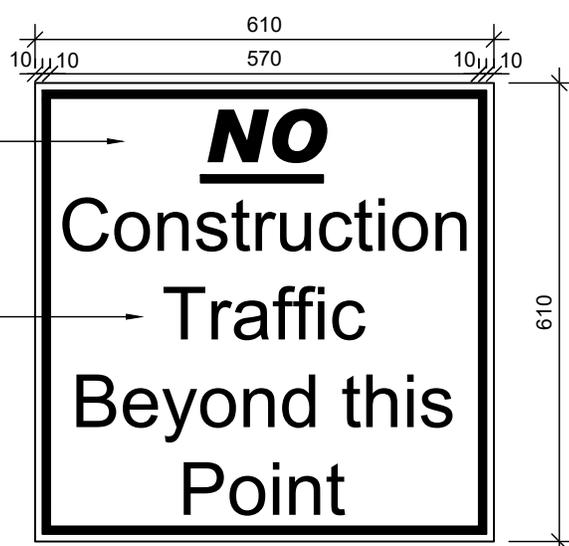
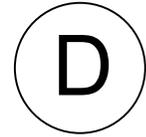
AD
257A

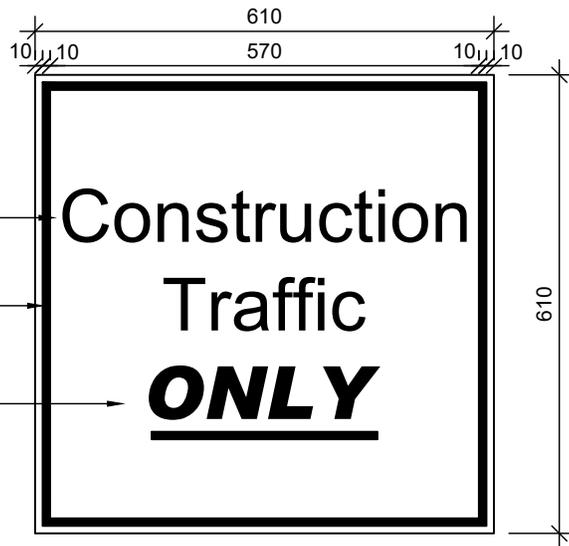

Arial 70 mm high
 10mm black band
 Arial 70 mm high (black)

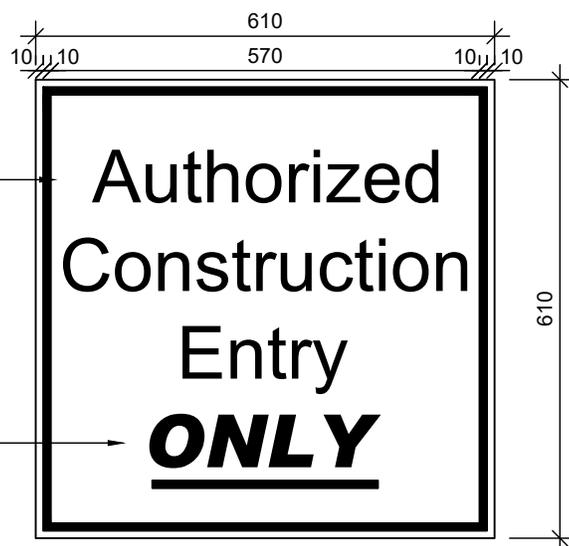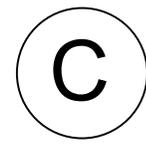

Arial 70 mm high
 Arial 70 mm high (black)



Arial 70 mm high (black)
 Arial 70 mm high




JOB SITE SIGNAGE


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| PROJ: | 22124 |
| SCALE: | 1:10 |
| DRAWN: | GB |
| DATE: | 260105 |




| | |
|------------|------|
| ISSUE/REV. | 00 |
| AD | 257B |

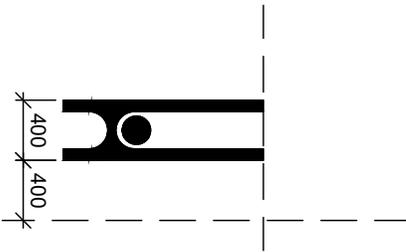

SIGNAGE 1
HDSB LOGO

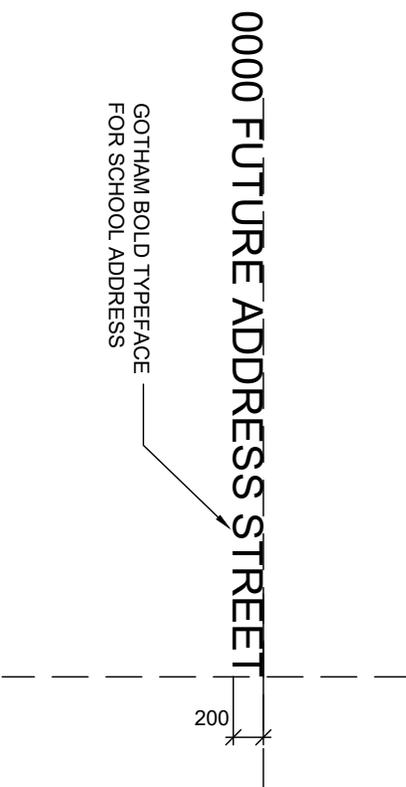

SIGNAGE 2
SCHOOL ADDRESS

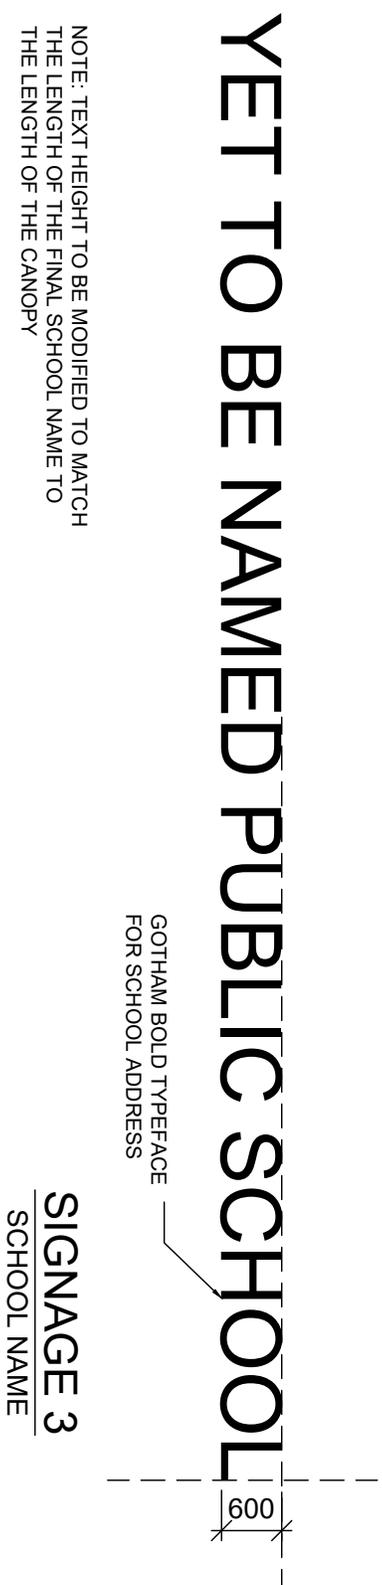

SIGNAGE 3
SCHOOL NAME

NOTE: TEXT HEIGHT TO BE MODIFIED TO MATCH THE LENGTH OF THE FINAL SCHOOL NAME TO THE LENGTH OF THE CANOPY

NOTE: REFER TO A09 EXTERIOR ELEVATIONS FOR SIGNAGE LOCATION


ISSUE/REV.

AD
259



| | |
|--------|--------|
| PROJ: | 22124 |
| SCALE: | NTS |
| DRAWN: | AM |
| DATE: | 260105 |

EXTERIOR BUILDING SIGNAGE
(CASH ALLOWANCE)

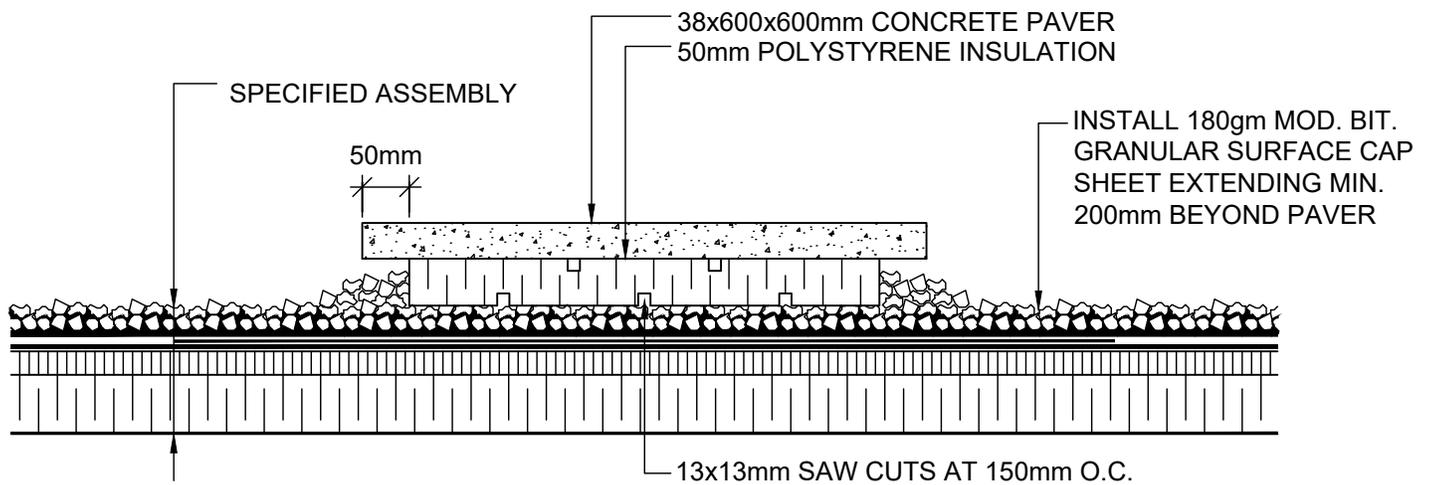



ROOF CONCRETE PAVER DETAIL

| | |
|--------|--------|
| PROJ: | 22124 |
| SCALE: | 1:8 |
| DRAWN: | KB |
| DATE: | 260105 |



ISSUE/REV.

AD
302

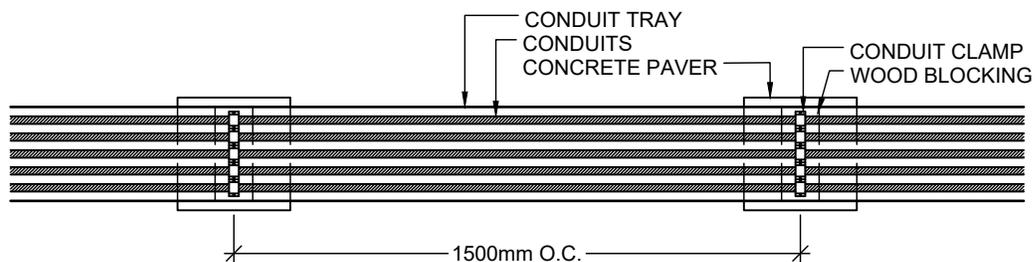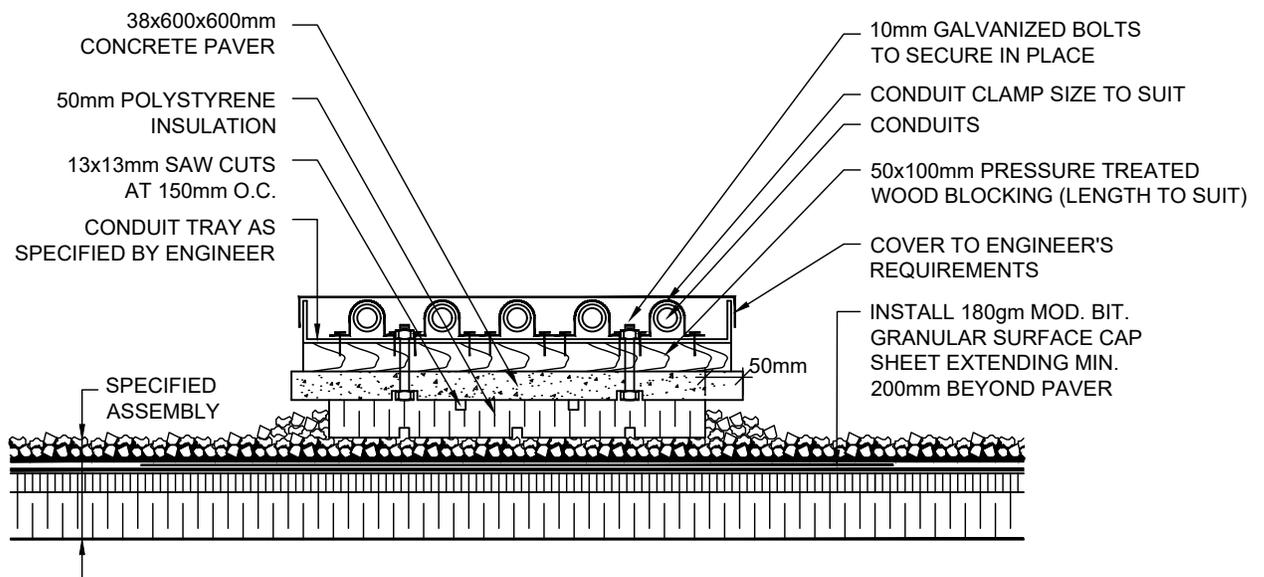


CONDUIT ROOF PAVER DETAIL

PROJ: 22124
 SCALE: 1:10
 DRAWN: KB
 DATE: 260105



ISSUE/REV.

AD
 303

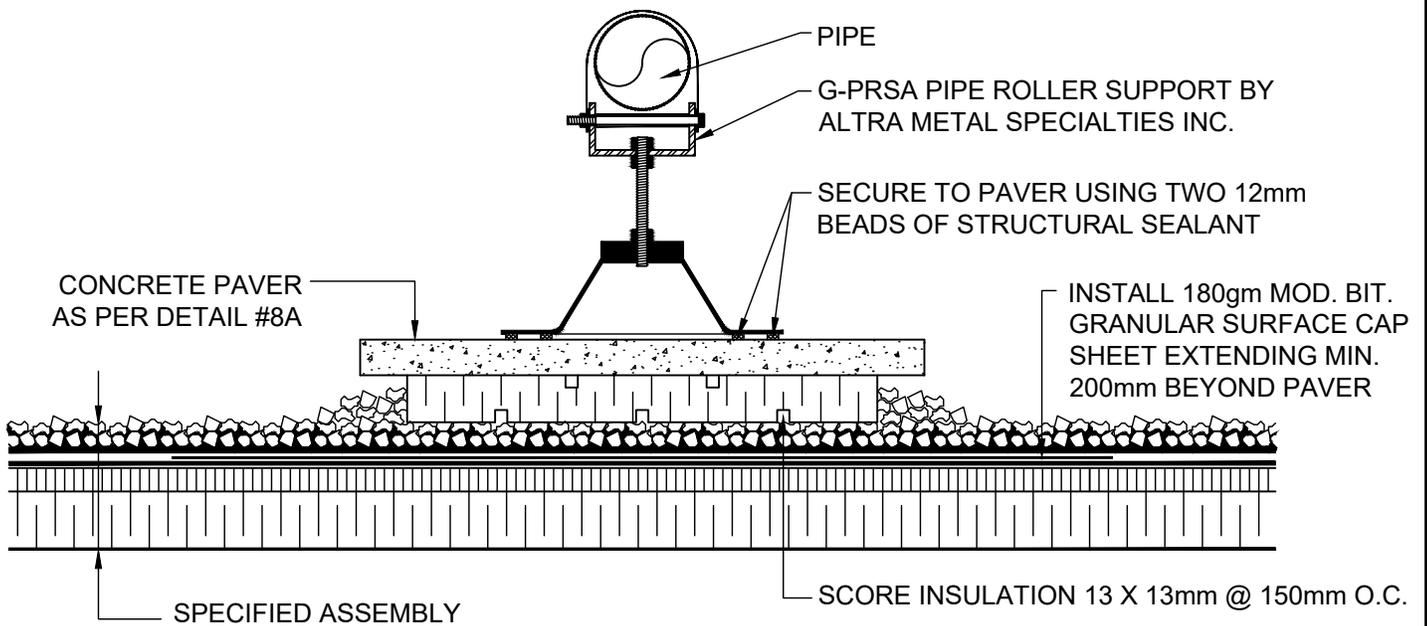

NOTE:

1. THIS DETAIL APPLIES FOR PIPES UP TO 100mm IN DIAMETER ONLY.


PIPE ROLLER ROOF PAVER DETAIL

| | |
|--------|--------|
| PROJ: | 22124 |
| SCALE: | 1:8 |
| DRAWN: | KB |
| DATE: | 260105 |



ISSUE/REV.

AD
304

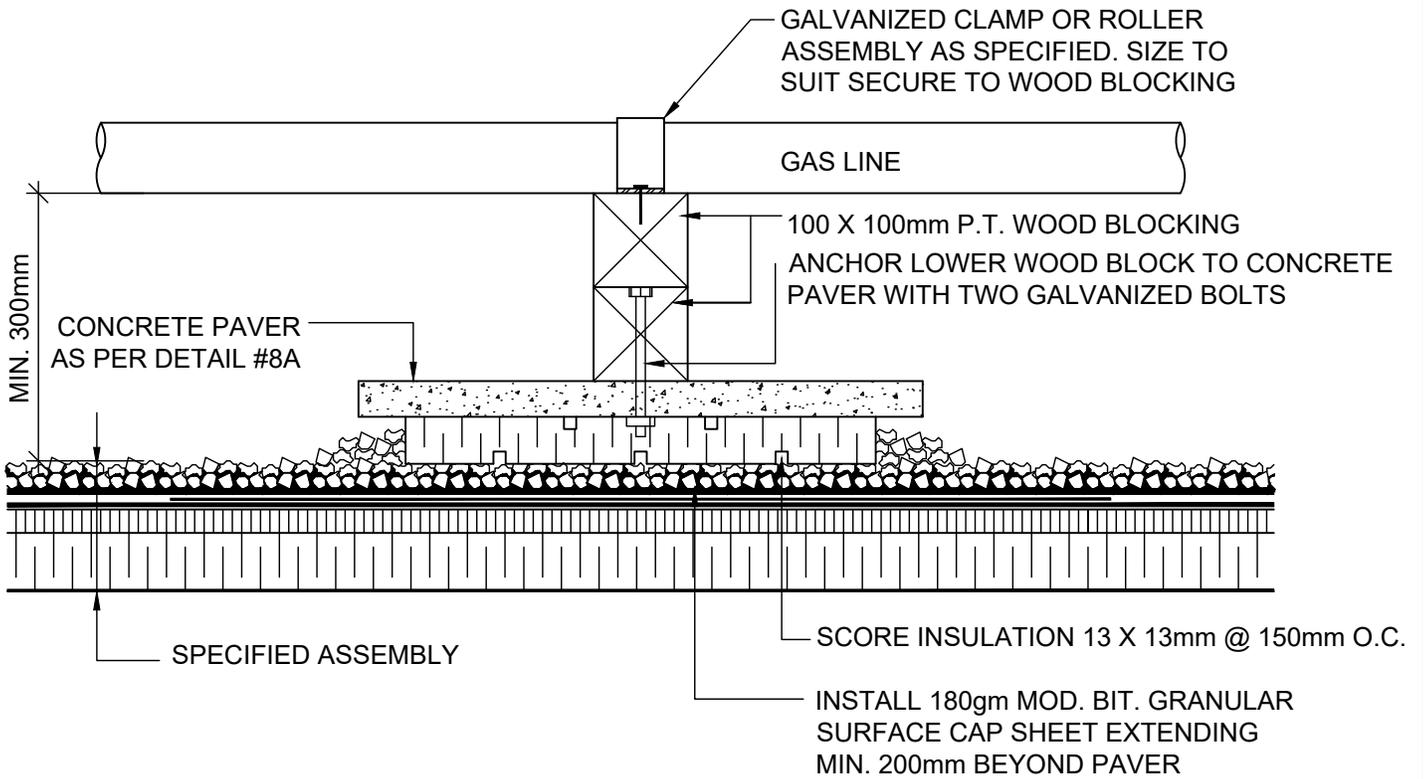


PIPE SUPPORT ROOF PAVER DETAIL

PROJ: 22124
 SCALE: 1:8
 DRAWN: KB
 DATE: 260105




ISSUE/REV.

AD
 305

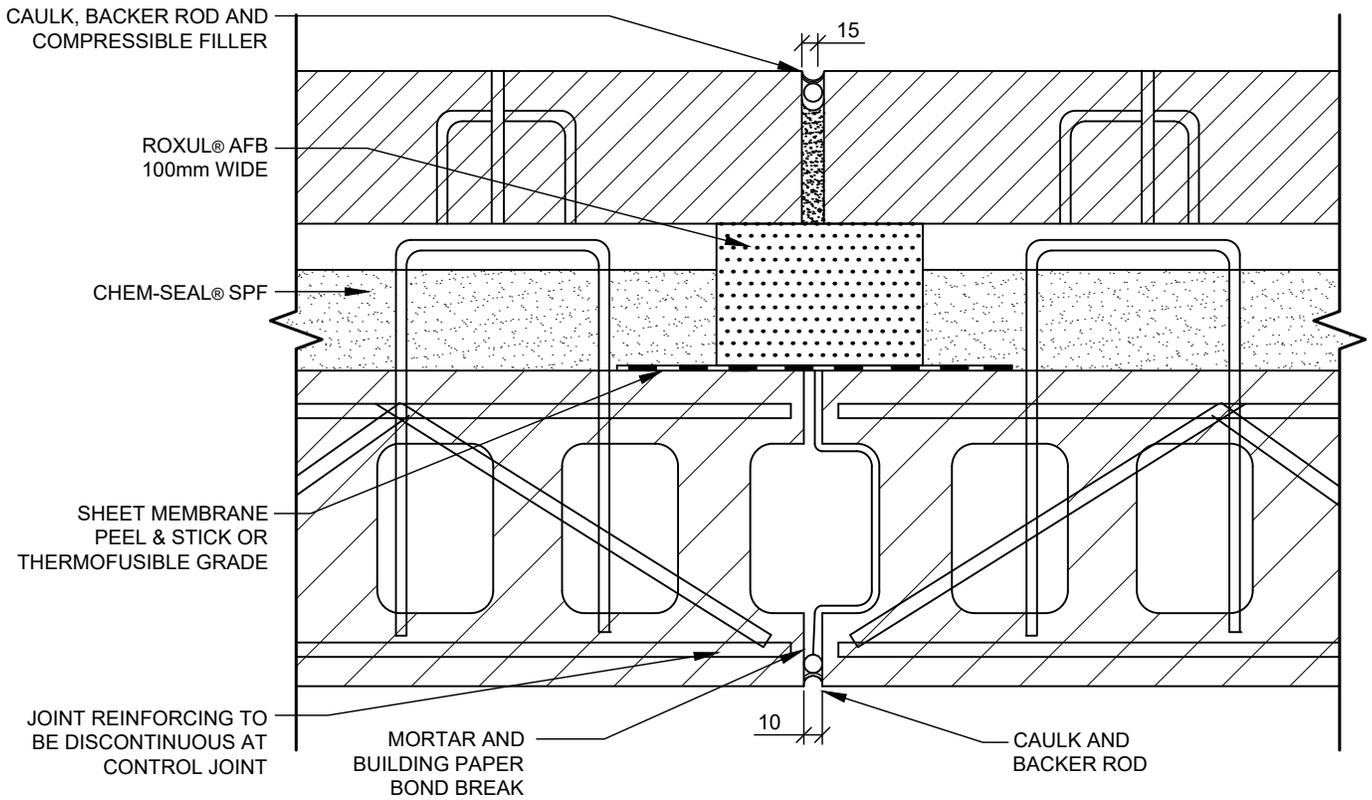

VERTICAL FIRE STOPPING

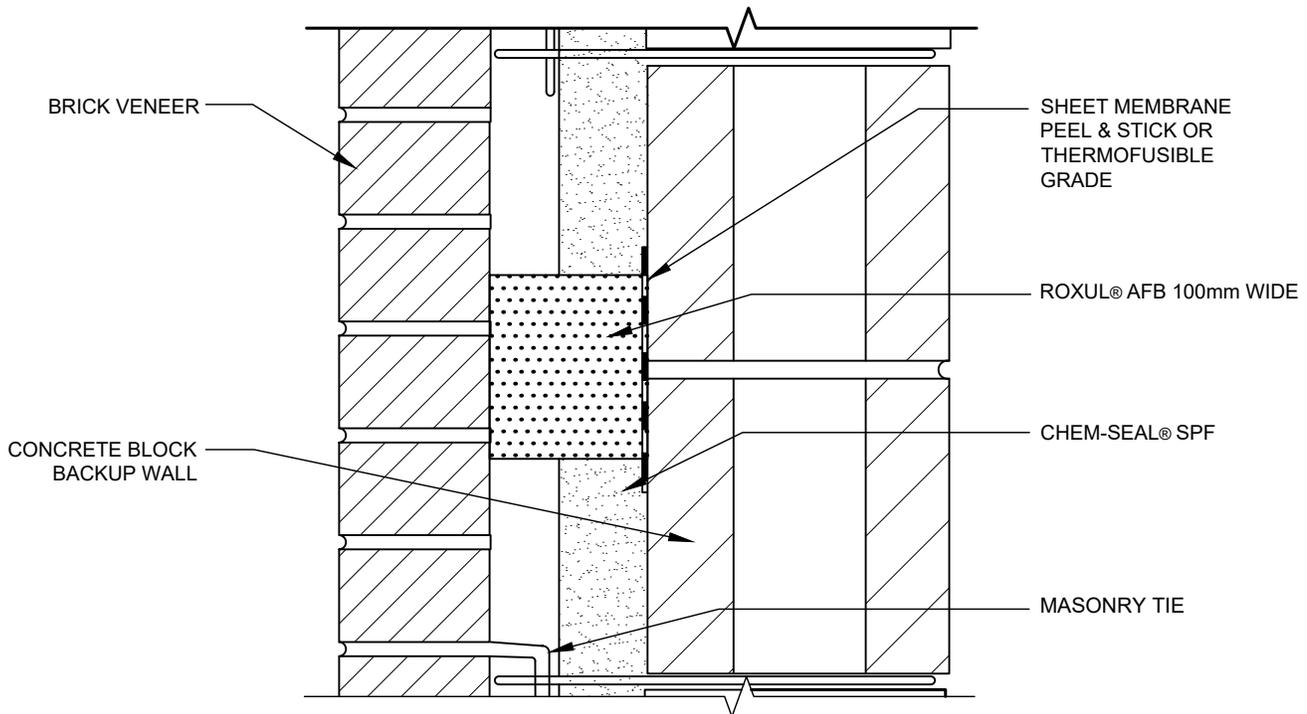

HORIZONTAL FIRE STOPPING

FIRESTOPPING DETAIL AT CAVITY WALL


PROJ: 22124
 SCALE: 1:5
 DRAWN: GB
 DATE: 260105



ISSUE/REV.
00

AD
400

WALL CONSTRUCTION:
FACE BRICK
AIR SPACE
INSULATION
CONC. BLOCK

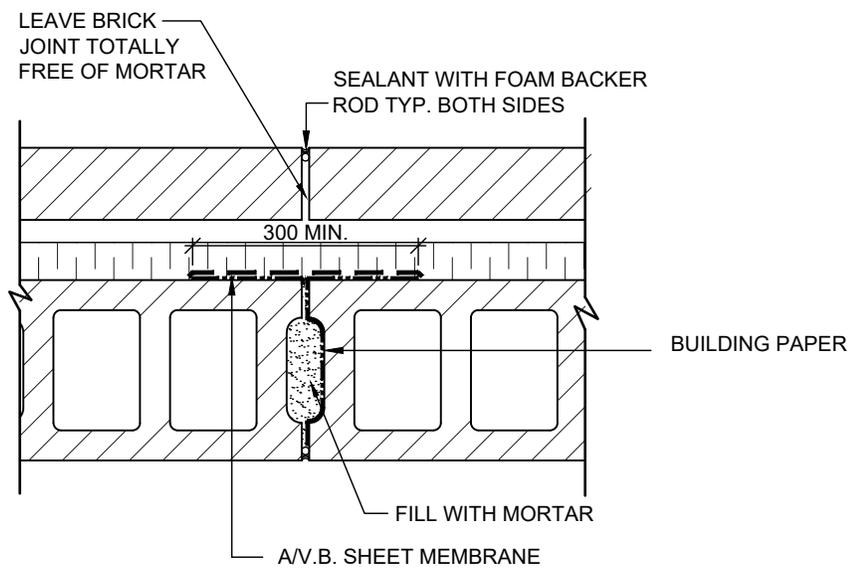


EXTERIOR CAVITY WALL CONTROL JOINT DETAIL

PROJ: 22124
SCALE: NTS
DRAWN: GB
DATE: 260105




ISSUE/REV.
00


AD
410

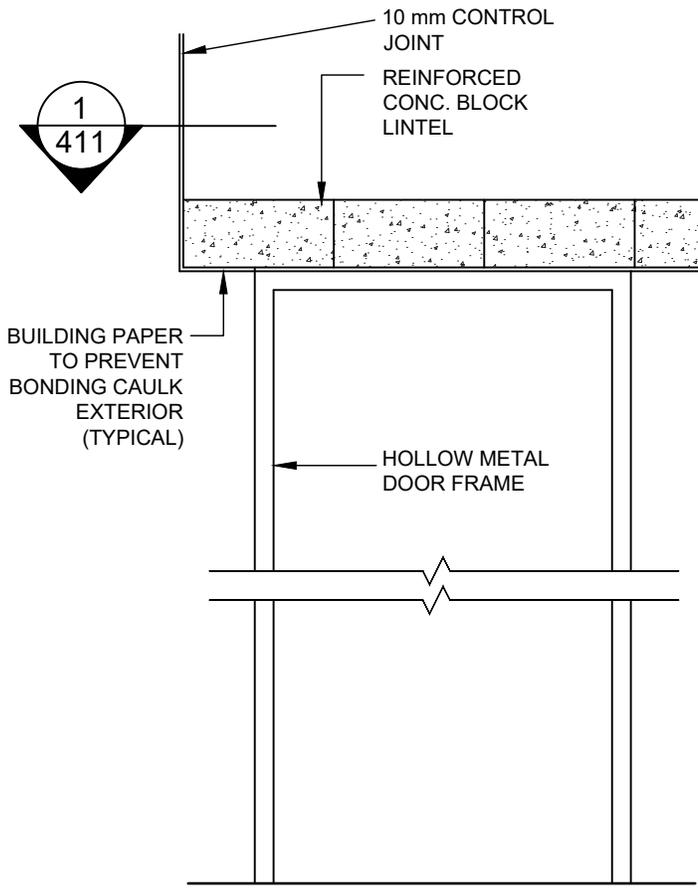

1 DOOR CONTROL JOINT
AD411 SCALE 1:20

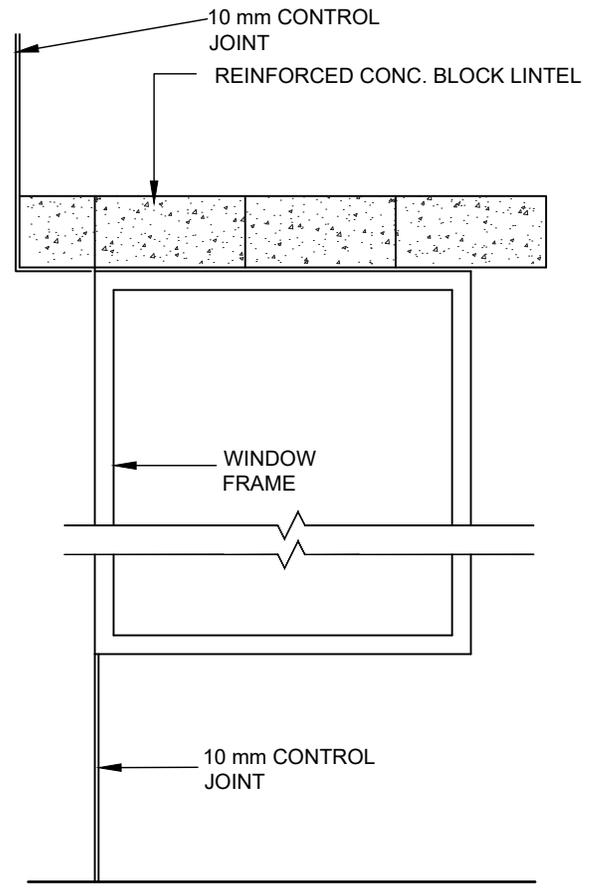

2 WINDOW CONTROL JOINT
AD411 SCALE 1:20

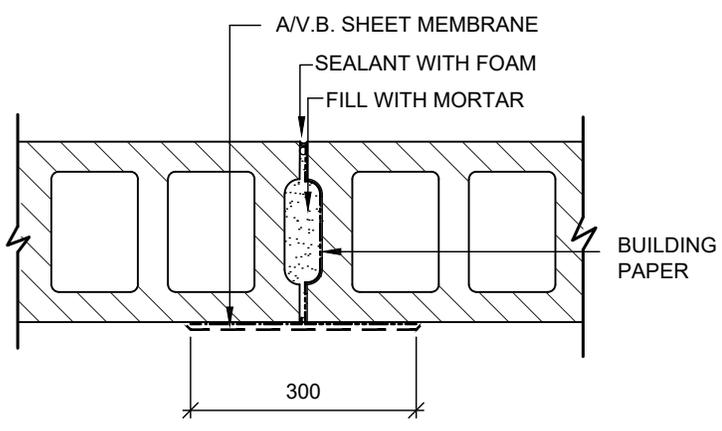


3 PLAN DETAIL
AD411 SCALE 1:10

**WALL CONTROL JOINT DETAILS
INTERIOR SIDE**


| | |
|--------|--------|
| PROJ: | 22124 |
| SCALE: | NOTED |
| DRAWN: | GB |
| DATE: | 260105 |




| | |
|------------|-----|
| ISSUE/REV. | 00 |
| AD | 411 |

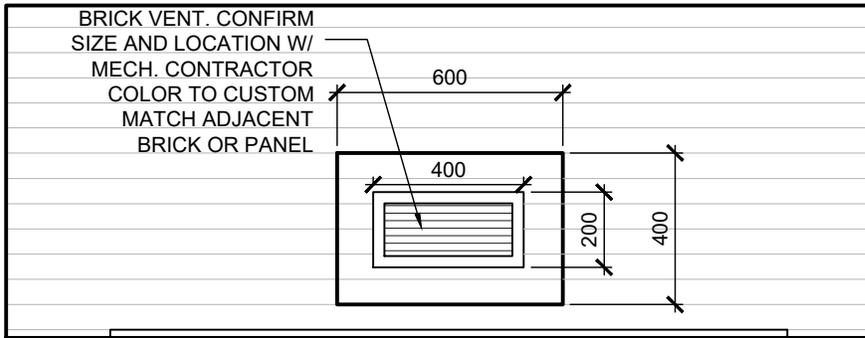

1 BRICK VENT DETAIL
AD412

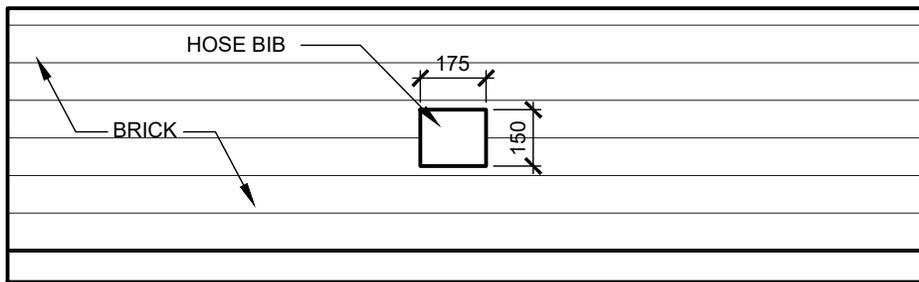

2 HOSE BIB DETAIL
AD412

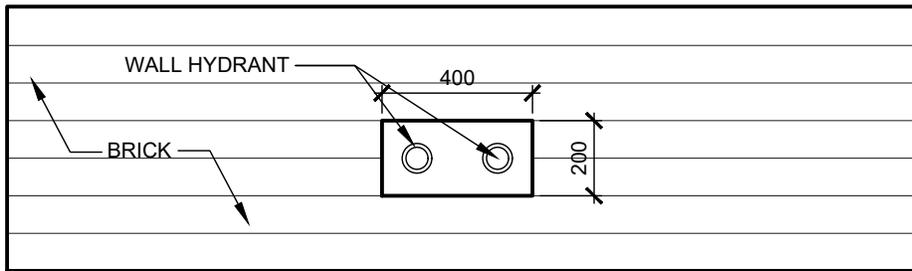

3 WALL HYDRANT DETAIL
AD412

BRICK VENT DETAILS

PROJ: 22124
SCALE: NTS
DRAWN: GB
DATE: 260105




ISSUE/REV.
00

AD
412

NOTE: REFER TO GROUND FLOOR PLAN FOR LOCATION ADJACENT TO THE MAIN ENTRANCE

NOTE: DATE ON STONE TO BE CONFIRMED BY OWNER PRIOR TO FABRICATION

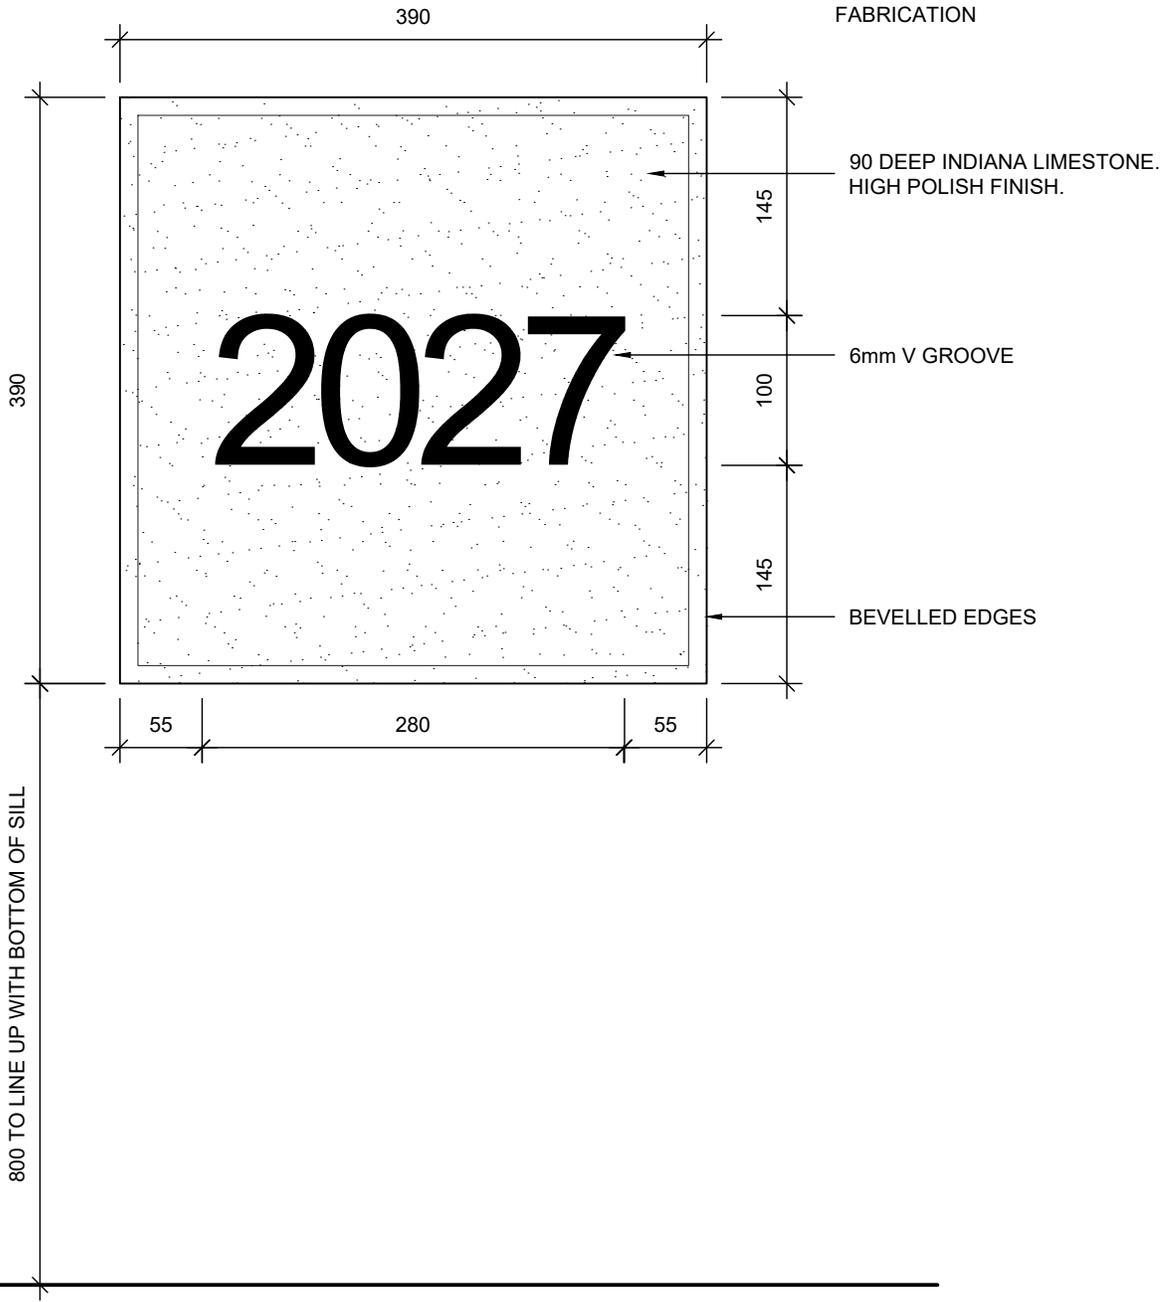

DATE STONE


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|--------|--------|
| PROJ: | 22124 |
| SCALE: | 1:5 |
| DRAWN: | GB |
| DATE: | 260105 |



ISSUE/REV.

AD
413


**CONDITION AT OFFSET
BEAM / JOIST AT ROOF**

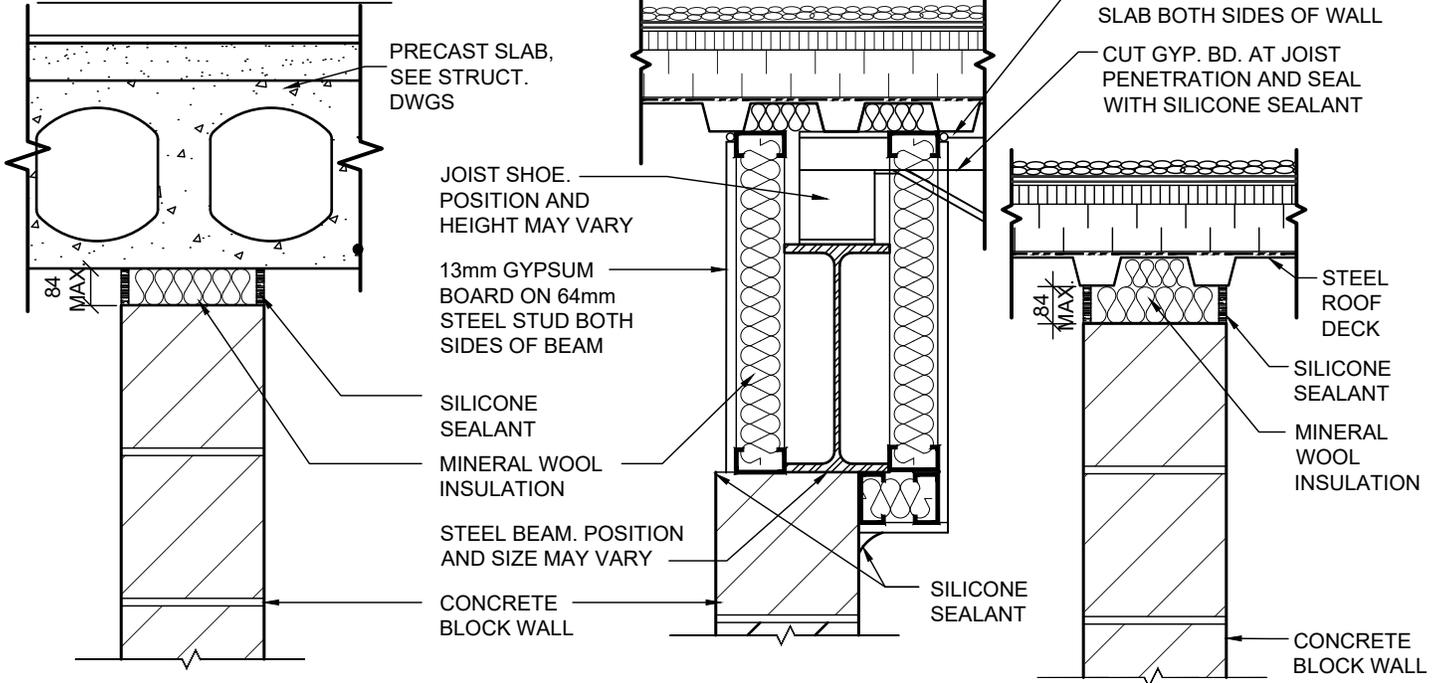

CONDITION AT FLOOR

CONDITION AT FLOOR

CONDITION AT ROOF

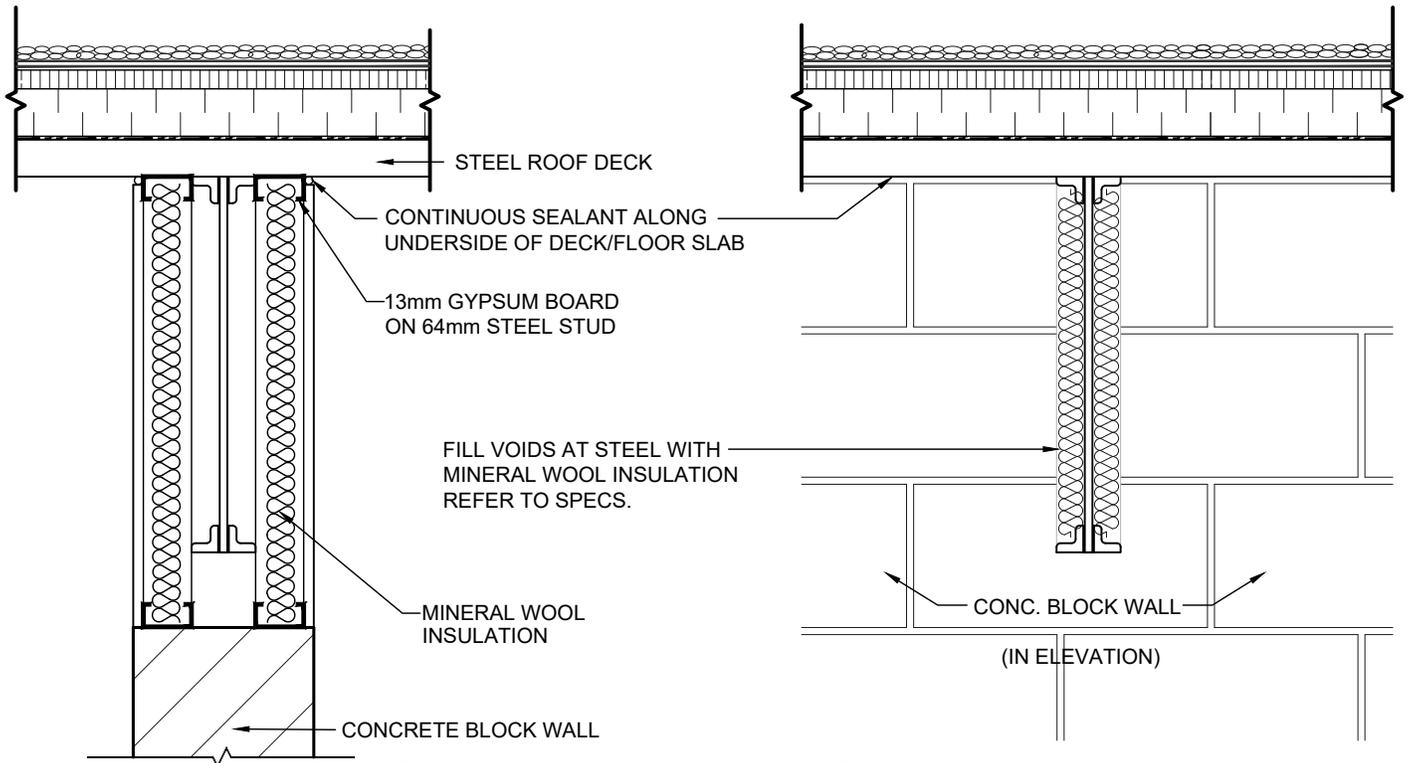

**CONDITION AT PARALLEL
JOIST OR BEAM**

NOTE: ADJUST STEEL STUD SIZES TO
SUIT BLOCK WALL CONDITION.
MIN. 64mm STUD AT MAX. 400 O.C.
REF. SPECS FOR FIRE-RATED SEALANTS

**CONDITION AT PERPENDICULAR
JOIST OR BEAM**


**TOP OF WALL CONSTRUCTION AT
NON-FIRE RATED ASSEMBLIES**

PROJ: 22124
SCALE: 1:5
DRAWN: CC
DATE: 260105




ISSUE/REV.
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AD
450

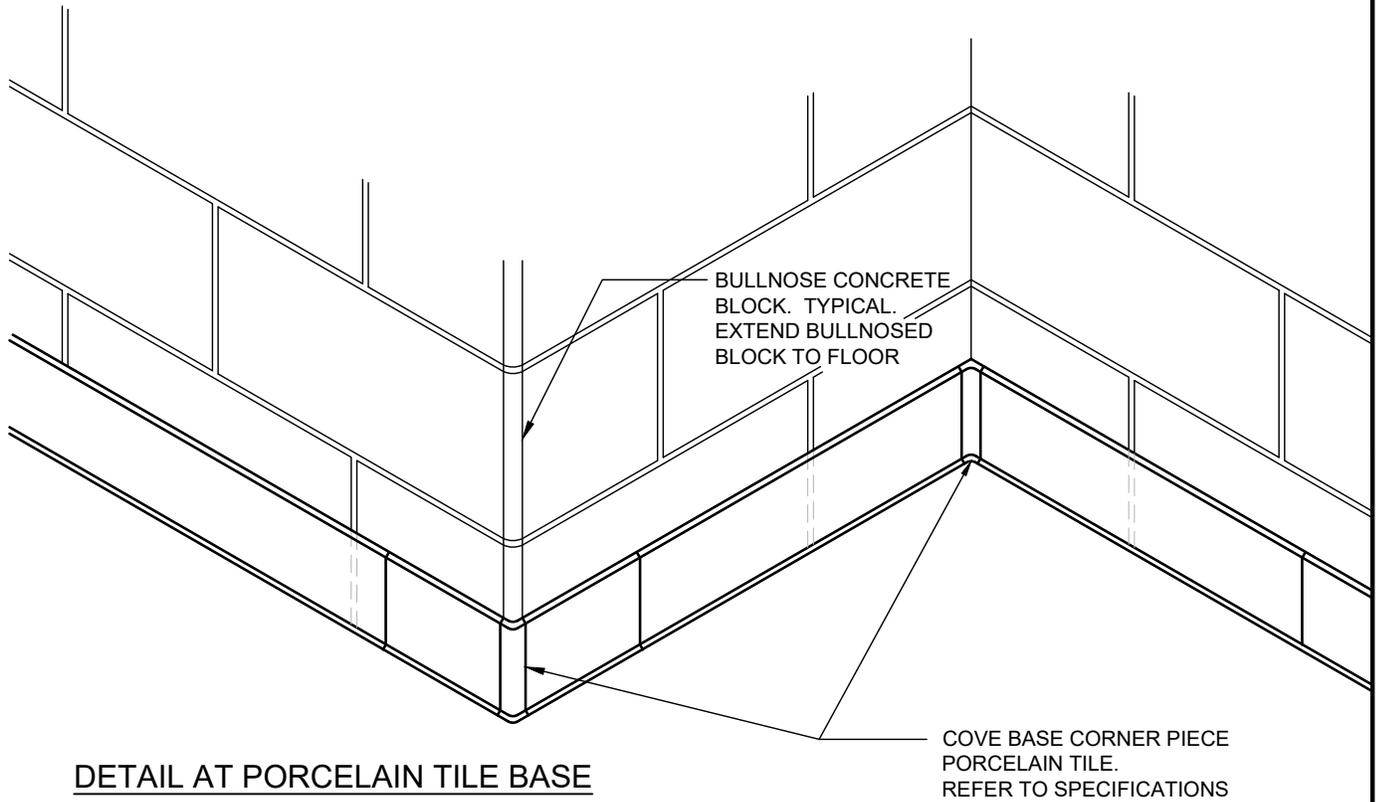

DETAIL AT PORCELAIN TILE BASE

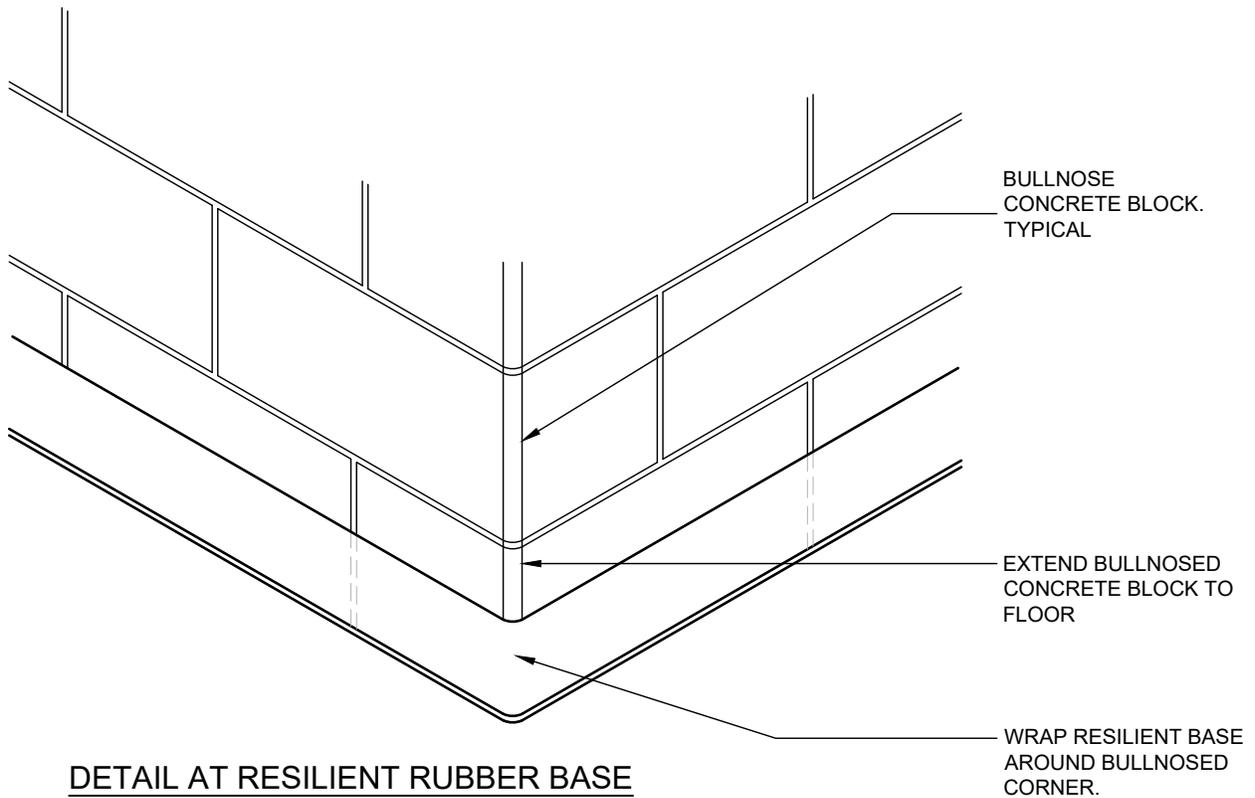

DETAIL AT RESILIENT RUBBER BASE

PORCELAIN TILE BASE

PROJ: 22124

SCALE: NTS



DRAWN: GB

DATE: 260105



ISSUE/REV.
00

AD
501

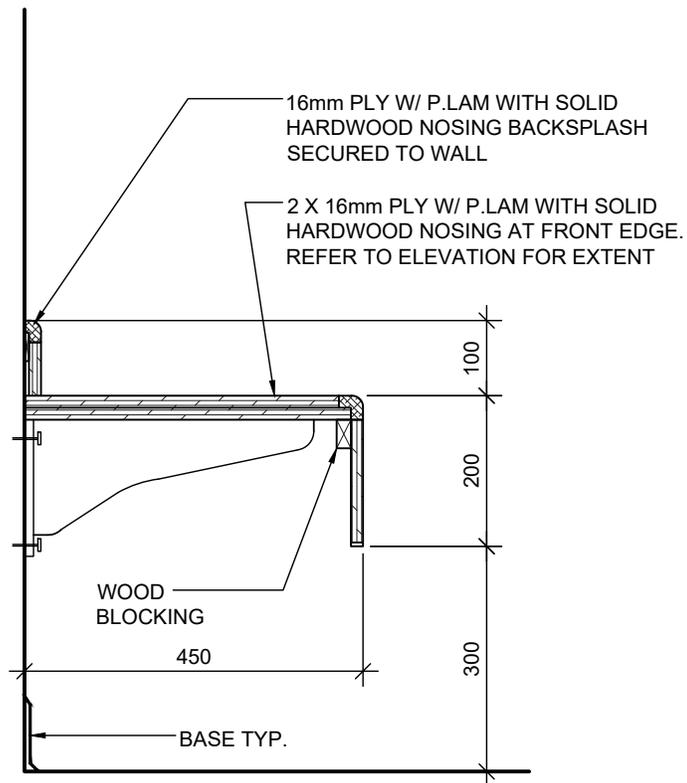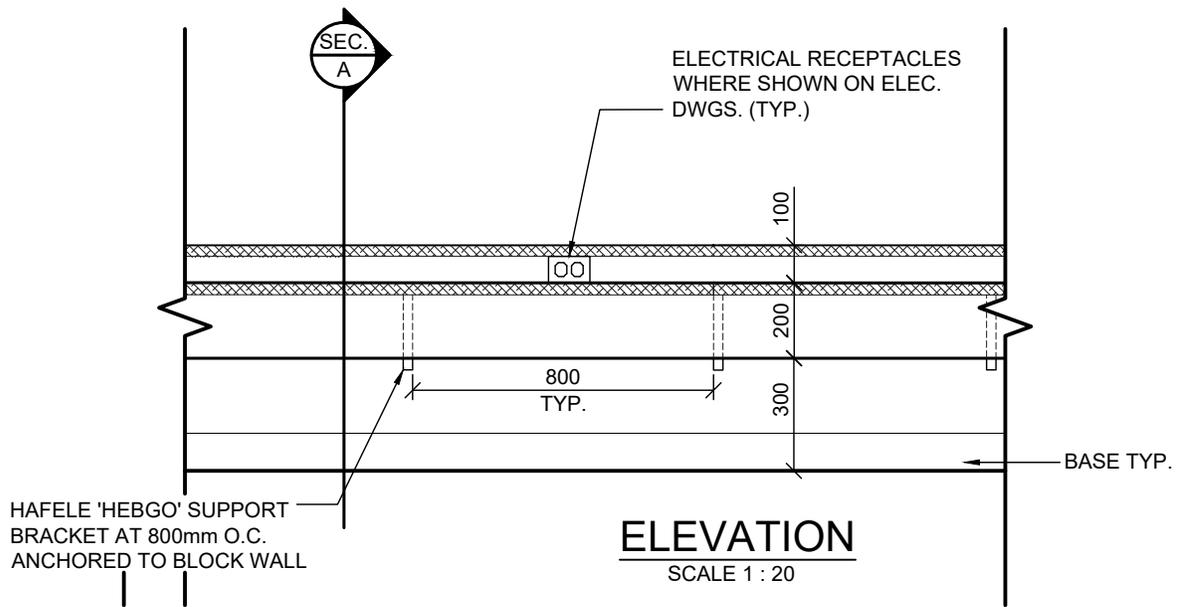

NOTES:
REFER TO SPECIFICATIONS FOR MILLWORK CONSTRUCTION AND HARDWARE.
CONFIRM UNIT SIZE WITH INTERIOR ELEVATIONS. TYP.
REFER TO ELEC. DWGS FOR LOCATIONS AND QUANTITY OF RECEPTACLES

SECTION A
1:10


BENCH M2
REFER TO FLOOR PLANS FOR LOCATIONS

PROJ: 22124
SCALE: NOTED
DRAWN: CC
DATE: 260105



ISSUE/REV.

AD
502

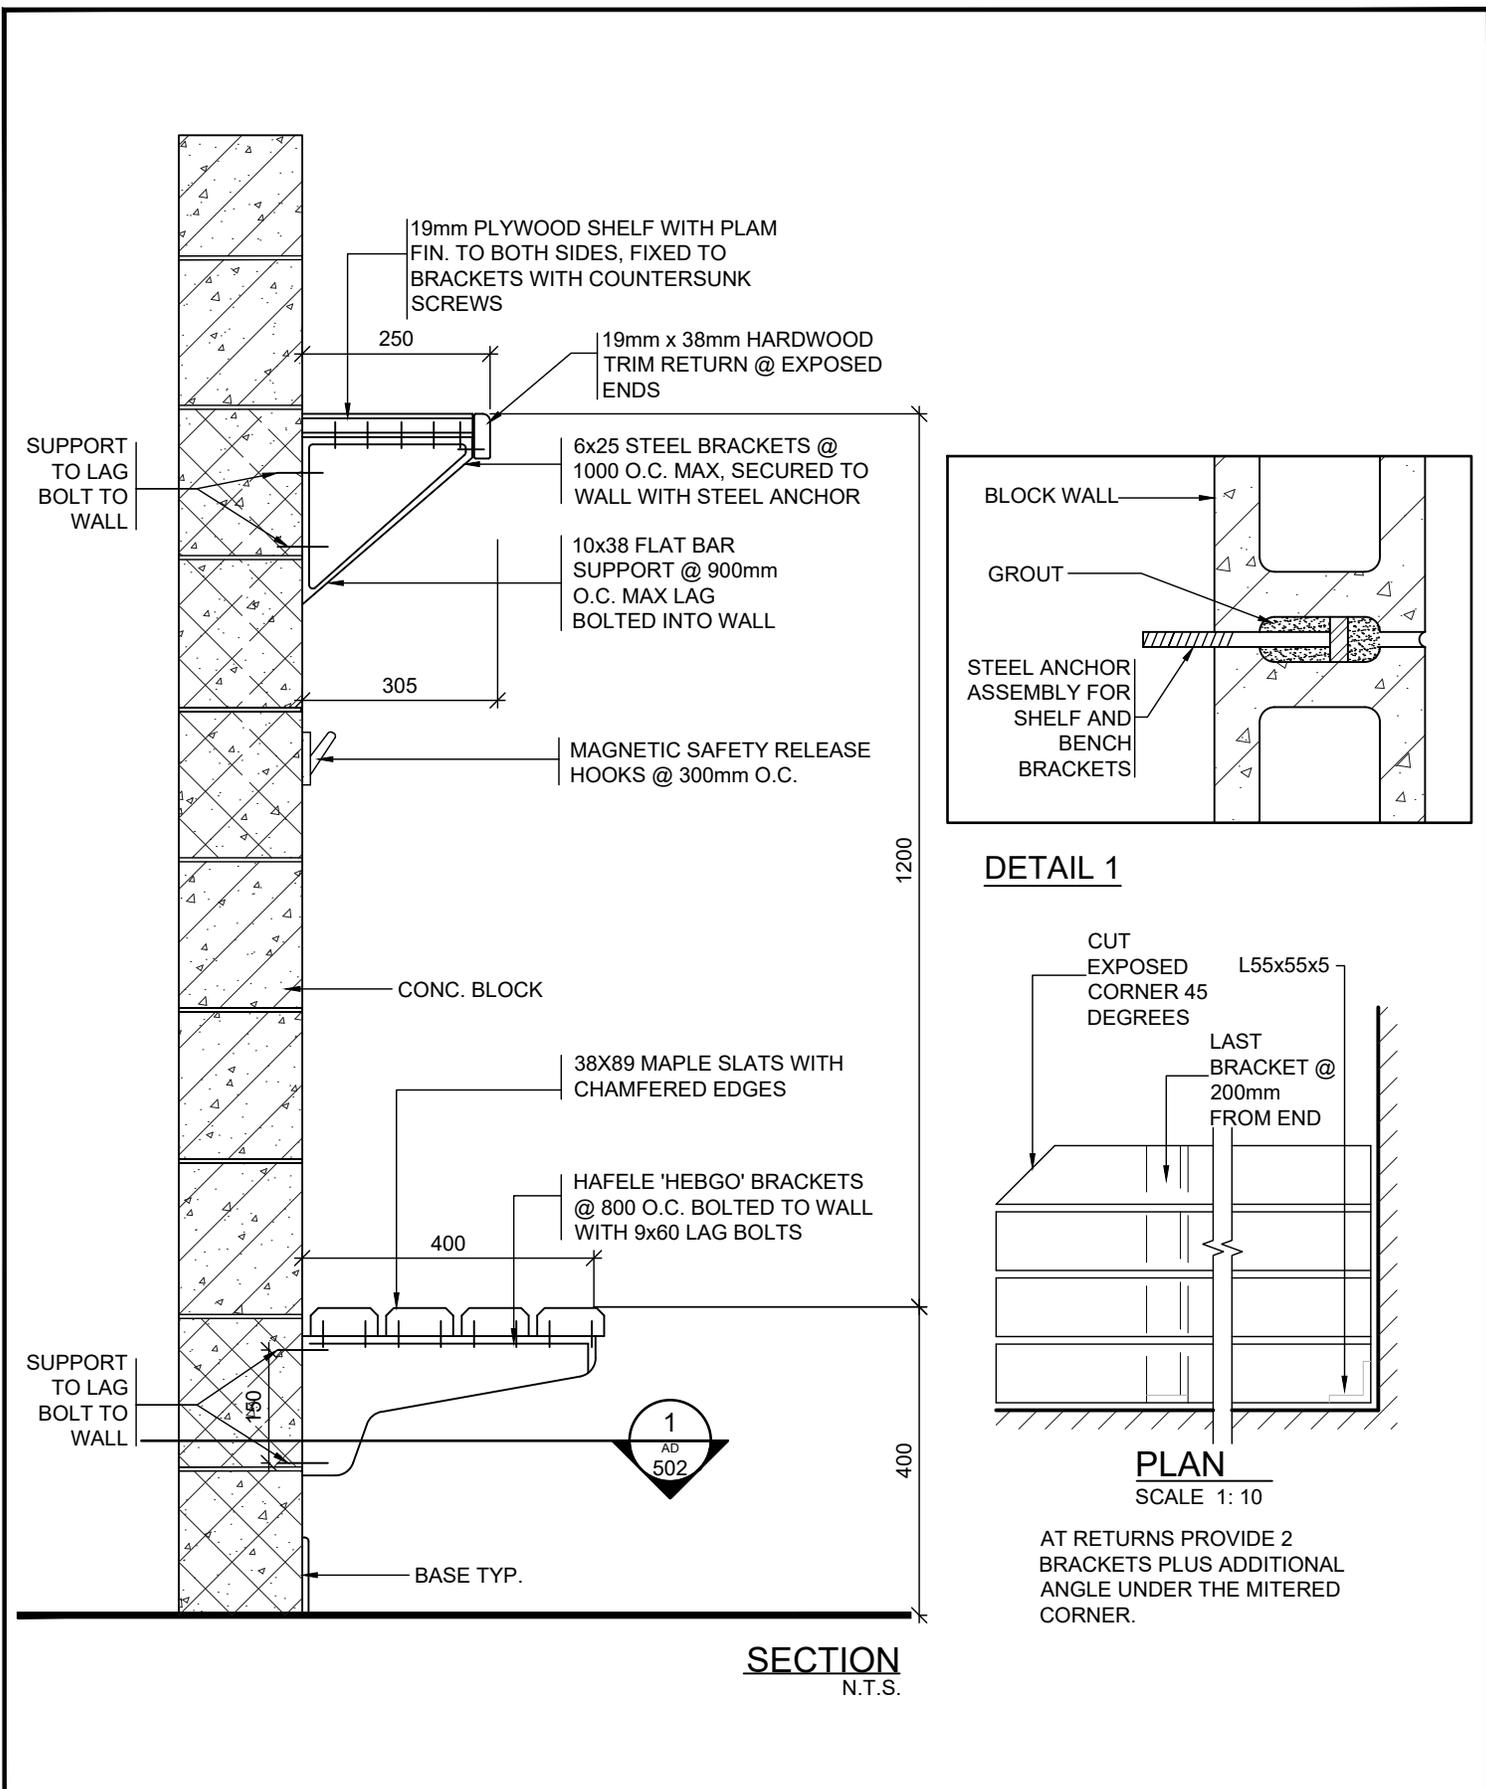

BENCH M5 - CHANGE ROOMS

PROJ: 22124

SCALE: NTS


DRAWN: GB

DATE: 260105



ISSUE/REV.
00

AD
505

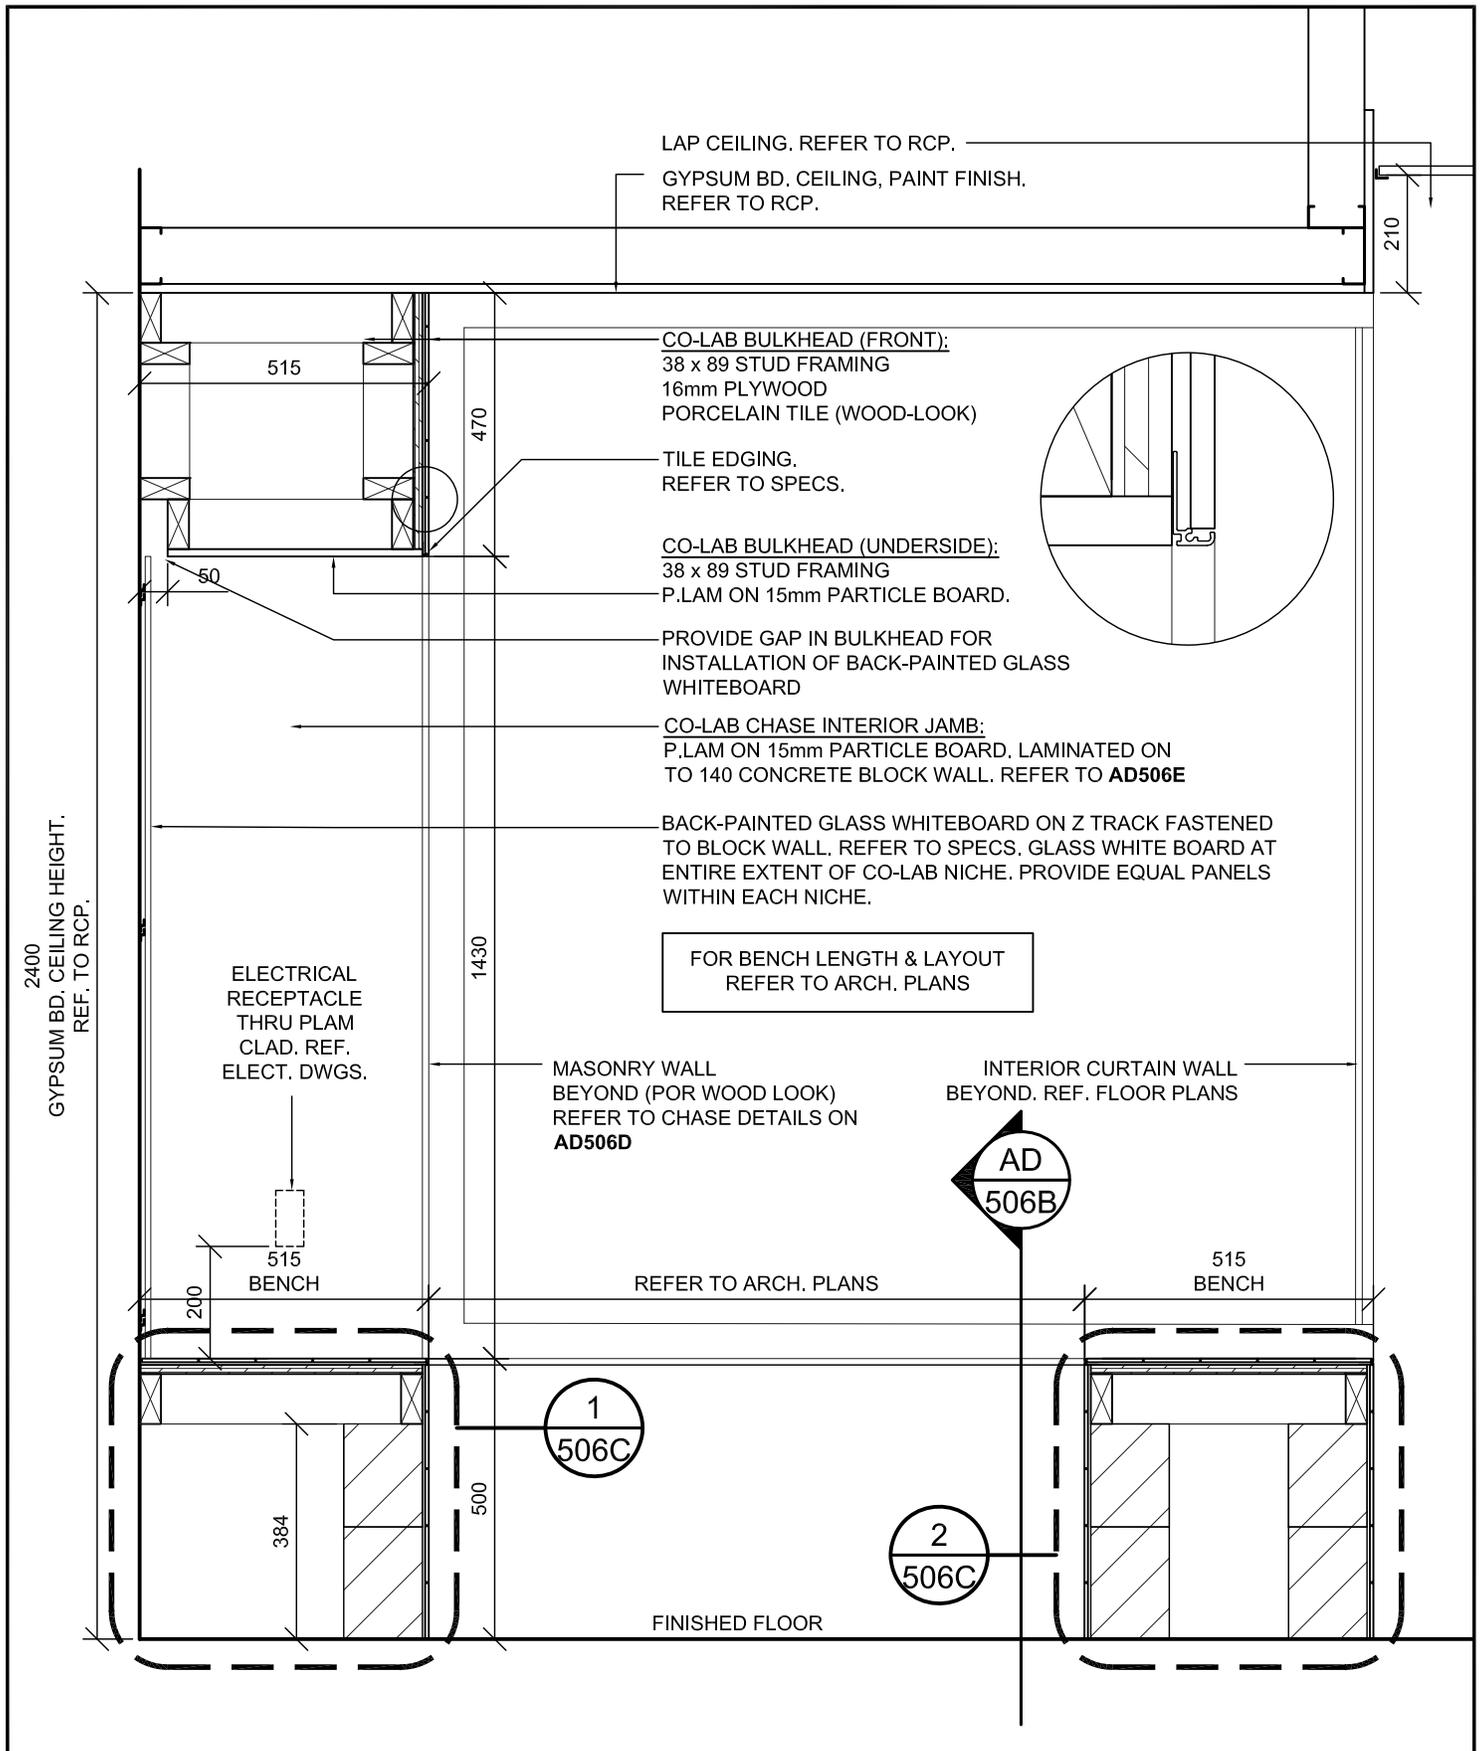

BENCH M3
CO-LAB SPACE BENCHES
 REFER TO FLOOR PLANS FOR LOCATIONS


PROJ: 22124
 SCALE: NTS
 DRAWN: KB
 DATE: 260106

HOSSACK
ARCHITECTURE



ISSUE/REV.

AD
506A

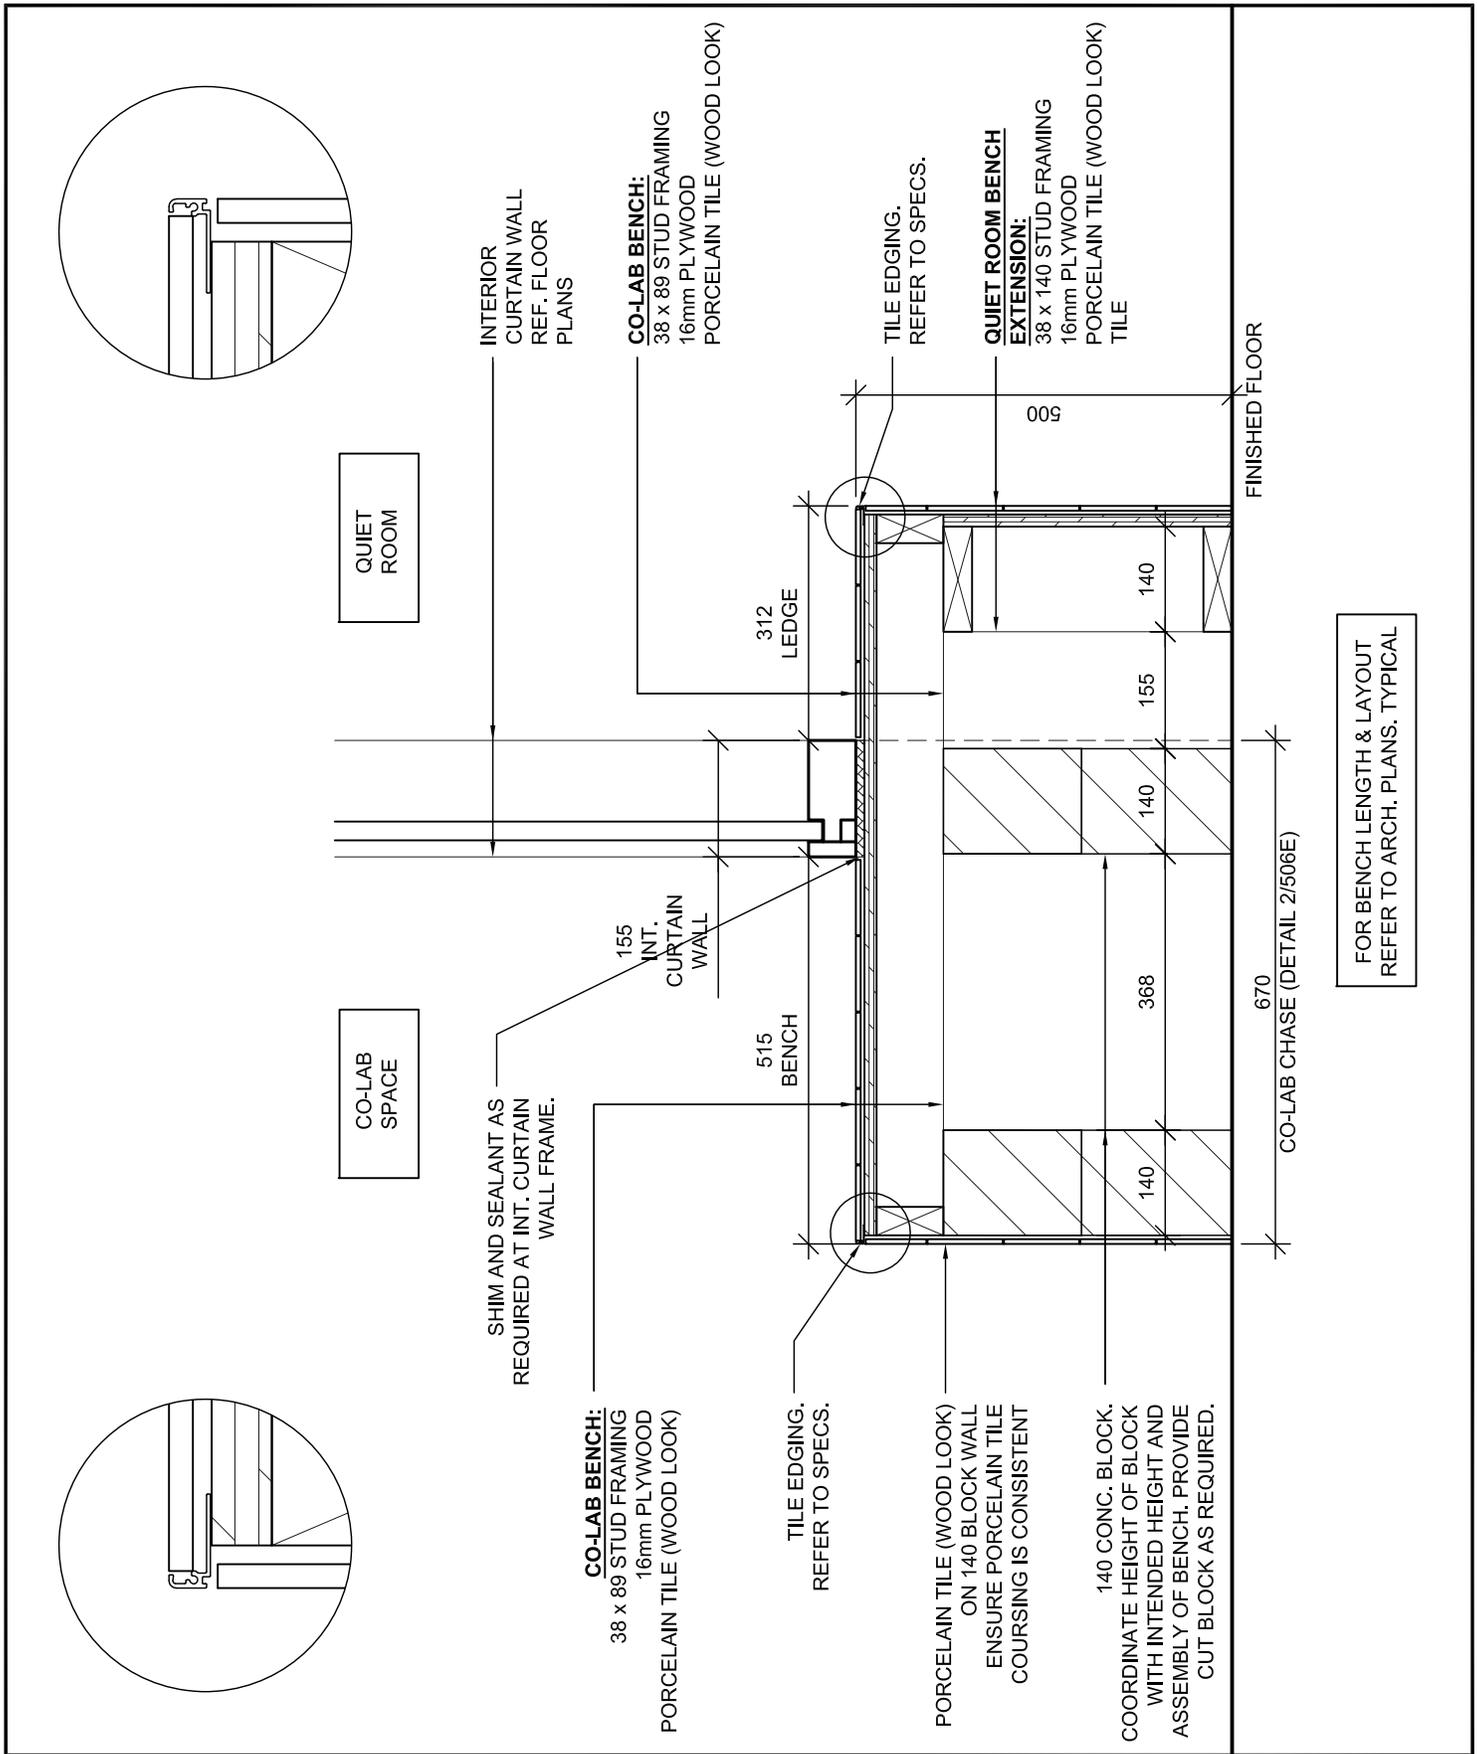


BENCH M3
CO-LAB SPACE BENCHES
 REFER TO FLOOR PLANS FOR LOCATIONS

| | |
|--------|----------|
| PROJ: | 22124 |
| SCALE: | NTS |
| DRAWN: | KB |
| DATE: | 26 01 06 |




| |
|------------|
| ISSUE/REV. |
| AD 506B |

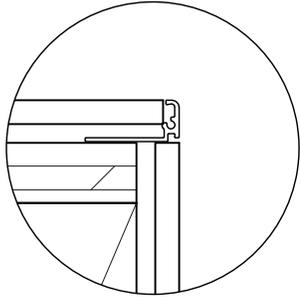

BACK-PAINTED GLASS WHITEBOARD ON Z TRACK FASTENED TO BLOCK WALL. REFER TO SPECS. GLASS WHITE BOARD AT ENTIRE EXTENT OF CO-LAB NICHE. PROVIDE EQUAL PANELS WITHIN EACH NICHE.

TILE TO EDGE OF WALL.

140 CONC. BLOCK. COORDINATE HEIGHT OF BLOCK WITH INTENDED HEIGHT AND ASSEMBLY OF BENCH. PROVIDE CUT BLOCK AS REQUIRED.

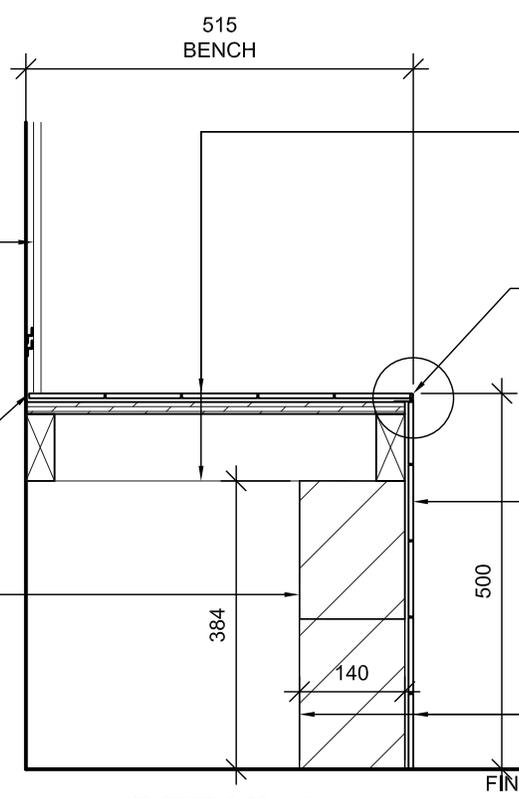

PORCELAIN TILE (WOOD LOOK)
REFER TO SPECIFICATIONS
SIZE: 100 x 700
LAYOUT PATTERN: RANDOM


CO-LAB BENCH:
38 x 89 STUD FRAMING
16mm PLYWOOD
PORCELAIN TILE (WOOD LOOK)

TILE EDGING.
REFER TO SPECS.

PORCELAIN TILE (WOOD LOOK)
ON 140 BLOCK WALL
ENSURE PORCELAIN TILE COURSING IS CONSISTENT


PORCELAIN TILE (WOOD LOOK)
ON 140 BLOCK WALL

DETAIL 1

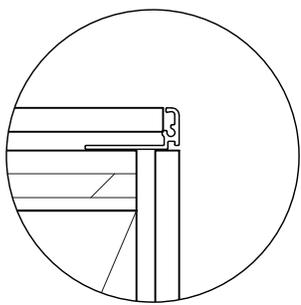

REFER TO FLOOR PLANS FOR EXTENTS OF BENCH AND CO-LAB CHASE. TYPICAL

140 CONC. BLOCK. COORDINATE HEIGHT OF BLOCK WITH INTENDED HEIGHT AND ASSEMBLY OF BENCH. PROVIDE CUT BLOCK AS REQUIRED.

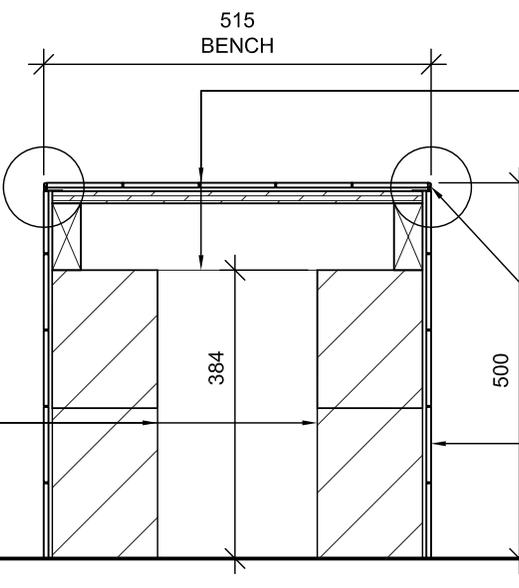

CO-LAB BENCH:
38 x 89 STUD FRAMING
16mm PLYWOOD
PORCELAIN TILE (WOOD LOOK)


TILE EDGING ON BOTH SIDES
REFER TO SPECS.

PORCELAIN TILE (WOOD LOOK)
ON 140 BLOCK WALL AT BOTH SIDES OF BENCH.
ENSURE PORCELAIN TILE COURSING IS CONSISTENT


DETAIL 2

BENCH M3
CO-LAB SPACE BENCHES
REFER TO FLOOR PLANS FOR LOCATIONS

| |
|----------------|
| PROJ: 22124 |
| SCALE: NTS |
| DRAWN:KB |
| DATE: 26 01 06 |

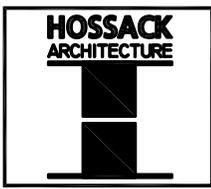

| |
|------------|
| ISSUE/REV. |
| AD 506C |

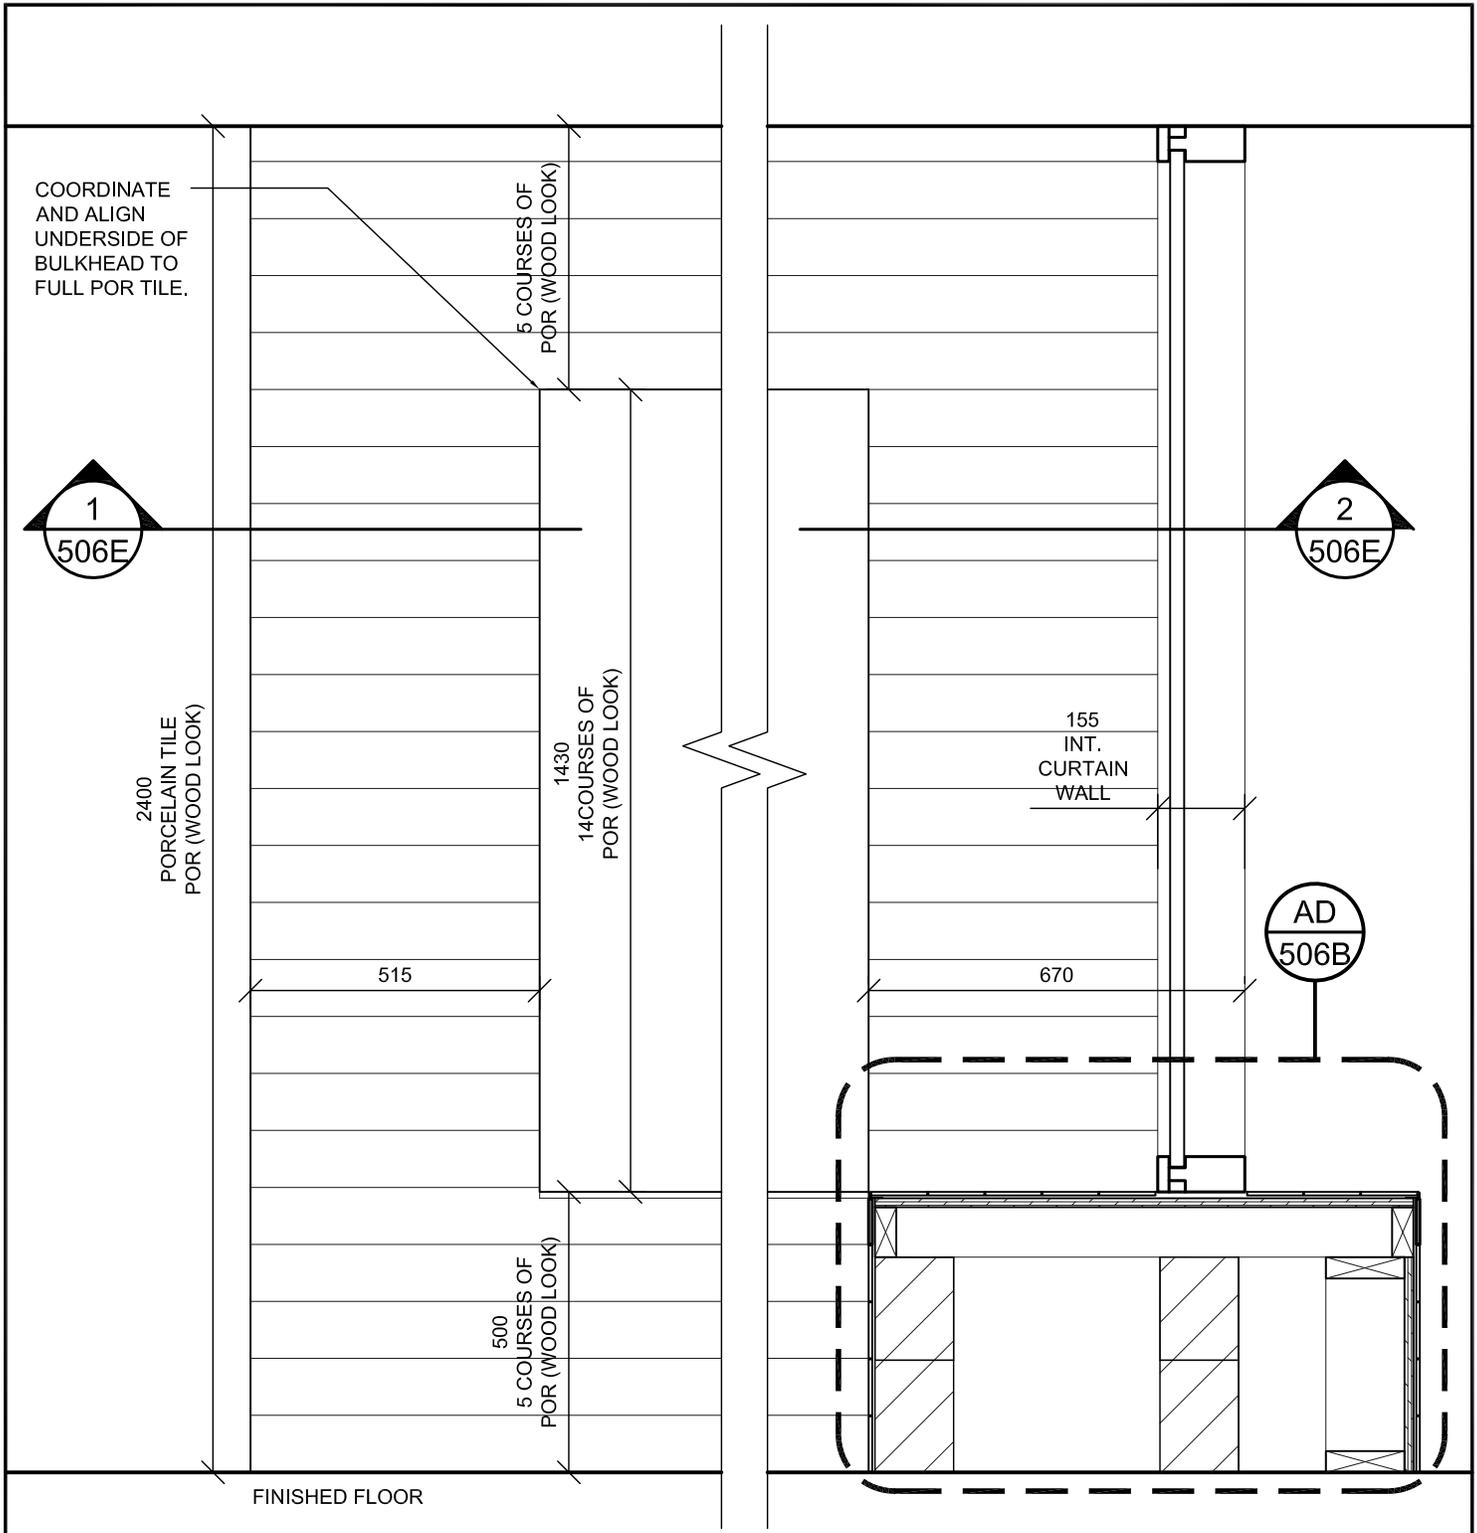

PORCELAIN TILE (WOOD LOOK)
 REFER TO SPECIFICATIONS
 SIZE: 100 x 700
 LAYOUT PATTERN: RANDOM

- NOTES:**
1. ENSURE CONSISTENT PORCELAIN TILE COURSING. TYPICAL.
 2. PROVIDE JOLLY SCHLUTER EDGING ON ALL EXPOSED TILE EDGE. TYPICAL. REFER TO DETAILS FOR ORIENTATION OF EDGE TRIM.
 3. COORDINATE EXTENTS OF CO-LAB BENCH AND CO-LAB CHASE WALLS PER ARCH. PLANS. TYPICAL.

| | | | |
|--|----------------|--|--------------------------|
| BENCH M3 CO-LAB SPACE BENCHES <i>PARTIAL ELEVATION</i> | PROJ: 22124 | | ISSUE/REV. |
| | SCALE: NTS | | AD 506D |
| | DRAWN:KB | | |
| | DATE: 26 01 06 | | |

NOTES:

- REFER TO ARCHITECTURAL PLANS. ORIENTATION OF CO-LAB SPACES DIFFER. COORDINATE SIMILAR DETAILS.


CO-LAB CHASE EXTERIOR JAMB: PORCELAIN TILE (WOOD LOOK) ON 140 BLOCK WALL. ENSURE PORCELAIN TILE COURSING IS CONSISTENT.

CO-LAB CHASE FRONT FACE: PORCELAIN TILE (WOOD LOOK) ON 140 BLOCK WALL. ENSURE PORCELAIN TILE COURSING IS CONSISTENT.

BACK-PAINTED GLASS WHITEBOARD ON Z TRACK FASTENED TO BLOCK WALL. REFER TO SPECS. GLASS WHITE BOARD AT ENTIRE EXTENT OF CO-LAB NICHE. PROVIDE EQUAL PANELS WITHIN EACH NICHE.

CO-LAB CHASE INTERIOR JAMB: P.LAM ON 15mm PARTICLE BOARD. LAMINATED ON TO 140 CONCRETE BLOCK WALL.

TILE EDGING ON BOTH SIDES. REFER TO SPECS.

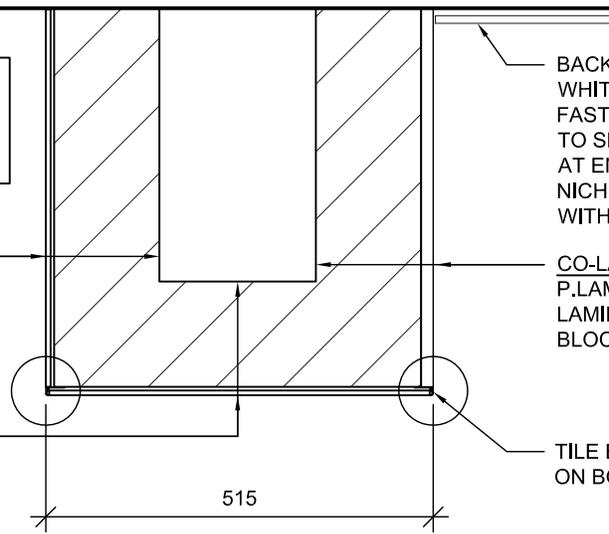

DETAIL 1

BACK-PAINTED GLASS WHITEBOARD ON Z TRACK FASTENED TO BLOCK WALL. REFER TO SPECS. GLASS WHITE BOARD AT ENTIRE EXTENT OF CO-LAB NICHE. PROVIDE EQUAL PANELS WITHIN EACH NICHE.


CO-LAB CHASE INTERIOR JAMB: P.LAM ON 15mm PARTICLE BOARD. LAMINATED ON TO 140 CONCRETE BLOCK WALL.

TILE EDGING REFER TO SPECS.


CO-LAB CHASE FRONT FACE: PORCELAIN TILE (WOOD LOOK) ON 140 BLOCK WALL. ENSURE PORCELAIN TILE COURSING IS CONSISTENT.

CO-LAB CHASE EXTERIOR JAMB: PORCELAIN TILE (WOOD LOOK) ON 140 BLOCK WALL. ENSURE PORCELAIN TILE COURSING IS CONSISTENT.

SHIM AND SEALANT AS REQUIRED AT INT. CURTAIN WALL FRAME.

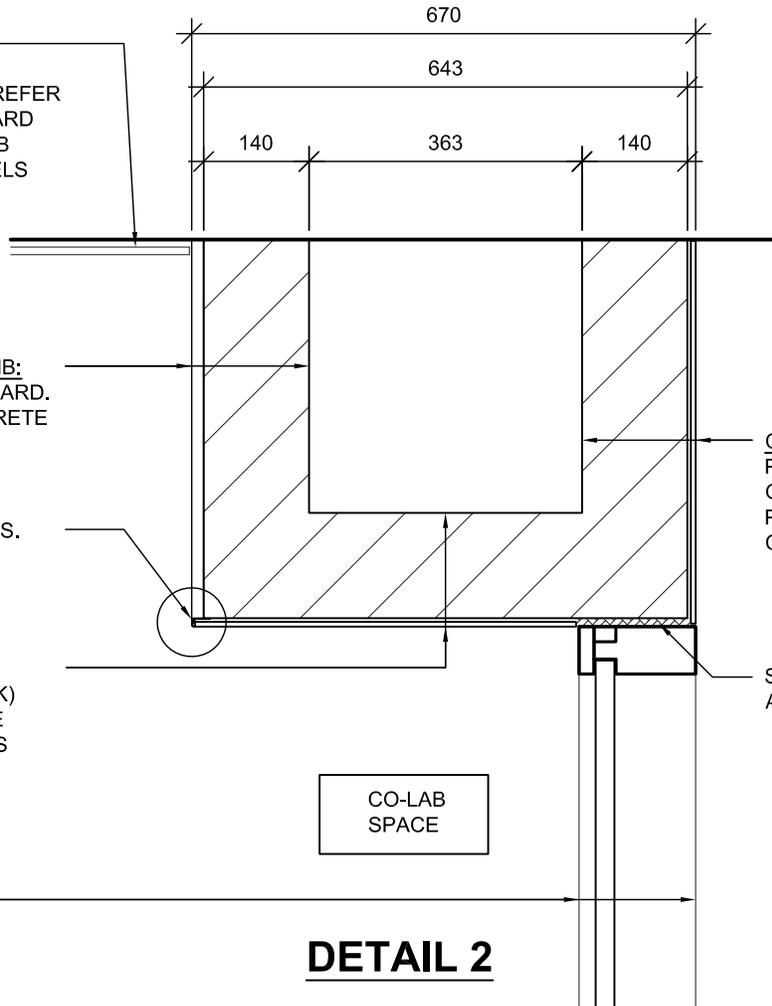

DETAIL 2

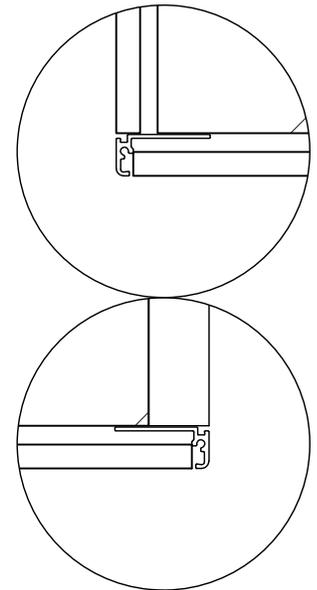

CO-LAB SPACE

QUIET ROOM

INTERIOR CURTAIN WALL REF. FLOOR PLANS


BENCH M3
CO-LAB SPACE BENCHES
PARTIAL ELEVATION

PROJ: 22124
 SCALE: NTS
 DRAWN:KB
 DATE: 26 01 06




ISSUE/REV.


AD
506E

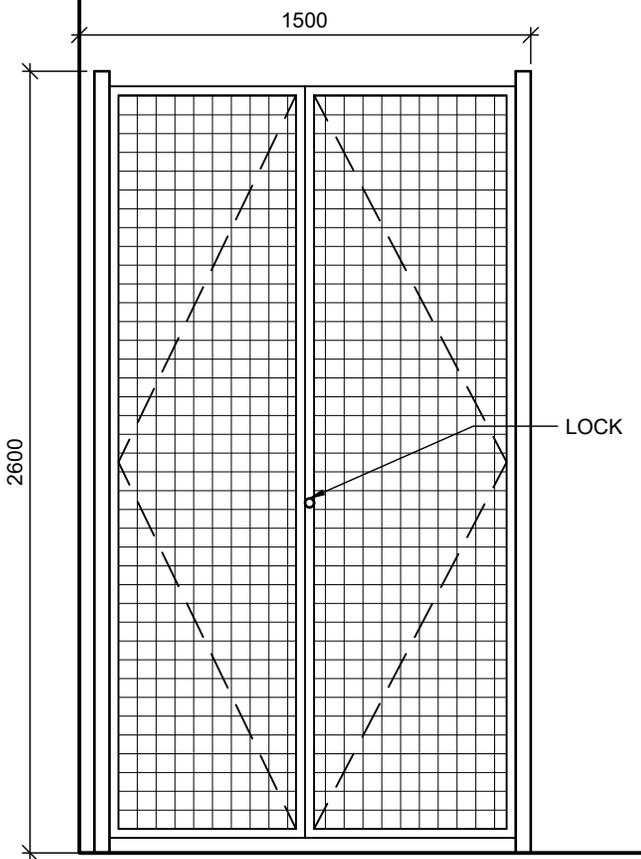

ELEVATION A
SCALE 1:25

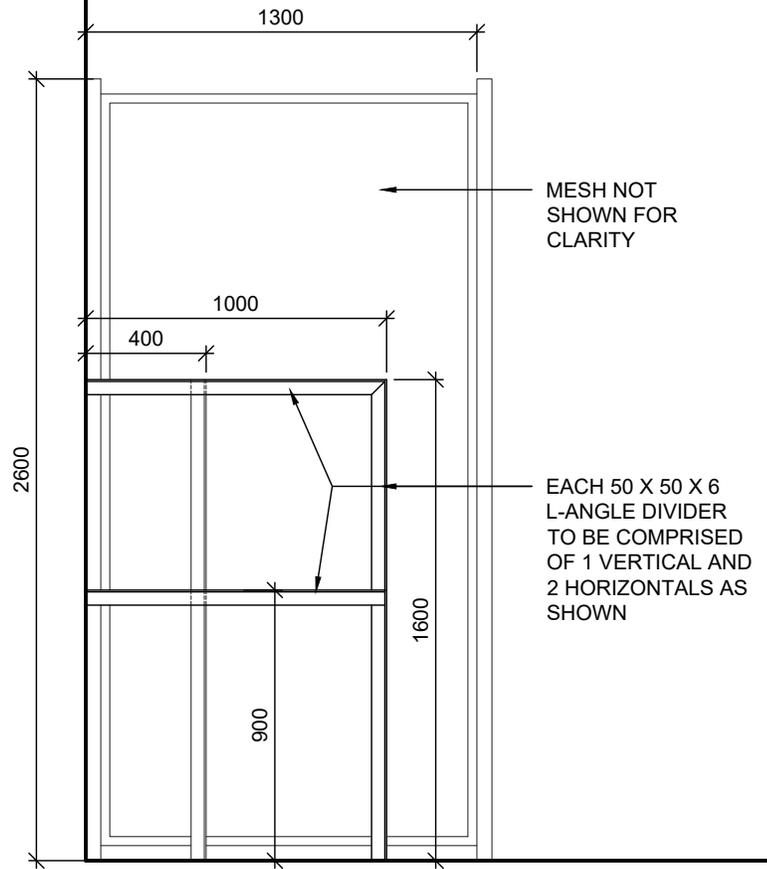

SECTION A
SCALE 1:25

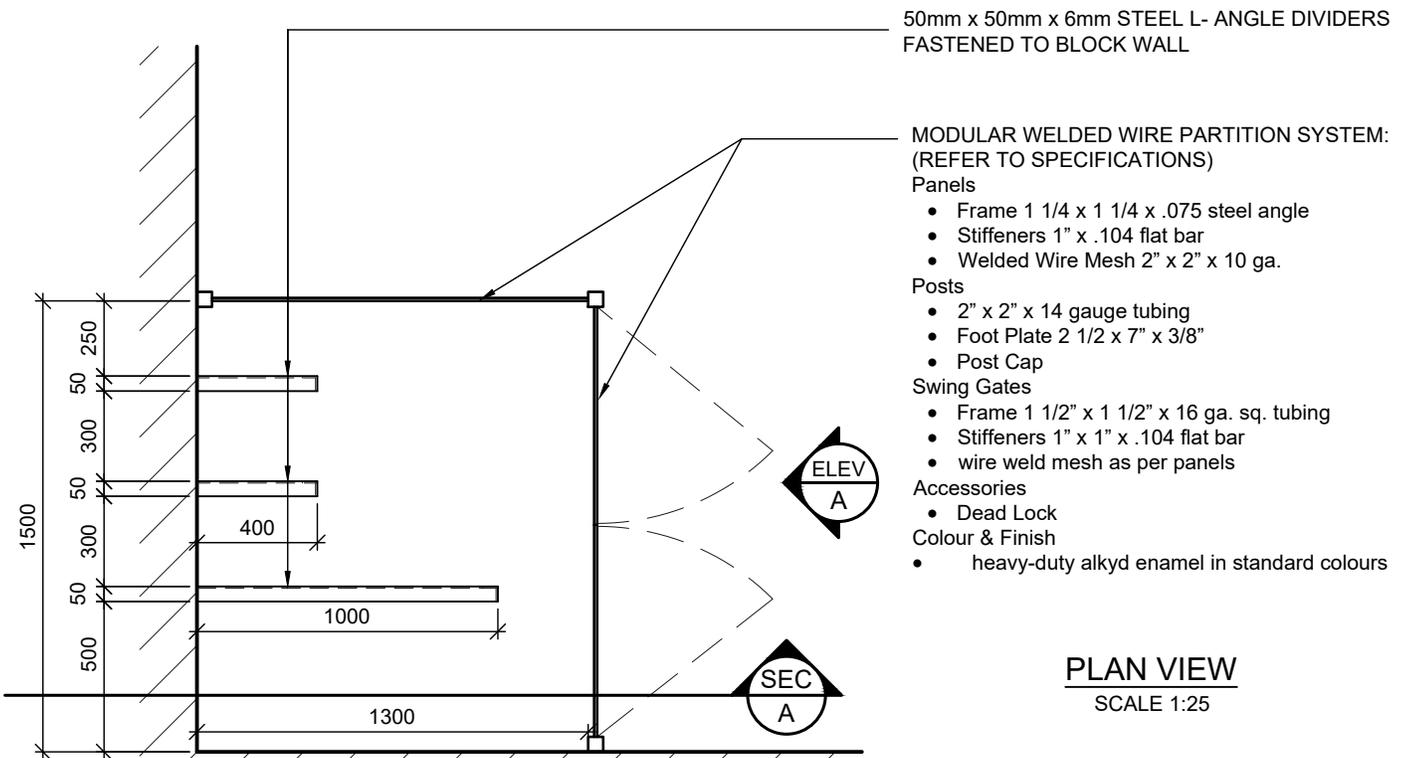

PLAN VIEW
SCALE 1:25


APPLICATIONS ROOM PLYWOOD STORAGE UNIT

PROJ: 22124
SCALE: NOTED
DRAWN: CC
DATE: 260105




ISSUE/REV.
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AD
510

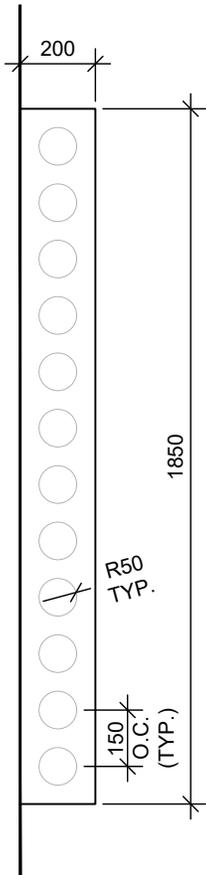


PLAN
SCALE 1:20

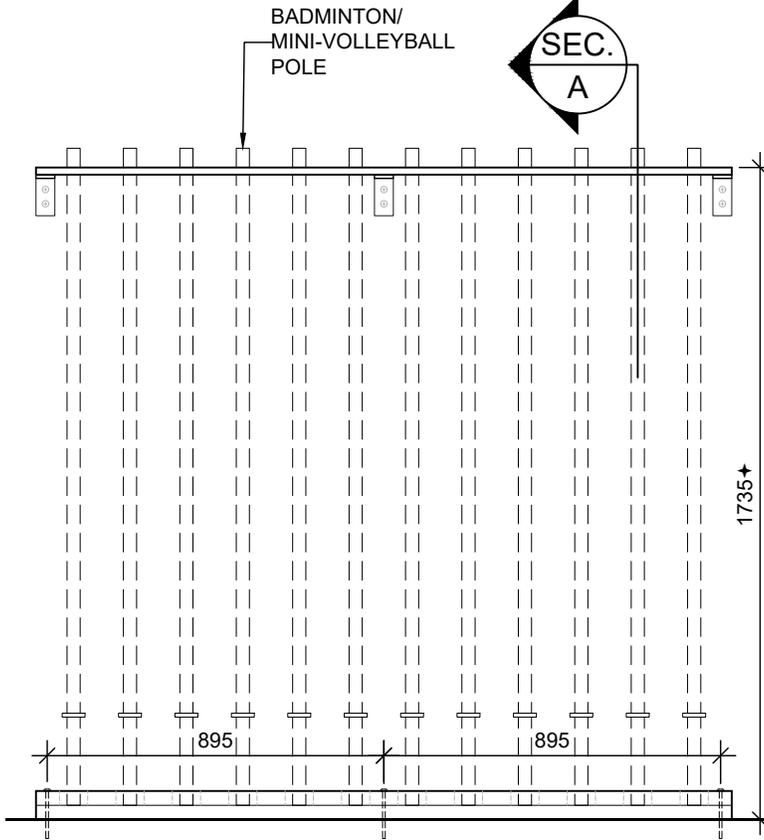

ELEVATION
SCALE 1:20

↑NOTE:
HEIGHT MAY VARY TO MANUFACTURER'S SPEC. & TO BE
CONFIRMED WITH SCHOOL BOARD PRIOR TO INSTALLATION.

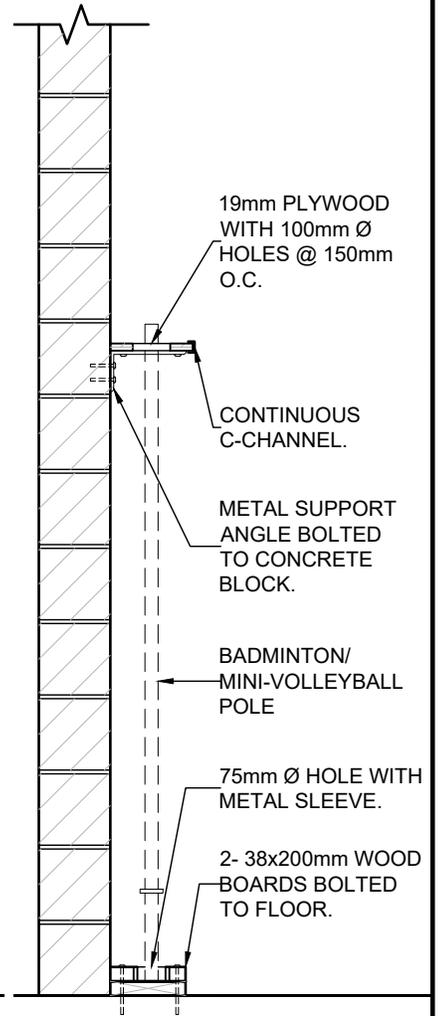

SECTION A
SCALE 1:20


GYM VERTICAL POLE STORAGE RACK

| | |
|--------|--------|
| PROJ: | 22124 |
| SCALE: | NOTED |
| DRAWN: | GB |
| DATE: | 260105 |



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|------------|
| ISSUE/REV. |
| AD 523 |


REFER TO INTERIOR ELEVATIONS

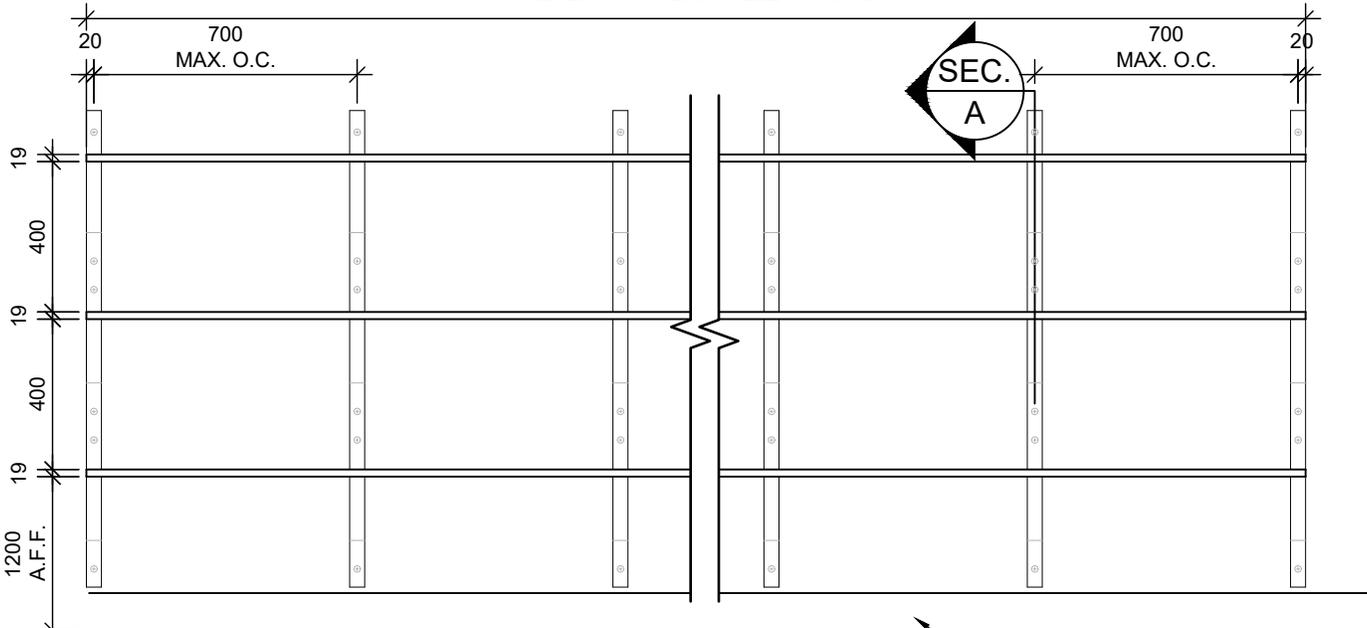

ELEVATION

SCALE 1:20

BASE TYP.

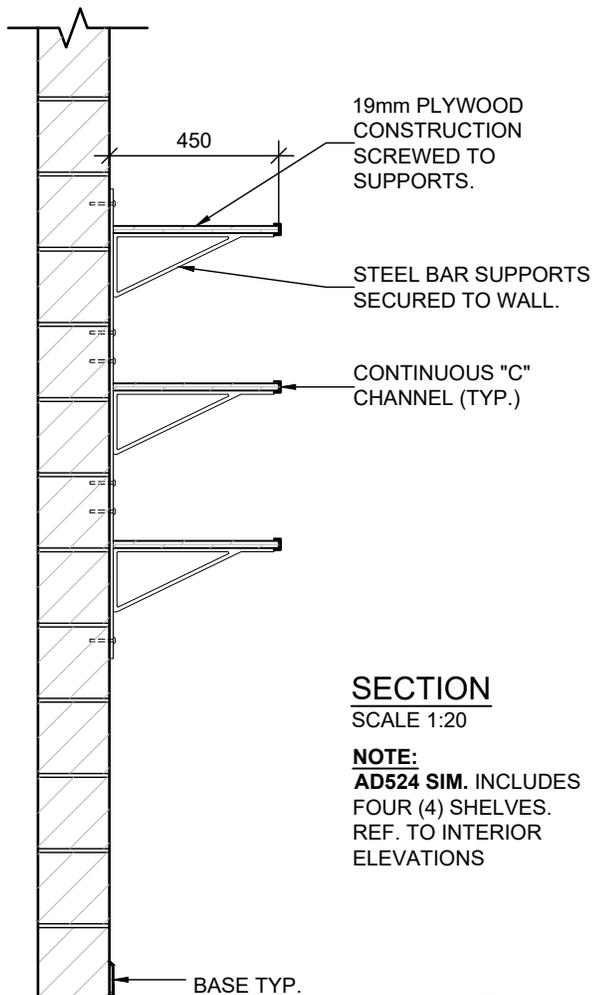

SECTION

SCALE 1:20

NOTE:
AD524 SIM. INCLUDES
FOUR (4) SHELVES.
REF. TO INTERIOR
ELEVATIONS


**GYM STORAGE SHELVING
& CART STORAGE**

| | |
|--------|--------|
| PROJ: | 22124 |
| SCALE: | NOTED |
| DRAWN: | KB |
| DATE: | 260105 |




ISSUE/REV.

AD
524

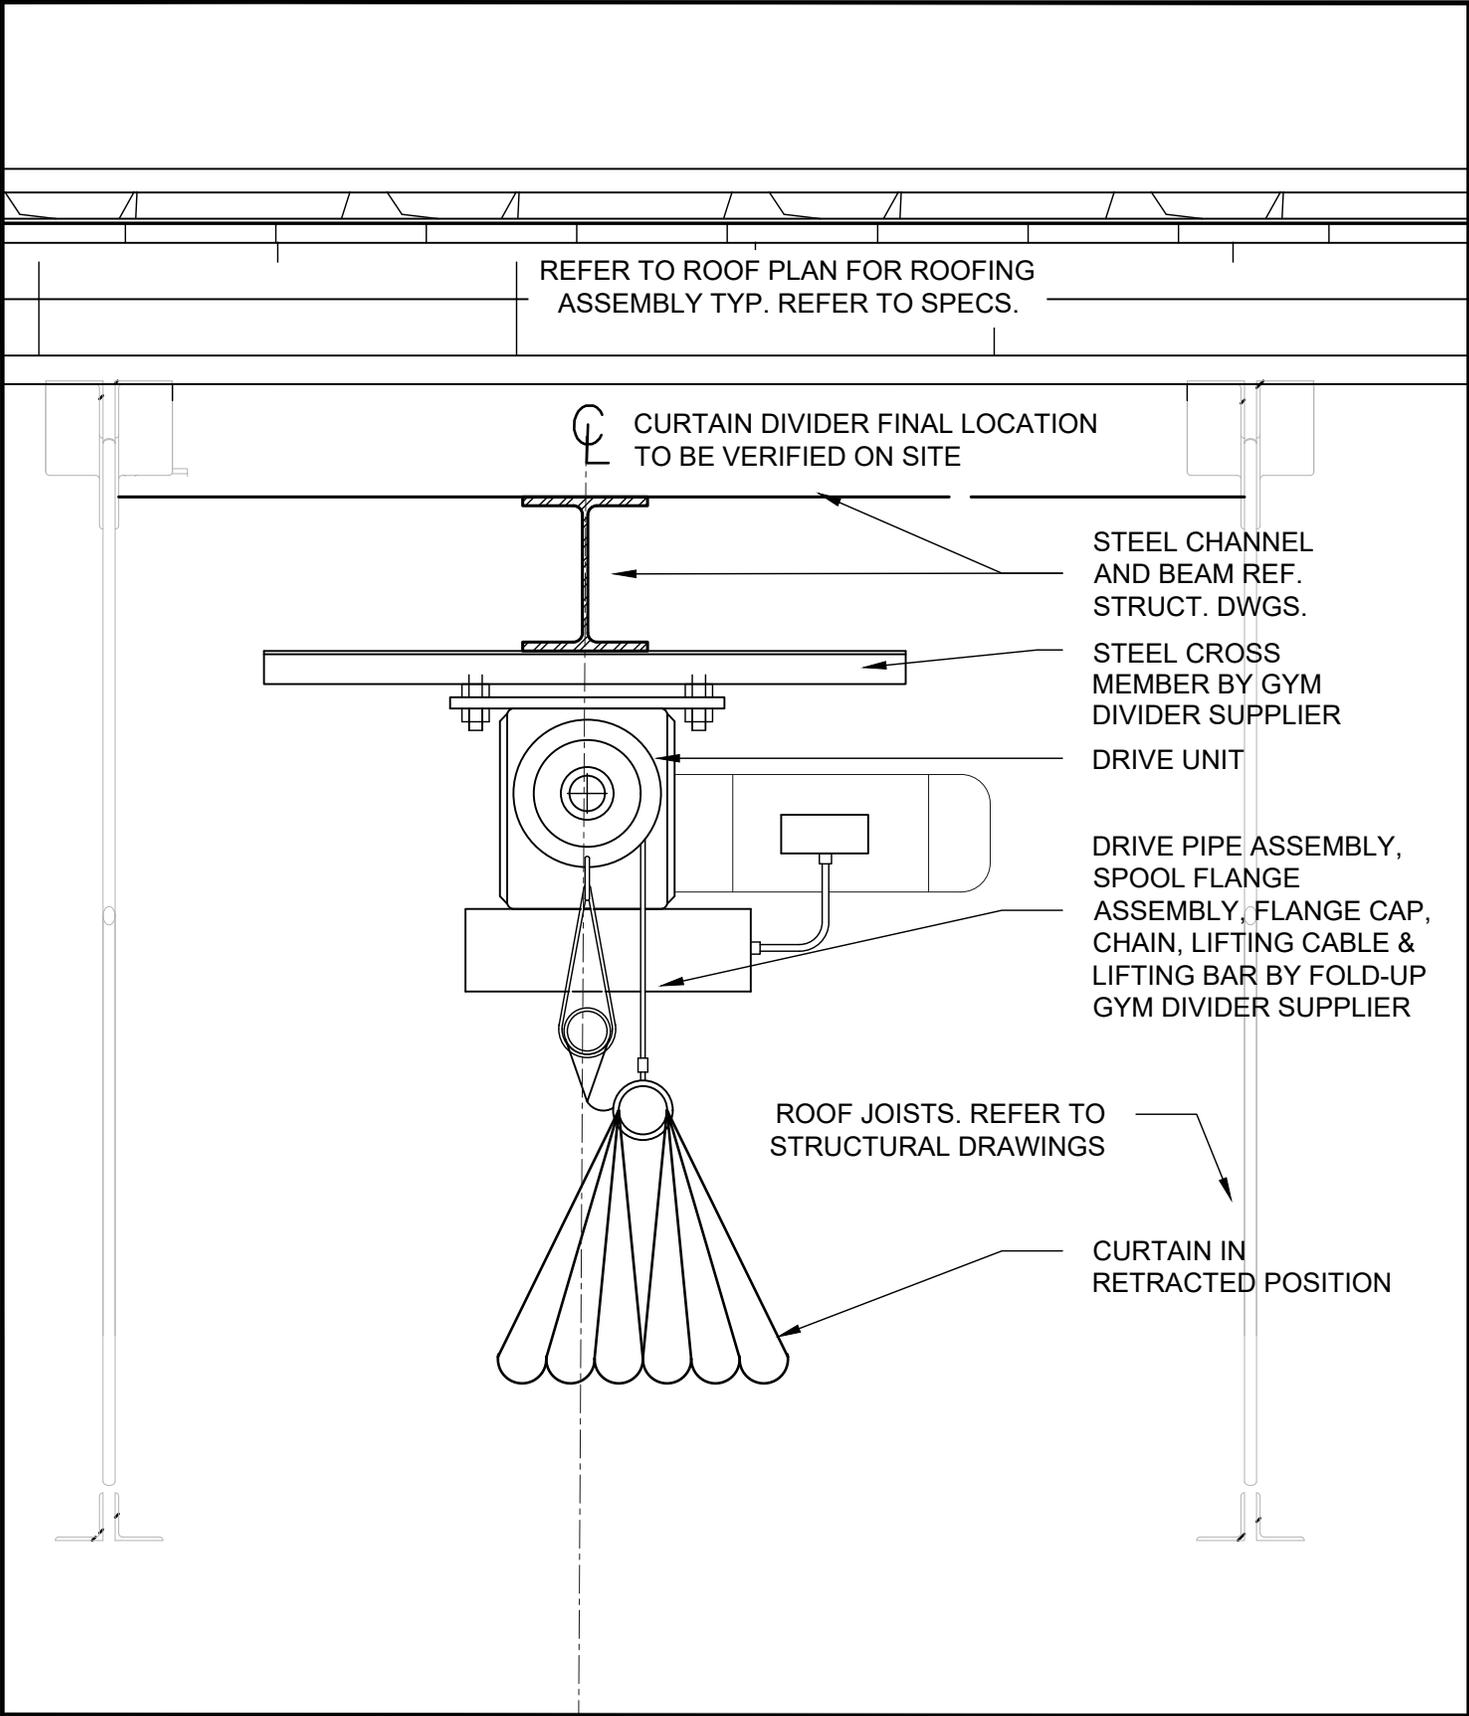

| | | | |
|-----------------------------------|--------------|--|------------------|
| GYM DIVIDER CURTAIN DETAIL | PROJ: 22124 | HOSSACK ARCHITECTURE  | ISSUE/REV. |
| | SCALE: 1:50 | | AD 525 |
| | DRAWN: KB | | |
| | DATE: 260105 | | |

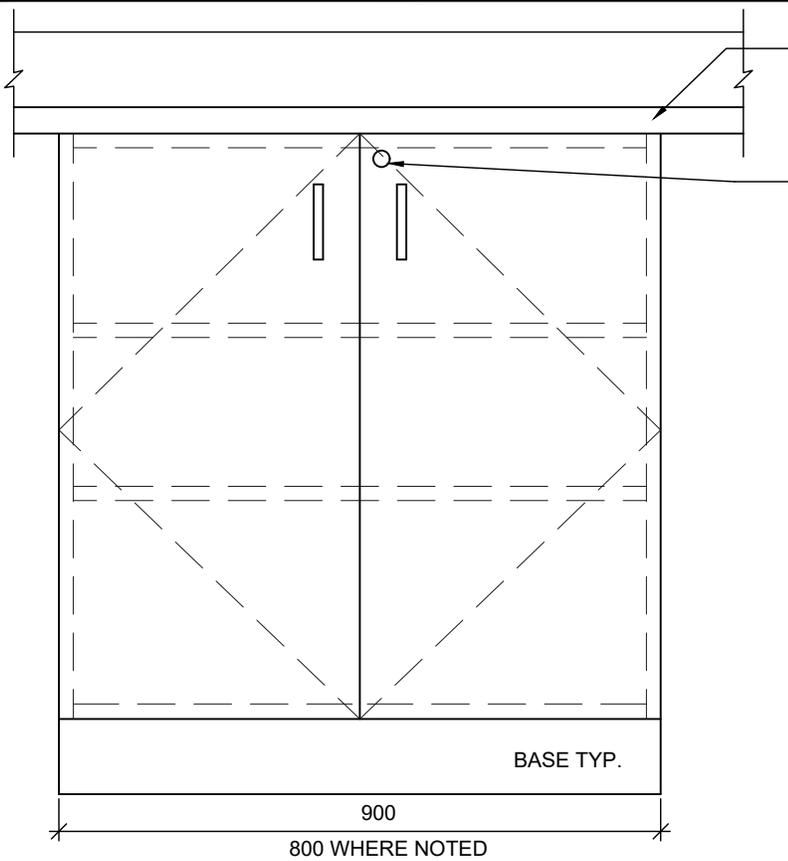

CONTINUOUS COUNTER
TOP AND BACKSPLASH.
POST FORMED

LOCK (TYP.)

ELEVATION

SCALE 1 : 10

NOTE:
ALL MILLWORK DOORS AND DRAWERS
TO BE EQUIPPED WITH LOCKS
UNLESS OTHERWISE NOTED.


**STANDARD HEIGHTS: (COORD. WITH
INTERIOR ELEVATIONS, TYP.)**

600 - PRESCHOOL, TODDLER

800 - CLASSROOMS, ART 313
LIFESKILLS 150, INFANT 405,
TODDLER, PRESCHOOL,
HEALTH ROOM 108.

865 - SPECIAL EDUCATION 212,

915 - KITCHENETTE 159

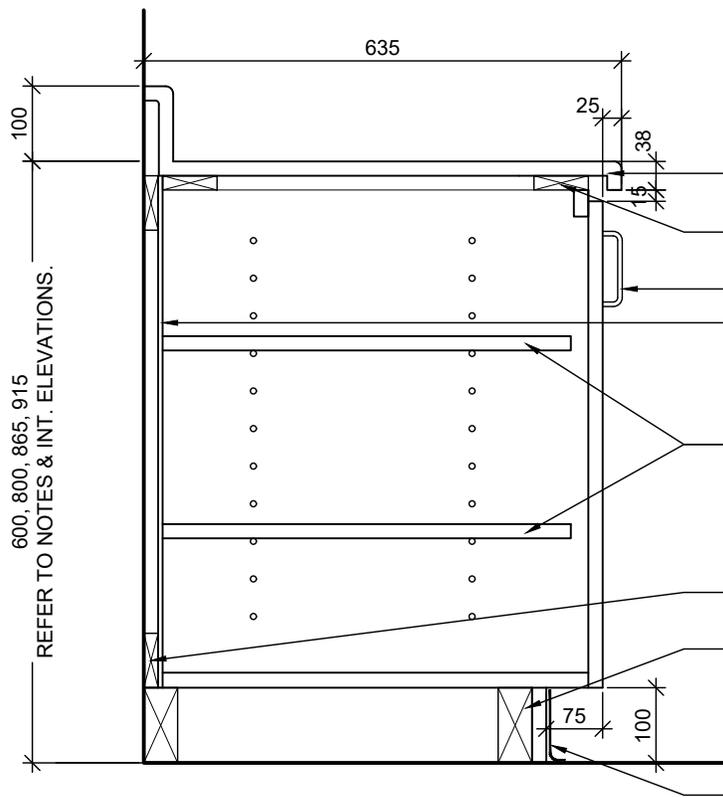

SECTION

SCALE 1 : 10

CONTINUOUS COUNTERTOP
AND BACKSPLASH

STRETCHER RAIL AT FRONT
AND BACK

DOOR PULL

BACKING

ADJ SHELVES

NAILER STRIPS AT TOP
AND BOTTOM

BASE FRAMING

BASE TYP.

TYPE B1

PROJ: 22124

SCALE: 1:10

DRAWN: KB


DATE: 260105

**HOSSACK
ARCHITECTURE**



ISSUE/REV.
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AD
600

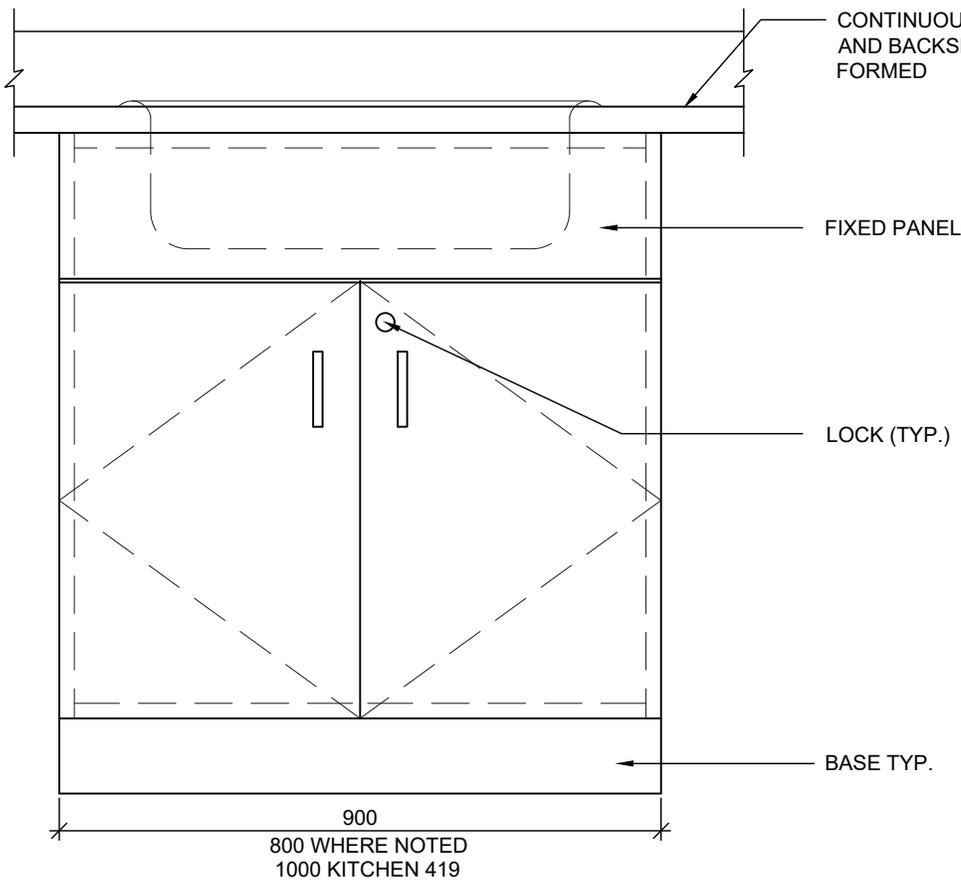

ELEVATION

SCALE 1 : 10

NOTE:


ALL MILLWORK DOORS AND DRAWERS TO BE EQUIPPED WITH LOCKS UNLESS OTHERWISE NOTED.

STANDARD HEIGHTS: (COORD. WITH INTERIOR ELEVATIONS, TYP.)

800 - ART 313, LIBRARY 209, LIFESKILLS 150, INFANT 405, TODDLER 406, PRESCHOOL, HEALTH ROOM 108.

865 - SPECIAL EDUCATION 212,

915 - KITCHEN 419, KITCHENETTE 159, STAFF 417, LAUNDRY 418.

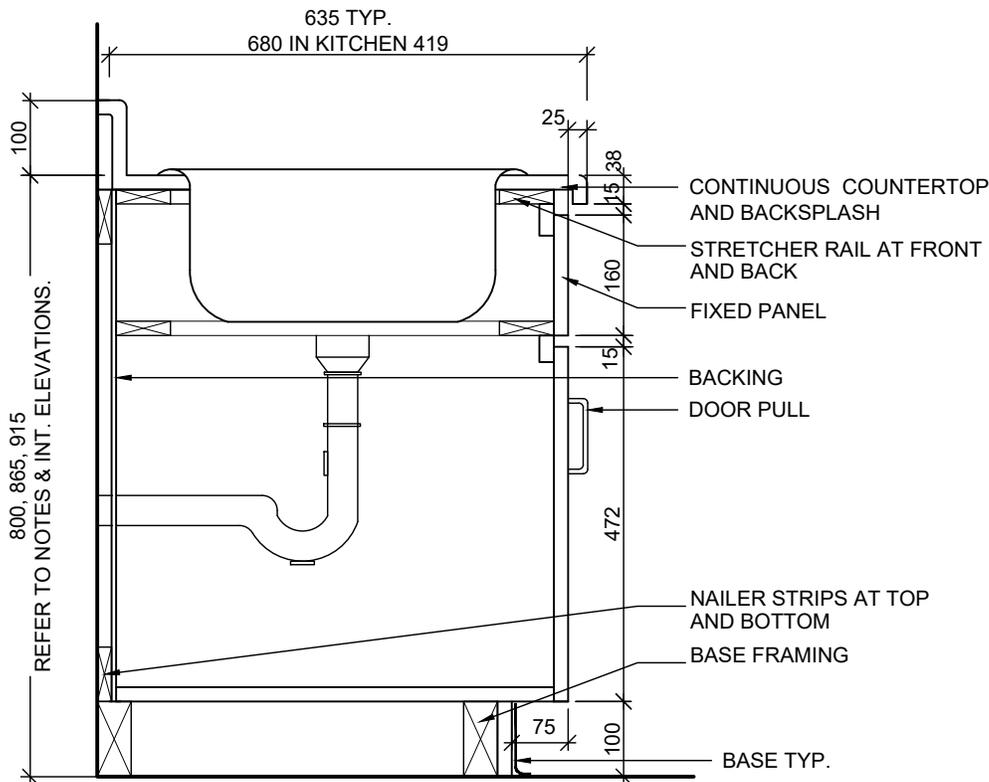

SECTION

SCALE 1 : 10

TYPE B2 - WITH SINK

PROJ: 22124

SCALE: 1:10

DRAWN: KB


DATE: 260105

HOSSACK
ARCHITECTURE



ISSUE/REV.
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AD
601

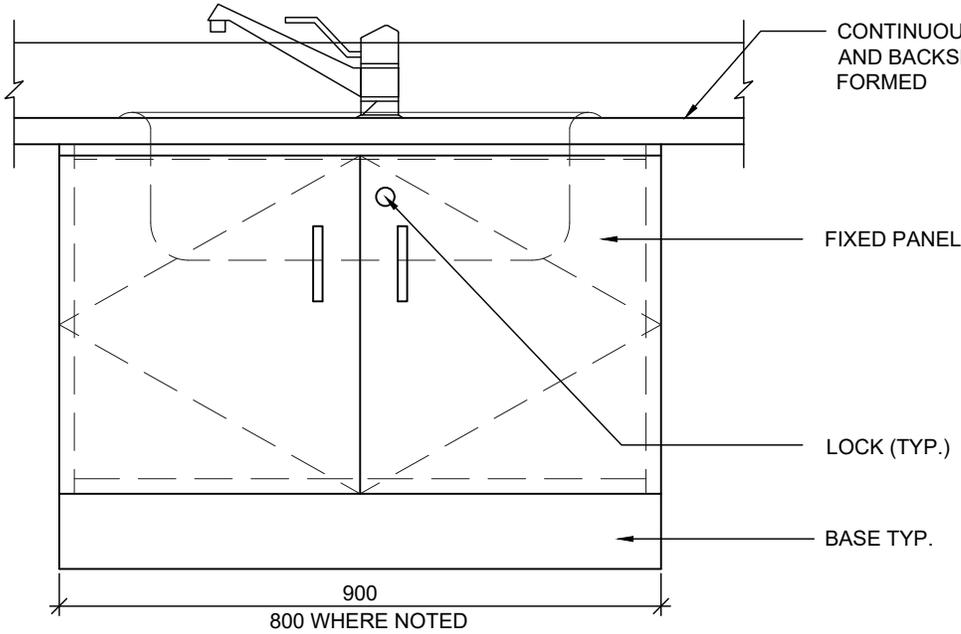


ELEVATION

SCALE 1 : 10

NOTE:
ALL MILLWORK DOORS AND DRAWERS TO BE EQUIPPED WITH LOCKS UNLESS OTHERWISE NOTED.

STANDARD HEIGHTS: (COORD. WITH INTERIOR ELEVATIONS, TYP.)

600 - PRESCHOOL, TODDLER 406

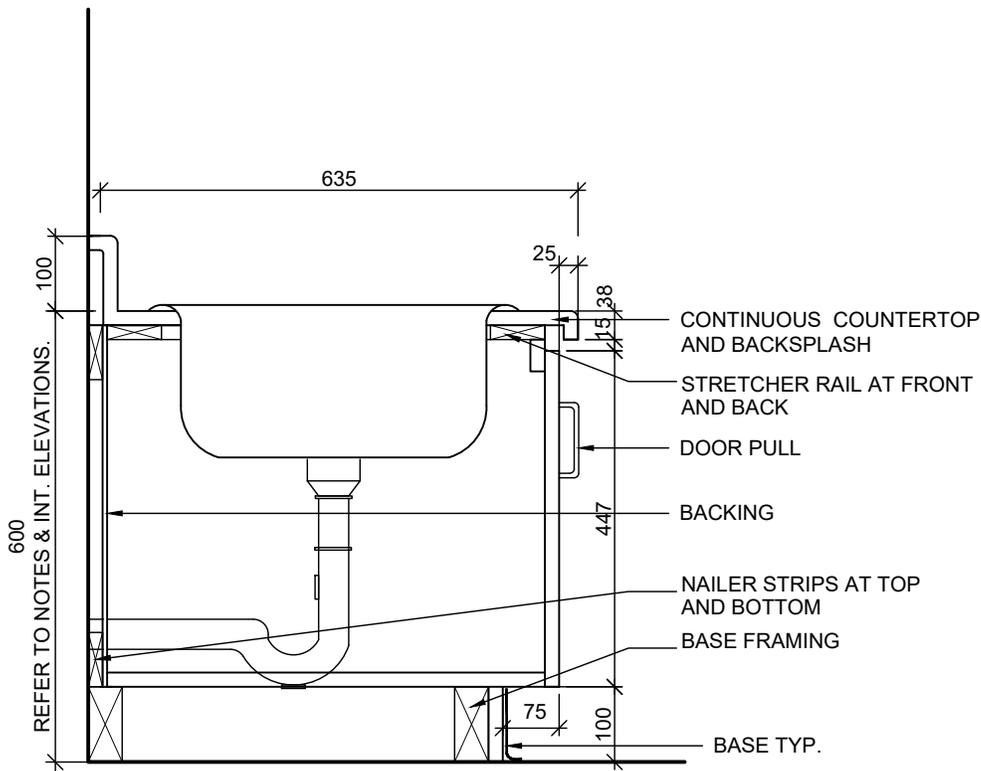

SECTION

SCALE 1 : 10

TYPE B2A - WITH SINK

PROJ: 22124

SCALE: 1:10

DRAWN: KB



DATE: 260105

HOSSACK
ARCHITECTURE



ISSUE/REV.
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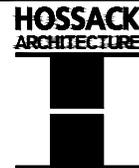
AD
601A

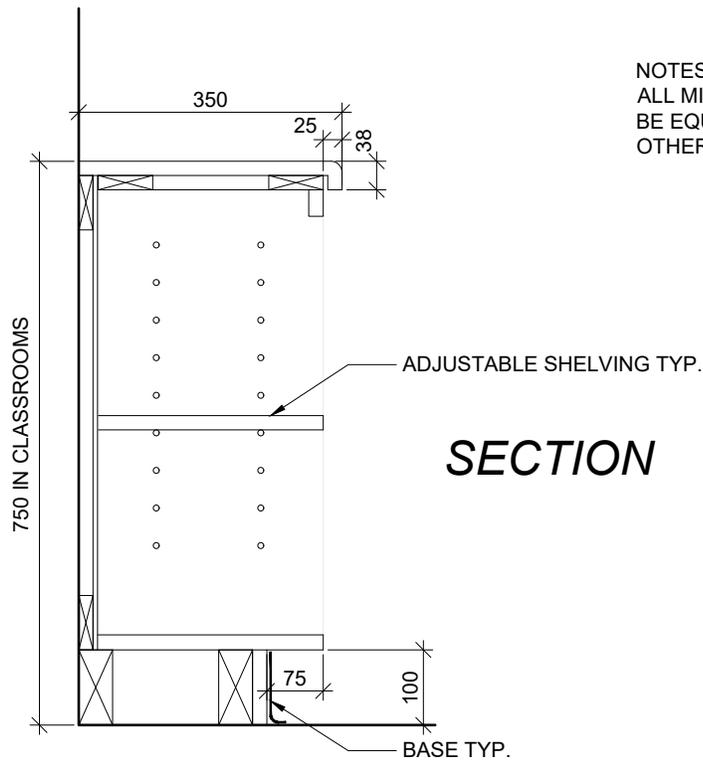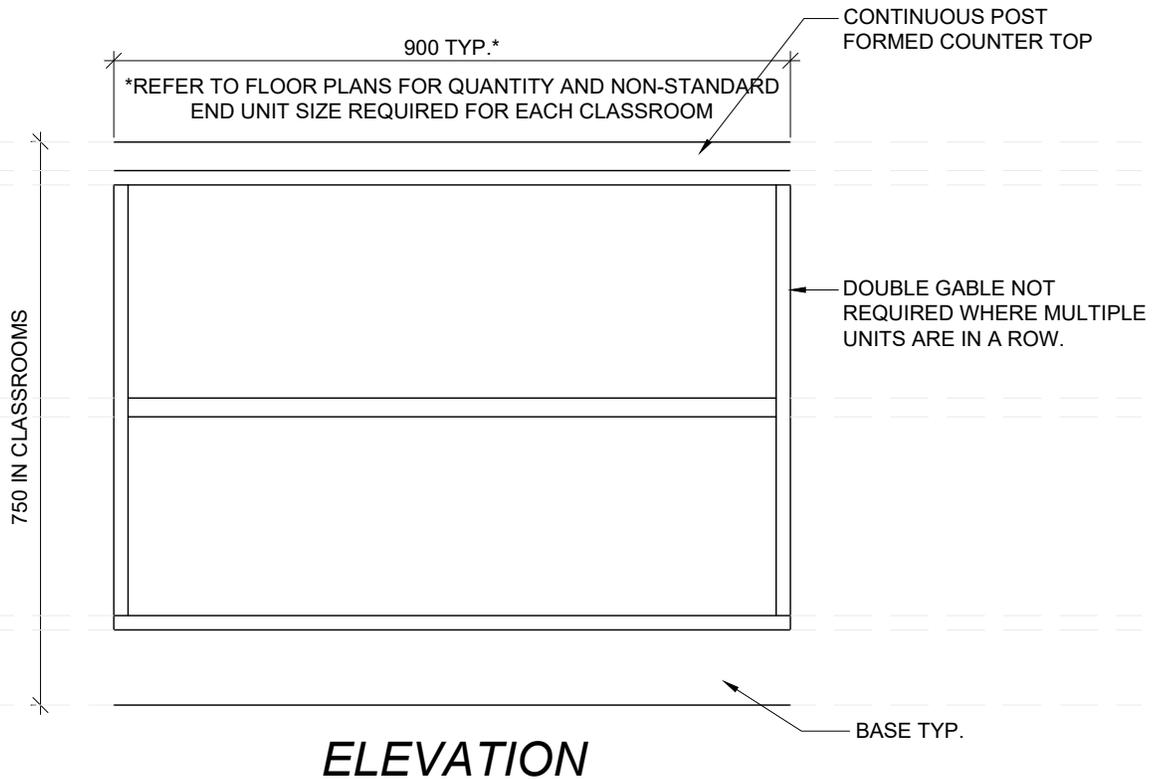

NOTES:
ALL MILLWORK DOORS AND DRAWERS TO BE EQUIPT WITH LOCKS UNLESS OTHERWISE NOTED.



**CABINET TYPE B3 - OPEN SHELVING
CLASSROOMS**

PROJ: 22124
SCALE: 1:10
DRAWN: KB
DATE: 260105




ISSUE/REV.

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603

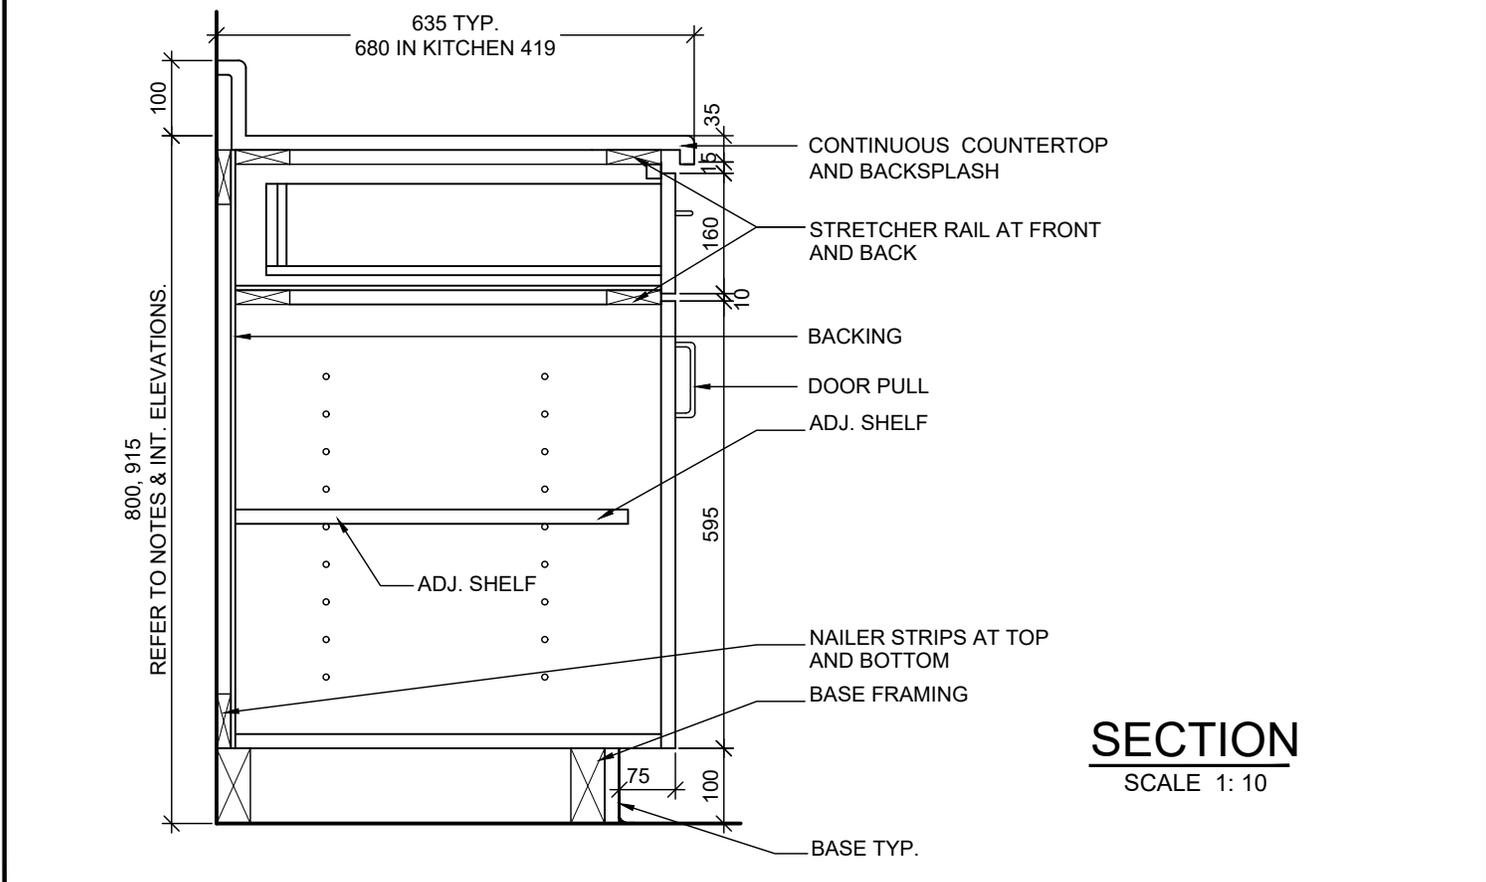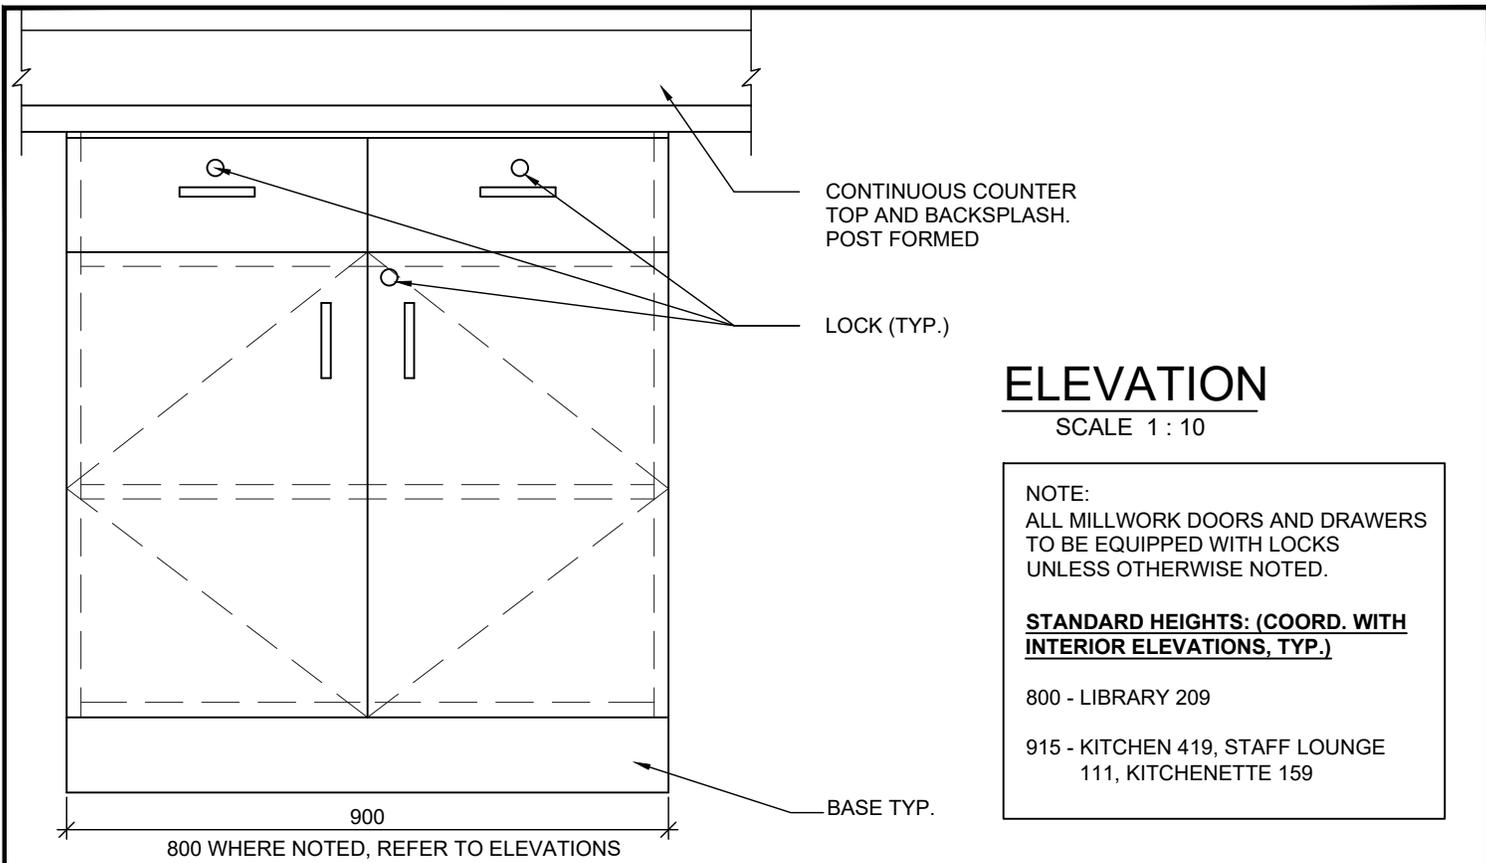

| | | | |
|---|--------------|-----------------------------|---------------|
| TYPE B6 - LOWER CABINET WITH DRAWERS | PROJ: 22124 | HOSSACK ARCHITECTURE | ISSUE/REV. 00 |
| | SCALE: 1:10 | | AD 606 |
| | DRAWN: KB | | |
| | DATE: 260105 | | |

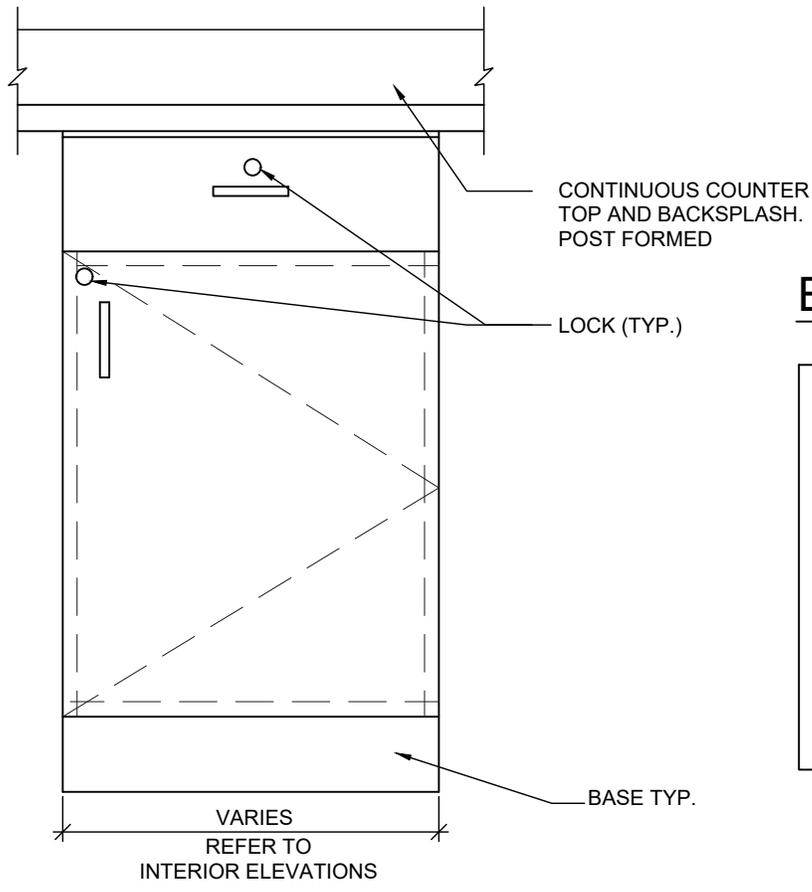

ELEVATION

SCALE 1 : 10


NOTE:
ALL MILLWORK DOORS AND DRAWERS TO BE EQUIPPED WITH LOCKS UNLESS OTHERWISE NOTED.

STANDARD HEIGHTS: (COORD. WITH INTERIOR ELEVATIONS, TYP.)

800 - LIBRARY 209

865 - KITCHENETTE 151

915 - KITCHEN 419, KITCHENETTE 159, LAUNDRY 418.

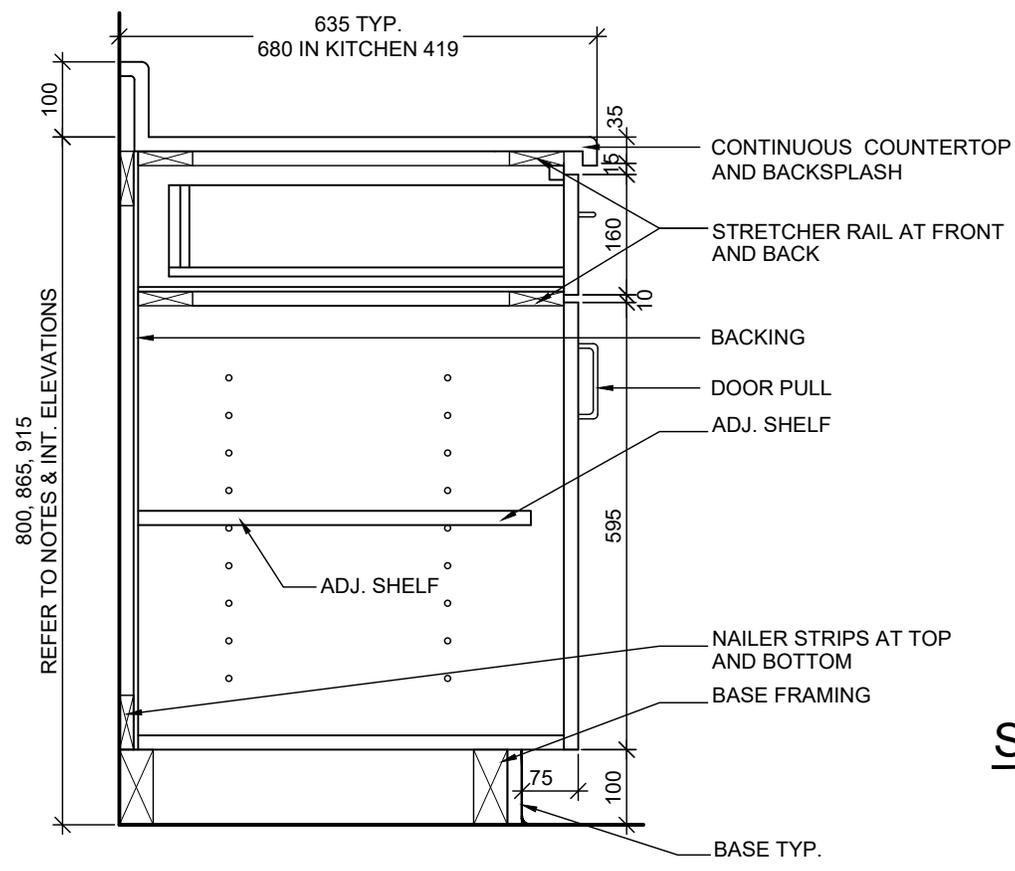

SECTION

SCALE 1 : 10


TYPE B8

| | |
|--------|--------|
| PROJ: | 22124 |
| SCALE: | 1:10 |
| DRAWN: | KB |
| DATE: | 260105 |




ISSUE/REV.
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608

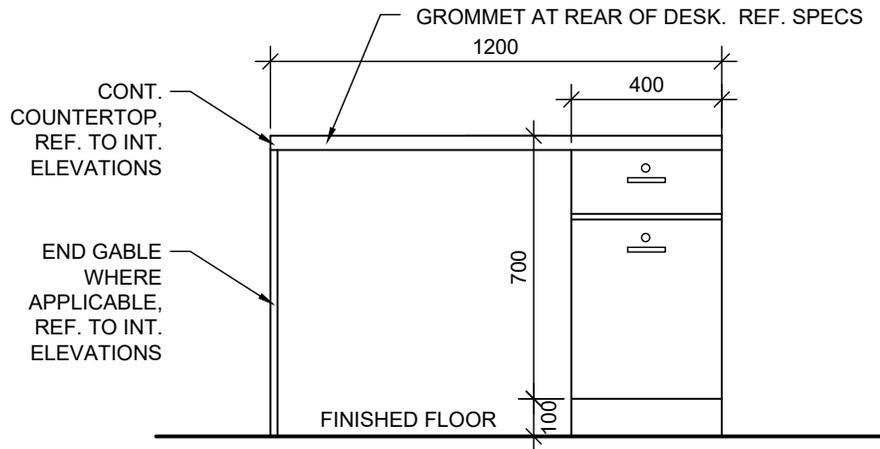

ELEVATION

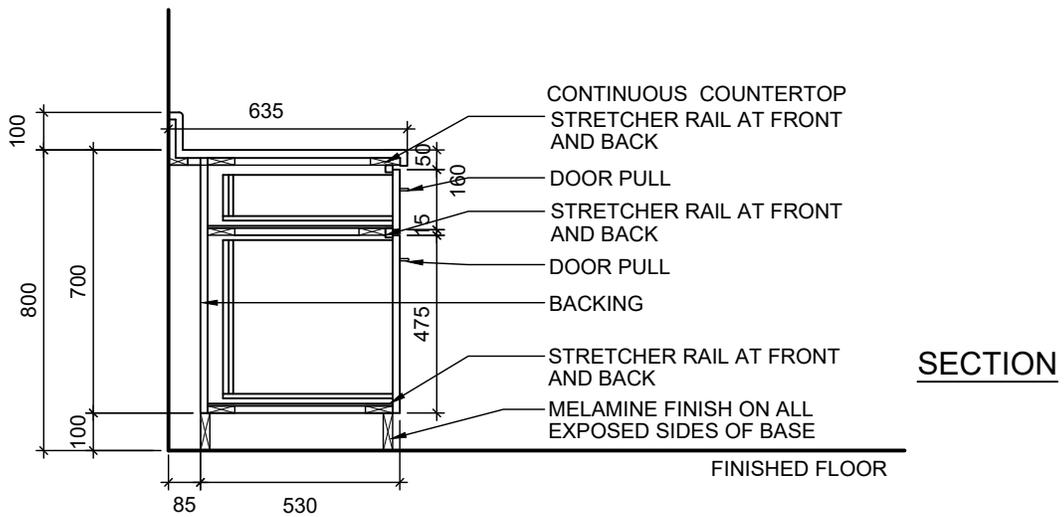

SECTION

TYPE B9 - DESK COUNTER - LIFE SKILLS

PROJ: 22124

SCALE: 1:20

DRAWN: KB


DATE: 260105

HOSSACK
ARCHITECTURE




ISSUE/REV.
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609

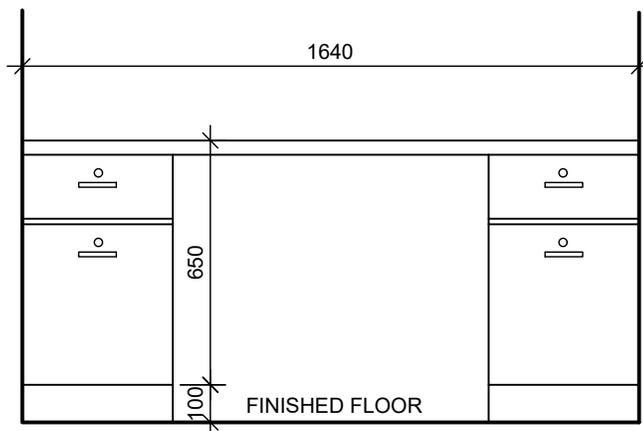

ELEVATION

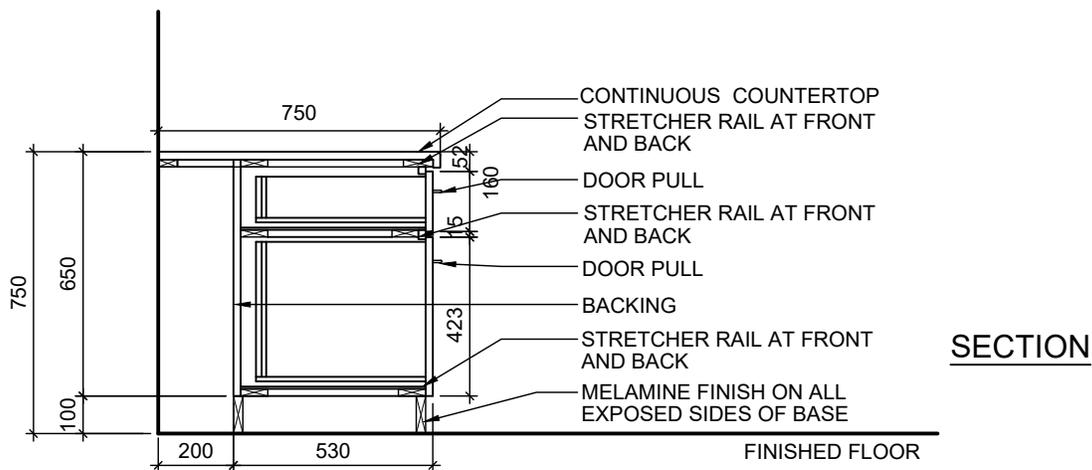

SECTION

TYPE B12 - GYM INSTRUCTOR DESK

PROJ: 22124

SCALE: 1:20

DRAWN: GB


DATE: 260105

HOSSACK
ARCHITECTURE




ISSUE/REV.
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613

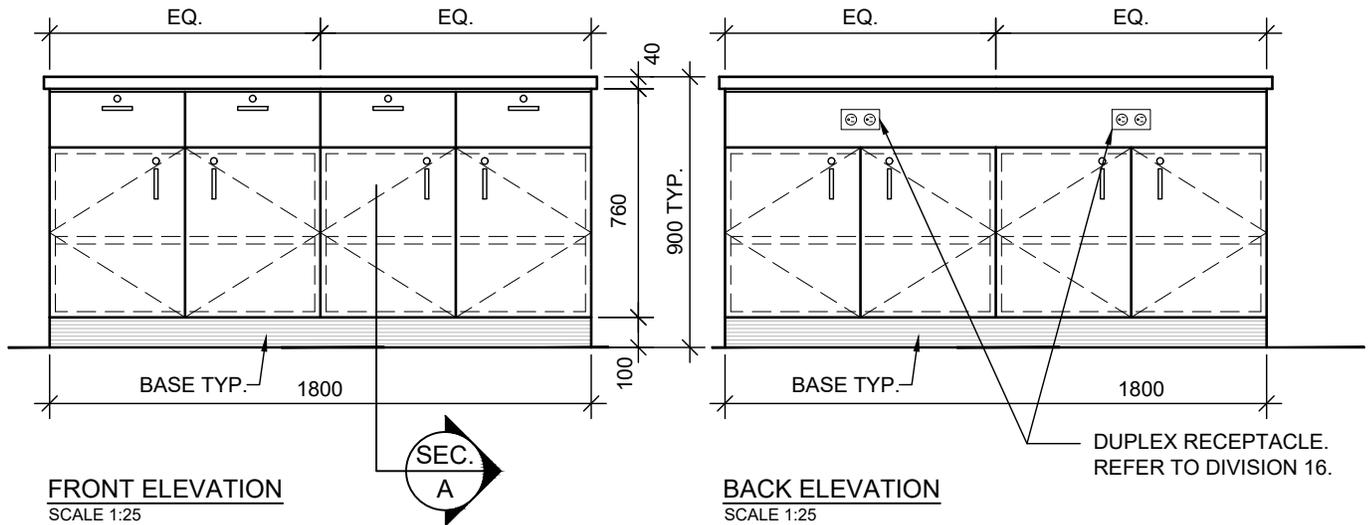

NOTE:
REFER TO SPECIFICATIONS FOR MILLWORK CONSTRUCTION AND HARDWARE.

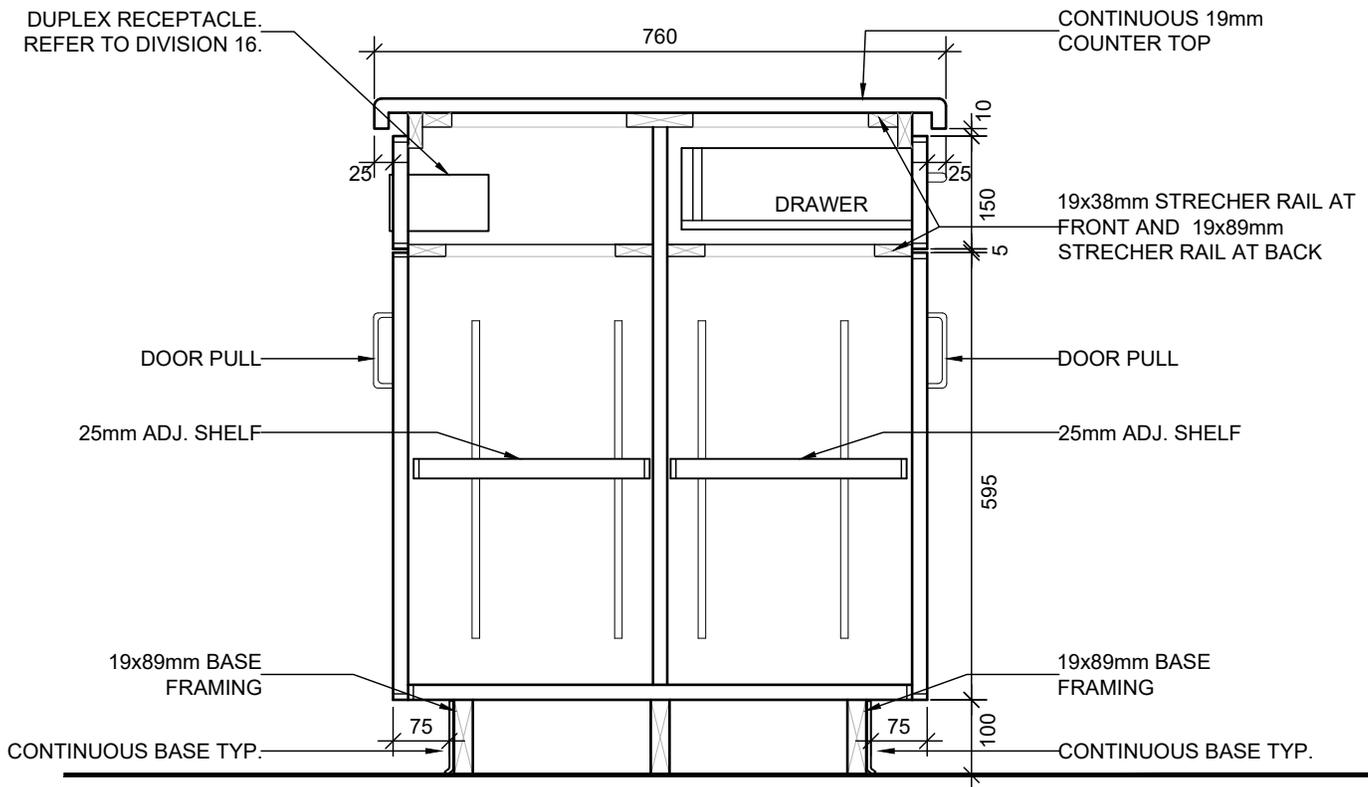


TYPE B14 - STAFF ROOM ISLAND

PROJ: 22124
SCALE: 1:10
DRAWN: CC
DATE: 260105



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AD
614

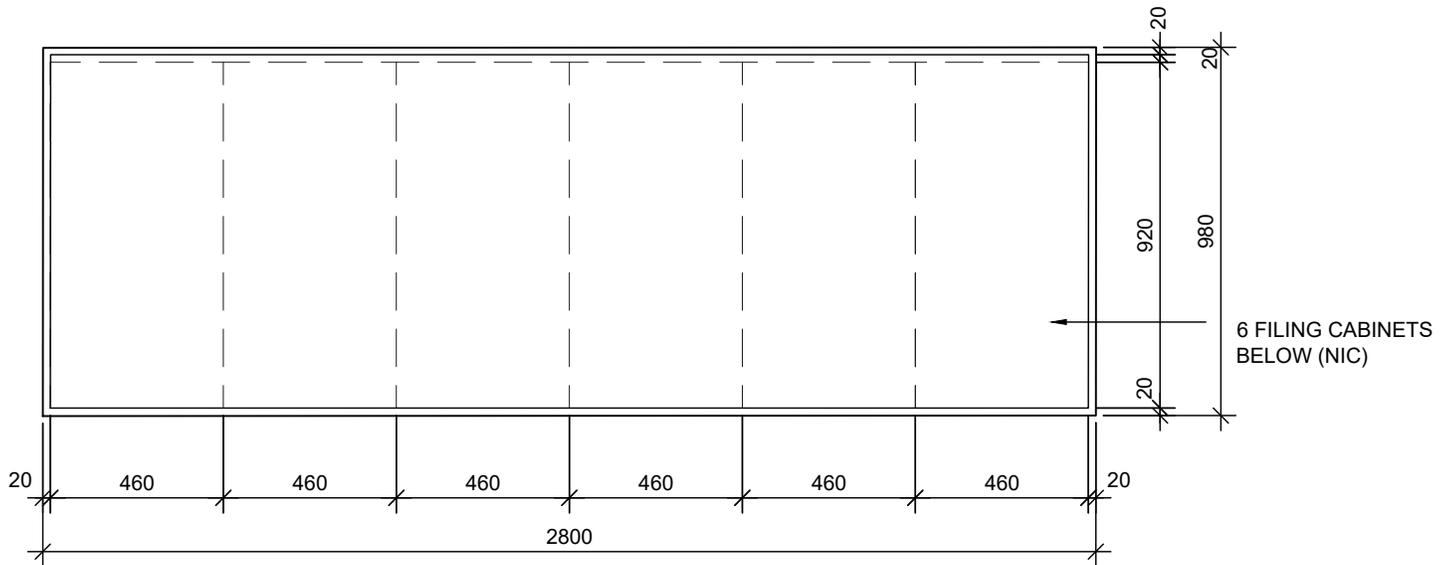

PLAN
SCALE 1:20

SOLID WOOD EDGING. STAIN FINISH.
CHAMFERED TOP AND BOTTOM EDGES TO
MATCH ADJACENT RECEPTION DESK
19mm COUNTERTOP. PLAM FINISH



SECTION
SCALE 1:10

NOTE: EXACT SIZE AND
LOCATION TO BE CONFIRMED
ON SITE WITH OWNER PRIOR
TO FABRICATION


TYPE B15
OSR CABINET COUNTERTOP

PROJ: 22124
SCALE: NOTED
DRAWN: CC
DATE: 260105



ISSUE/REV.
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AD
615

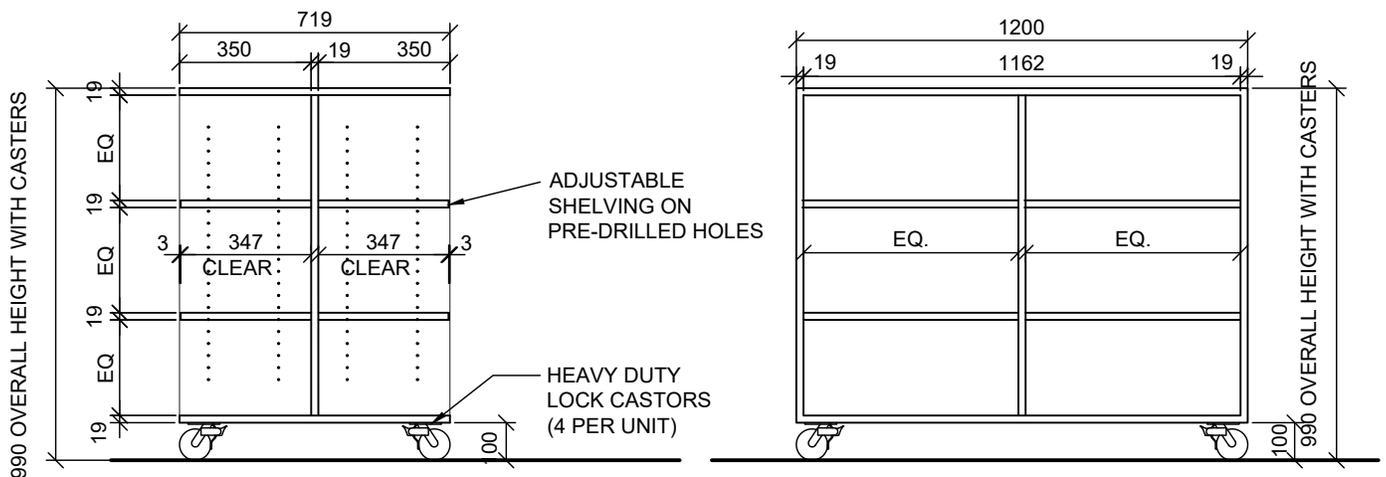

SECTION

ELEVATION

NOTE:
 REFER TO SPECIFICATION FOR
 MILLWORK CONSTRUCTION AND
 HARDWARE.


**CABINET TYPE B26:
 MOBILE BOOK SHELVING**

| | |
|--------|--------|
| PROJ: | 22124 |
| SCALE: | 1:20 |
| DRAWN: | KB |
| DATE: | 260105 |



ISSUE/REV.
 IFC

AD
 619

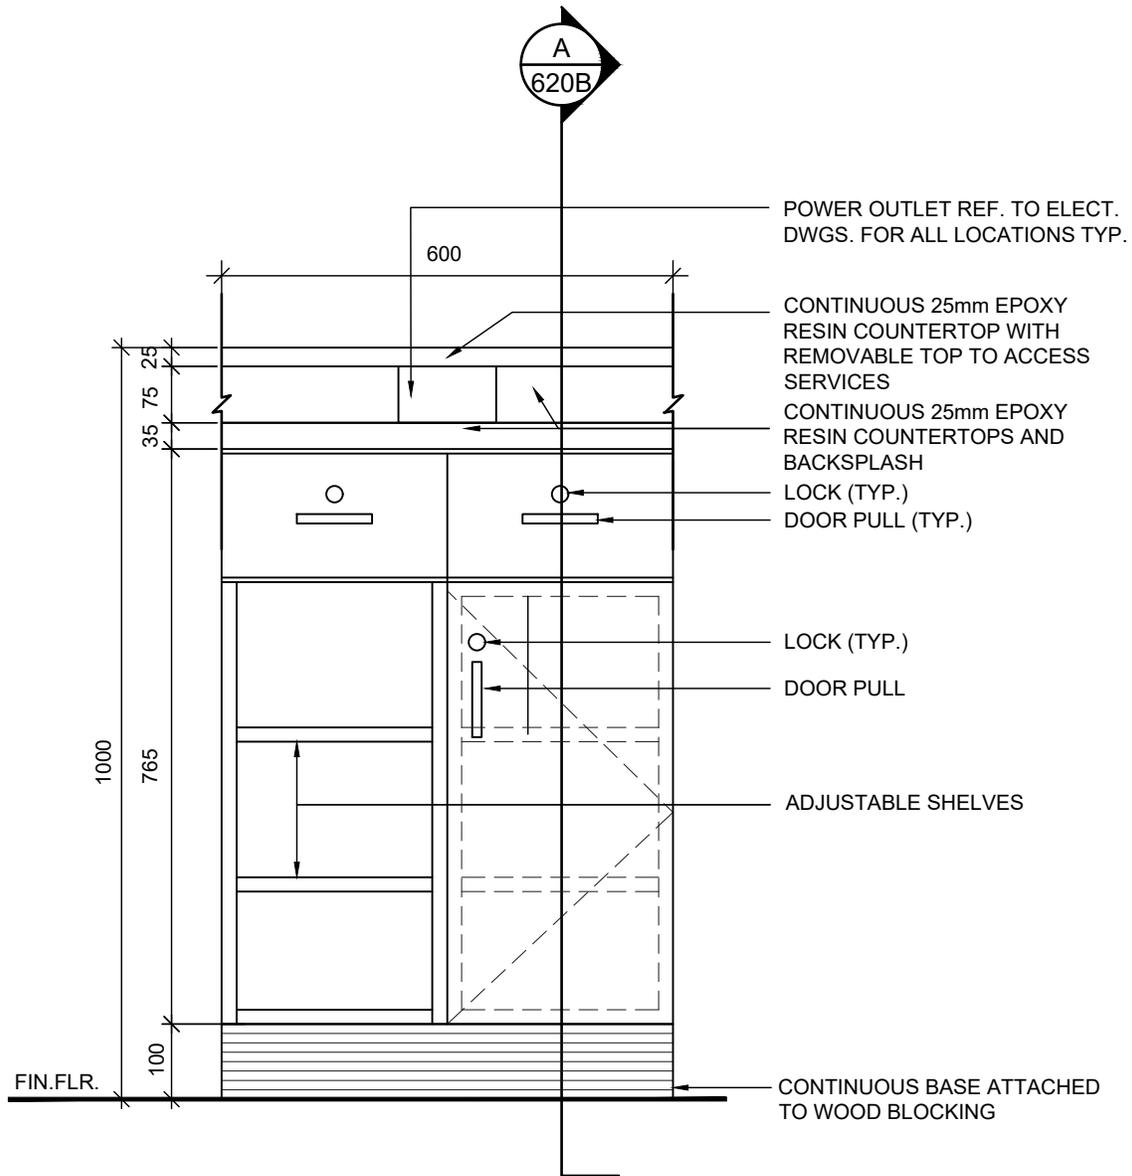

NOTE:
ALL MILLWORK DOORS AND DRAWERS
TO BE EQUIPPED WITH LOCKS
UNLESS OTHERWISE NOTED.

REFER TO INTERIOR ELEVATIONS
FOR DOOR SWING DIRECTION.

**CABINET TYPE B27 - SCIENCE ROOM
MILLWORK WITH MECHANICAL CHASE &
SHELVING - ELEVATION**

PROJ: 22124

SCALE: 1:10


DRAWN: KB

DATE: 260105



ISSUE/REV.

AD
620A

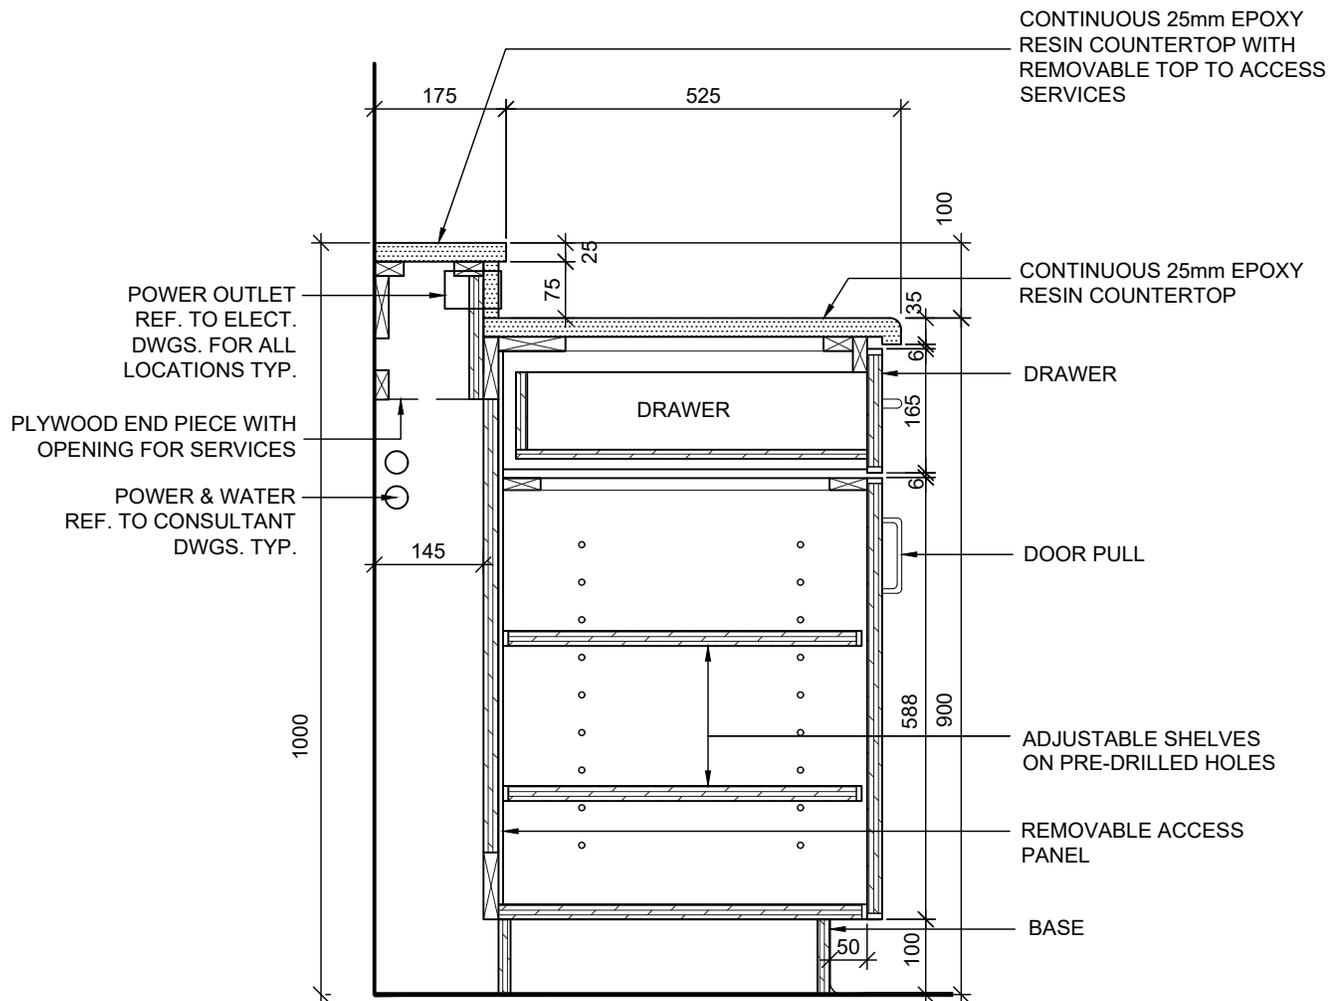

NOTE:
 ALL MILLWORK DOORS AND DRAWERS
 TO BE EQUIPPED WITH LOCKS
 UNLESS OTHERWISE NOTED.

REFER TO INTERIOR ELEVATIONS
 FOR DOOR SWING DIRECTION.

**CABINET TYPE B27 - SCIENCE ROOM
 MILLWORK WITH MECHANICAL CHASE &
 SHELVING - SECTION**

PROJ: 22124

SCALE: 1:10

DRAWN: KB


DATE: 260105

**HOSSACK
 ARCHITECTURE**



ISSUE/REV.
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AD
620B

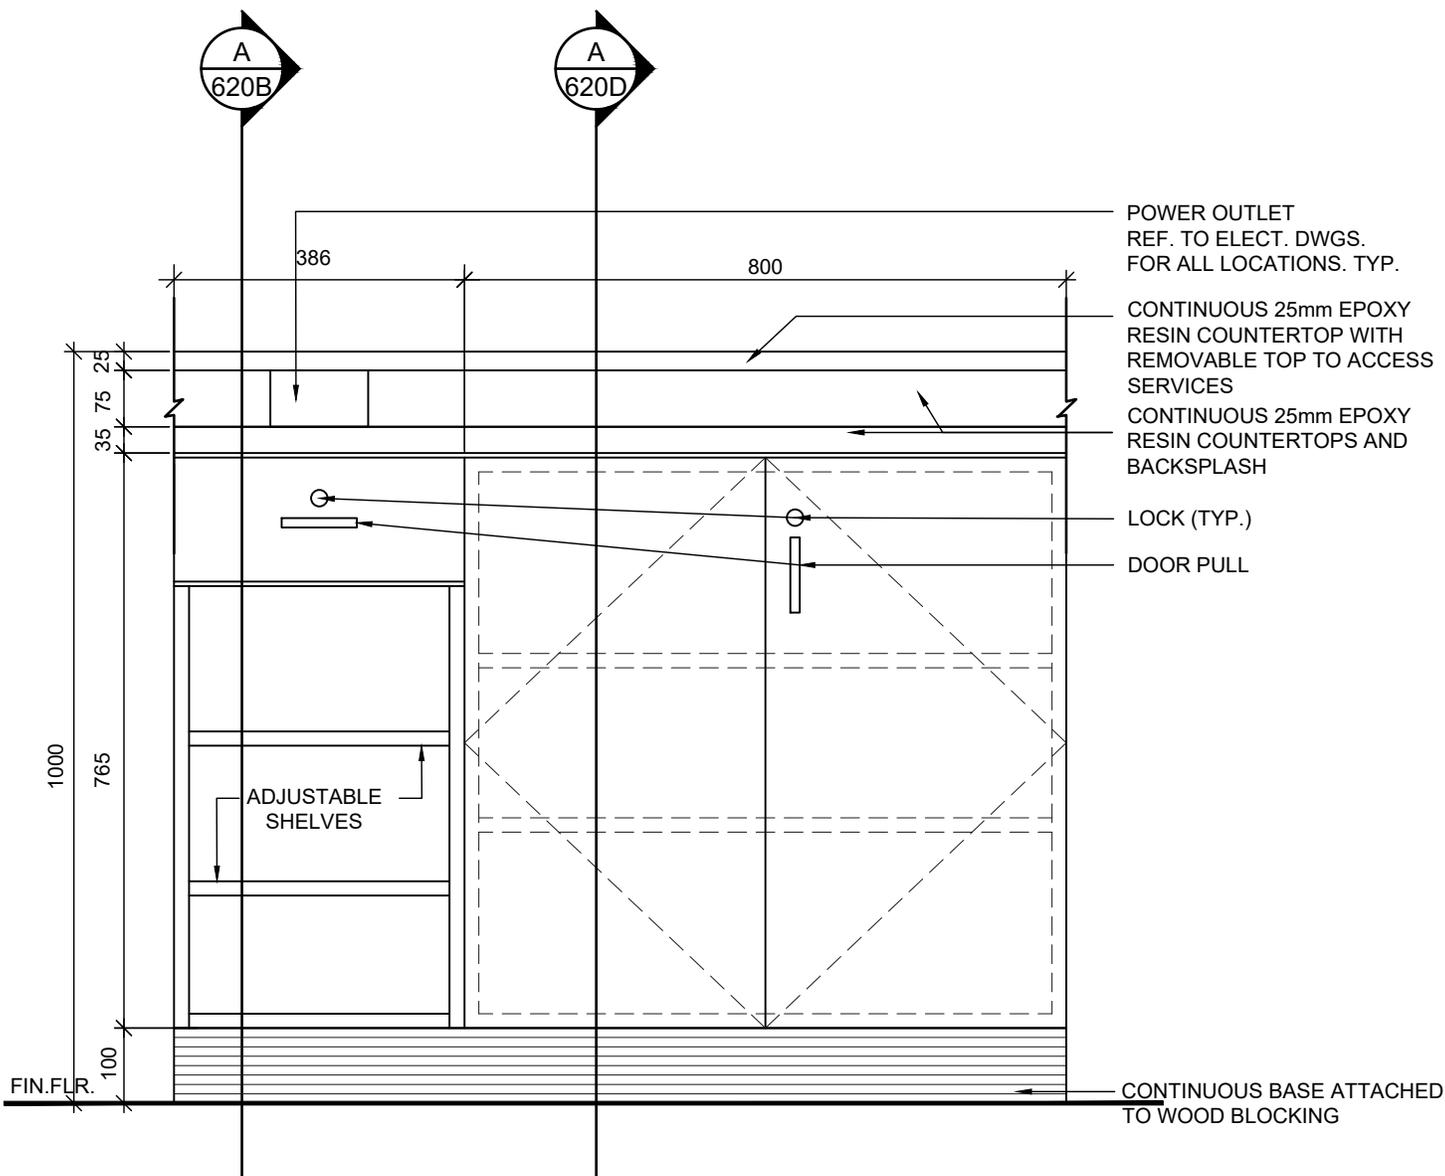

NOTE:
 ALL MILLWORK DOORS AND DRAWERS
 TO BE EQUIPPED WITH LOCKS
 UNLESS OTHERWISE NOTED.


REFER TO INTERIOR ELEVATIONS
 FOR DOOR SWING DIRECTION.

**CABINET TYPE B27A - SCIENCE ROOM
 MILLWORK WITH MECHANICAL CHASE &
 SHELVING - ELEVATION**

| | |
|--------|--------|
| PROJ: | 22124 |
| SCALE: | 1:10 |
| DRAWN: | KB |
| DATE: | 260105 |



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| ISSUE/REV. ADD#1 |
| AD 620C |

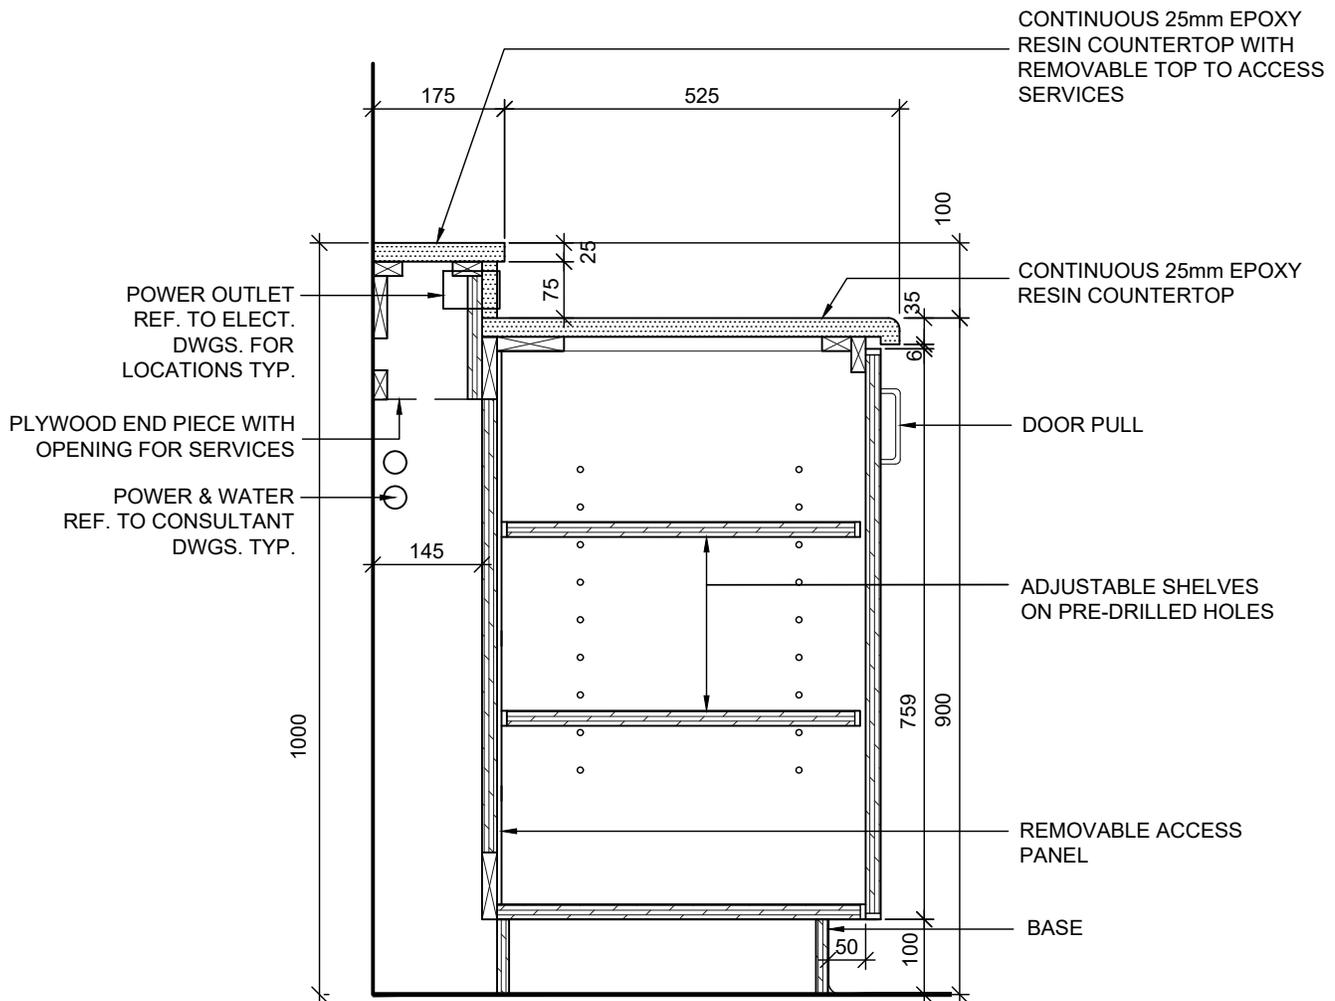

NOTE:
 ALL MILLWORK DOORS AND DRAWERS
 TO BE EQUIPPED WITH LOCKS
 UNLESS OTHERWISE NOTED.

REFER TO INTERIOR ELEVATIONS
 FOR DOOR SWING DIRECTION.

**CABINET TYPE B27A - SCIENCE ROOM
 MILLWORK WITH MECHANICAL CHASE &
 SHELVING - SECTION**

PROJ: 22124

SCALE: 1:10



DRAWN: KB

DATE: 260105



ISSUE/REV.
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AD
 620D

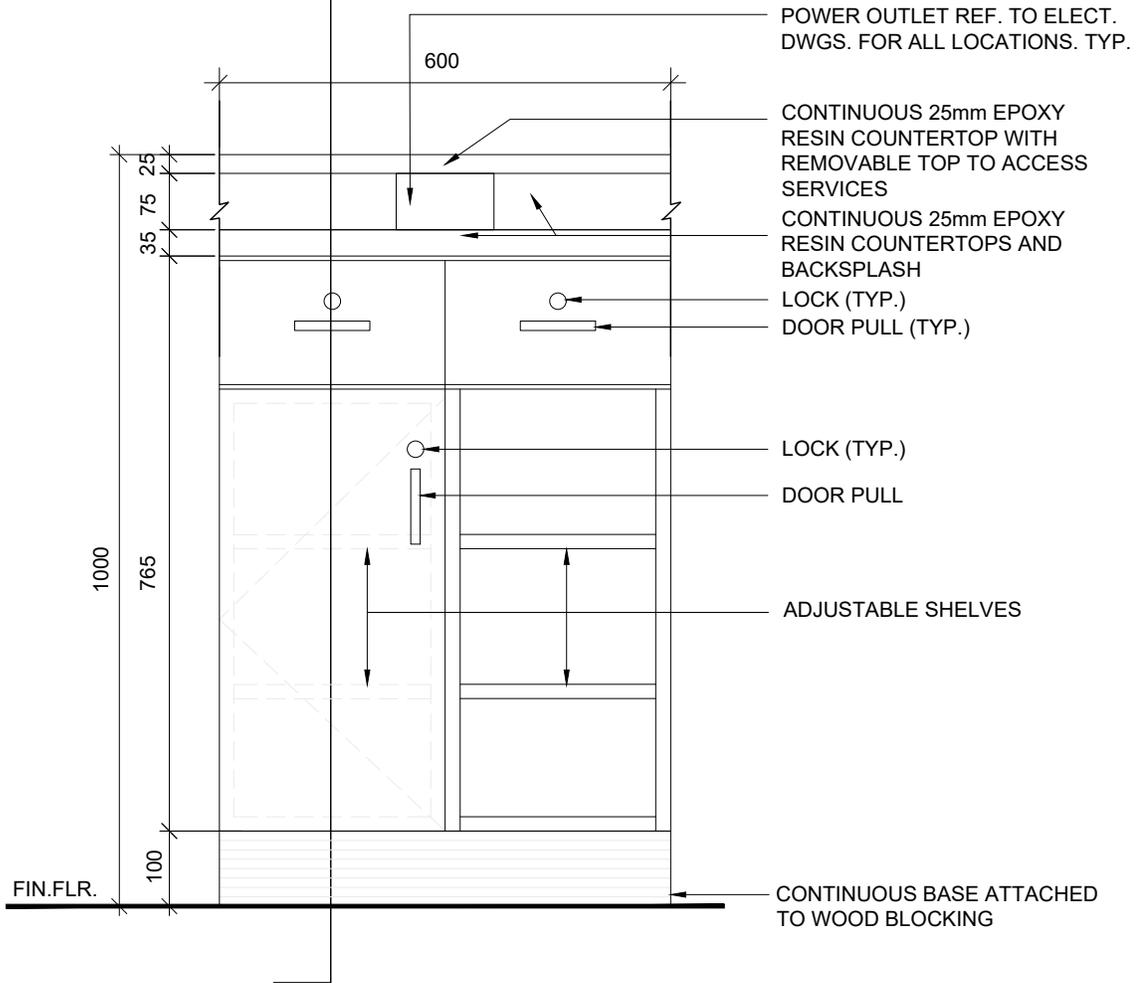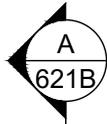

NOTE:
 ALL MILLWORK DOORS AND DRAWERS
 TO BE EQUIPPED WITH LOCKS
 UNLESS OTHERWISE NOTED.

REFER TO INTERIOR ELEVATIONS
 FOR DOOR SWING DIRECTION.


**CABINET TYPE B28 - SCIENCE ROOM
 MILLWORK WITH MECHANICAL CHASE &
 SHELVING - ELEVATION**

PROJ: 22124
 SCALE: 1:10
 DRAWN: KB
 DATE: 260105



ISSUE/REV.
 ADD#1

AD
621A

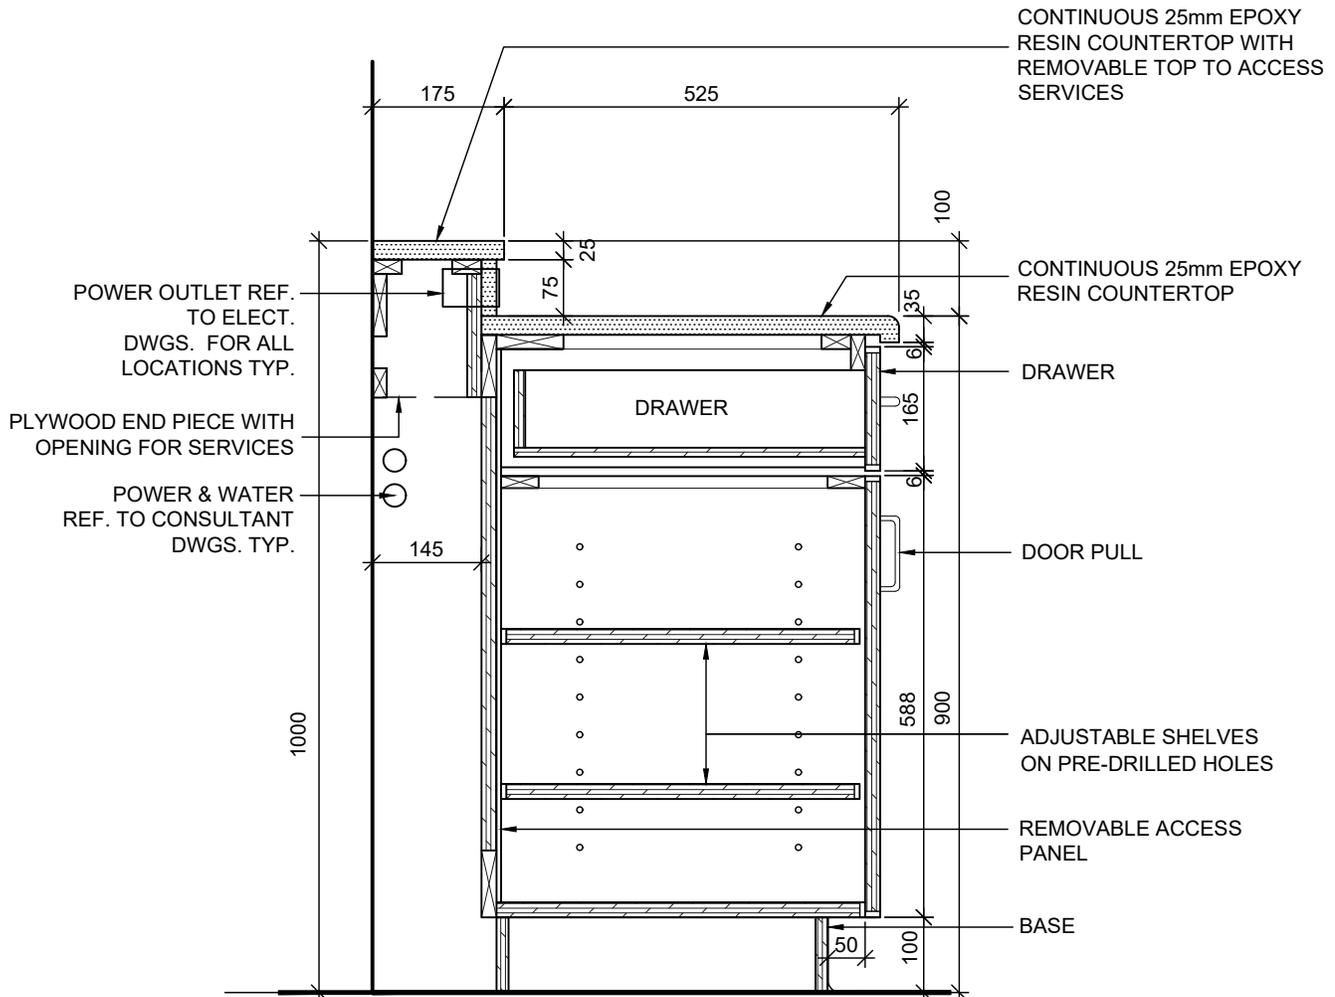

NOTE:
 ALL MILLWORK DOORS AND DRAWERS
 TO BE EQUIPPED WITH LOCKS
 UNLESS OTHERWISE NOTED.

REFER TO INTERIOR ELEVATIONS
 FOR DOOR SWING DIRECTION.

**CABINET TYPE B28 - SCIENCE ROOM
 MILLWORK WITH MECHANICAL CHASE &
 SHELVING - SECTION**

PROJ: 22124

SCALE: 1:10

DRAWN: KB


DATE: 260105

**HOSSACK
 ARCHITECTURE**



ISSUE/REV.
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AD
621B

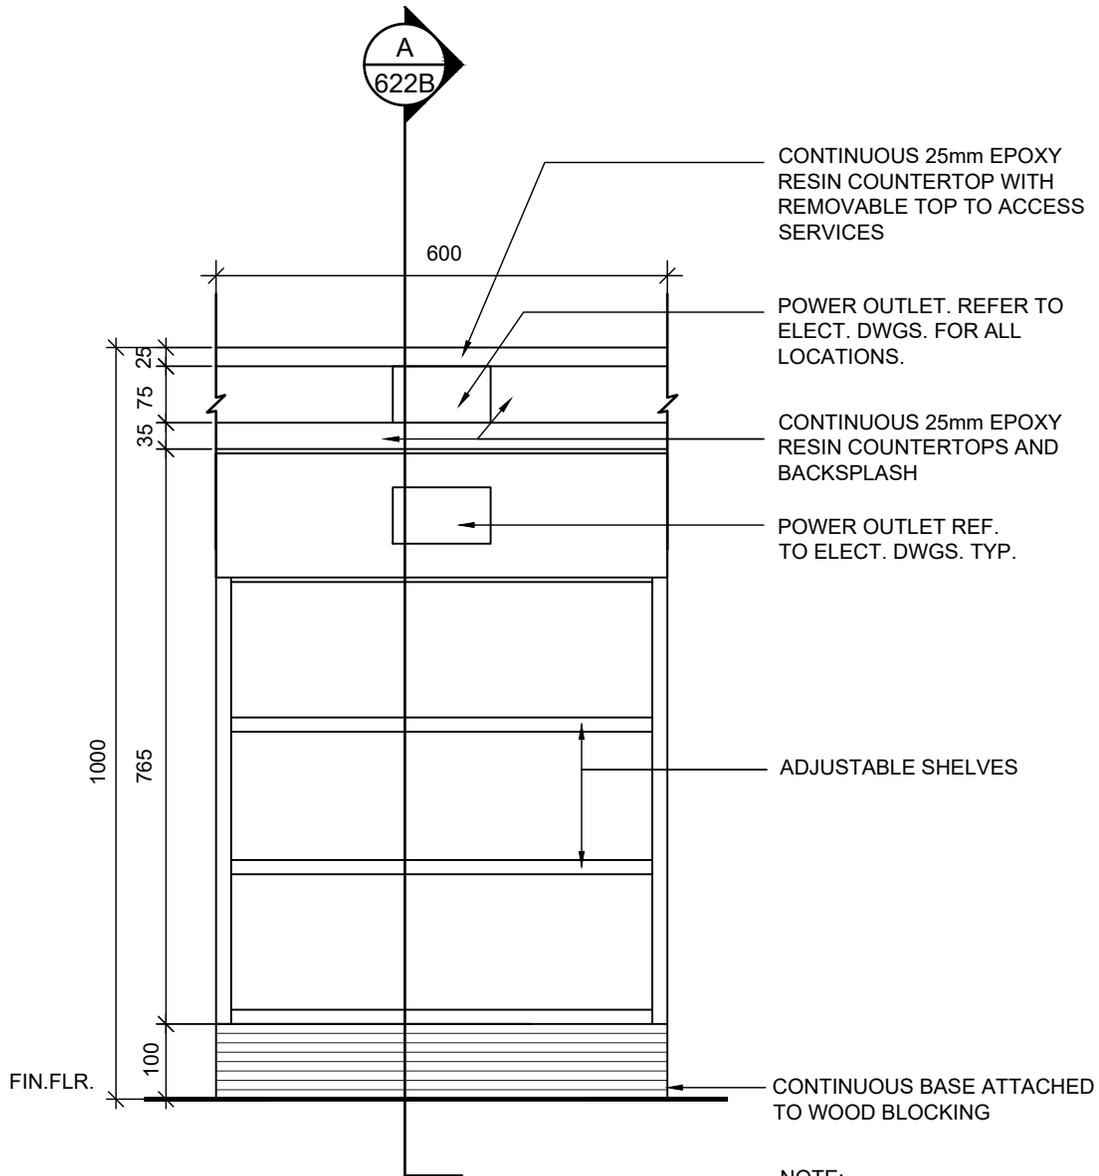

NOTE:
ALL MILLWORK DOORS AND DRAWERS TO BE EQUIPPED WITH LOCKS UNLESS OTHERWISE NOTED.

REFER TO INTERIOR ELEVATIONS FOR DOOR SWING DIRECTION.

ELECT. OUTLET NOT REQUIRED AT ALL B29 UNITS. REFER TO ELECT. DWGS. FOR FINAL ELECT. OUTLET PLACEMENT ON FRONT AND BACKSPLASH OF UNIT.

**CABINET TYPE B29 - SCIENCE ROOM
MILLWORK WITH MECHANICAL CHASE &
SHELVING - ELEVATION**

PROJ: 22124

SCALE: 1:10

DRAWN: KB


DATE: 260105

**HOSSACK
ARCHITECTURE**



ISSUE/REV.
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AD
622A

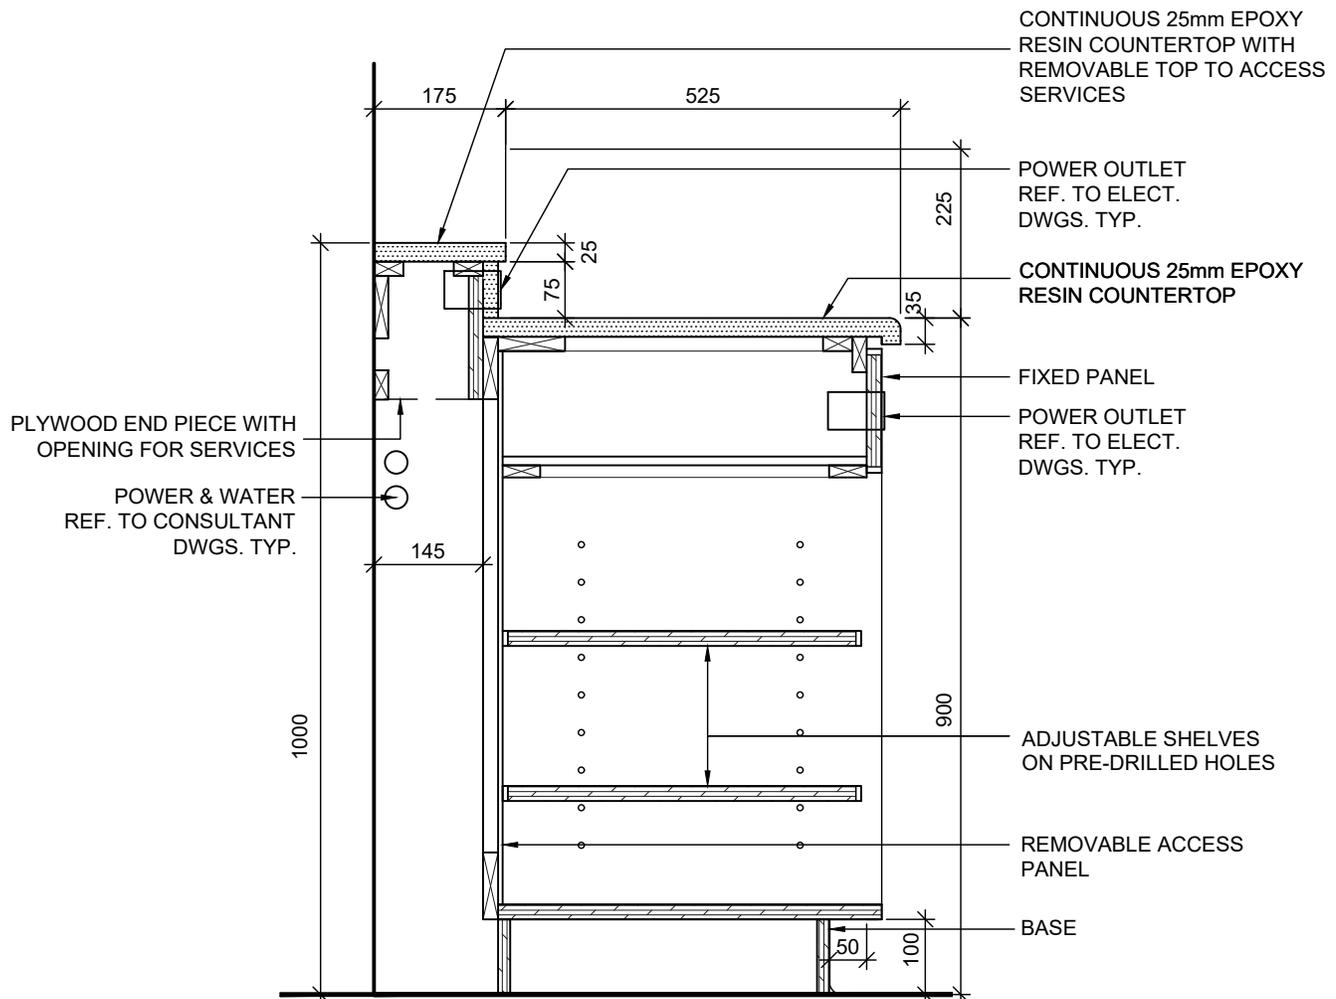

NOTE:
 ALL MILLWORK DOORS AND DRAWERS TO BE EQUIPPED WITH LOCKS UNLESS OTHERWISE NOTED.

REFER TO INTERIOR ELEVATIONS FOR DOOR SWING DIRECTION.

**CABINET TYPE B29 - SCIENCE ROOM
 MILLWORK WITH MECHANICAL CHASE &
 SHELVING - SECTION**

PROJ: 22124

SCALE: 1:10


DRAWN: KB

DATE: 260105



ISSUE/REV.
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AD
622B

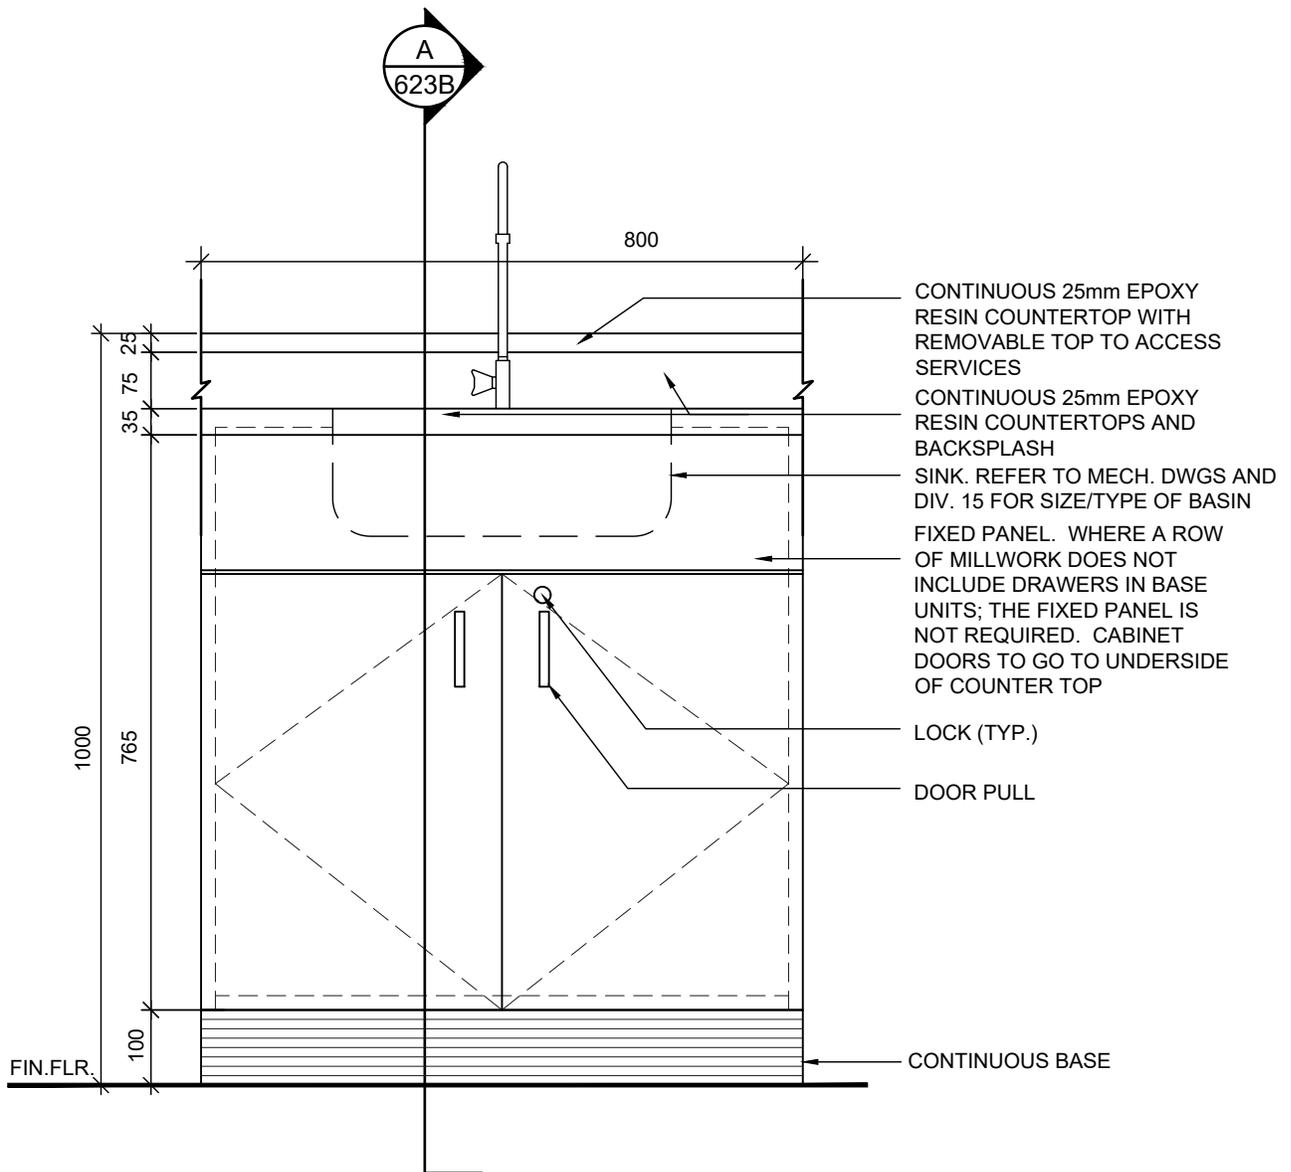

NOTE:
 ALL MILLWORK DOORS AND DRAWERS
 TO BE EQUIPPED WITH LOCKS
 UNLESS OTHERWISE NOTED.

REFER TO INTERIOR ELEVATIONS
 FOR DOOR SWING DIRECTION.

**CABINET TYPE B30 - SCIENCE ROOM
 SINK WITH MECHANICAL CHASE-
 ELEVATION**

PROJ: 22124

SCALE: 1:10


DRAWN: KB

DATE: 260105



ISSUE/REV.
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AD
623A

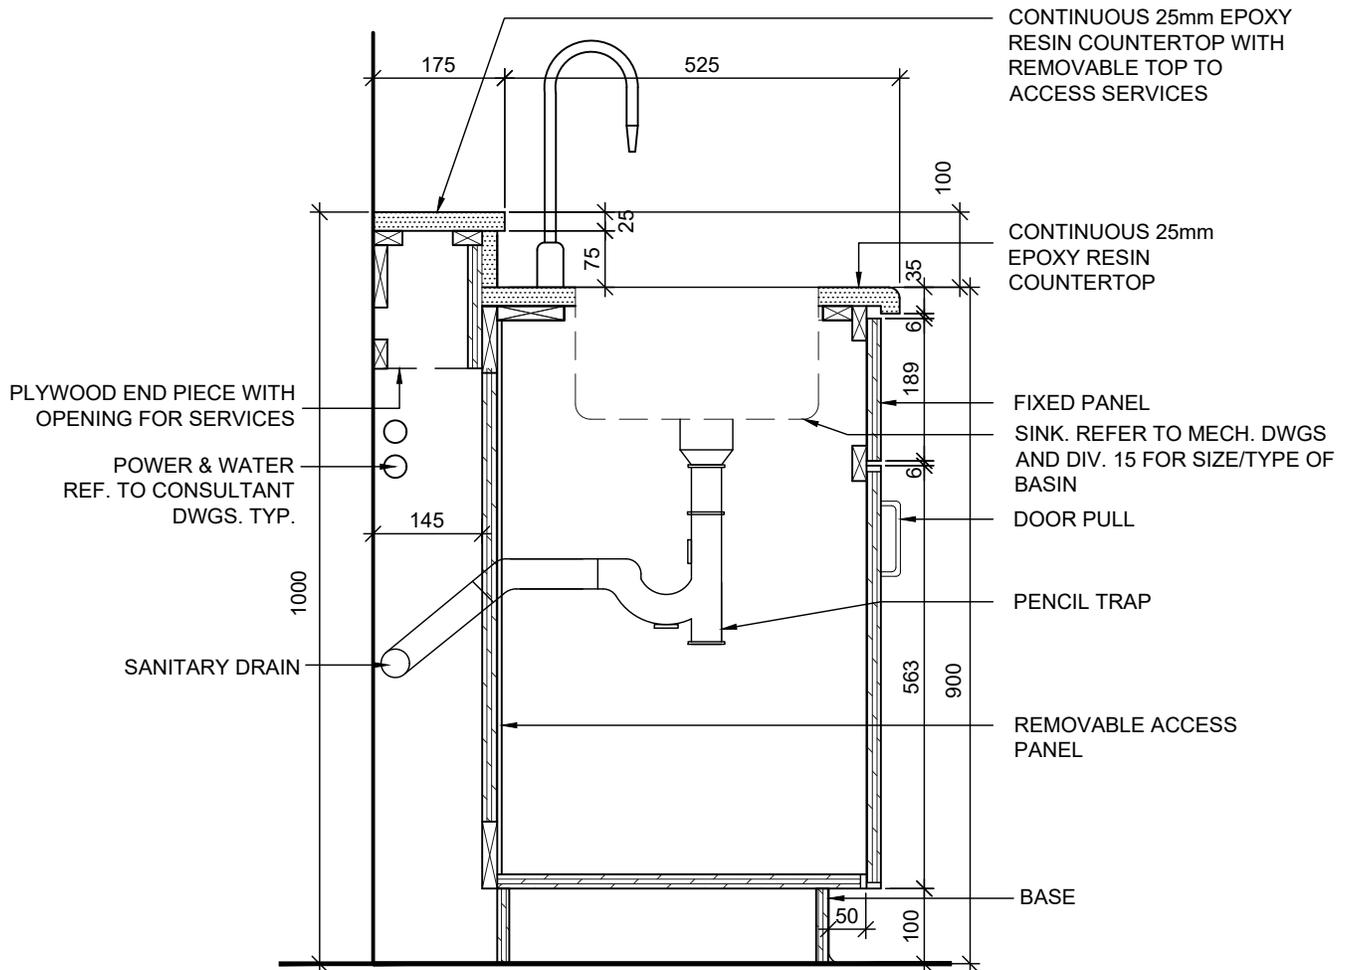

NOTE:
 ALL MILLWORK DOORS AND DRAWERS
 TO BE EQUIPPED WITH LOCKS
 UNLESS OTHERWISE NOTED.

REFER TO INTERIOR ELEVATIONS
 FOR DOOR SWING DIRECTION.


**CABINET TYPE B30 - SCIENCE ROOM
 SINK WITH MECHANICAL CHASE -
 SECTION**

| | |
|--------|--------|
| PROJ: | 22124 |
| SCALE: | 1:10 |
| DRAWN: | KB |
| DATE: | 260105 |



ISSUE/REV.
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623B

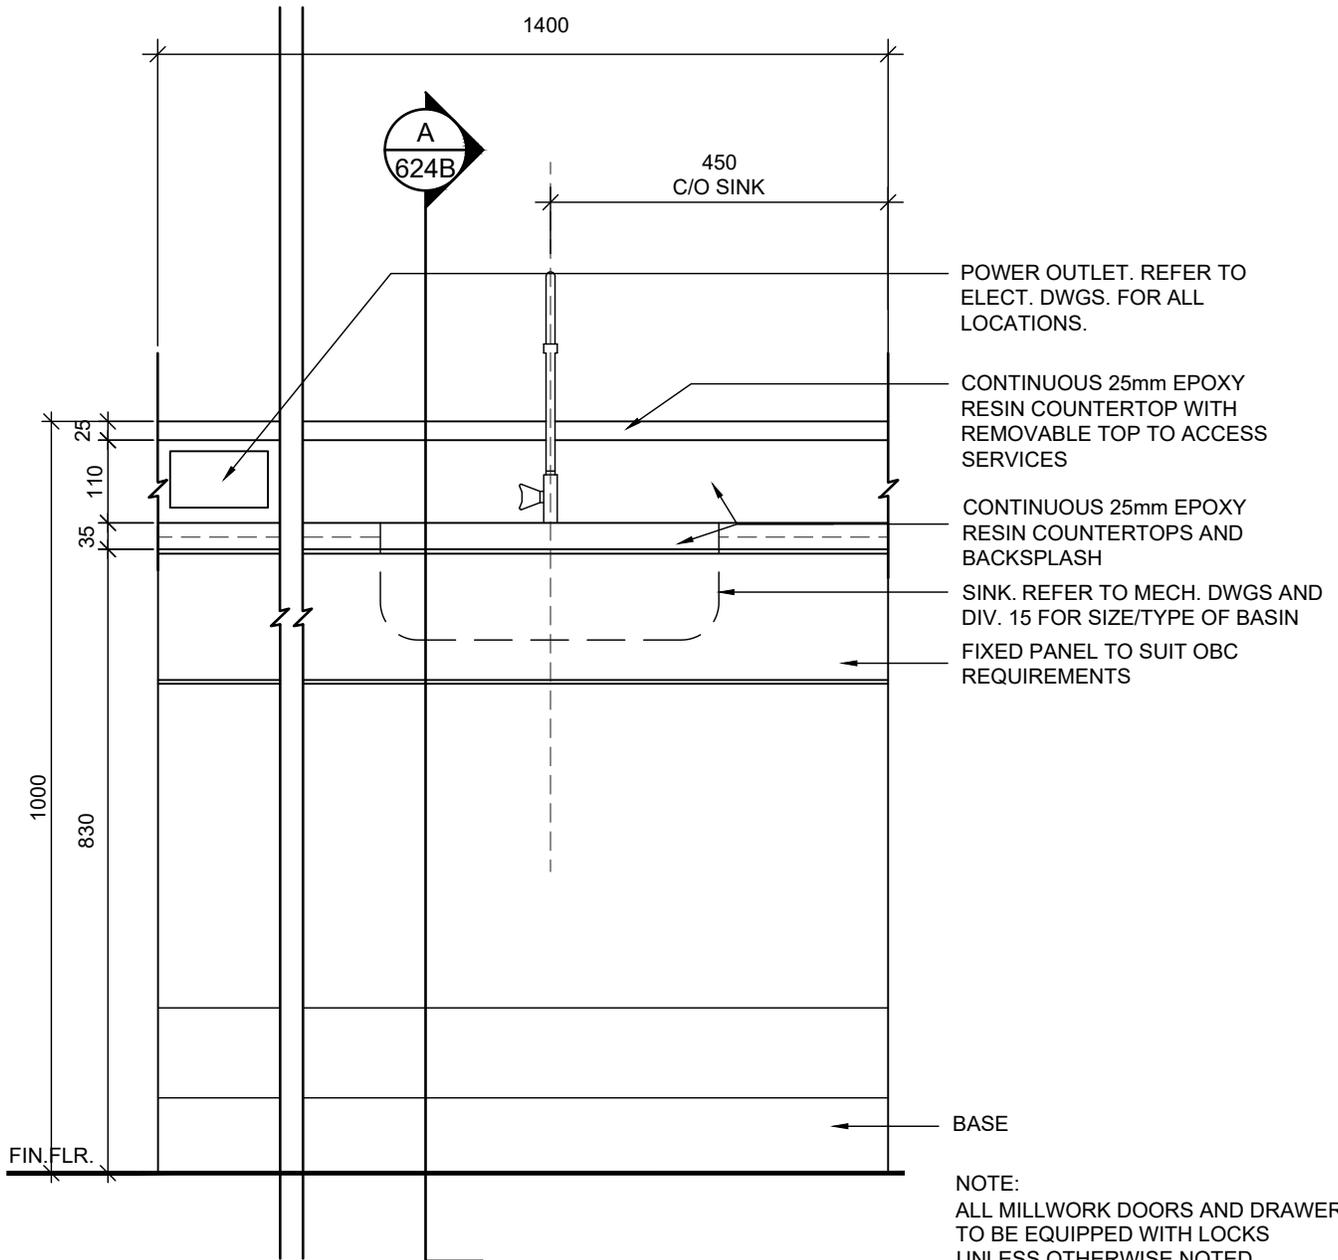

NOTE:
ALL MILLWORK DOORS AND DRAWERS TO BE EQUIPPED WITH LOCKS UNLESS OTHERWISE NOTED.

REFER TO INTERIOR ELEVATIONS FOR DOOR SWING DIRECTION.

REFER TO MECH. DWGS. AND COORDINATE WITH DIV 15 FOR SINK PLACEMENT

**CABINET TYPE B31 - SCIENCE ROOM
B/F MILLWORK WITH SINK - ELEVATION**

PROJ: 22124

SCALE: 1:10


DRAWN: KB

DATE: 260105



ISSUE/REV.
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624A

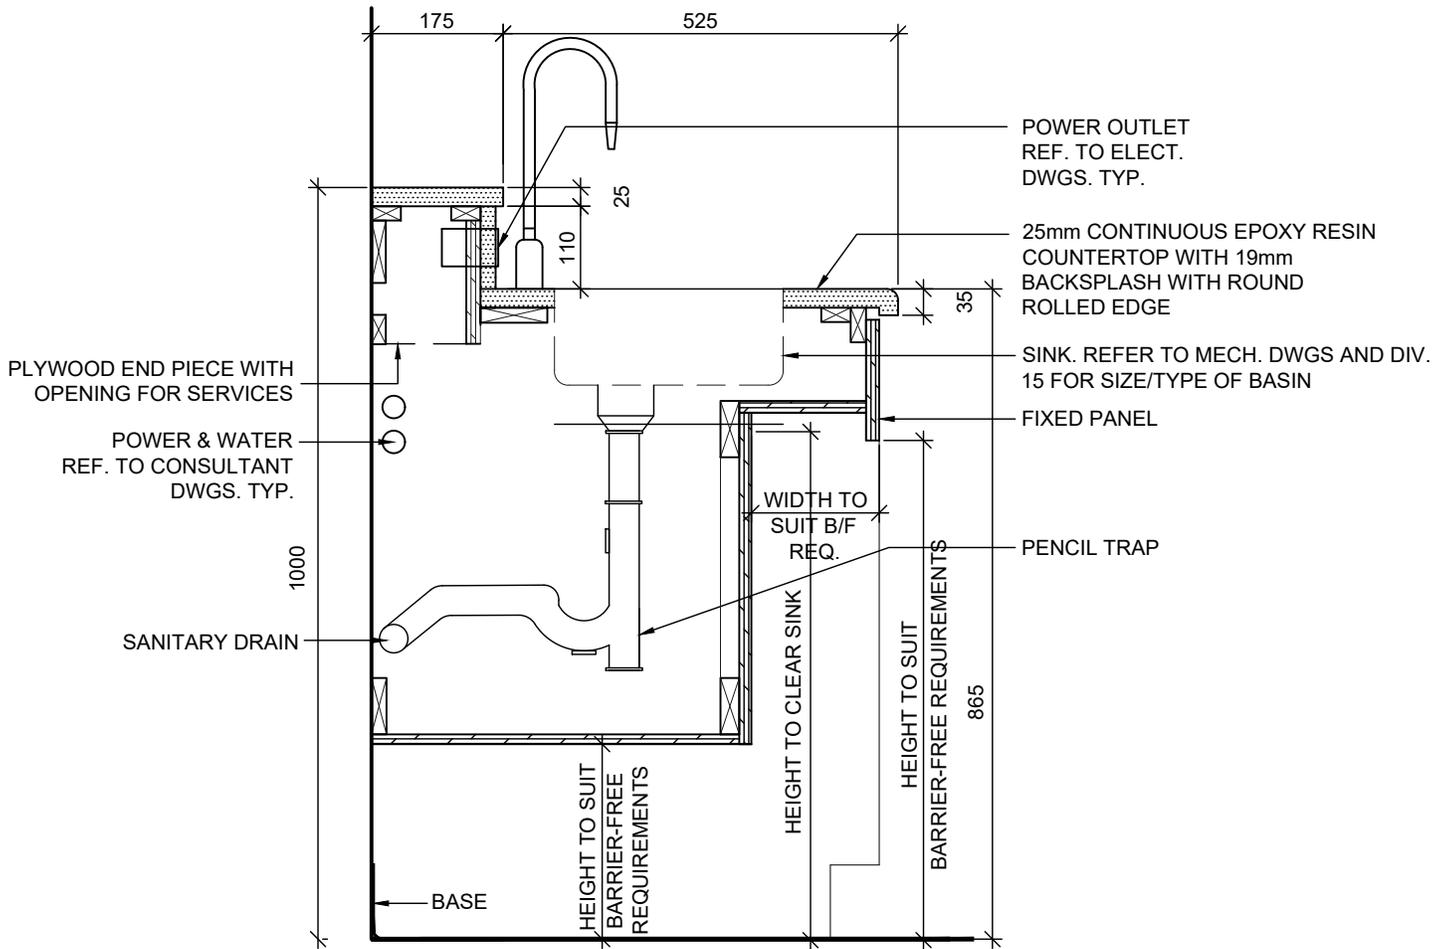

NOTE:
 ALL MILLWORK DOORS AND DRAWERS
 TO BE EQUIPPED WITH LOCKS
 UNLESS OTHERWISE NOTED.

REFER TO INTERIOR ELEVATIONS
 FOR DOOR SWING DIRECTION.


**CABINET TYPE B31 - SCIENCE ROOM
 B/F MILLWORK WITH SINK - SECTION**

PROJ: 22124
 SCALE: 1:10
 DRAWN: KB
 DATE: 260105



ISSUE/REV.
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AD
624B

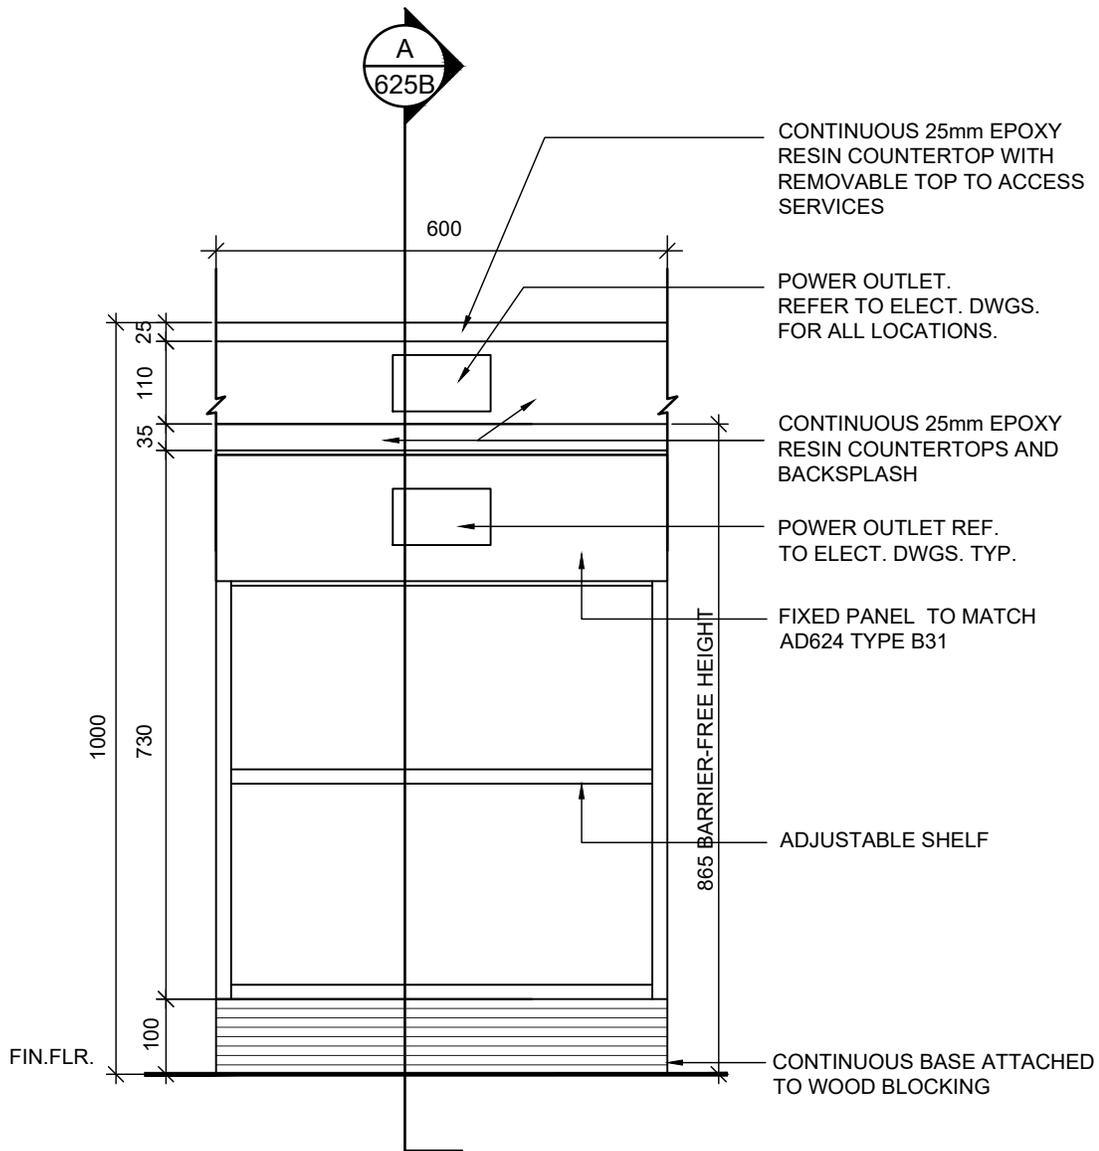

NOTE:
ALL MILLWORK DOORS AND DRAWERS TO BE EQUIPPED WITH LOCKS UNLESS OTHERWISE NOTED.

REFER TO INTERIOR ELEVATIONS FOR DOOR SWING DIRECTION.

**CABINET TYPE B32 - SCIENCE ROOM
B/F MILLWORK WITH MECHANICAL
CHASE & SHELVING - ELEVATION**

PROJ: 22124

SCALE: 1:10


DRAWN: KB

DATE: 260105



ISSUE/REV.
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AD
625A

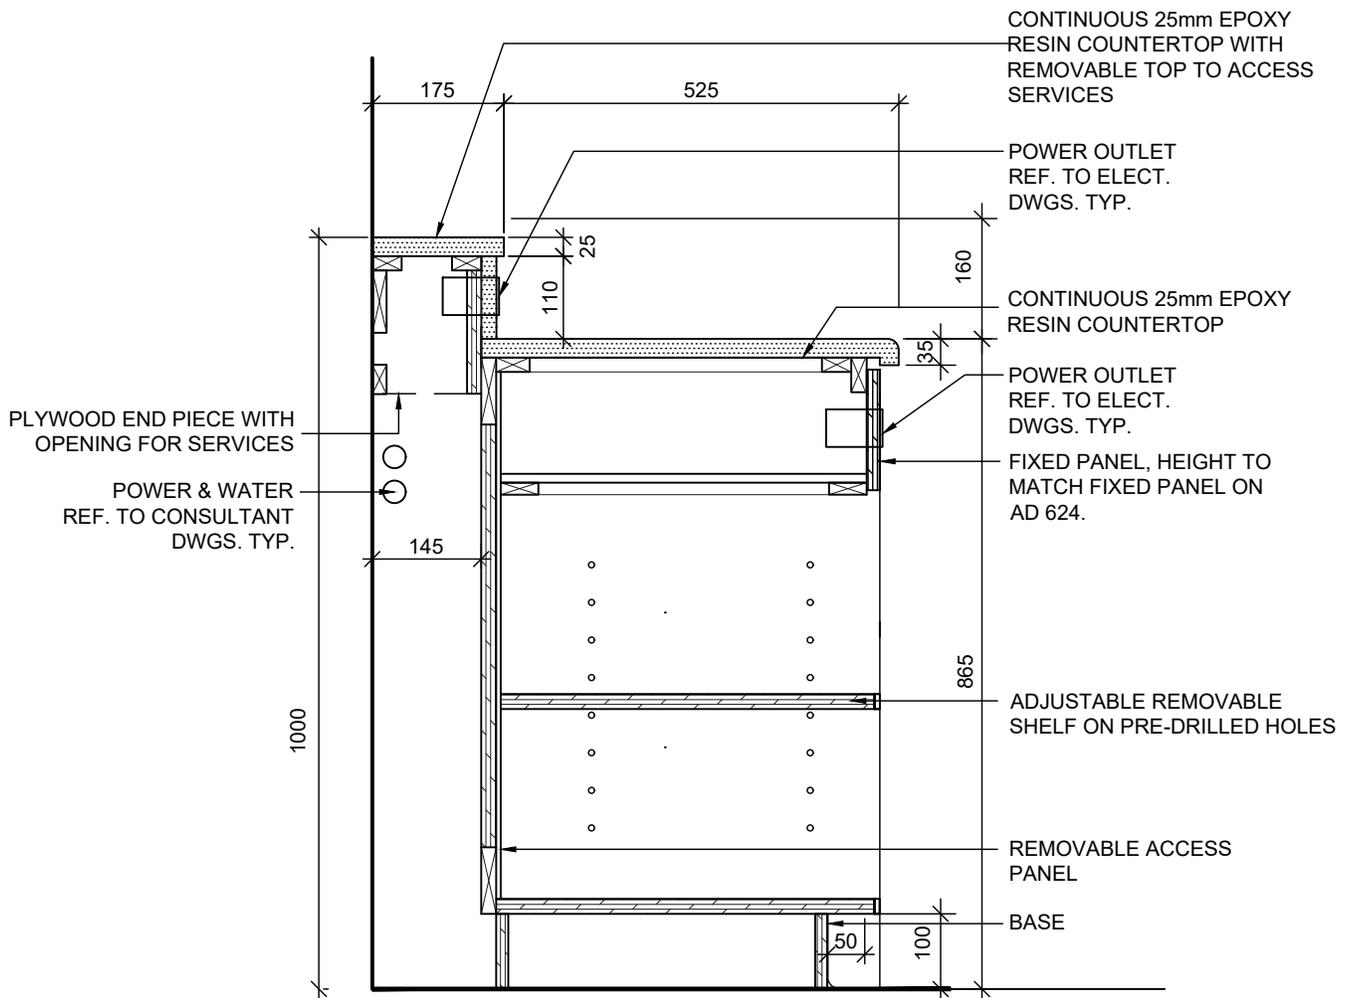

NOTE:
ALL MILLWORK DOORS AND DRAWERS TO BE EQUIPPED WITH LOCKS UNLESS OTHERWISE NOTED.

REFER TO INTERIOR ELEVATIONS FOR DOOR SWING DIRECTION.

**CABINET TYPE B32 - SCIENCE ROOM
B/F MILLWORK WITH MECHANICAL
CHASE & SHELVING - SECTION**

PROJ: 22124

SCALE: 1:10

DRAWN: KB


DATE: 260105

**HOSSACK
ARCHITECTURE**




ISSUE/REV.
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AD
625B

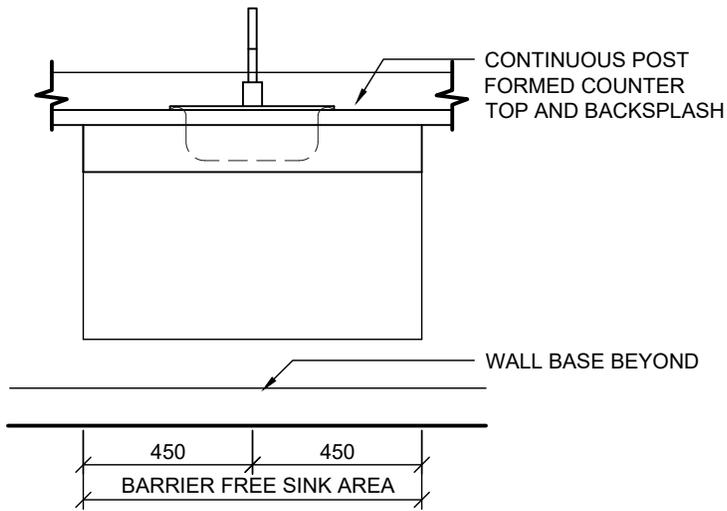

ELEVATION
1:20

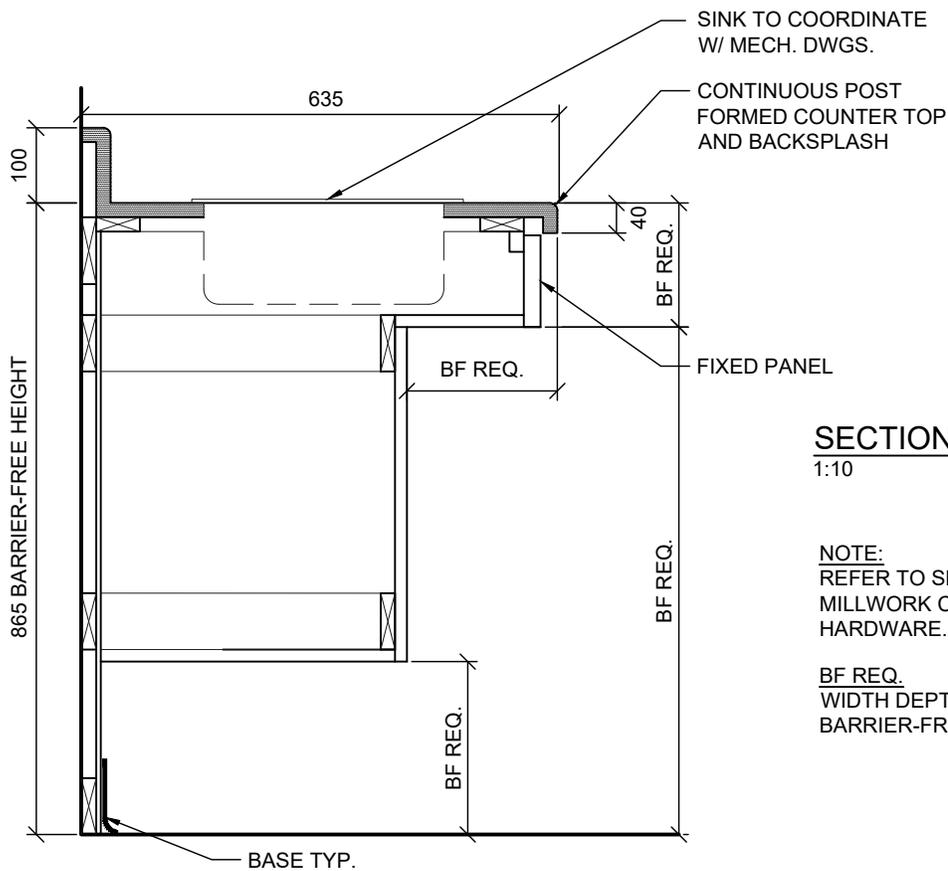

SECTION
1:10

NOTE:
REFER TO SPECIFICATION FOR
MILLWORK CONSTRUCTION AND
HARDWARE.

BF REQ.
WIDTH DEPTH AND HEIGHT TO SUIT
BARRIER-FREE REQUIREMENT.


**TYPE B33 - BARRIER FREE COUNTER
WITH SINGLE SINK**

PROJ: 22124
SCALE: VARIES
DRAWN: KB
DATE: 260105




ISSUE/REV.
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AD
626A

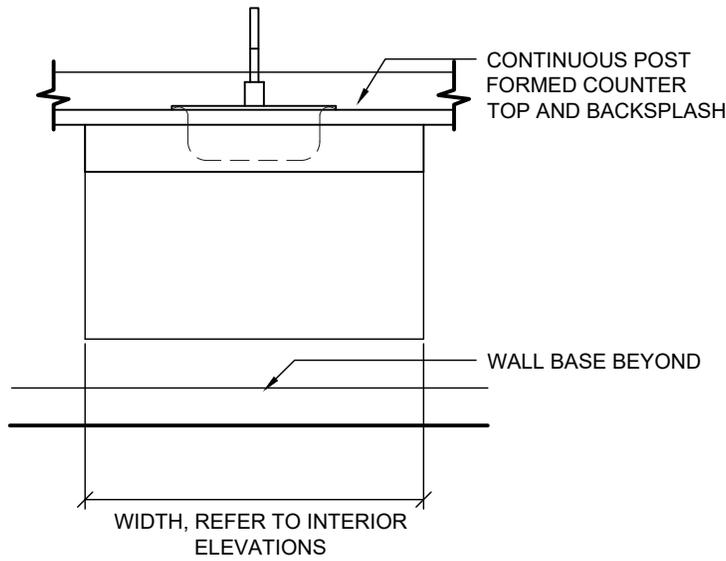

ELEVATION
1:20

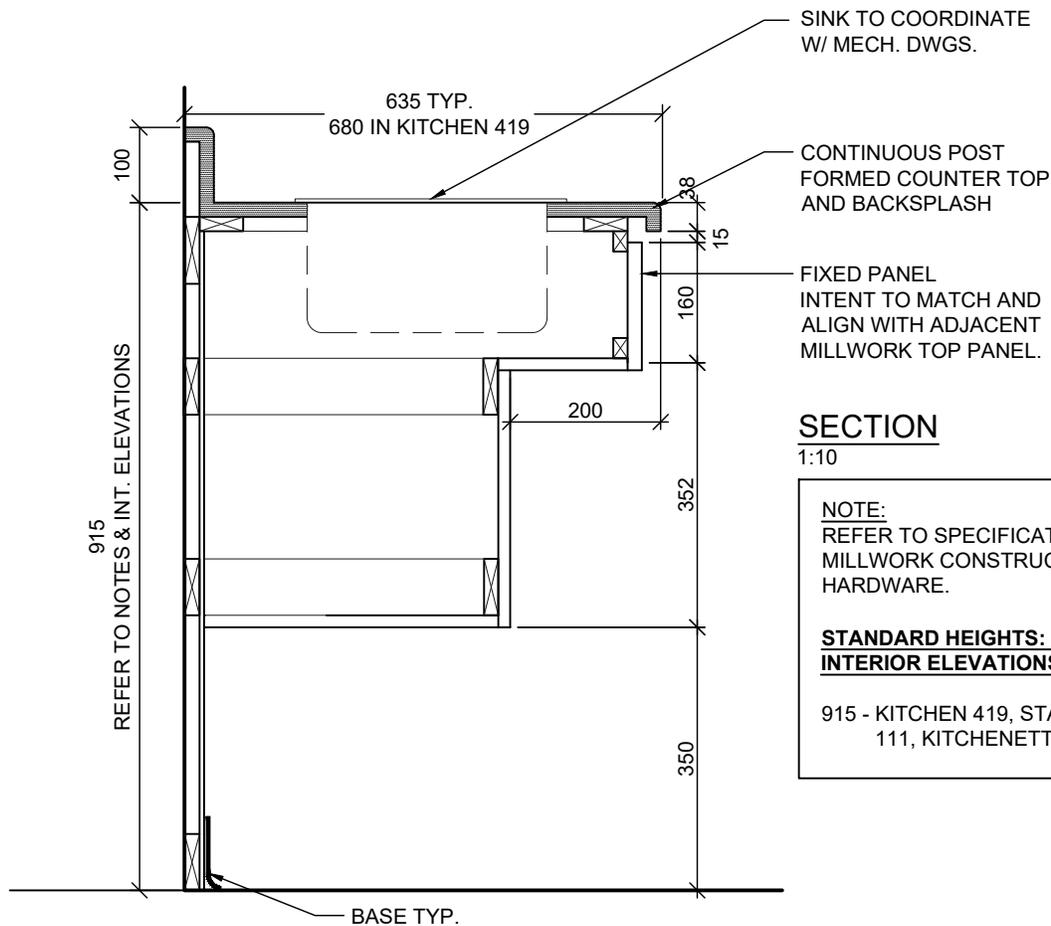

SECTION
1:10

NOTE:
REFER TO SPECIFICATION FOR MILLWORK CONSTRUCTION AND HARDWARE.

STANDARD HEIGHTS: (COORD. WITH INTERIOR ELEVATIONS, TYP.)


915 - KITCHEN 419, STAFF LOUNGE
111, KITCHENETTE 159,

TYPE B33A - BARRIER FREE COUNTER WITH SINGLE SINK

| | |
|--------|--------|
| PROJ: | 22124 |
| SCALE: | VARIES |
| DRAWN: | KB |
| DATE: | 260105 |



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| ISSUE/REV. | 00 |
| AD | 626B |

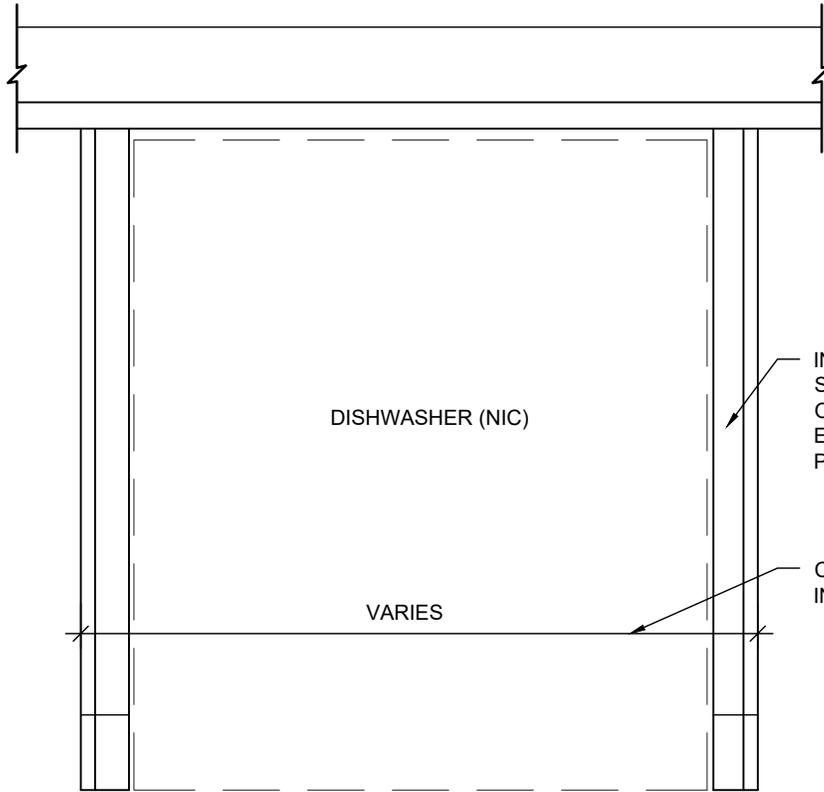


DISHWASHER (NIC)

VARIES

INCLUDE FOR FILLER STRIPS TO BE INSTALLED ON SITE. COORDINATE EXACT DIMENSIONS WITH PURCHASED APPLIANCES

ELEVATION

COORDINATE WITH INTERIOR ELEVATIONS

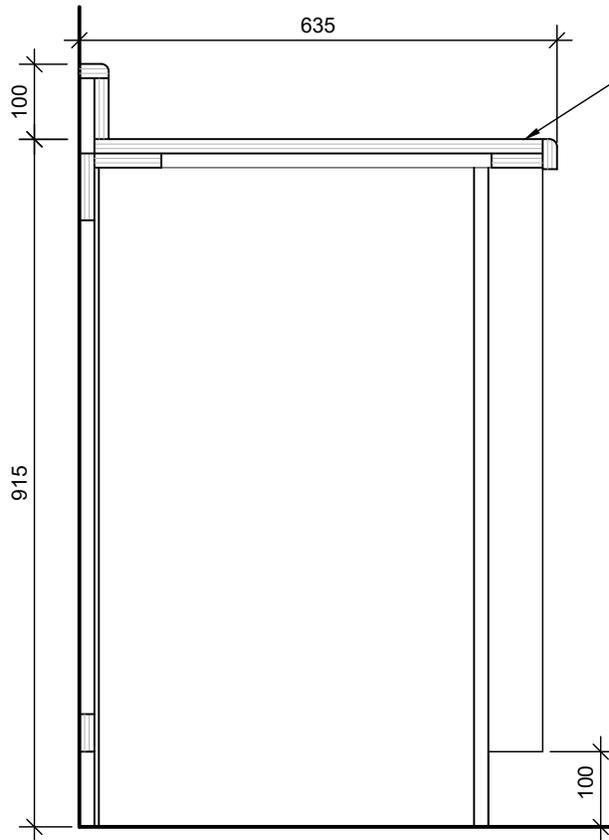

635

100

915

100

CONTINUOUS POST FORMED COUNTER TOP AND BACKSPLASH

SECTION

TYPE B34 - LOWER MILLWORK AT
DISHWASHER

PROJ: 22124

SCALE: 1:10

DRAWN: KB


DATE: 260105

HOSSACK
ARCHITECTURE




ISSUE/REV.
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AD
627

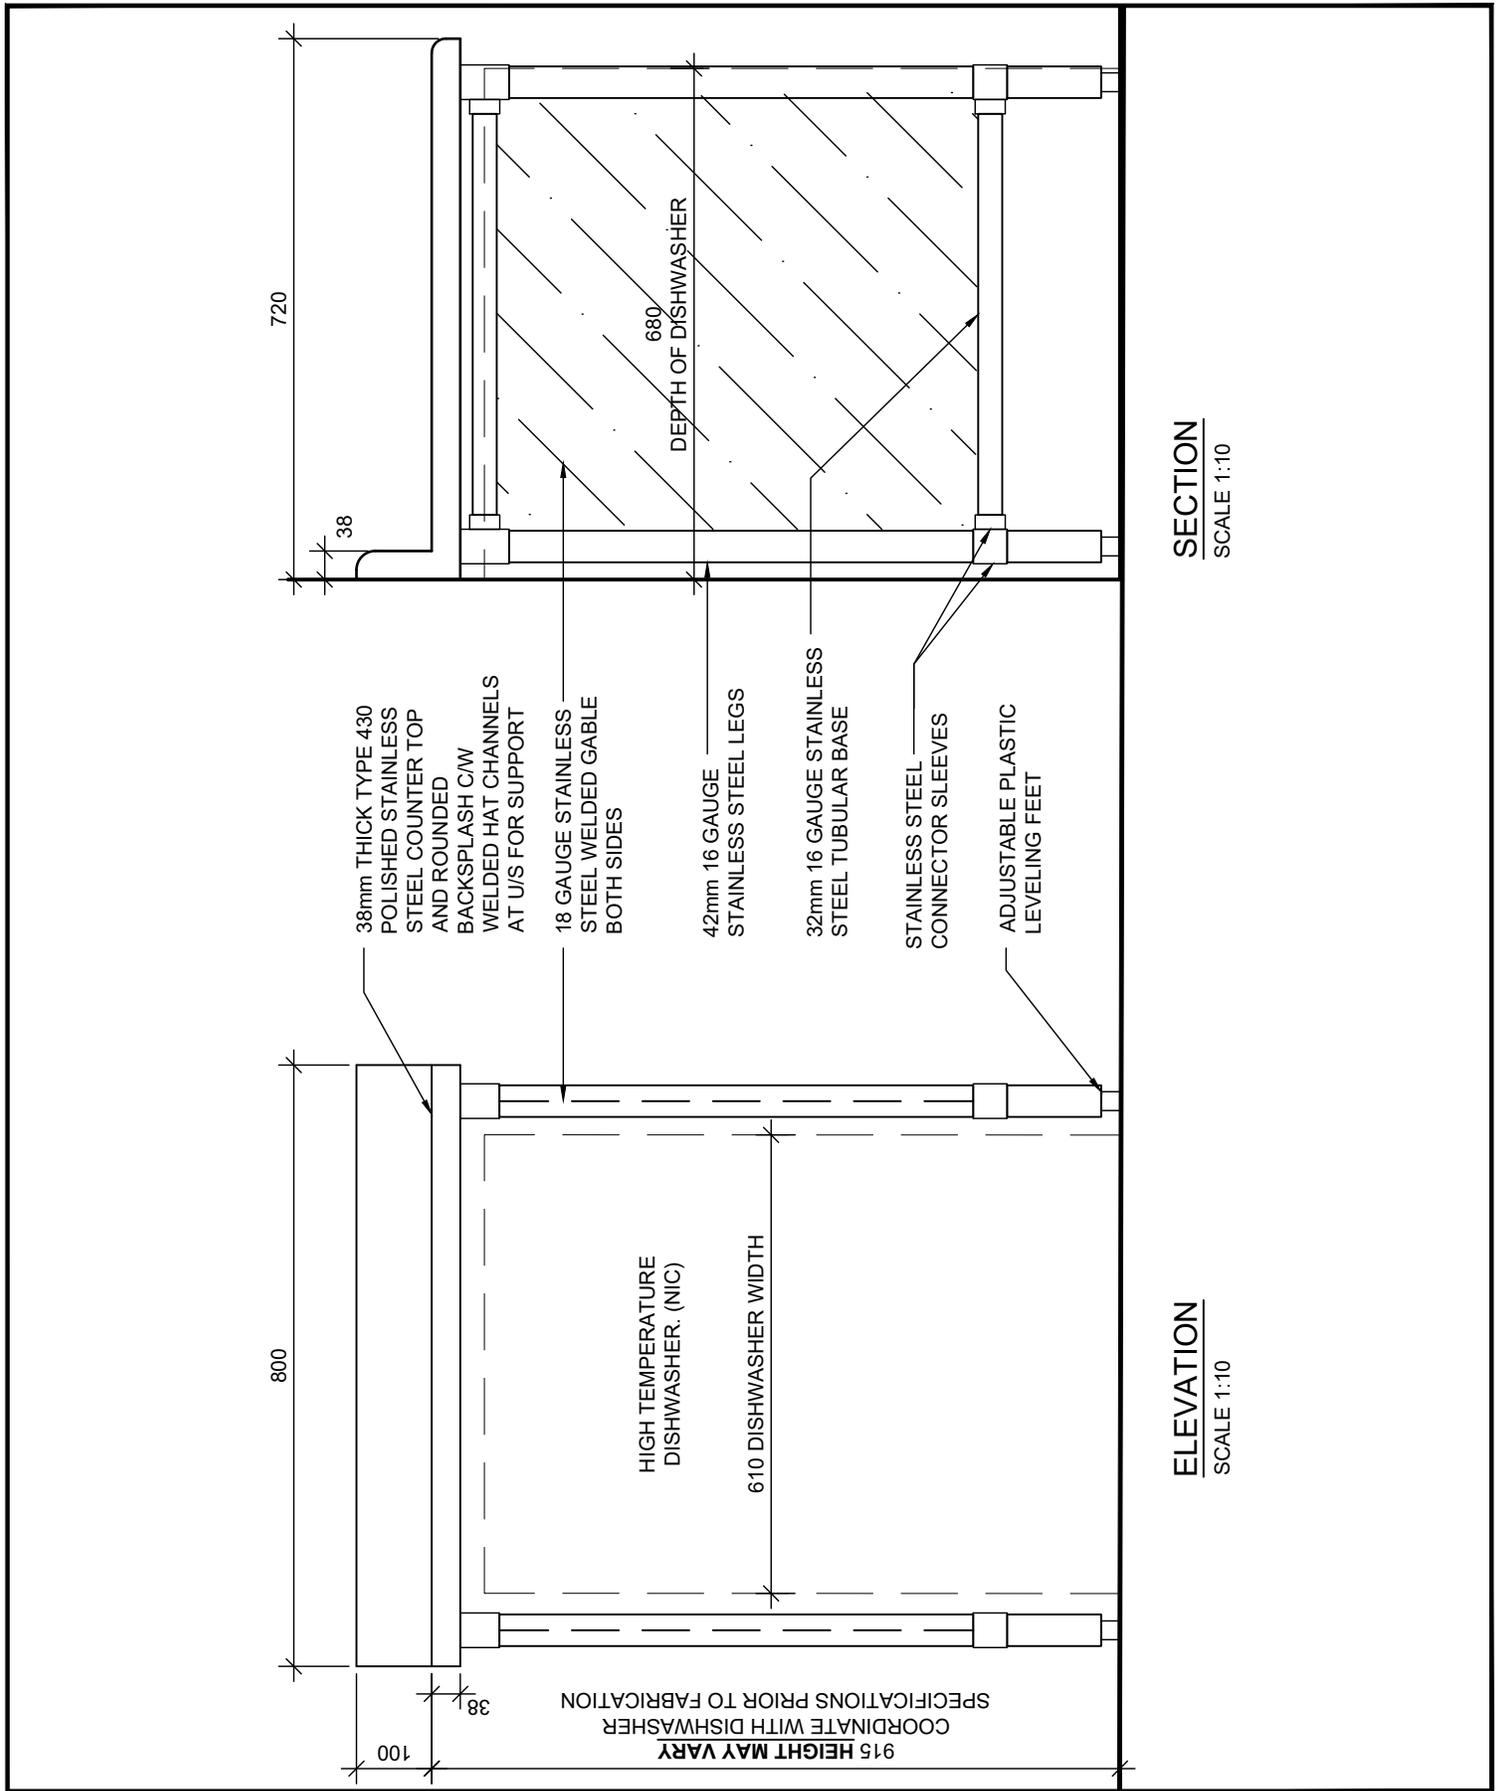



**B34A - COMMERCIAL DISHWASHER -
STAINLESS STEEL COUNTER**
CHILD CARE KITCHEN

PROJ: 22124
SCALE: 1:10
DRAWN: KB
DATE: 260105

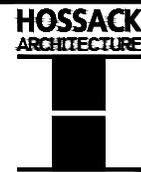

ISSUE/REV.
00

AD
627A

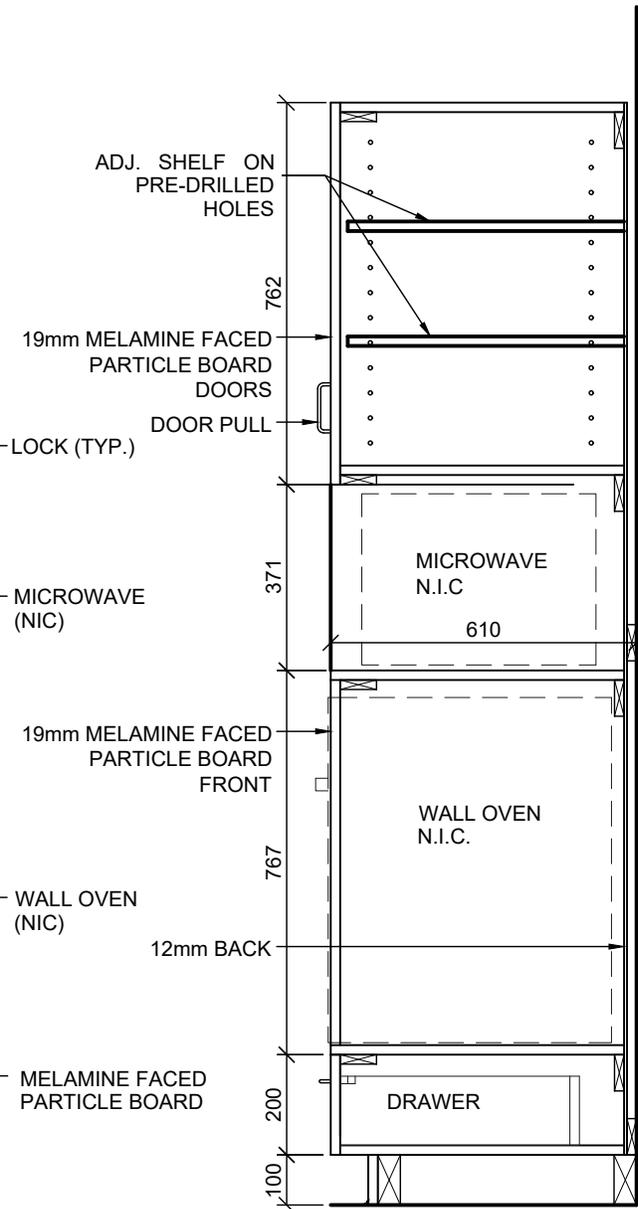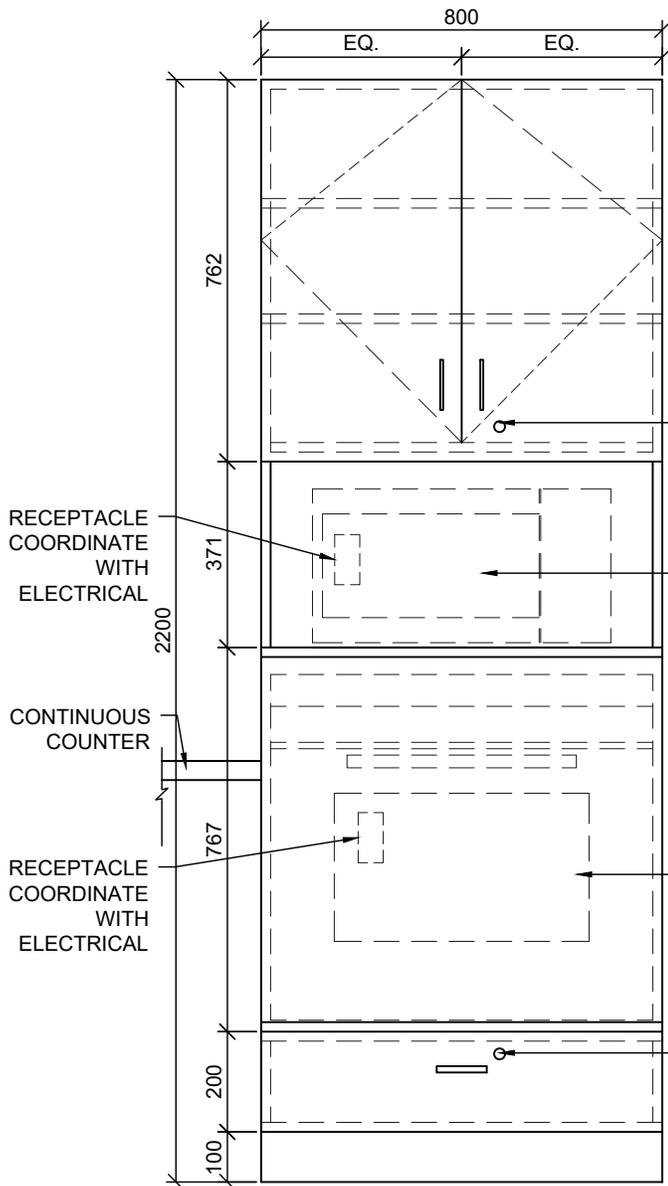

ELEVATION

SCALE 1 : 15

SECTION

SCALE 1: 15

NOTE:

ALL MILLWORK DOORS AND DRAWERS TO BE EQUIPPED WITH LOCKS

REFER TO SPECIFICATION FOR MILLWORK CONSTRUCTION AND HARDWARE.

TYPE B35 BARRIER FREE WALL OVEN CABINET

PROJ: 22124

SCALE: 1:15

DRAWN: KB


DATE: 260105

**HOSSACK
ARCHITECTURE**



ISSUE/REV.
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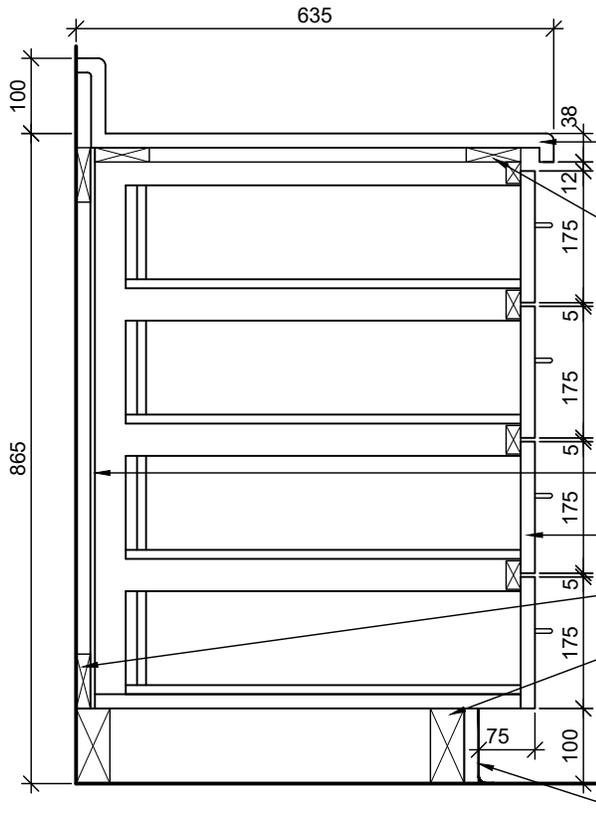
AD
628

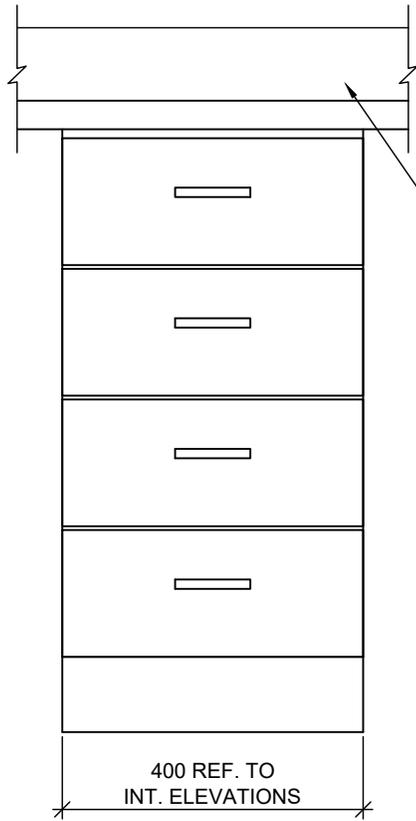

CONTINUOUS COUNTER
TOP AND BACKSPLASH.
POST FORMED

ELEVATION

SCALE 1 : 10



CONTINUOUS COUNTERTOP
AND BACKSPLASH

STRETCHER RAIL AT FRONT
AND BACK

BACKING

DRAWER (TYP.)

NAILER STRIPS AT TOP
AND BOTTOM

BASE FRAMING

BASE

NOTE:

ALL MILLWORK DOORS AND DRAWERS
TO BE EQUIPPED WITH LOCKS
UNLESS OTHERWISE NOTED.

REFER TO SPECIFICATION FOR
MILLWORK CONSTRUCTION AND
HARDWARE.

SECTION

SCALE 1 : 10

TYPE B36 - LOWER CABINET DRAWERS

PROJ: 22124

SCALE: 1:10

DRAWN: KB


DATE: 260105

HOSSACK
ARCHITECTURE




ISSUE/REV.
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AD
629

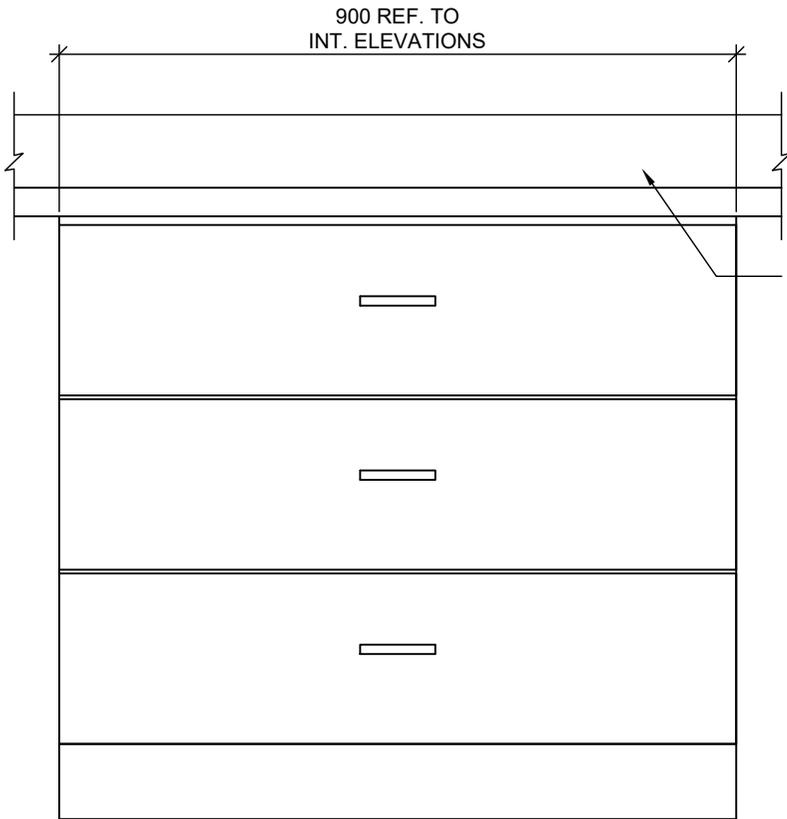

CONTINUOUS COUNTER
TOP AND BACKSPLASH.
POST FORMED

ELEVATION
SCALE 1 : 10

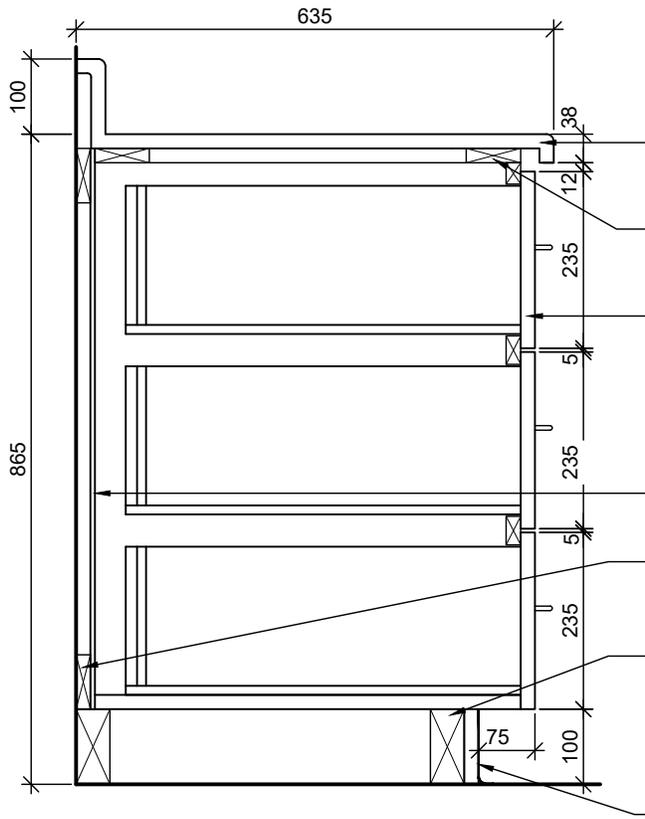

CONTINUOUS COUNTERTOP
AND BACKSPLASH

STRETCHER RAIL AT FRONT
AND BACK

DRAWER (TYP.)

BACKING

NAILER STRIPS AT TOP
AND BOTTOM

BASE FRAMING

BASE

NOTE:
ALL MILLWORK DOORS AND DRAWERS
TO BE EQUIPPED WITH LOCKS
UNLESS OTHERWISE NOTED.
REFER TO SPECIFICATION FOR
MILLWORK CONSTRUCTION AND
HARDWARE.

SECTION
SCALE 1 : 10

TYPE B37 - LOWER CABINET DRAWERS

PROJ: 22124

SCALE: 1:10

DRAWN: KB




DATE: 260105

HOSSACK
ARCHITECTURE



ISSUE/REV.
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AD
630

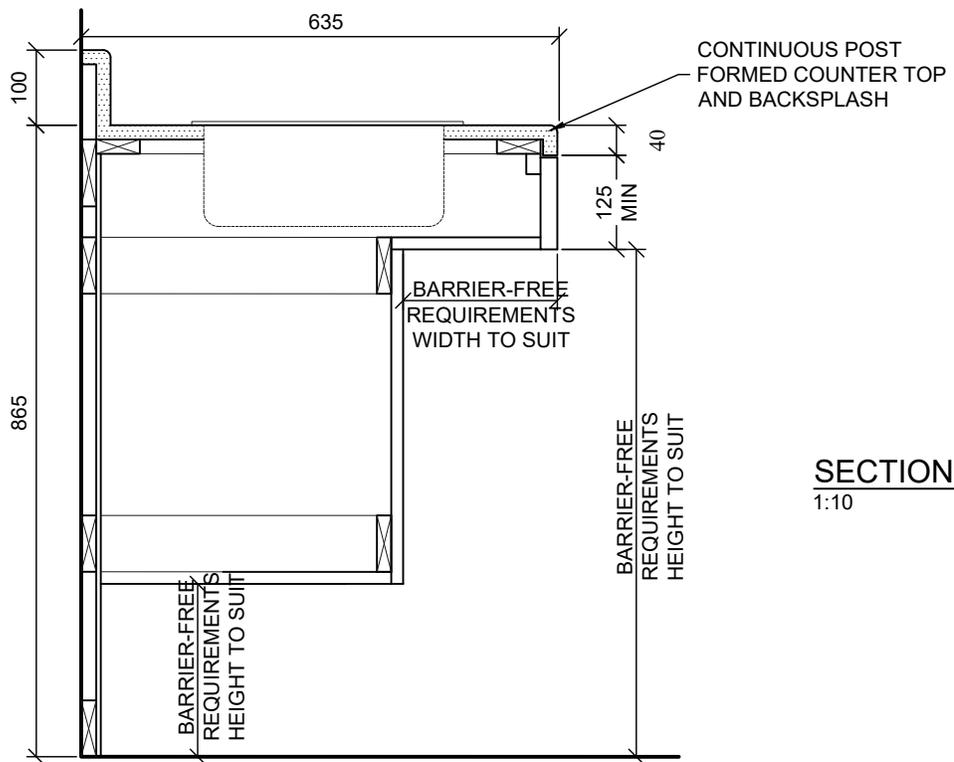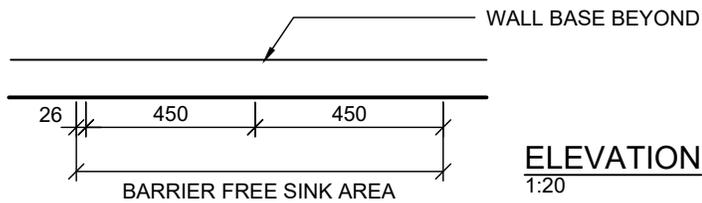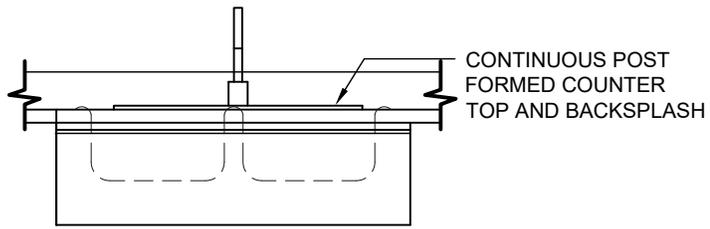


**TYPE B38 - BARRIER FREE COUNTER
WITH DOUBLE SINK (SPEC. ED.)**

PROJ: 22124
SCALE: VARIES
DRAWN: KB
DATE: 260105




ISSUE/REV.
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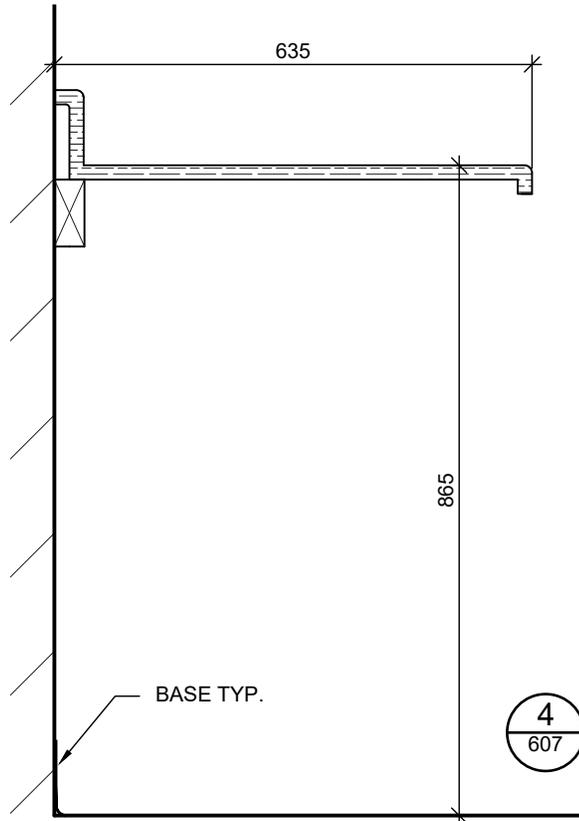
AD
631

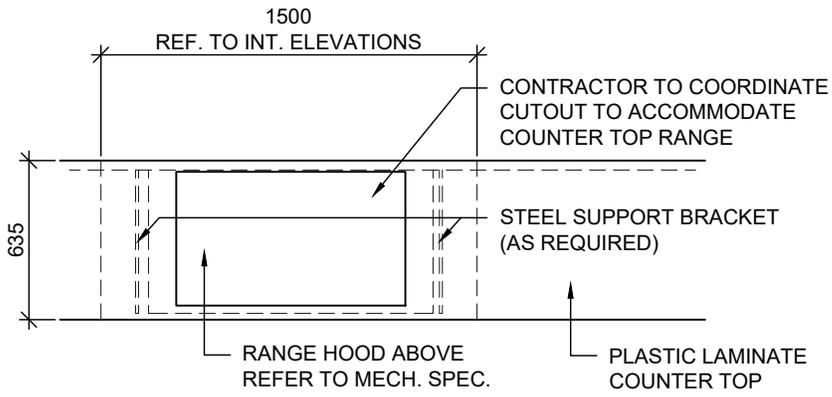


1 PLAN
607 1:30

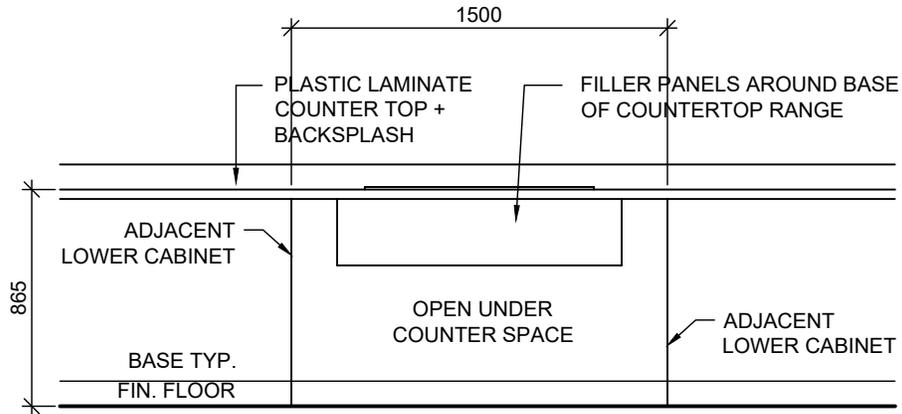

2 ELEVATION
607 1:30



4 SECTION
607 1:10

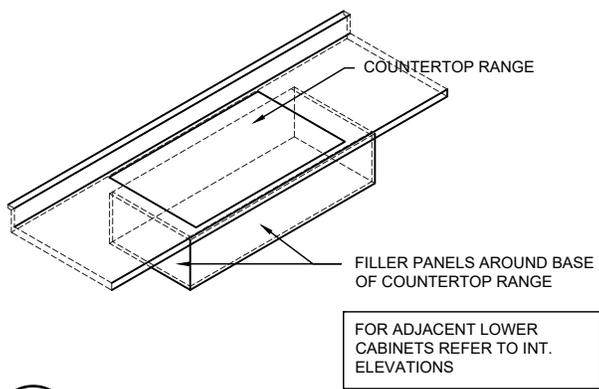

3 ISOMETRIC
607 NTS


KITCHEN COUNTER TYPE B39
COUNTERTOP RANGE

PROJ: 22124
SCALE: NOTED
DRAWN: KB
DATE: 260105




ISSUE/REV.
00

AD
632

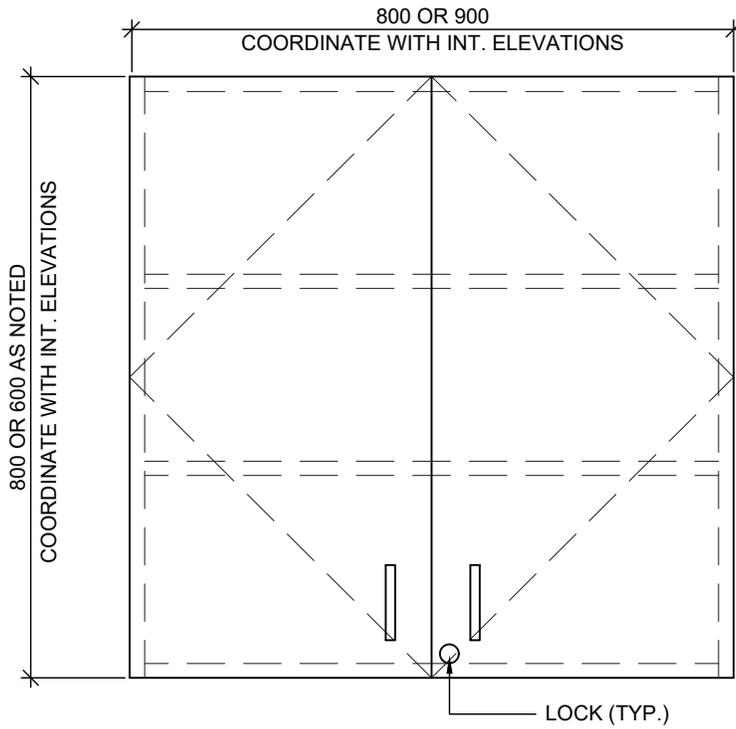

NOTE:
ALL MILLWORK DOORS AND DRAWERS
TO BE EQUIPT WITH LOCKS.
UNLESS OTHERWISE NOTED.

ELEVATION

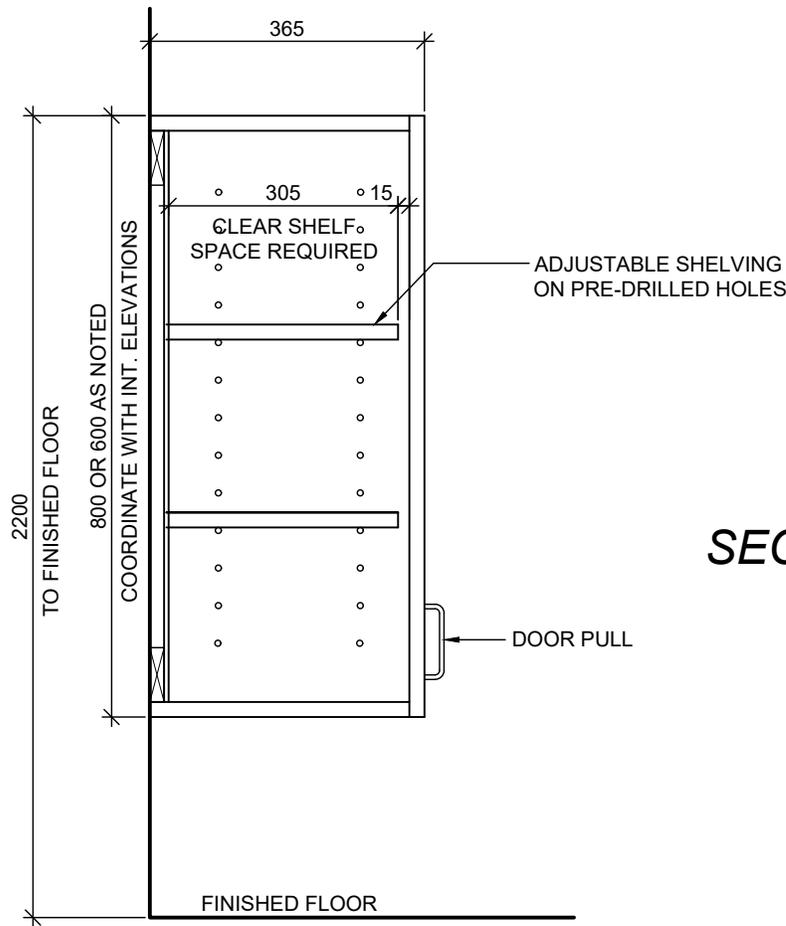

SECTION


UPPER CABINET TYPE U1

| | |
|--------|--------|
| PROJ: | 22124 |
| SCALE: | 1:10 |
| DRAWN: | GB |
| DATE: | 260105 |




ISSUE/REV.

AD
635

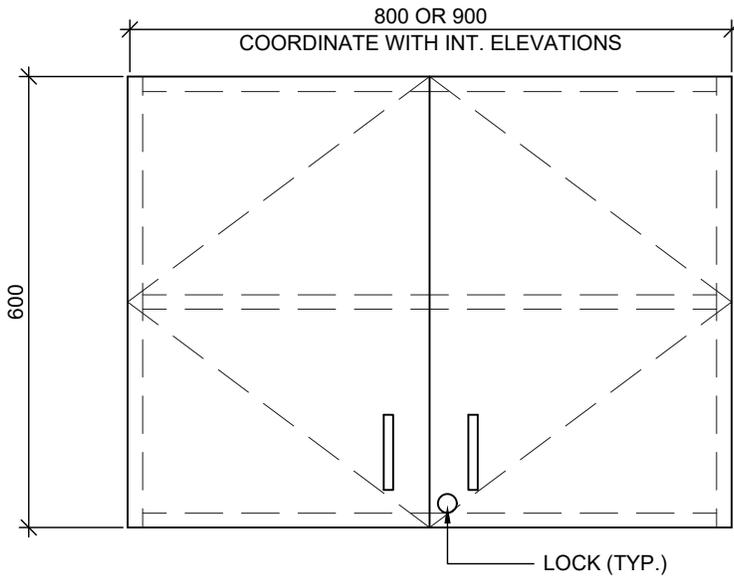

NOTE:
ALL MILLWORK DOORS AND DRAWERS
TO BE EQUIPT WITH LOCKS.
UNLESS OTHERWISE NOTED.

ELEVATION

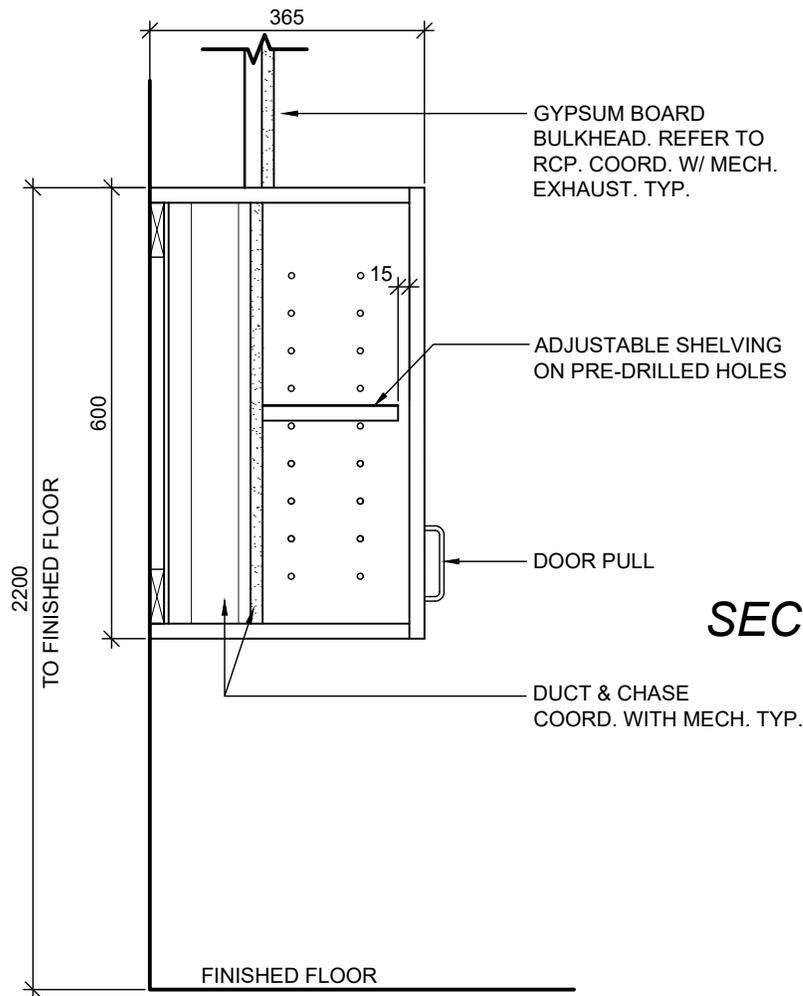

SECTION


UPPER CABINET TYPE U1A
WITH STOVE EXHAUST CHASE

PROJ: 22124
SCALE: 1:10
DRAWN: KB
DATE: 260105




ISSUE/REV.

AD
635A

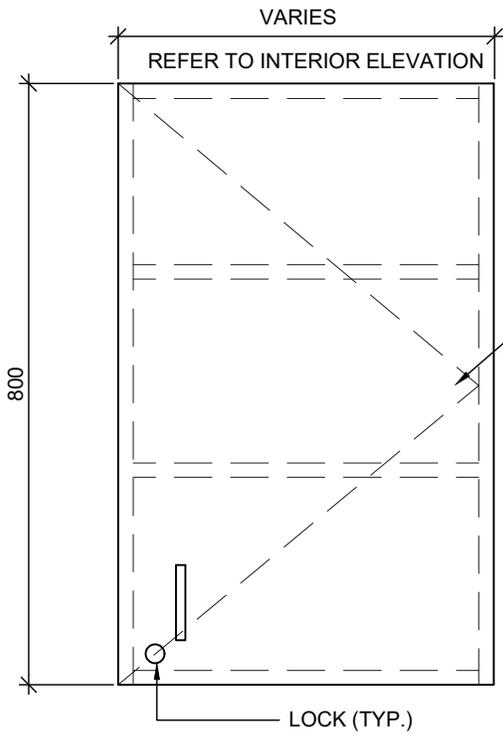

ELEVATION

NOTE:
ALL MILLWORK DOORS AND DRAWERS
TO BE EQUIPT WITH LOCKS.
UNLESS OTHERWISE NOTED.

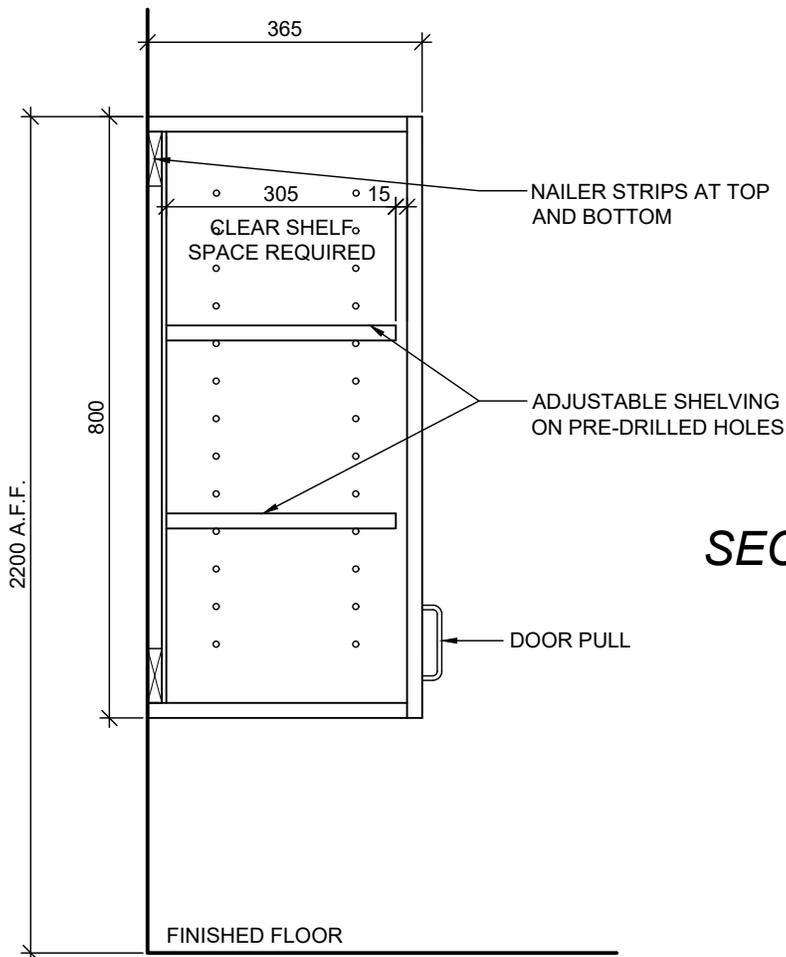

SECTION


UPPER CABINET TYPE U3

PROJ: 22124
SCALE: 1:10
DRAWN: CC
DATE: 260105




ISSUE/REV.

AD
636

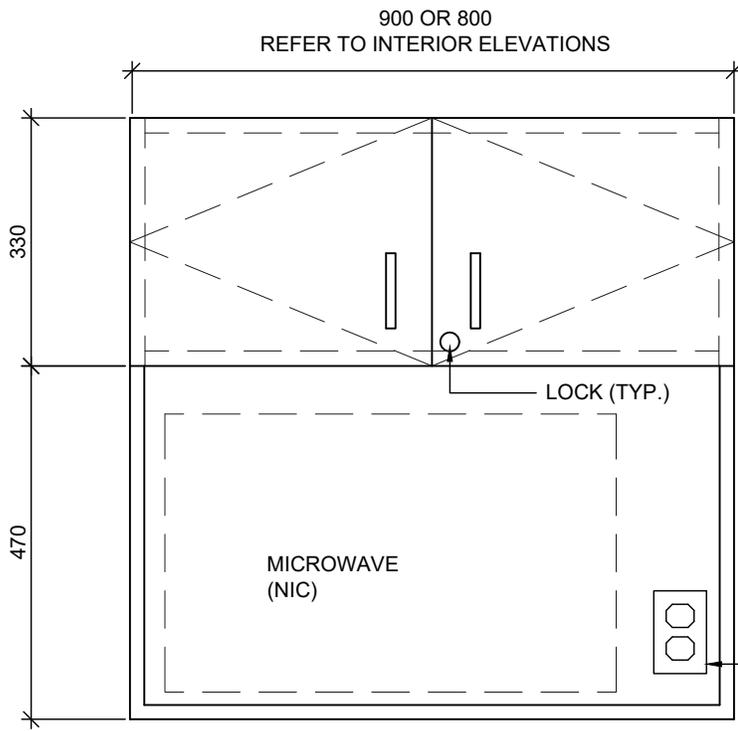

NOTE:
ALL MILLWORK DOORS AND DRAWERS
TO BE EQUIPT WITH LOCKS.
UNLESS OTHERWISE NOTED.

ELEVATION

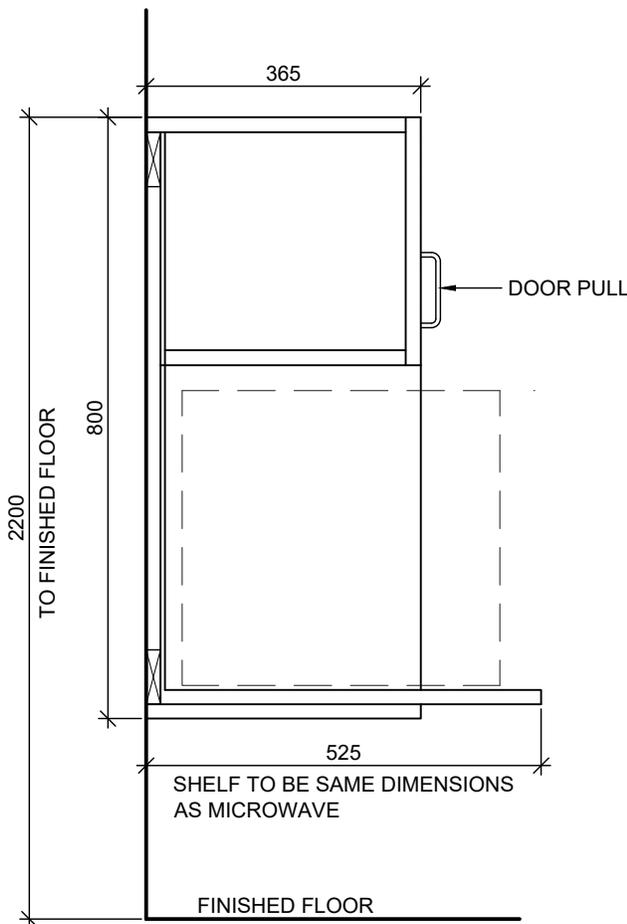

SECTION


UPPER CABINET TYPE U4

| | |
|--------|--------|
| PROJ: | 22124 |
| SCALE: | 1:10 |
| DRAWN: | CC |
| DATE: | 260105 |



ISSUE/REV.


AD
637

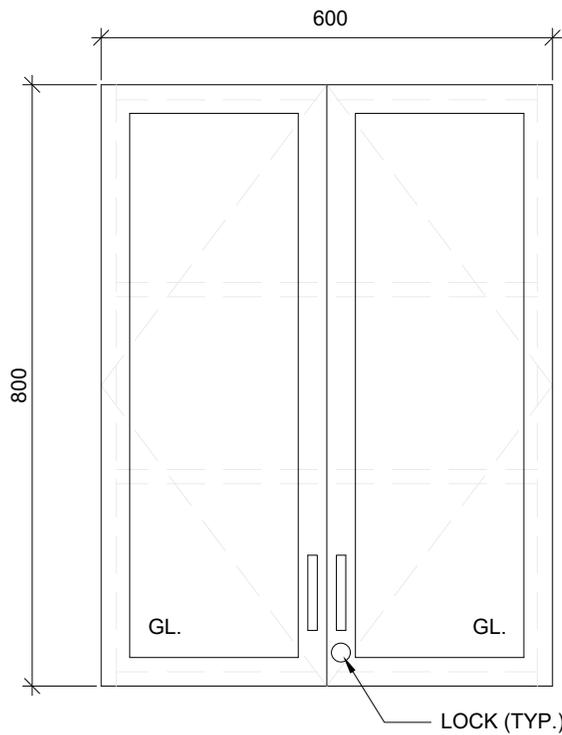

NOTE:
ALL MILLWORK DOORS AND DRAWERS
TO BE EQUIPPED WITH LOCKS
UNLESS OTHERWISE NOTED.

REFER TO INTERIOR ELEVATIONS
FOR DOOR SWING DIRECTION

ELEVATION

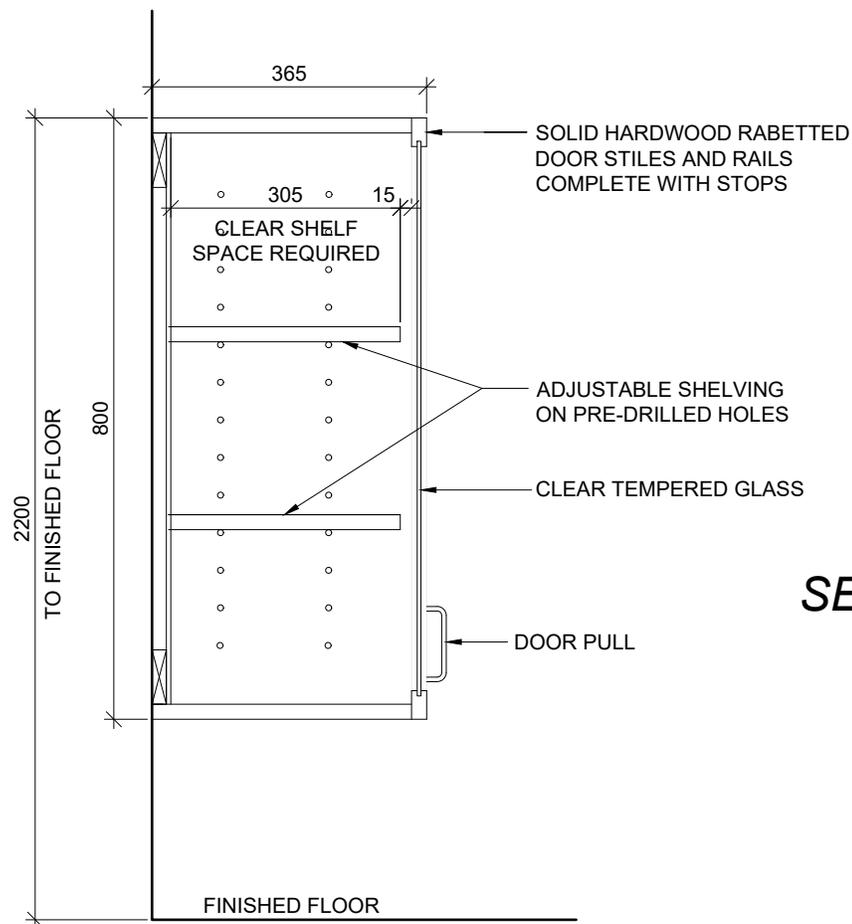

SECTION


UPPER CABINET TYPE U5 WITH GLASS

| | |
|--------|--------|
| PROJ: | 22124 |
| SCALE: | 1:10 |
| DRAWN: | KB |
| DATE: | 260105 |



ISSUE/REV.


AD
638

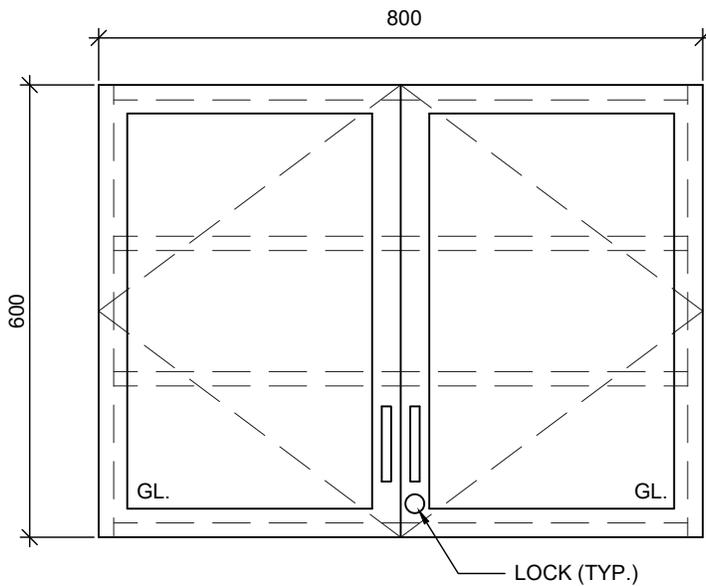

NOTE:
ALL MILLWORK DOORS AND DRAWERS
TO BE EQUIPPED WITH LOCKS
UNLESS OTHERWISE NOTED.

REFER TO INTERIOR ELEVATIONS
FOR DOOR SWING DIRECTION

ELEVATION

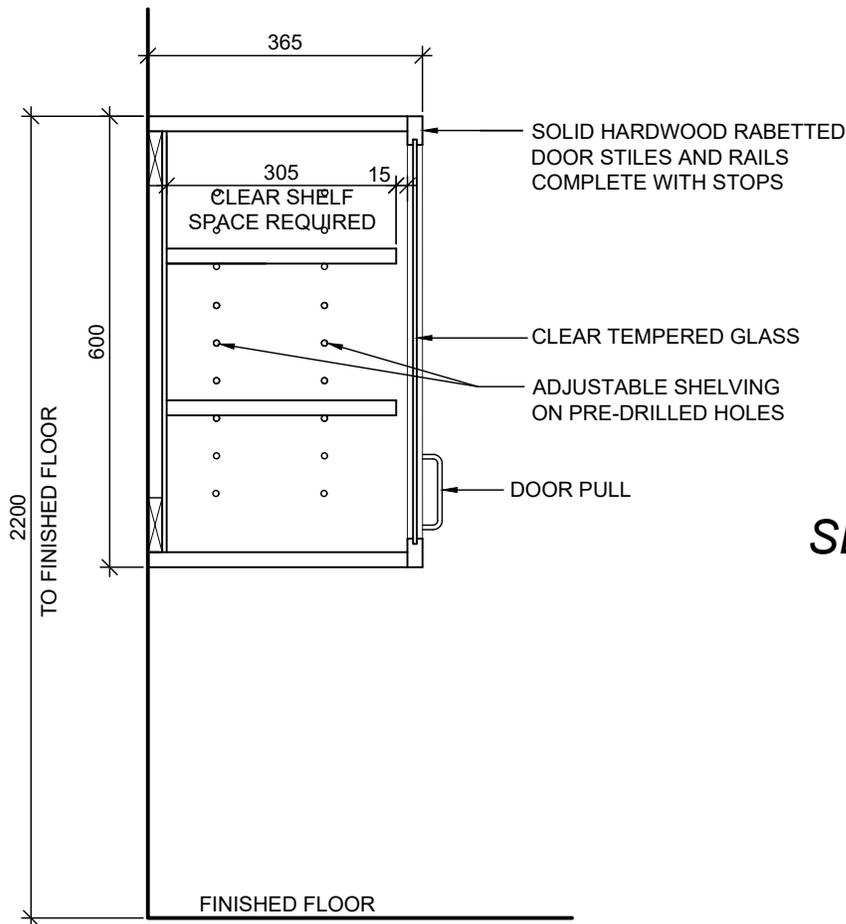

SECTION


UPPER CABINET TYPE U6

| | |
|--------|--------|
| PROJ: | 22124 |
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| DRAWN: | KB |
| DATE: | 260105 |




ISSUE/REV.

AD
639

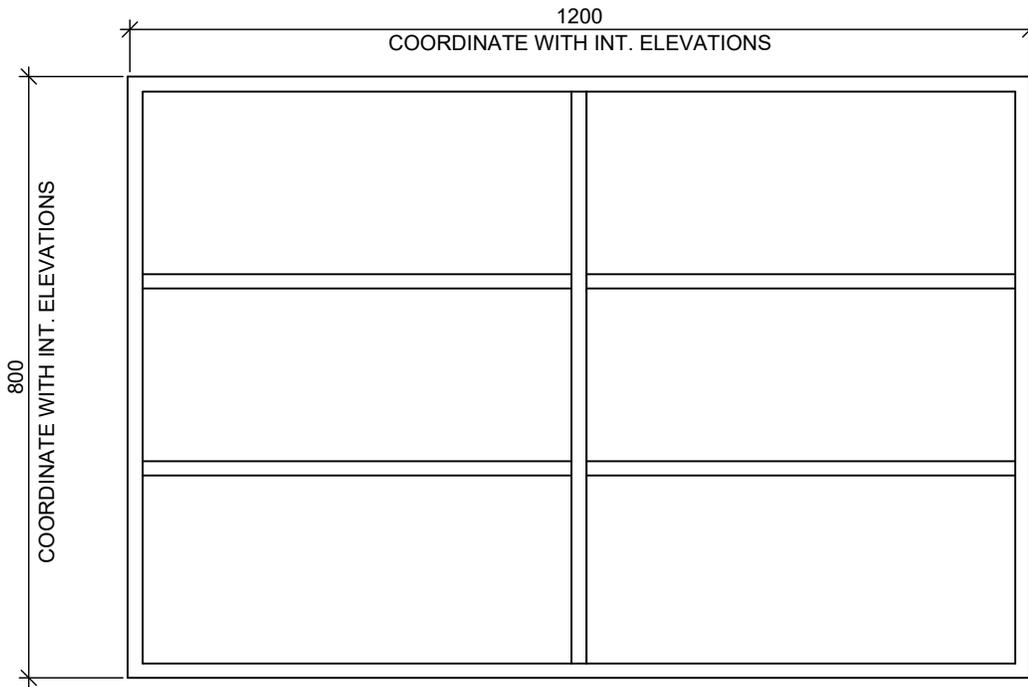

ELEVATION

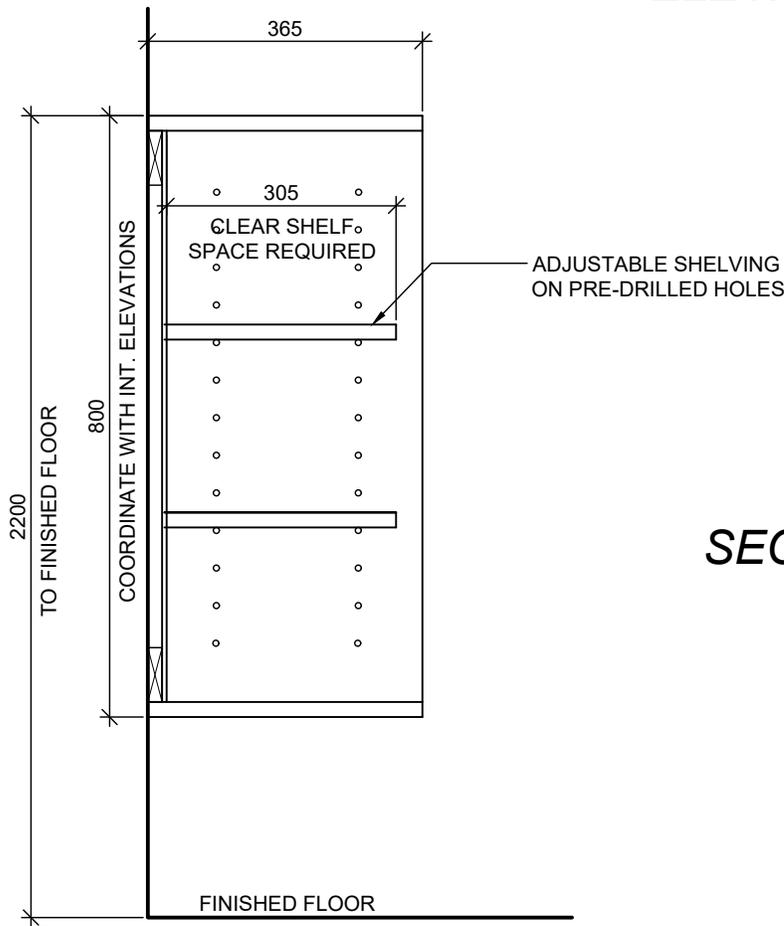

SECTION

UPPER CABINET TYPE U7


| | |
|--------|--------|
| PROJ: | 22124 |
| SCALE: | 1:10 |
| DRAWN: | KB |
| DATE: | 260105 |



ISSUE/REV.

AD
640

NOTE:
 ALL MILLWORK DOORS AND DRAWERS
 TO BE EQUIPT WITH LOCKS.
 UNLESS OTHERWISE NOTED.

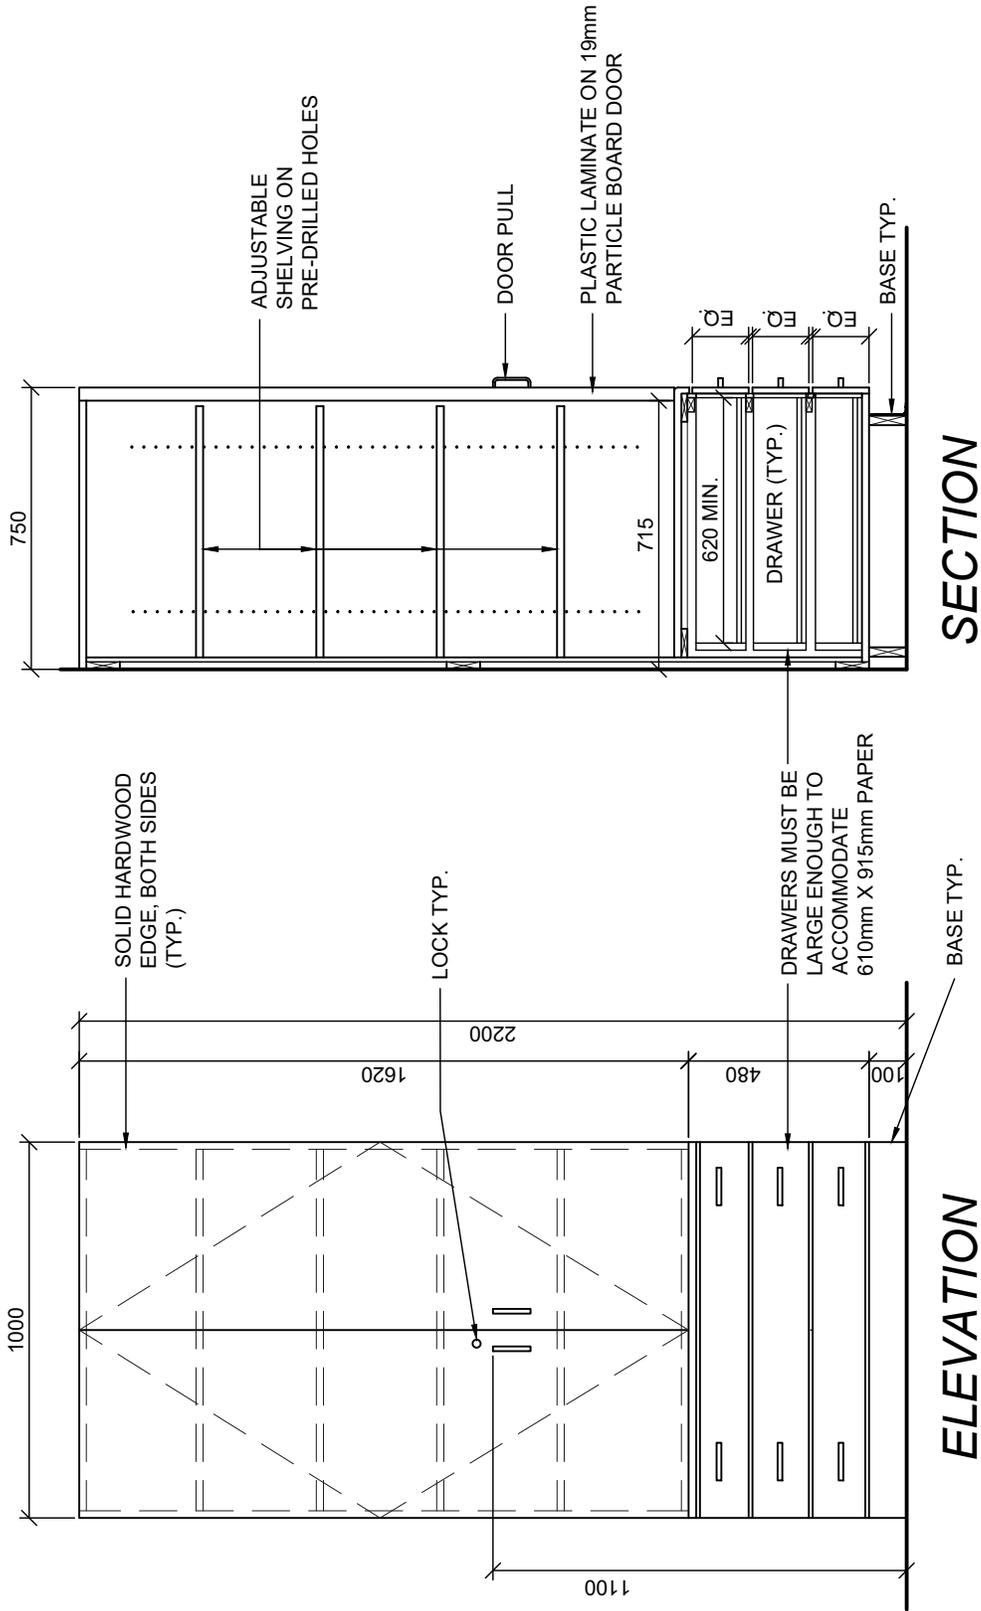

TYPE C2 - PAPER STORAGE UNIT

| | |
|--------|--------|
| PROJ: | 22124 |
| SCALE: | 1:20 |
| DRAWN: | CC |
| DATE: | 260105 |




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| ISSUE/REV. |
| AD 641 |


NOTE:
 ALL MILLWORK DOORS AND DRAWERS
 TO BE EQUIPT WITH LOCKS.
 UNLESS OTHERWISE NOTED.

TYPICAL SIZE - 900 WIDE x 650 DEEP
SIM1 (KITCHEN 419) - 800 WIDE x 650 DEEP
SIM2 (COPY 110) - 900 WIDE x 470 DEEP.

REFER TO PLANS & ELEVATIONS.

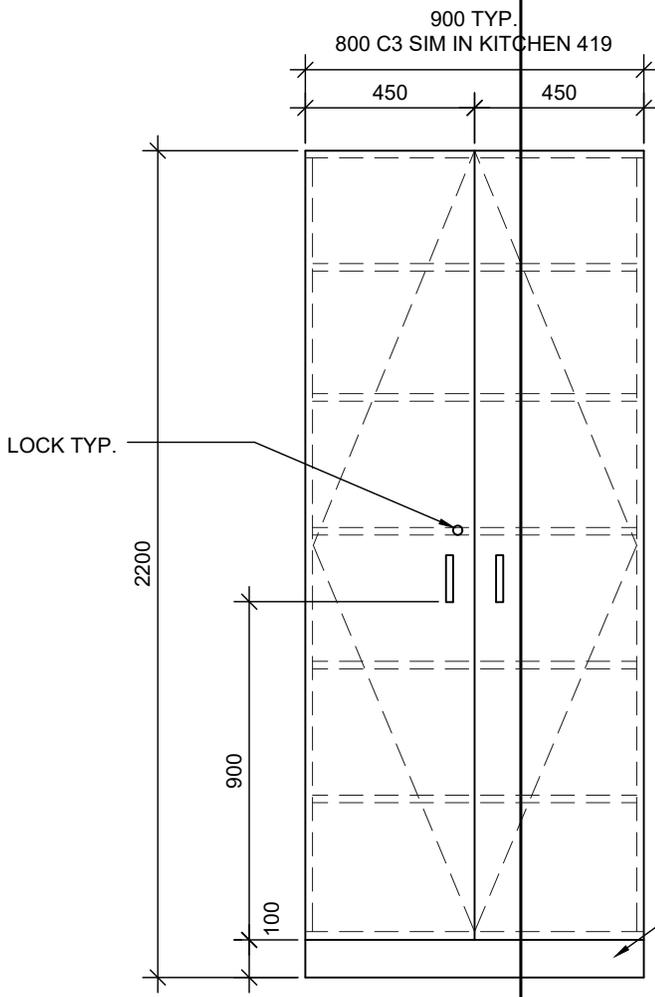

ELEVATION

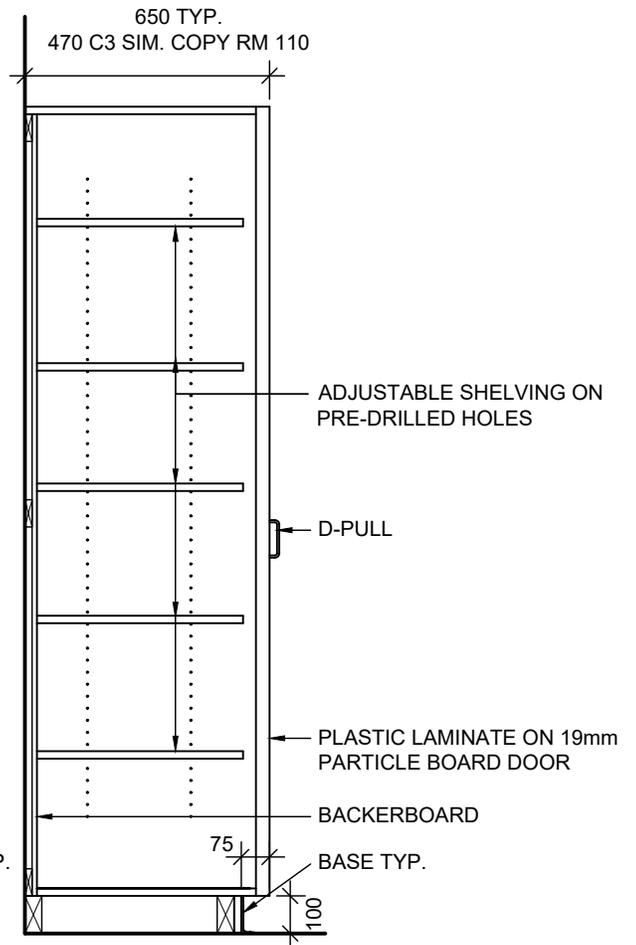

SECTION 'A'

TYPE C3 - STORAGE CABINET


PROJ: 22124
 SCALE: 1:20
 DRAWN: KB/CC
 DATE: 260105




ISSUE/REV.
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AD
 642

DEPTH VARIATION:
 450mm DEEP - STANDARD.
 340mm DEEP - GYM STORAGE 163

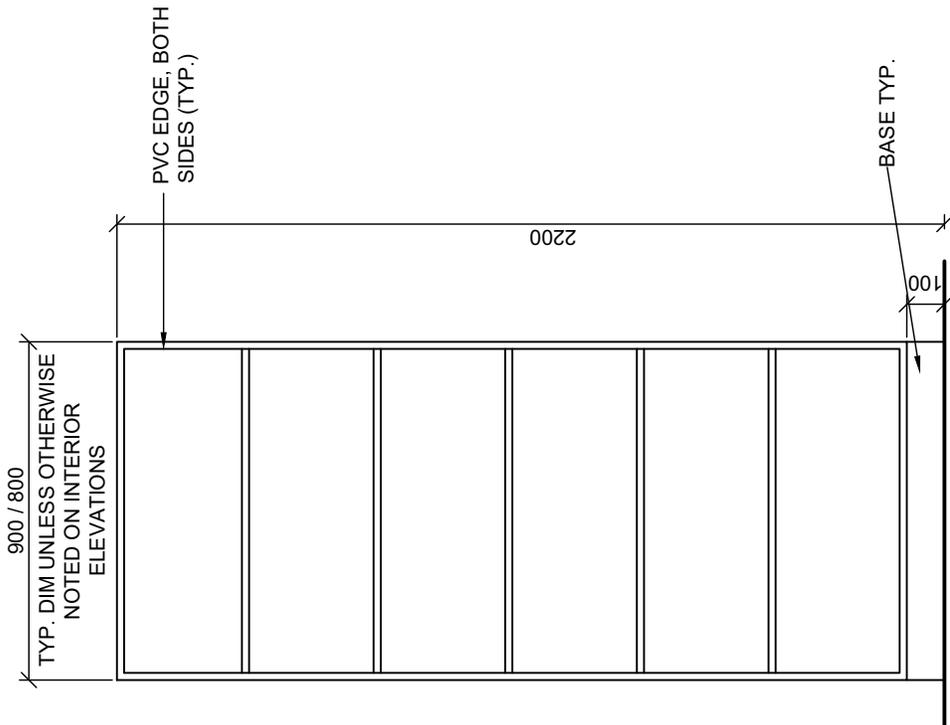

ELEVATION

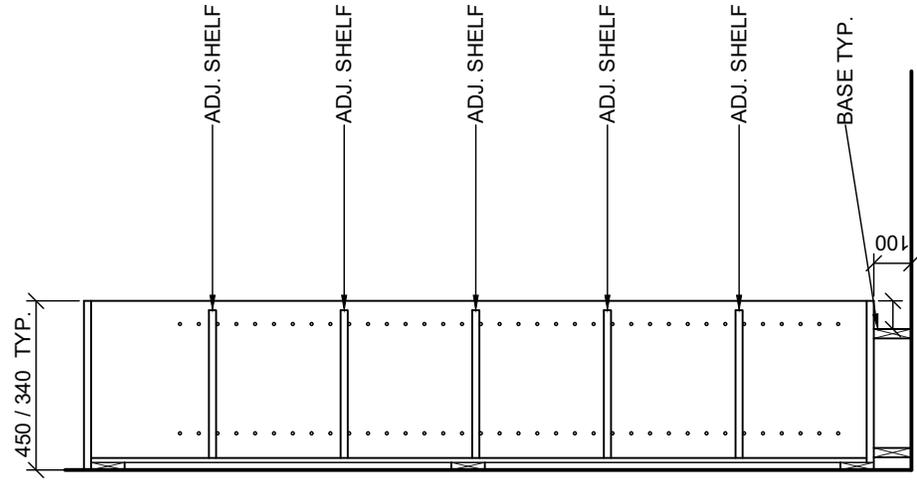

SECTION



TALL OPEN SHELVING TYPE C5

| | |
|--------|--------|
| PROJ: | 22124 |
| SCALE: | 1:20 |
| DRAWN: | CC |
| DATE: | 260105 |



ISSUE/REV.

AD
 644

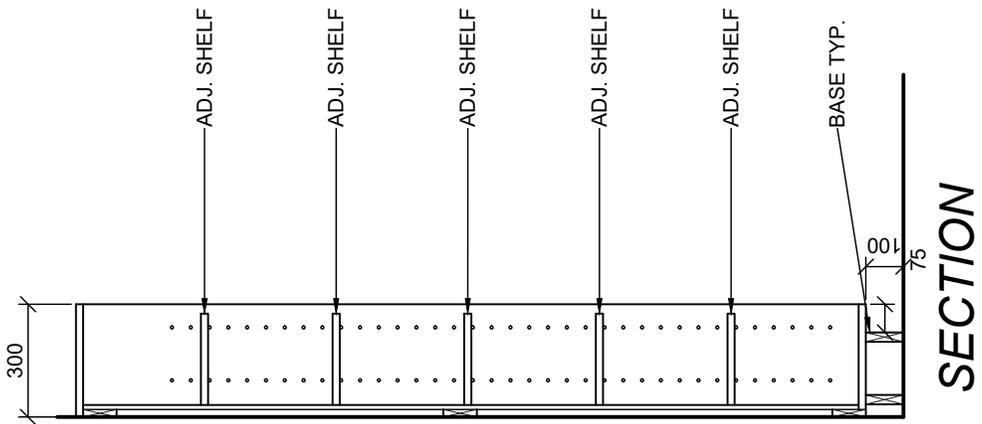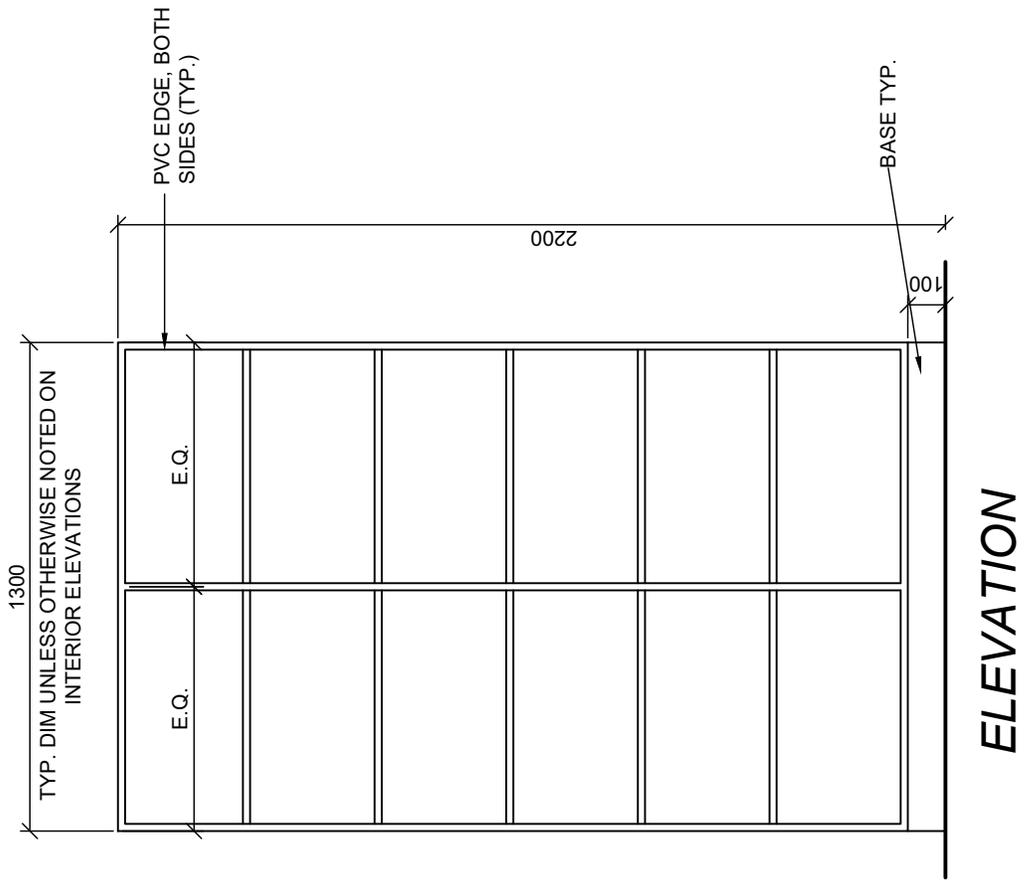


TALL OPEN SHELVING TYPE C5A

| | |
|--------|--------|
| PROJ: | 22124 |
| SCALE: | 1:20 |
| DRAWN: | CC |
| DATE: | 260105 |



ISSUE/REV.


AD
644A

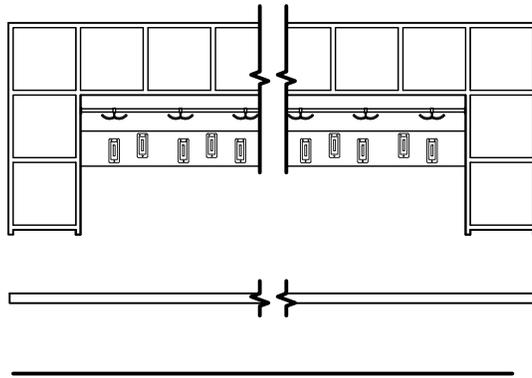

TYP. CHILDCARE COAT AREA CUBBIES ELEVATION


SCALE nts

NOTE:
REFER TO FLOOR PLANS AND ELEVATIONS FOR HEIGHT &
LENGTH REQUIRED CONFIGURATION VARIES PER ROOM

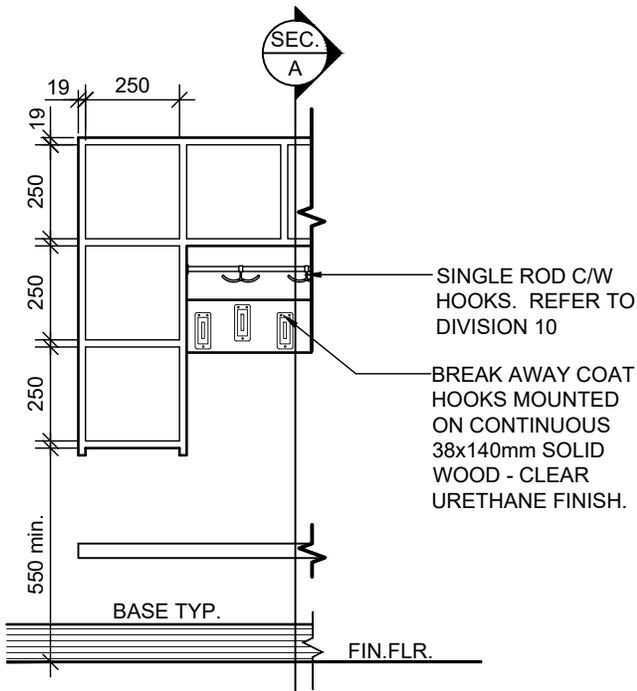

PARTIAL FRONT ELEVATION

SCALE 1 : 20

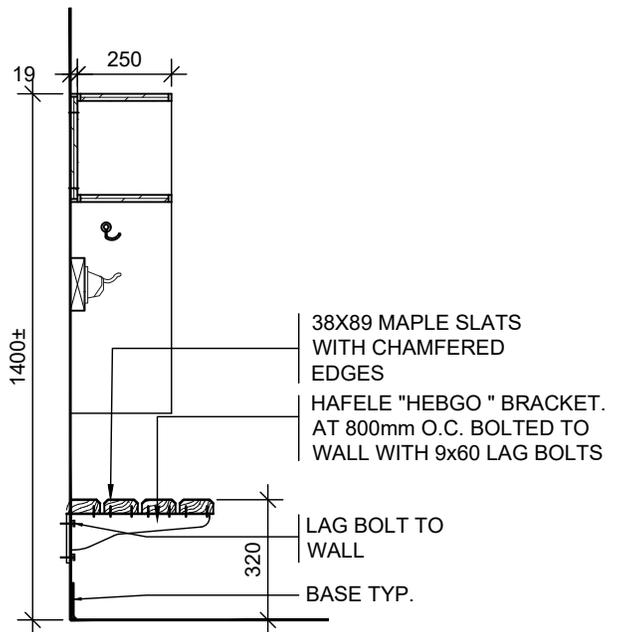

SECTION A

SCALE 1 : 20

NOTE:
REFER TO SPECIFICATION FOR MILLWORK CONSTRUCTION AND HARDWARE.


**CHILDCARE COAT AREA CUBBIES
TYPE C6**

PROJ: 22124
SCALE: NOTED
DRAWN:KB
DATE: 260105




ISSUE/REV.
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AD
645

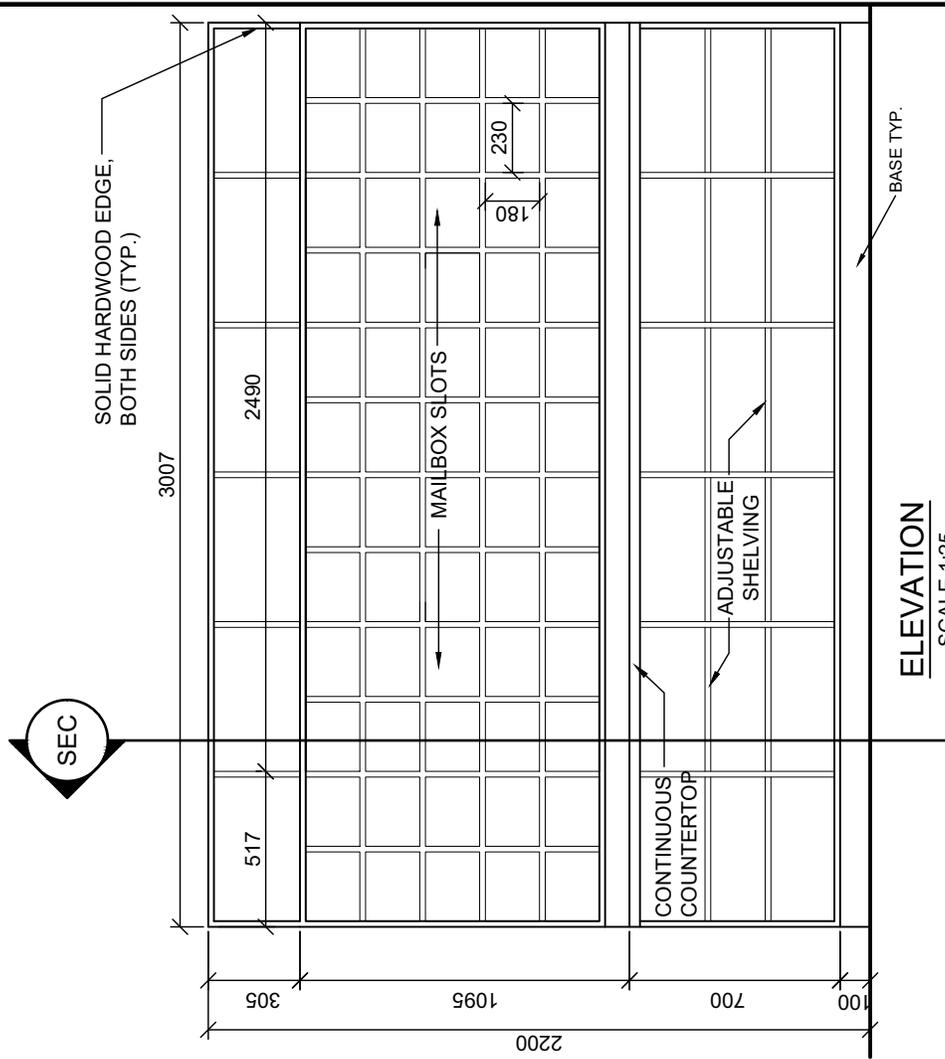

ELEVATION
SCALE 1:25

NOTE:
MAILBOX SLOTS: CLEAR INSIDE DIMENSION TO SUIT
PAPER SIZE 215 X 355 (STD. LEGAL SIZE 8.5" X 14")

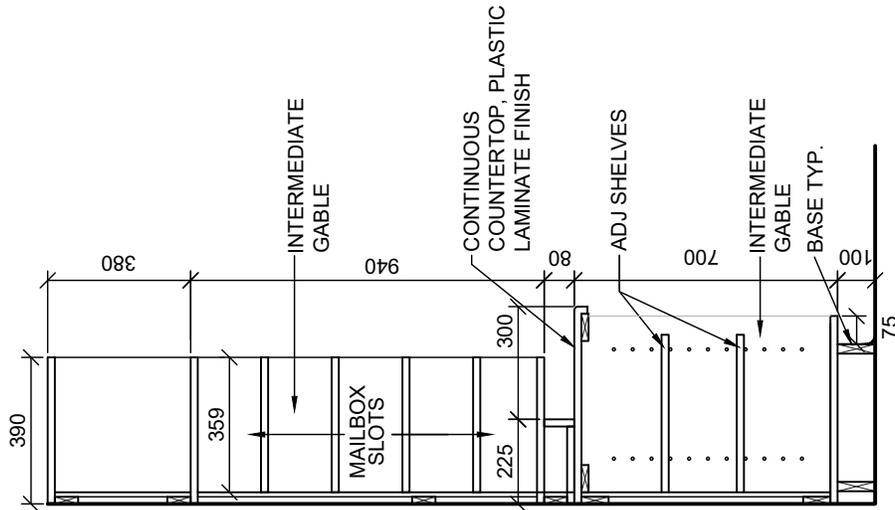

SECTION
SCALE 1:20

**MAILBOX SLOTS AND OPEN SHELVING
TYPE C7**


PROJ: 22124
SCALE: NOTED
DRAWN: KB
DATE: 260105

**HOSSACK
ARCHITECTURE**




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646**

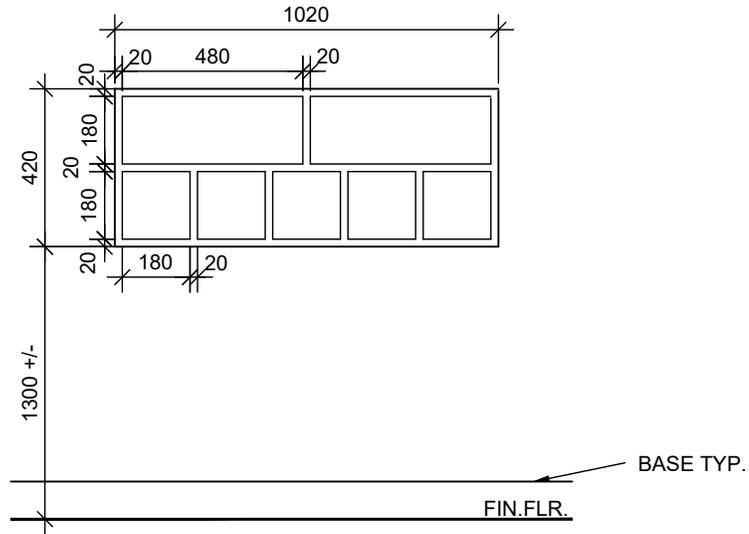

FRONT ELEVATION

SCALE 1 : 20

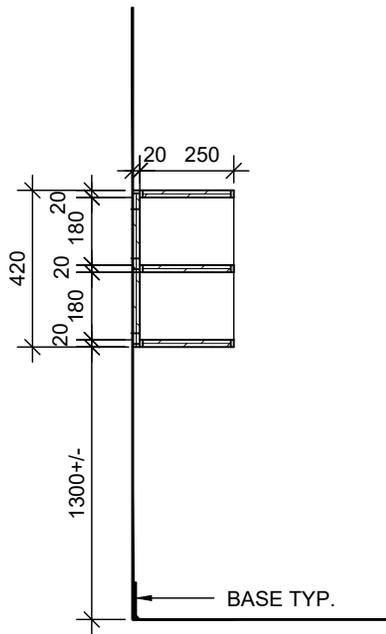

SECTION A

SCALE 1 : 20


NOTE:
REFER TO SPECIFICATION FOR MILLWORK
CONSTRUCTION AND HARDWARE.

**CHILD CARE WASHROOM CUBBIES
TYPE C9**

PROJ: 22124
SCALE: 1:20
DRAWN:GB
DATE: 260105



ISSUE/REV.
**AD
648**

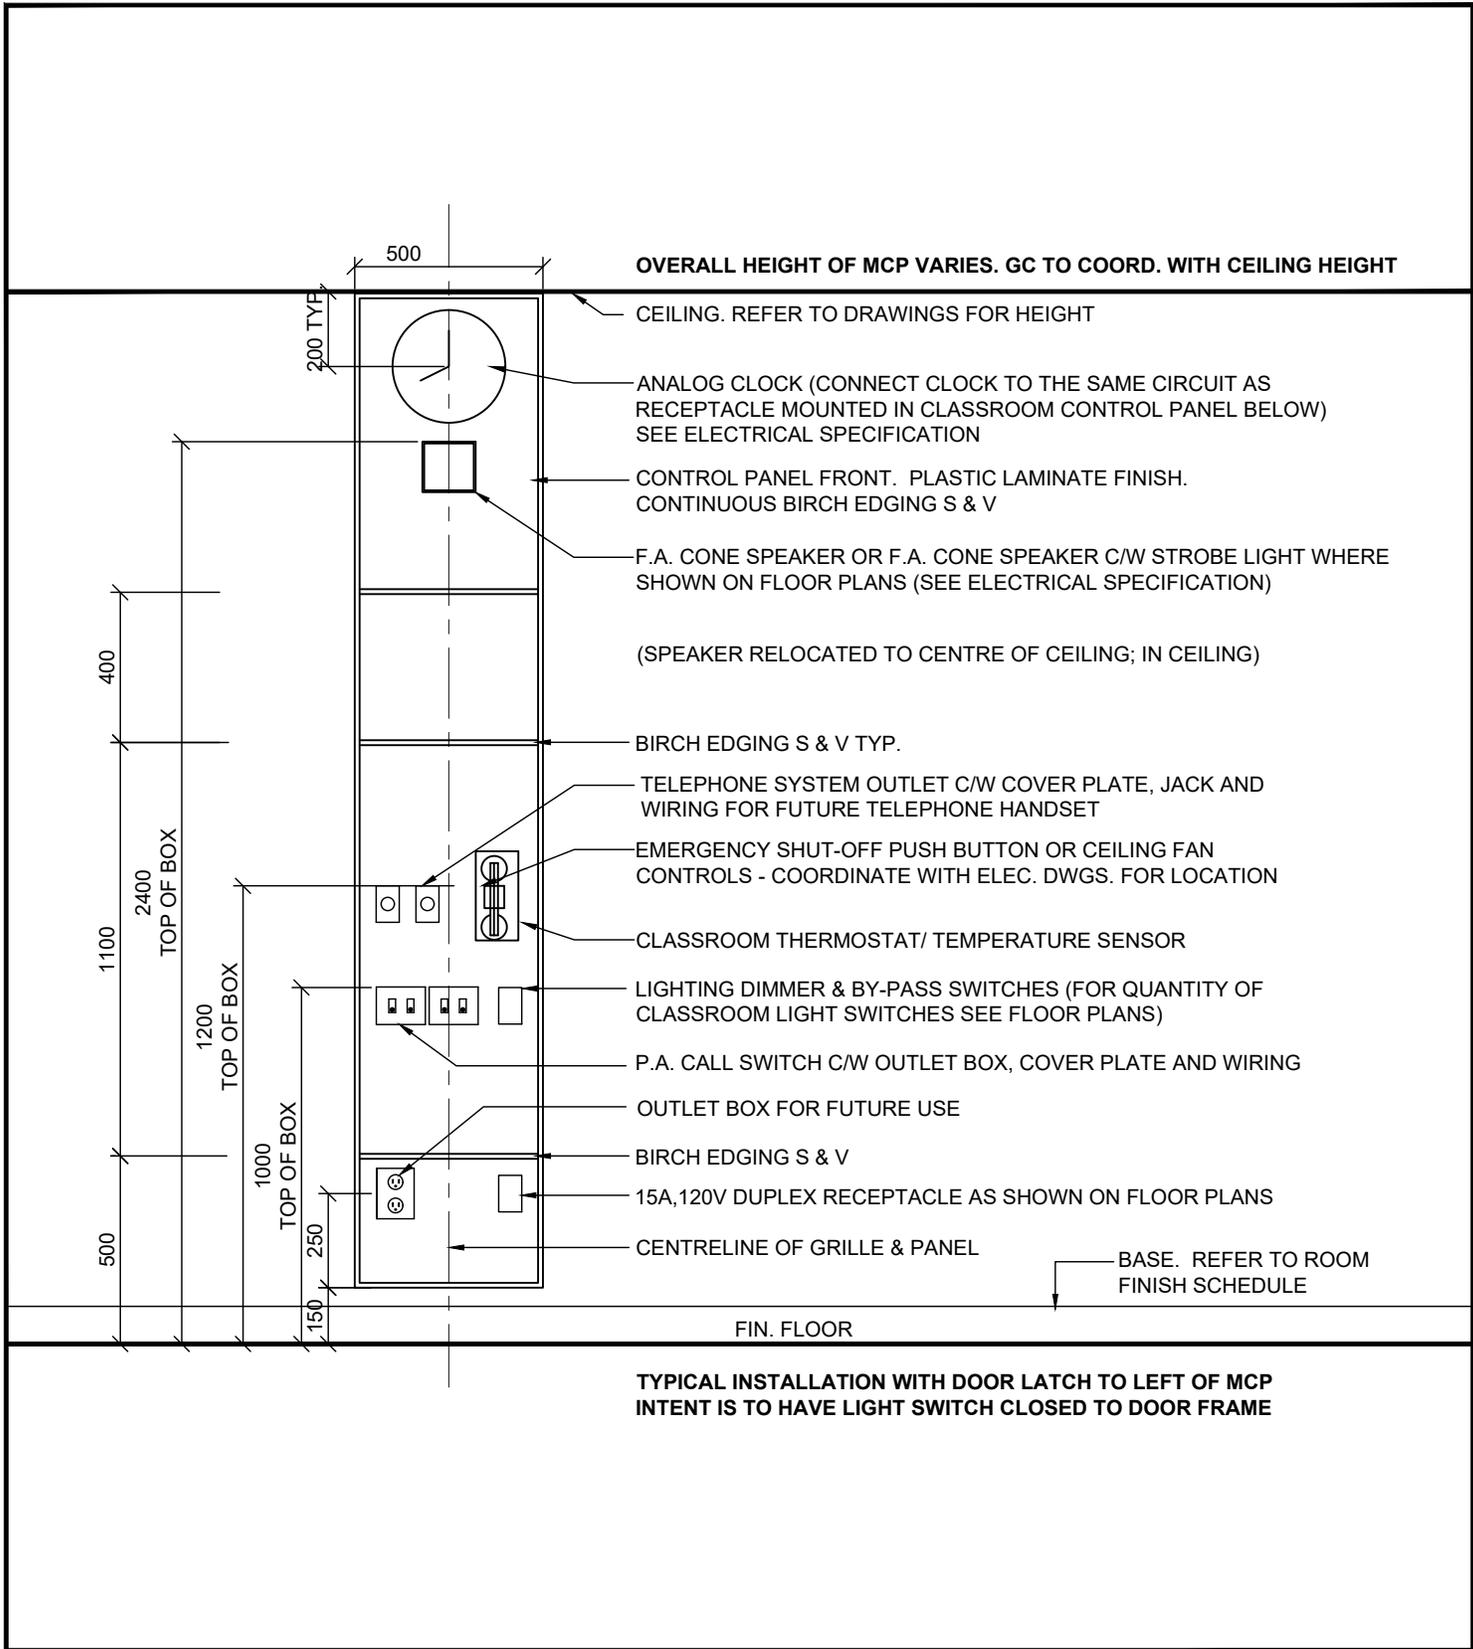

**TYPICAL INSTALLATION WITH DOOR LATCH TO LEFT OF MCP
INTENT IS TO HAVE LIGHT SWITCH CLOSED TO DOOR FRAME**


**MODULAR CONTROL PANEL
DOOR LATCH LEFT OF MCP**

| | |
|--------|--------|
| PROJ: | 22124 |
| SCALE: | 1:20 |
| DRAWN: | GB |
| DATE: | 260105 |




| |
|------------|
| ISSUE/REV. |
| AD 650 |

THIS DRAWING IS TO BE READ IN CONJUNCTION WITH THE SECTIONS AND DETAILS LISTED, AND THE WRITTEN SPECIFICATION.

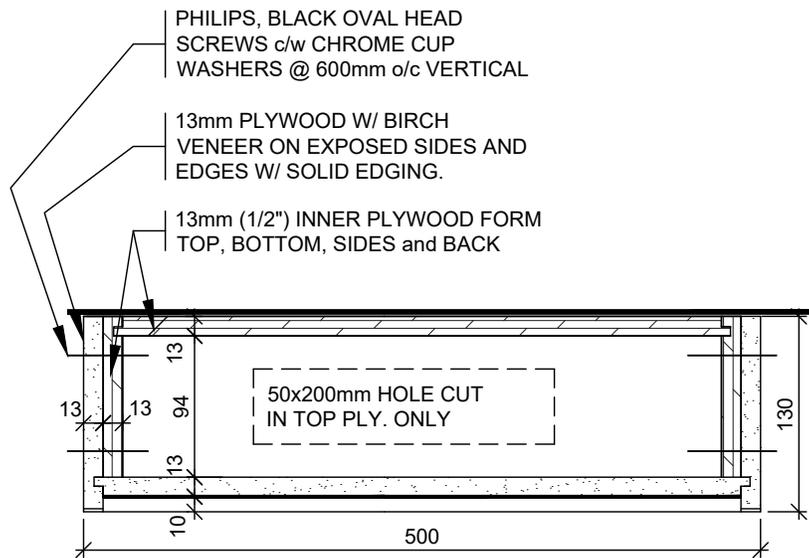

1 SECTION
650 PLAN VIEW

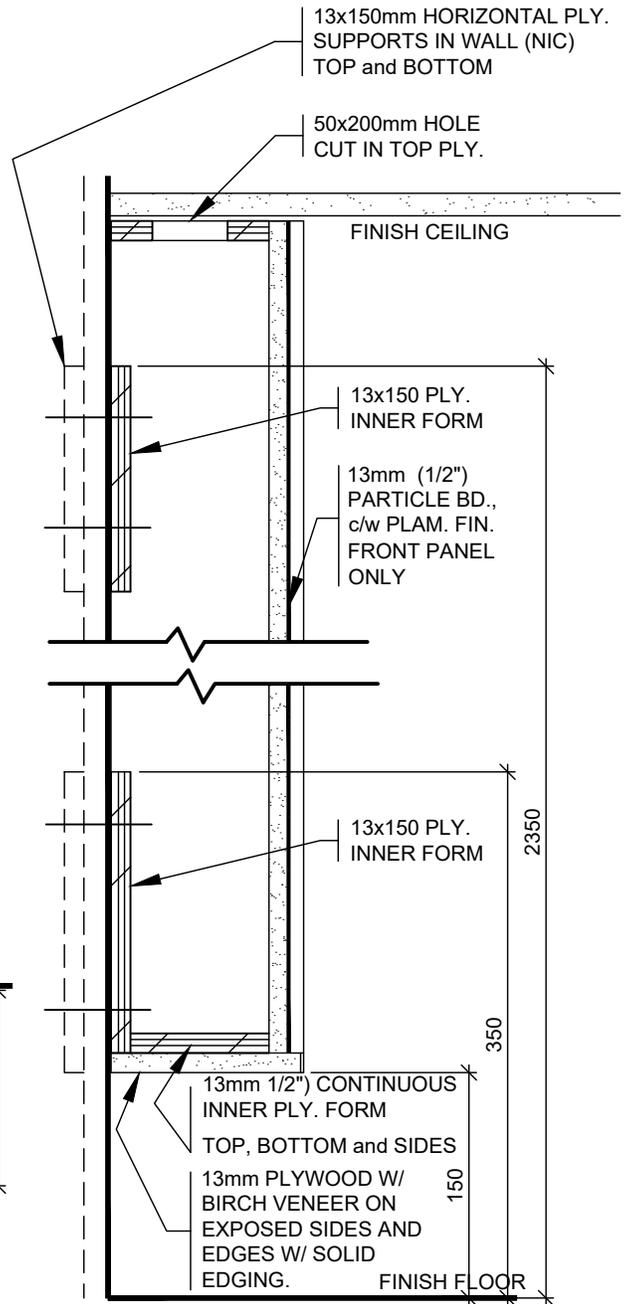


2 SECTION
650

MODULAR CONTROL PANEL SECTIONS

| | |
|--------|--------|
| PROJ: | 22124 |
| SCALE: | 1:5 |
| DRAWN: | GB |
| DATE: | 260105 |



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| ISSUE/REV. |
| AD 651 |

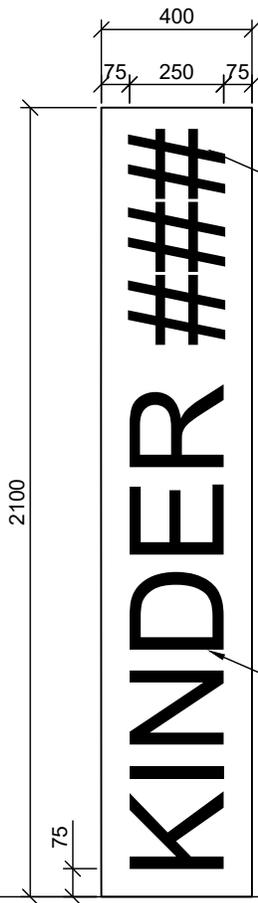

NOTE: REFER TO ELEVATIONS AND FLOOR PLANS FOR LOCATION OF INTERIOR SIGNAGE PANELS ADJACENT KINDERGARTEN DOORS

PLASTIC LAMINATE ON 16MM PARTICLE BOARD LAMINATED TO WALL

SOLID WHITE ACRYLIC LETTERS, REFER TO SPECIFICATIONS

BASE. REFER TO ROOM FINISH SCHEDULE

FIN. FLOOR



INTERIOR SIGNAGE PANEL (ISP)

| | |
|--------|--------|
| PROJ: | 22124 |
| SCALE: | 1:20 |
| DRAWN: | AM |
| DATE: | 260105 |



ISSUE/REV.


AD
652

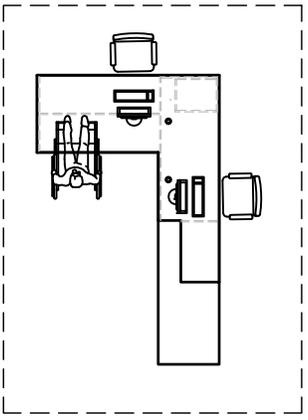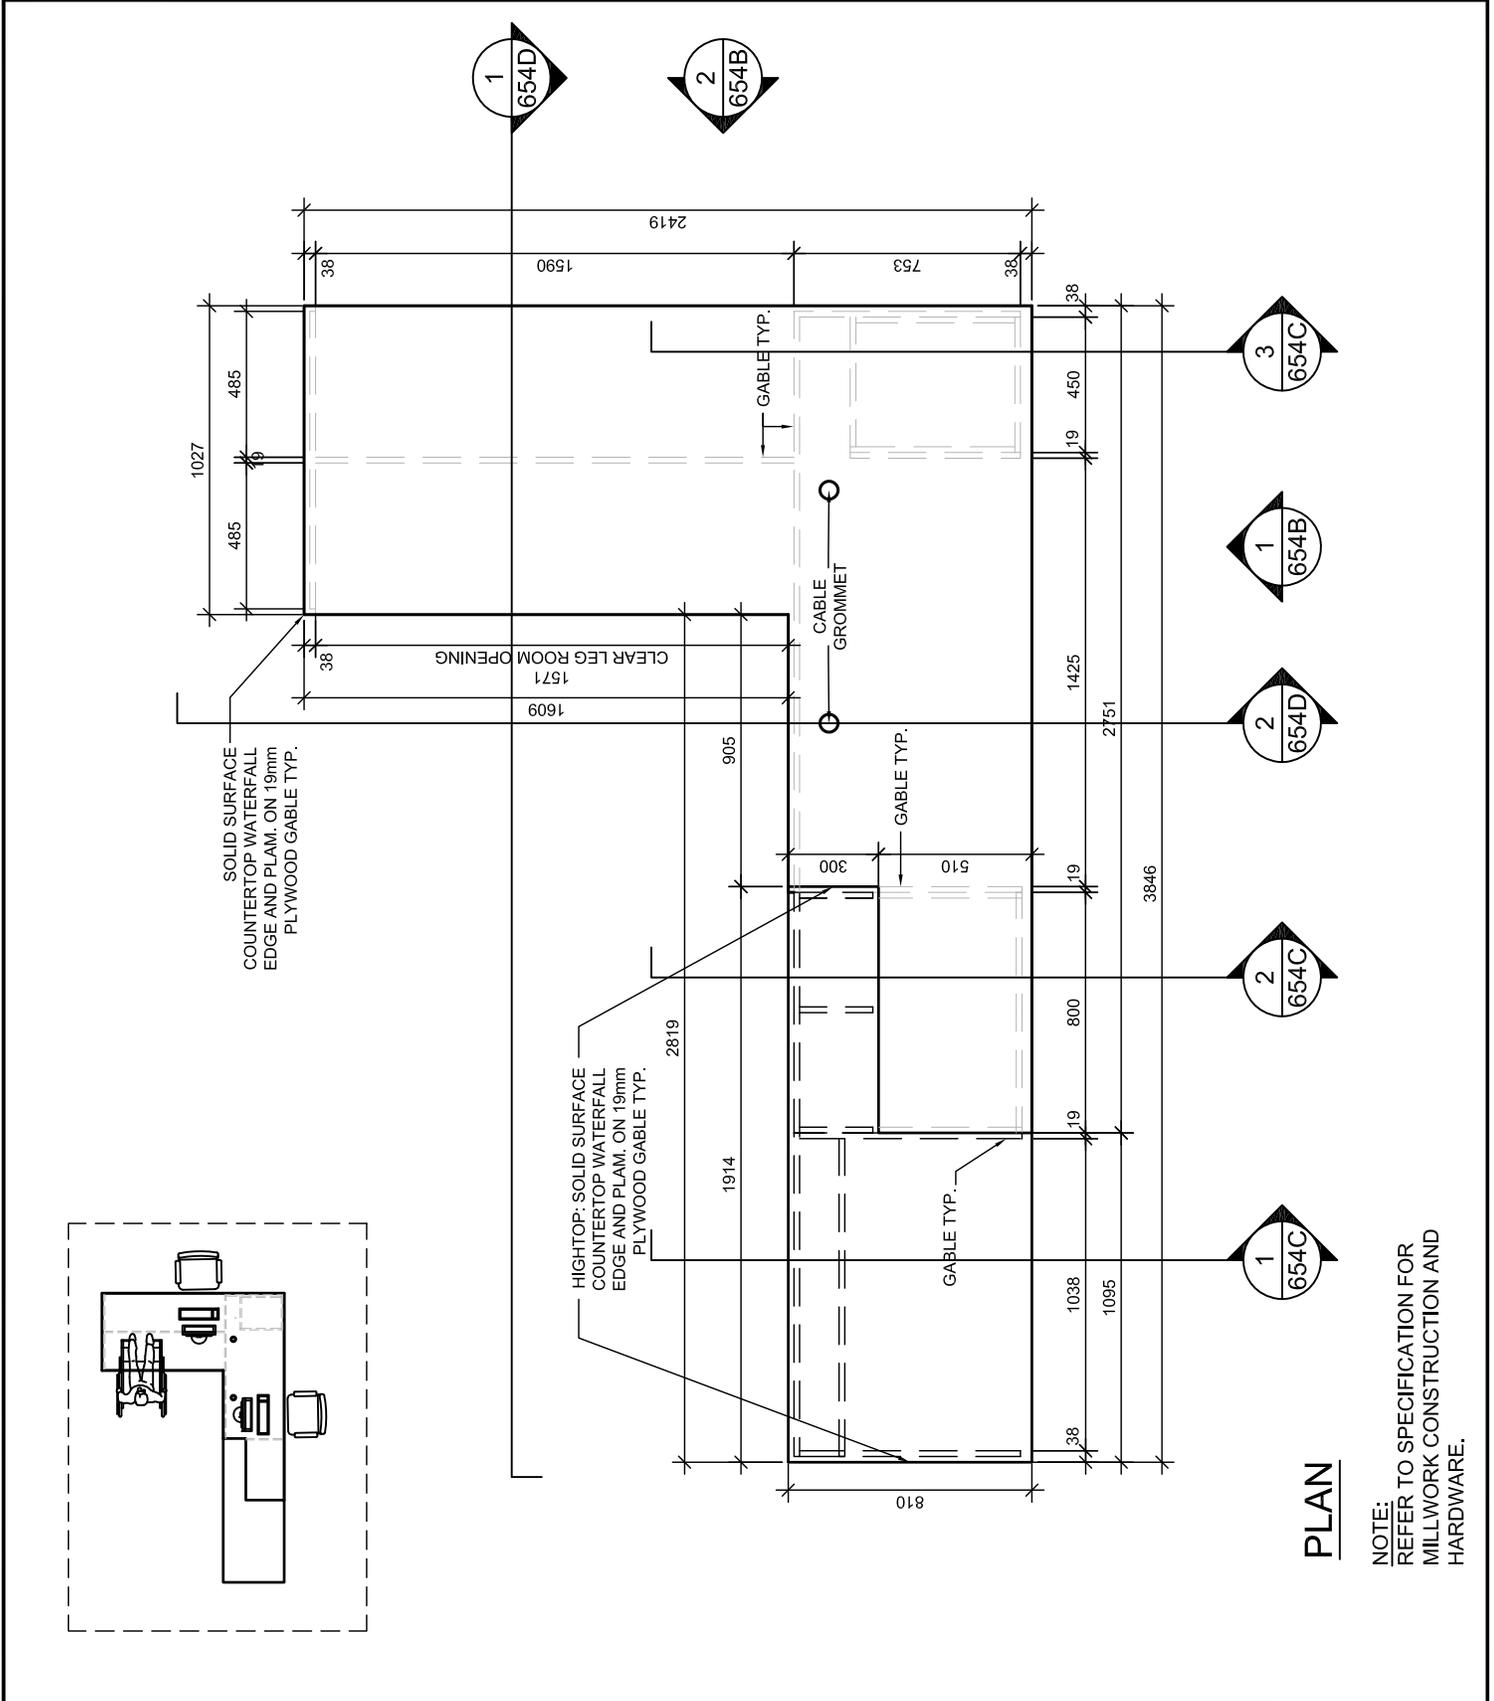


PLAN

NOTE:
REFER TO SPECIFICATION FOR
MILLWORK CONSTRUCTION AND
HARDWARE.

| | | | |
|-------------------------|--------------|--|--------------------|
| <h1>RECEPTION DESK</h1> | PROJ: 22124 | HOSSACK ARCHITECTURE  | ISSUE/REV. 00 |
| | SCALE: 1:25 | | AD 654A |
| | DRAWN: KB | | |
| | DATE: 260201 | | |

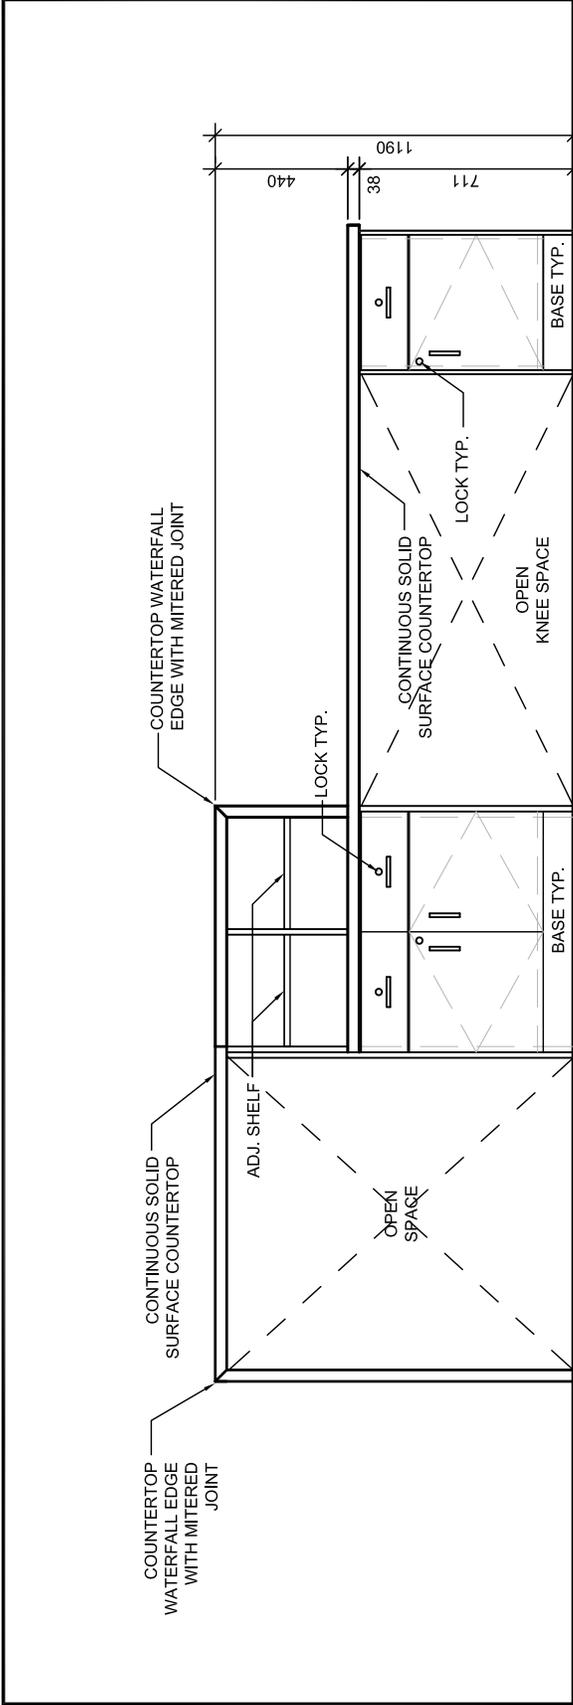

1 COUNTER ELEVATION
 654B SCALE: 1:25

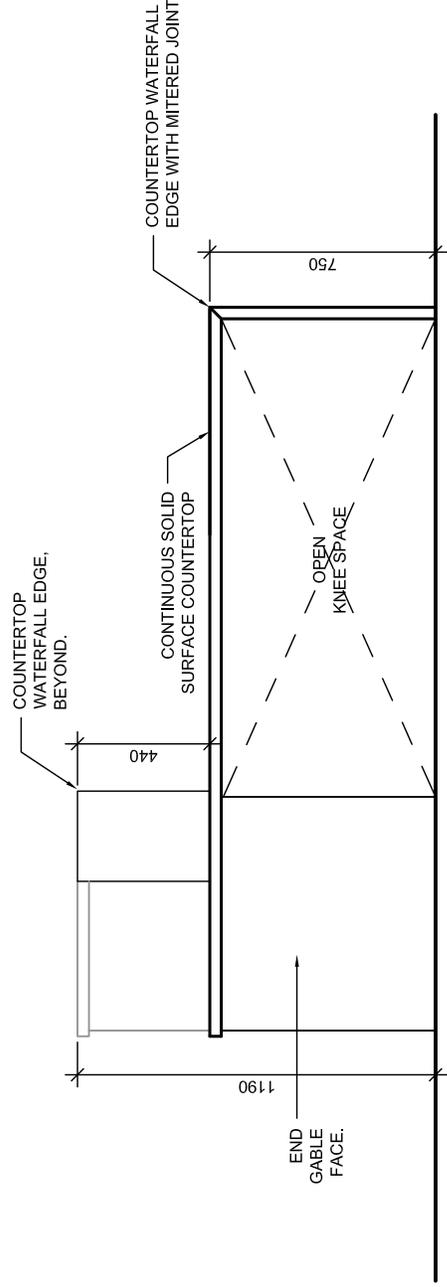


2 COUNTER ELEVATION
 654B SCALE: 1:20


ELEVATION

NOTE:
 REFER TO FLOOR PLAN FOR DESK LOCATION


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|-----------------------|--------------|---------------------------------|----------------|
| RECEPTION DESK | PROJ: 22124 | HOSSACK ARCHITECTURE | ISSUE/REV. 00 |
| | SCALE: NOTED | | AD 654B |
| | DRAWN: KB | | |
| | DATE: 260201 | | |

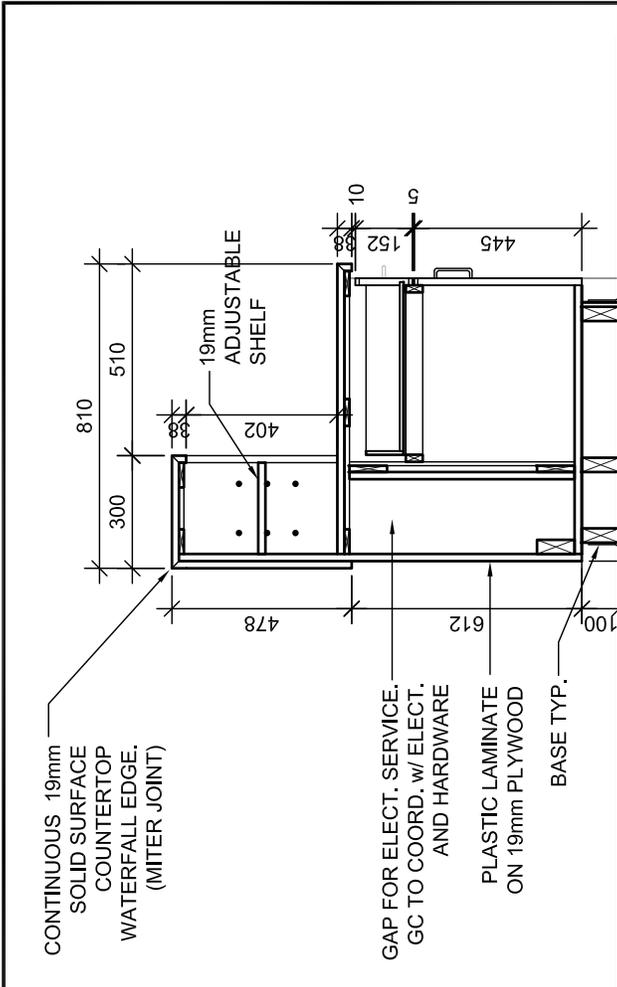

2 COUNTER SECTION
654C SCALE: 1:20

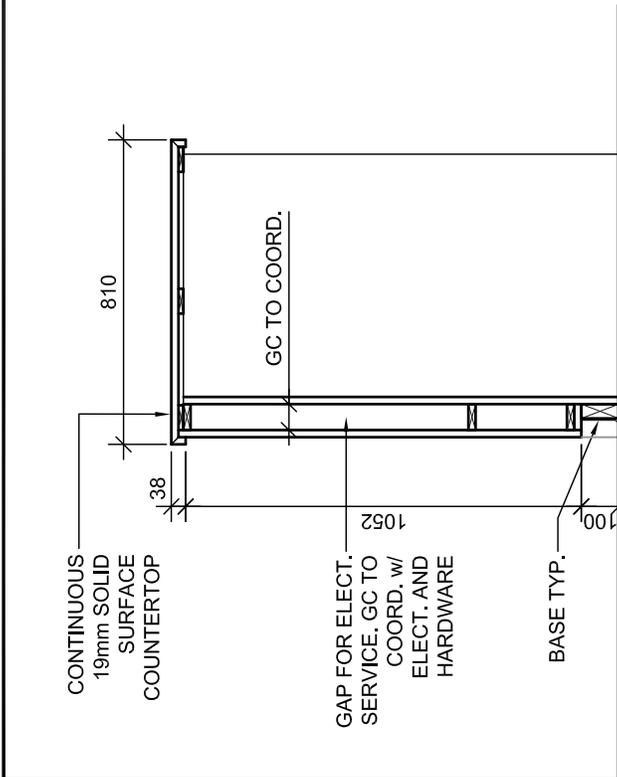


1 COUNTER SECTION
654C SCALE: 1:20

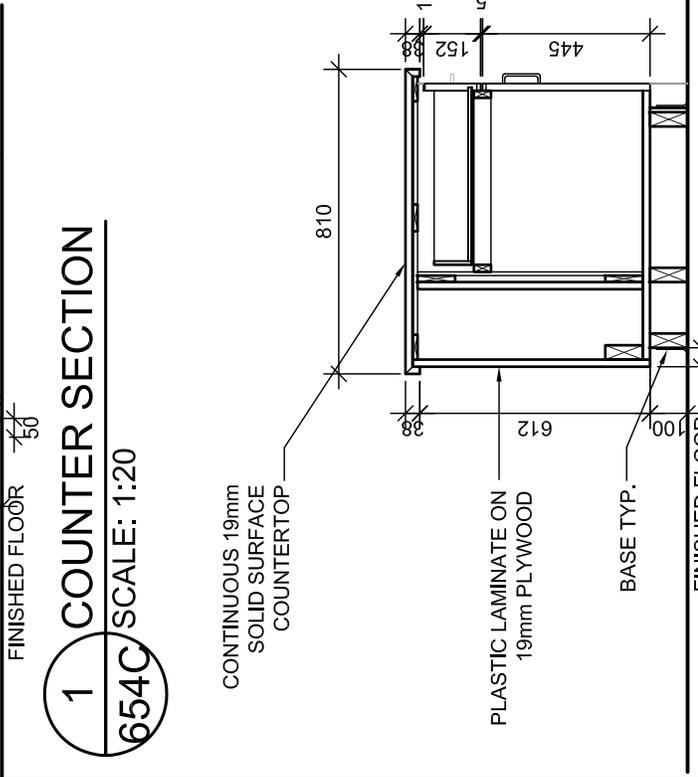


3 COUNTER SECTION
654C SCALE: 1:20

| | | | |
|-------------------------|--------------|---|--------------------------|
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| | SCALE: 1:20 | | AD 654C |
| | DRAWN: KB | | |
| | DATE: 260201 | | |

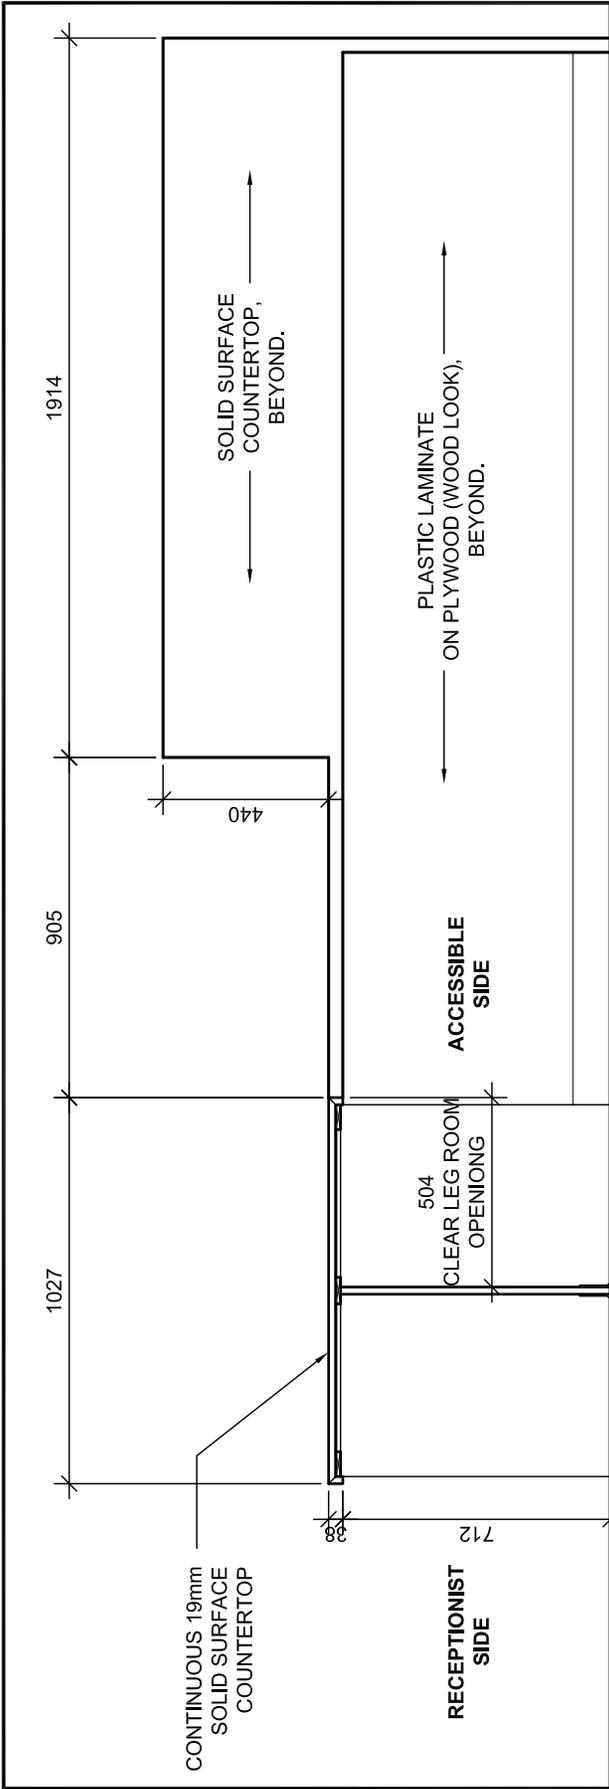


1 COUNTER SECTION
 SCALE: 1:20

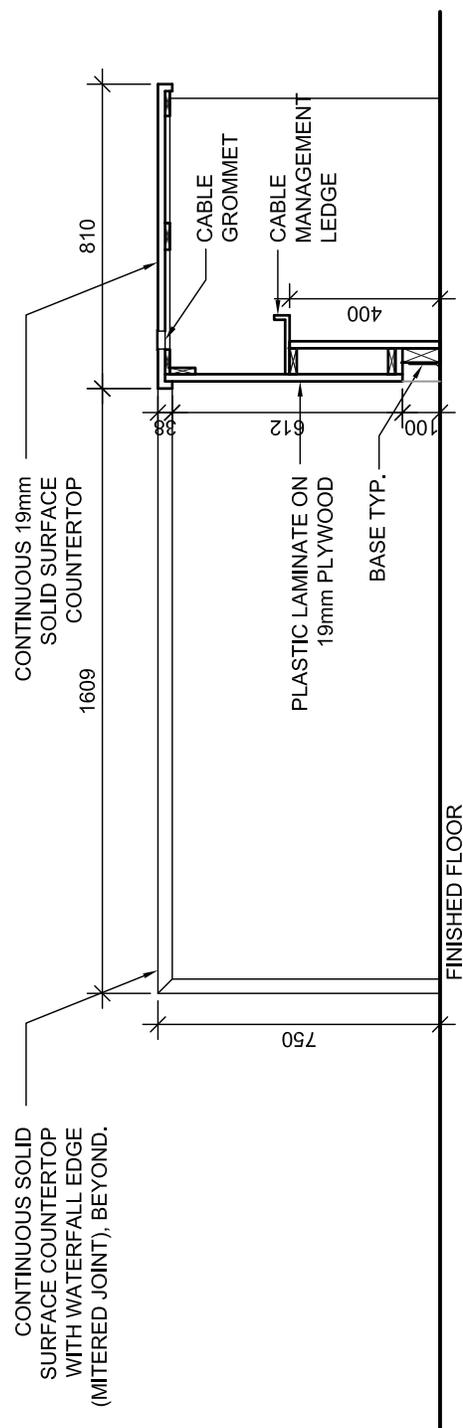

2 COUNTER SECTION
 SCALE: 1:20

| | | | |
|-------------------------|--------------|---|--------------------------|
| <h1>RECEPTION DESK</h1> | PROJ: 22124 | HOSSACK ARCHITECTURE  | ISSUE/REV. 00 |
| | SCALE: 1:20 | | AD 654D |
| | DRAWN: KB | | |
| | DATE: 260201 | | |

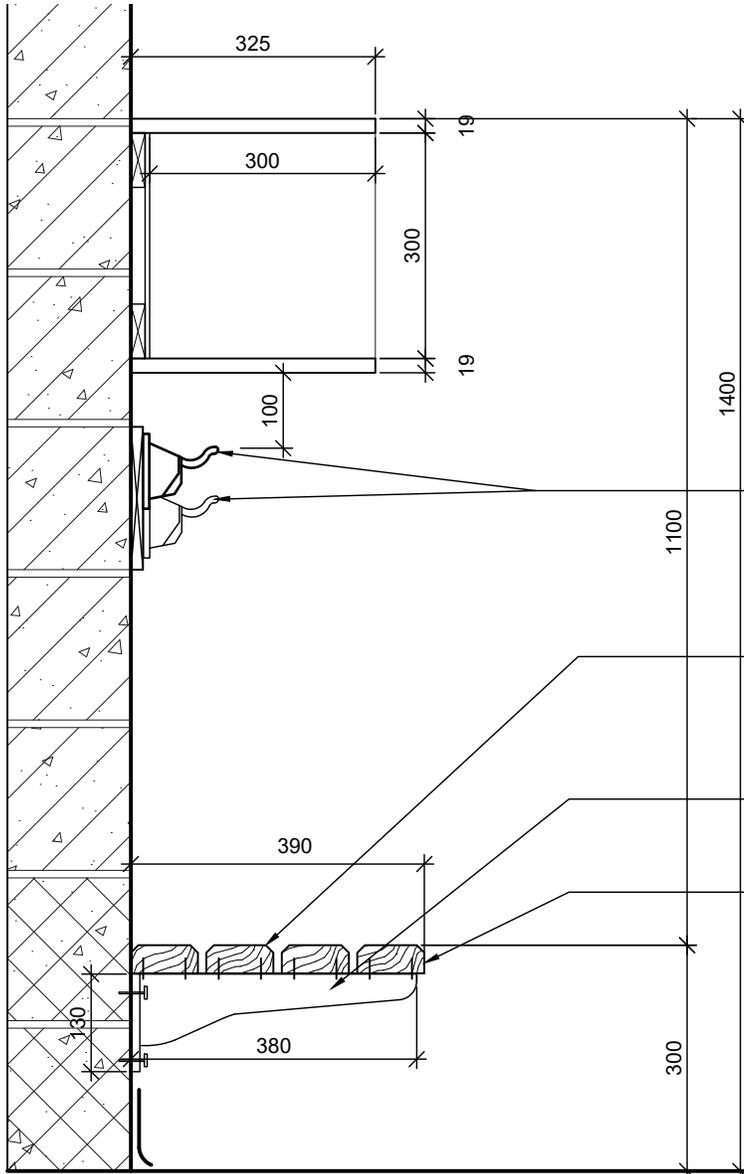

NOTE:
FOR LENGTH OF CUBBIES, REFER TO
INTERIOR ELEVATIONS.

BREAK AWAY COAT HOOKS FASTENED TO
2X8 SOLID WOOD - CLEAR URETHANE
FINISH. HOOKS ON TOP AND BOTTOM ROW
STAGGERED

4 - 38 X 89 HARDWOOD SLATS
WITH EASED EDGES SECURED
TO BRACKETS

HAFELE "HEBGO " BRACKET. AT 800mm O.C.
BOLTED TO WALL WITH 9x60 LAG BOLTS

CHAMFER EDGE OF BENCH IN
KINDERGARTEN CLASSROOM
WHERE NO HALF WALL EXIST AT
ADJACENT B3 UNIT

SECTION
SCALE 1:10


KINDERGARTEN CUBBIES TYPE K4

| | |
|--------|--------|
| PROJ: | 22124 |
| SCALE: | NOTED |
| DRAWN: | CC |
| DATE: | 260105 |




ISSUE/REV.

AD
655

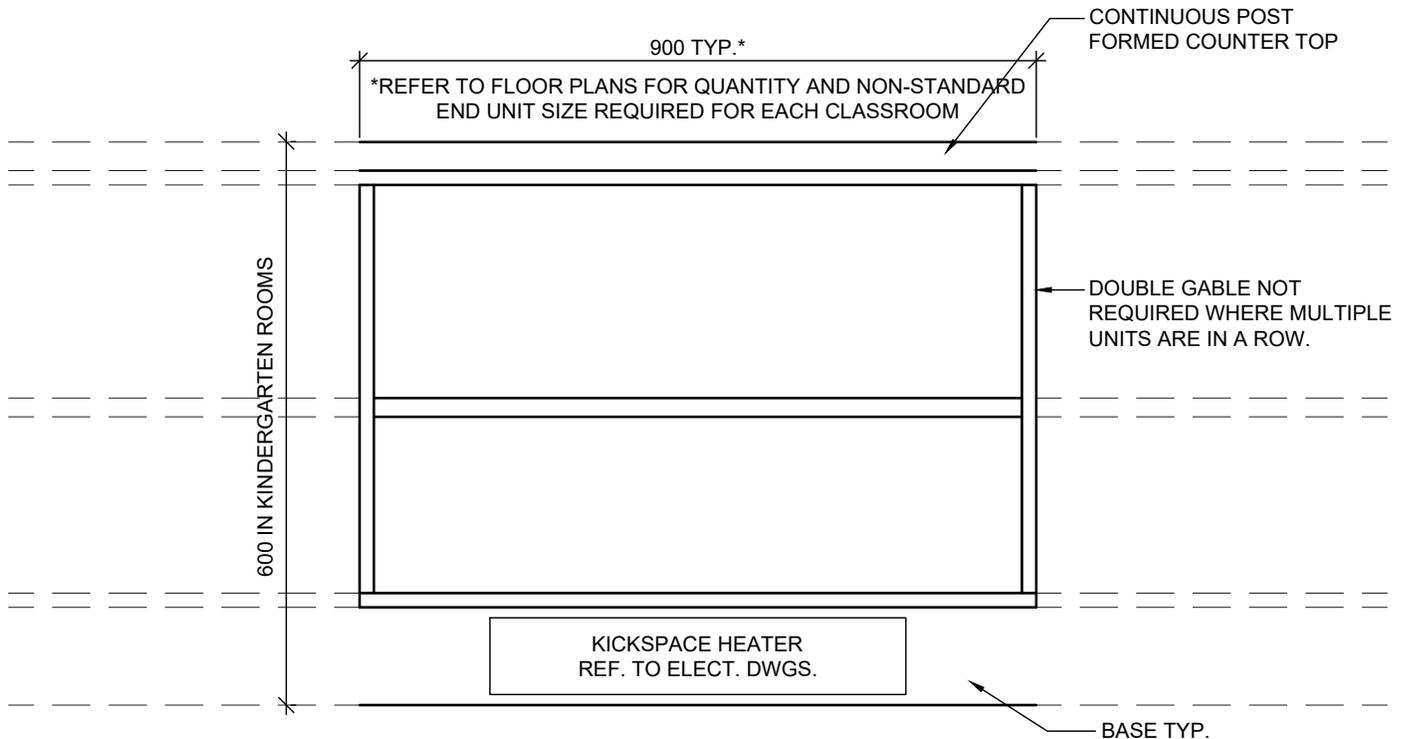

ELEVATION

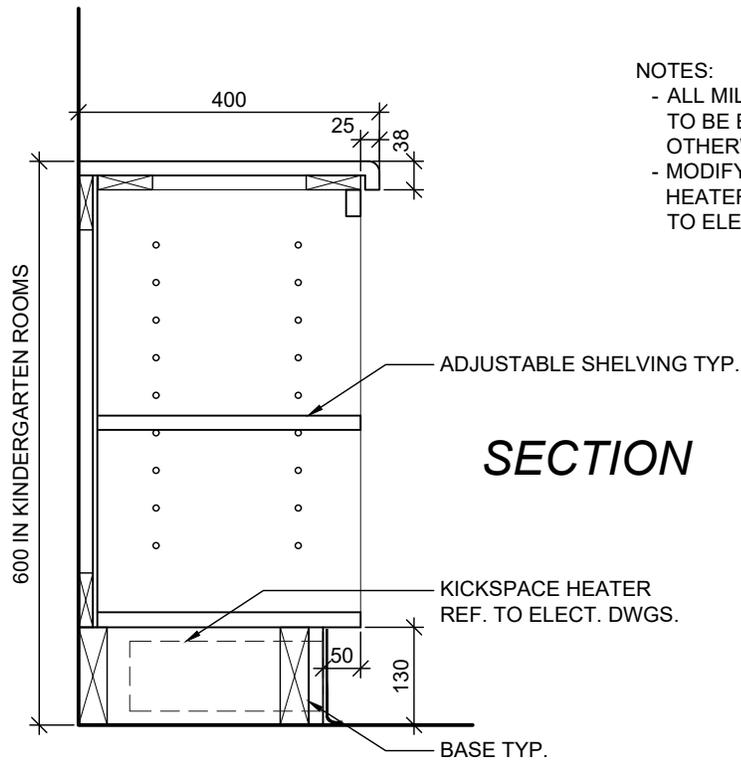

NOTES:

- ALL MILLWORK DOORS AND DRAWERS TO BE EQUIPT WITH LOCKS UNLESS OTHERWISE NOTED.
- MODIFY KICK PLATES FOR KICKSPACE HEATER WHERE APPLICABLE. REFER TO ELECT. DWGS. TYPICAL.

SECTION


OPEN SHELVING TYPE K5
KINDERGARTEN ROOMS

PROJ: 22124
SCALE: 1:10
DRAWN: KB
DATE: 260105




ISSUE/REV.

AD
656

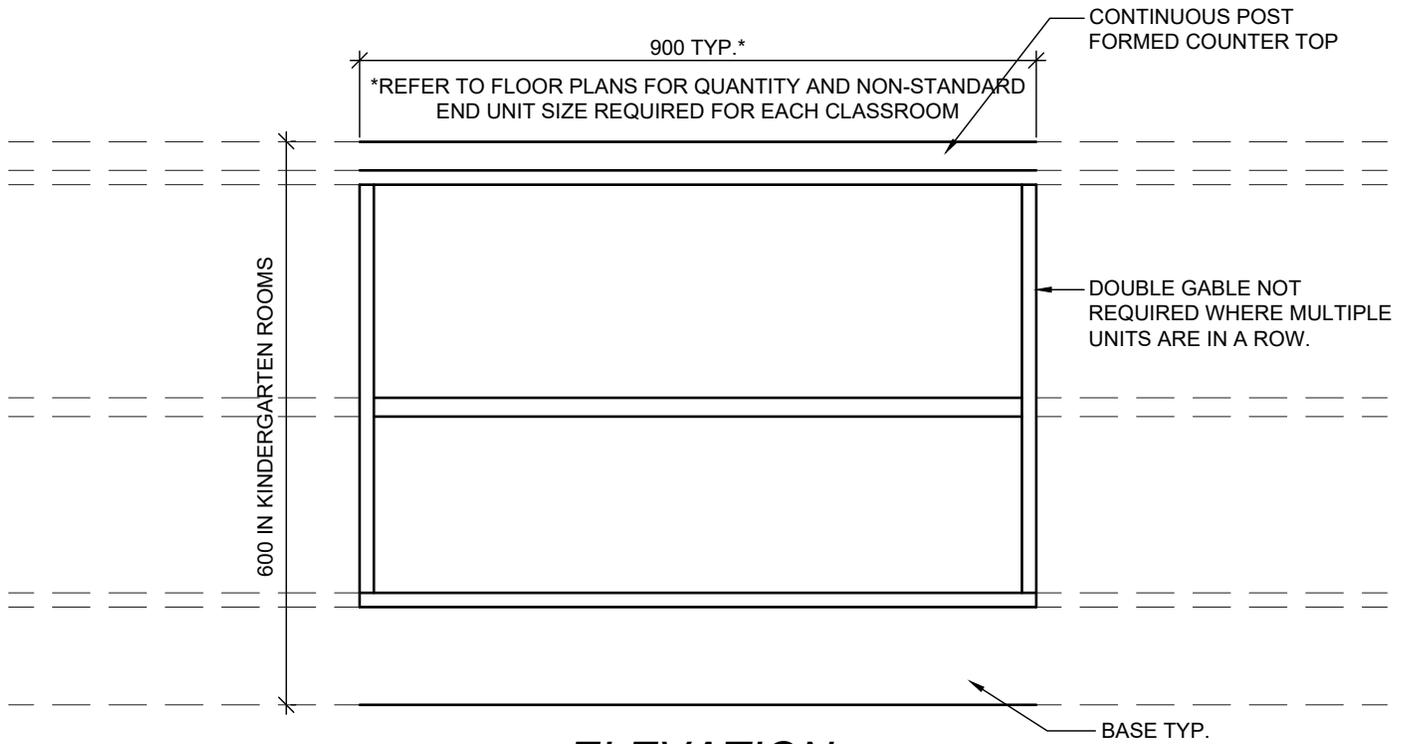

ELEVATION

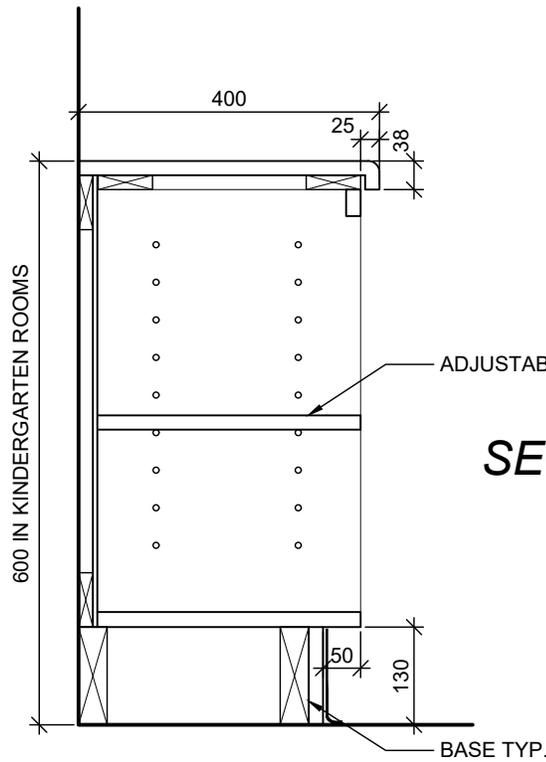

NOTES:
 - ALL MILLWORK DOORS AND DRAWERS TO BE EQUIPT WITH LOCKS UNLESS OTHERWISE NOTED.

SECTION


OPEN SHELVING TYPE K6
 KINDERGARTEN ROOMS

PROJ: 22124
 SCALE: 1:10
 DRAWN: KB
 DATE: 260105



ISSUE/REV.

AD
 657

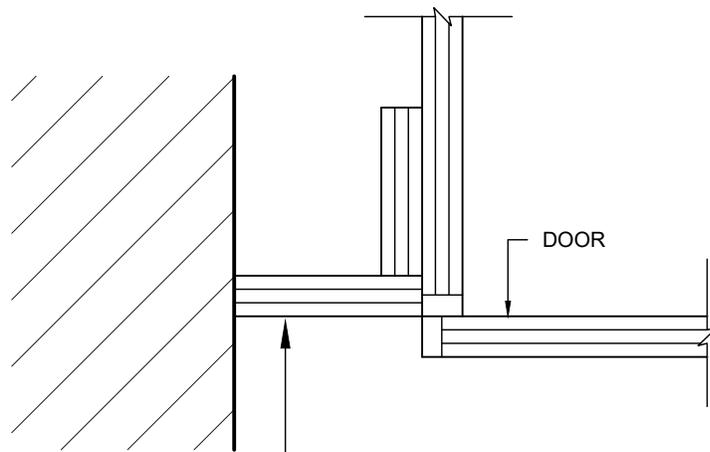

FILLER STRIP AT ALL MILLWORK/
WALL CONNECTIONS. (TYPICAL).

UPPER CABINETS: PROVIDE AT FRONT, UNDERSIDE AND TOP

LOWER CABINETS: PROVIDE AT FRONT AND BASE


MILLWORK FILLER STRIP DETAIL

| | |
|--------|--------|
| PROJ: | 22124 |
| SCALE: | 1:10 |
| DRAWN: | GB |
| DATE: | 260105 |




ISSUE/REV.
00


AD
661

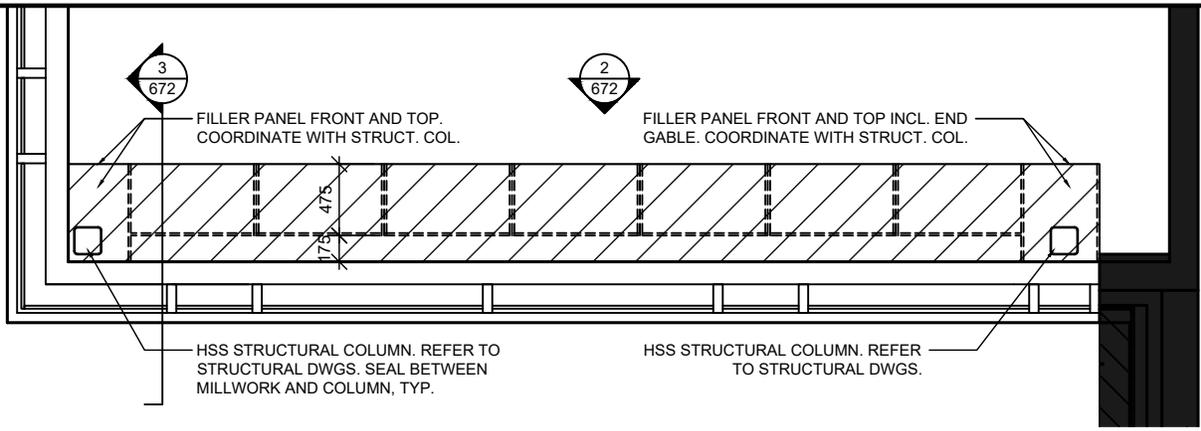

1
672 **PLAN**
SCALE NTS

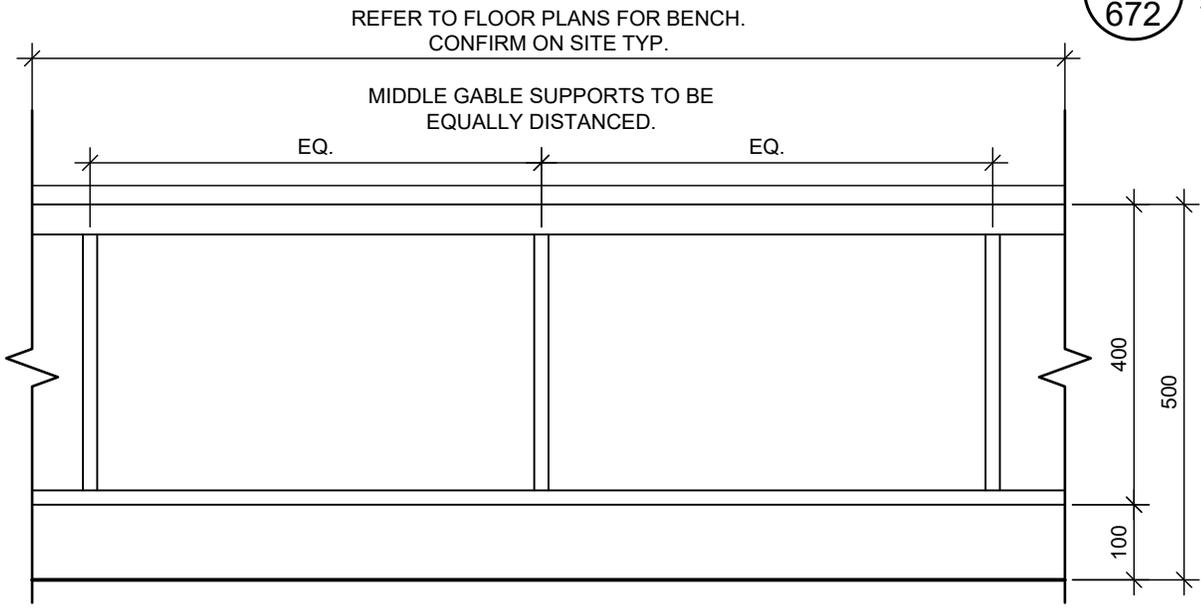

2
672 **ELEVATION**
SCALE 1:10

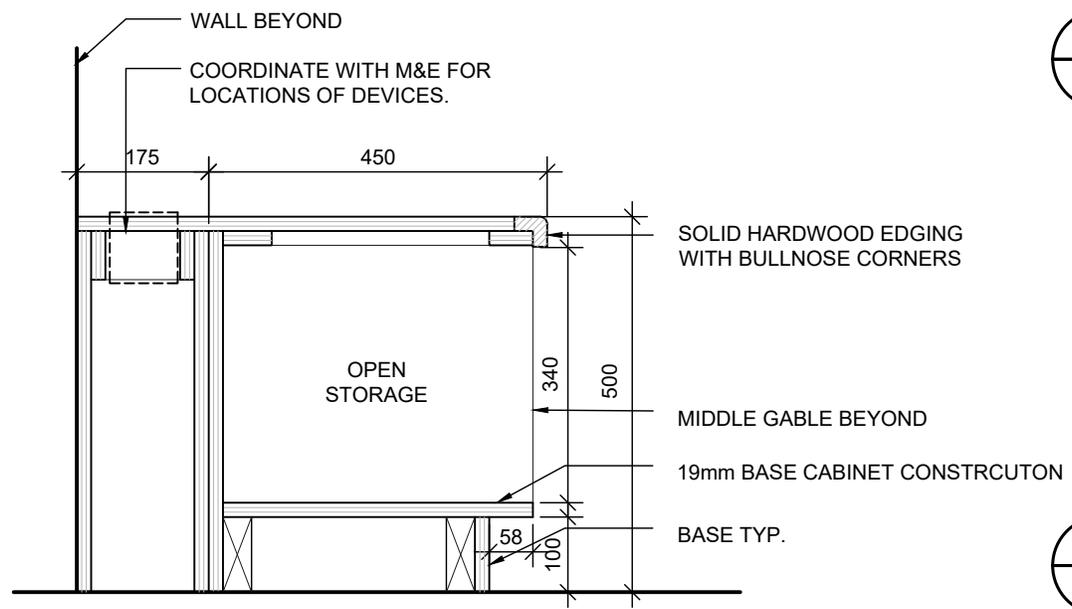


3
672 **SECTION**
SCALE 1:10

**LIBRARY MILLWORK
TYPE L3: BENCH WITH OPEN STORAGE**

| | |
|--------|--------|
| PROJ: | 22124 |
| SCALE: | NOTED |
| DRAWN: | KB |
| DATE: | 260105 |



| | |
|------------|-----|
| ISSUE/REV. | 00 |
| AD | 672 |

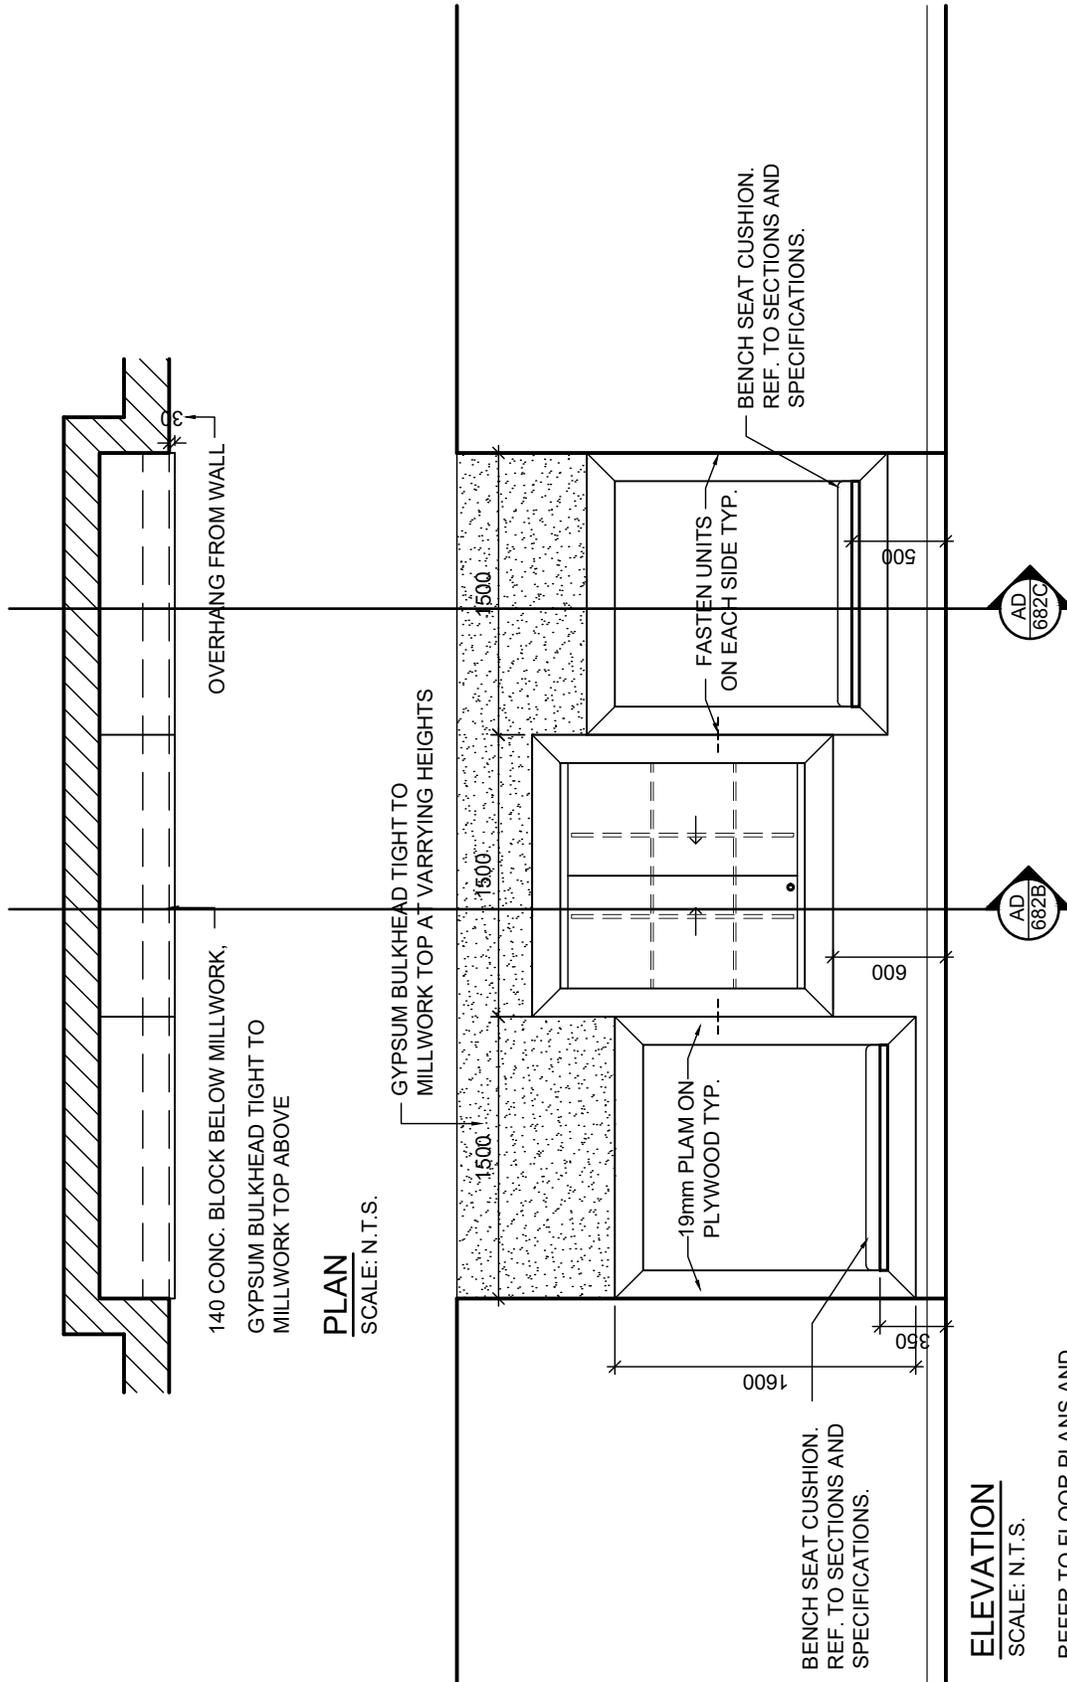

PLAN
SCALE: N.T.S.

ELEVATION
SCALE: N.T.S.

REFER TO FLOOR PLANS AND INTERIOR ELEVATIONS FOR LOCATION.


FEATURE WALL DISPLAY AND BENCH DETAILS - TYPE D2
LOBBY 102

PROJ: 22124
SCALE: N.T.S.
DRAWN: KB
DATE: 260105



ISSUE/REV.
00

AD
682A

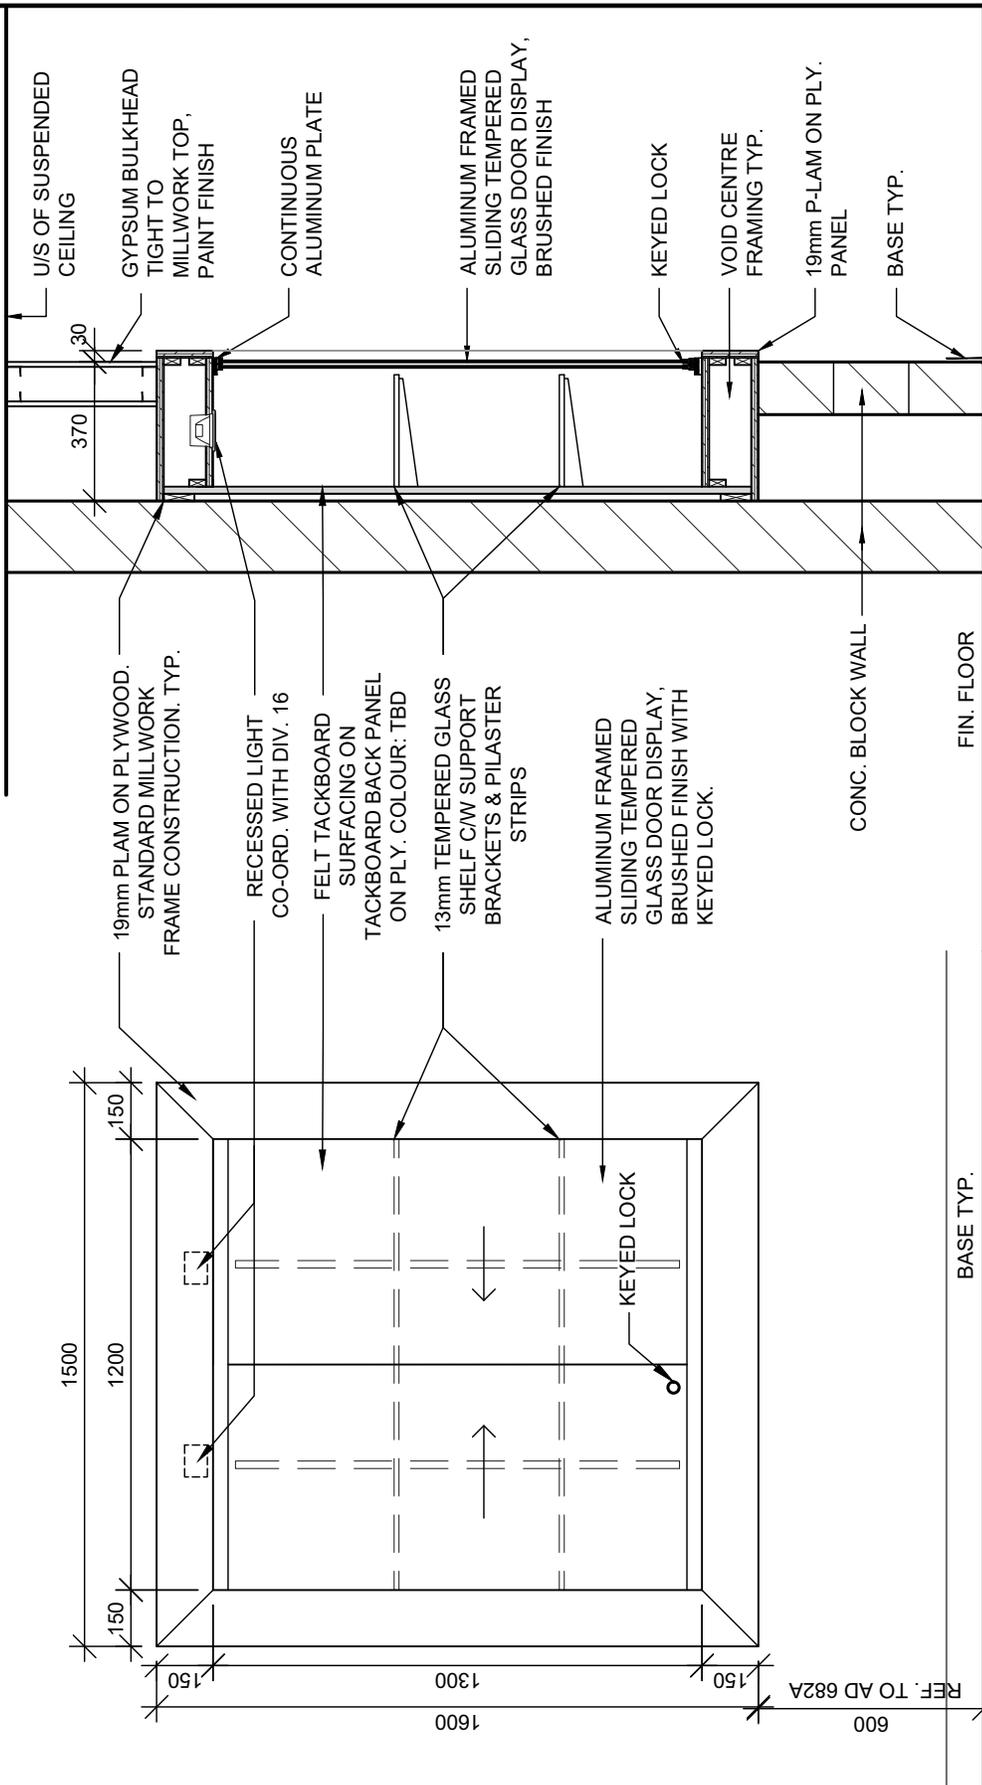

SECTION
SCALE 1:20

ELEVATION
SCALE 1:20


FEATURE WALL DISPLAY AND BENCH DETAILS - TYPE D2
LOBBY 102

| | |
|--------|--------|
| PROJ: | 22124 |
| SCALE: | NOTED |
| DRAWN: | KB |
| DATE: | 260105 |



ISSUE/REV.
00

AD
682B

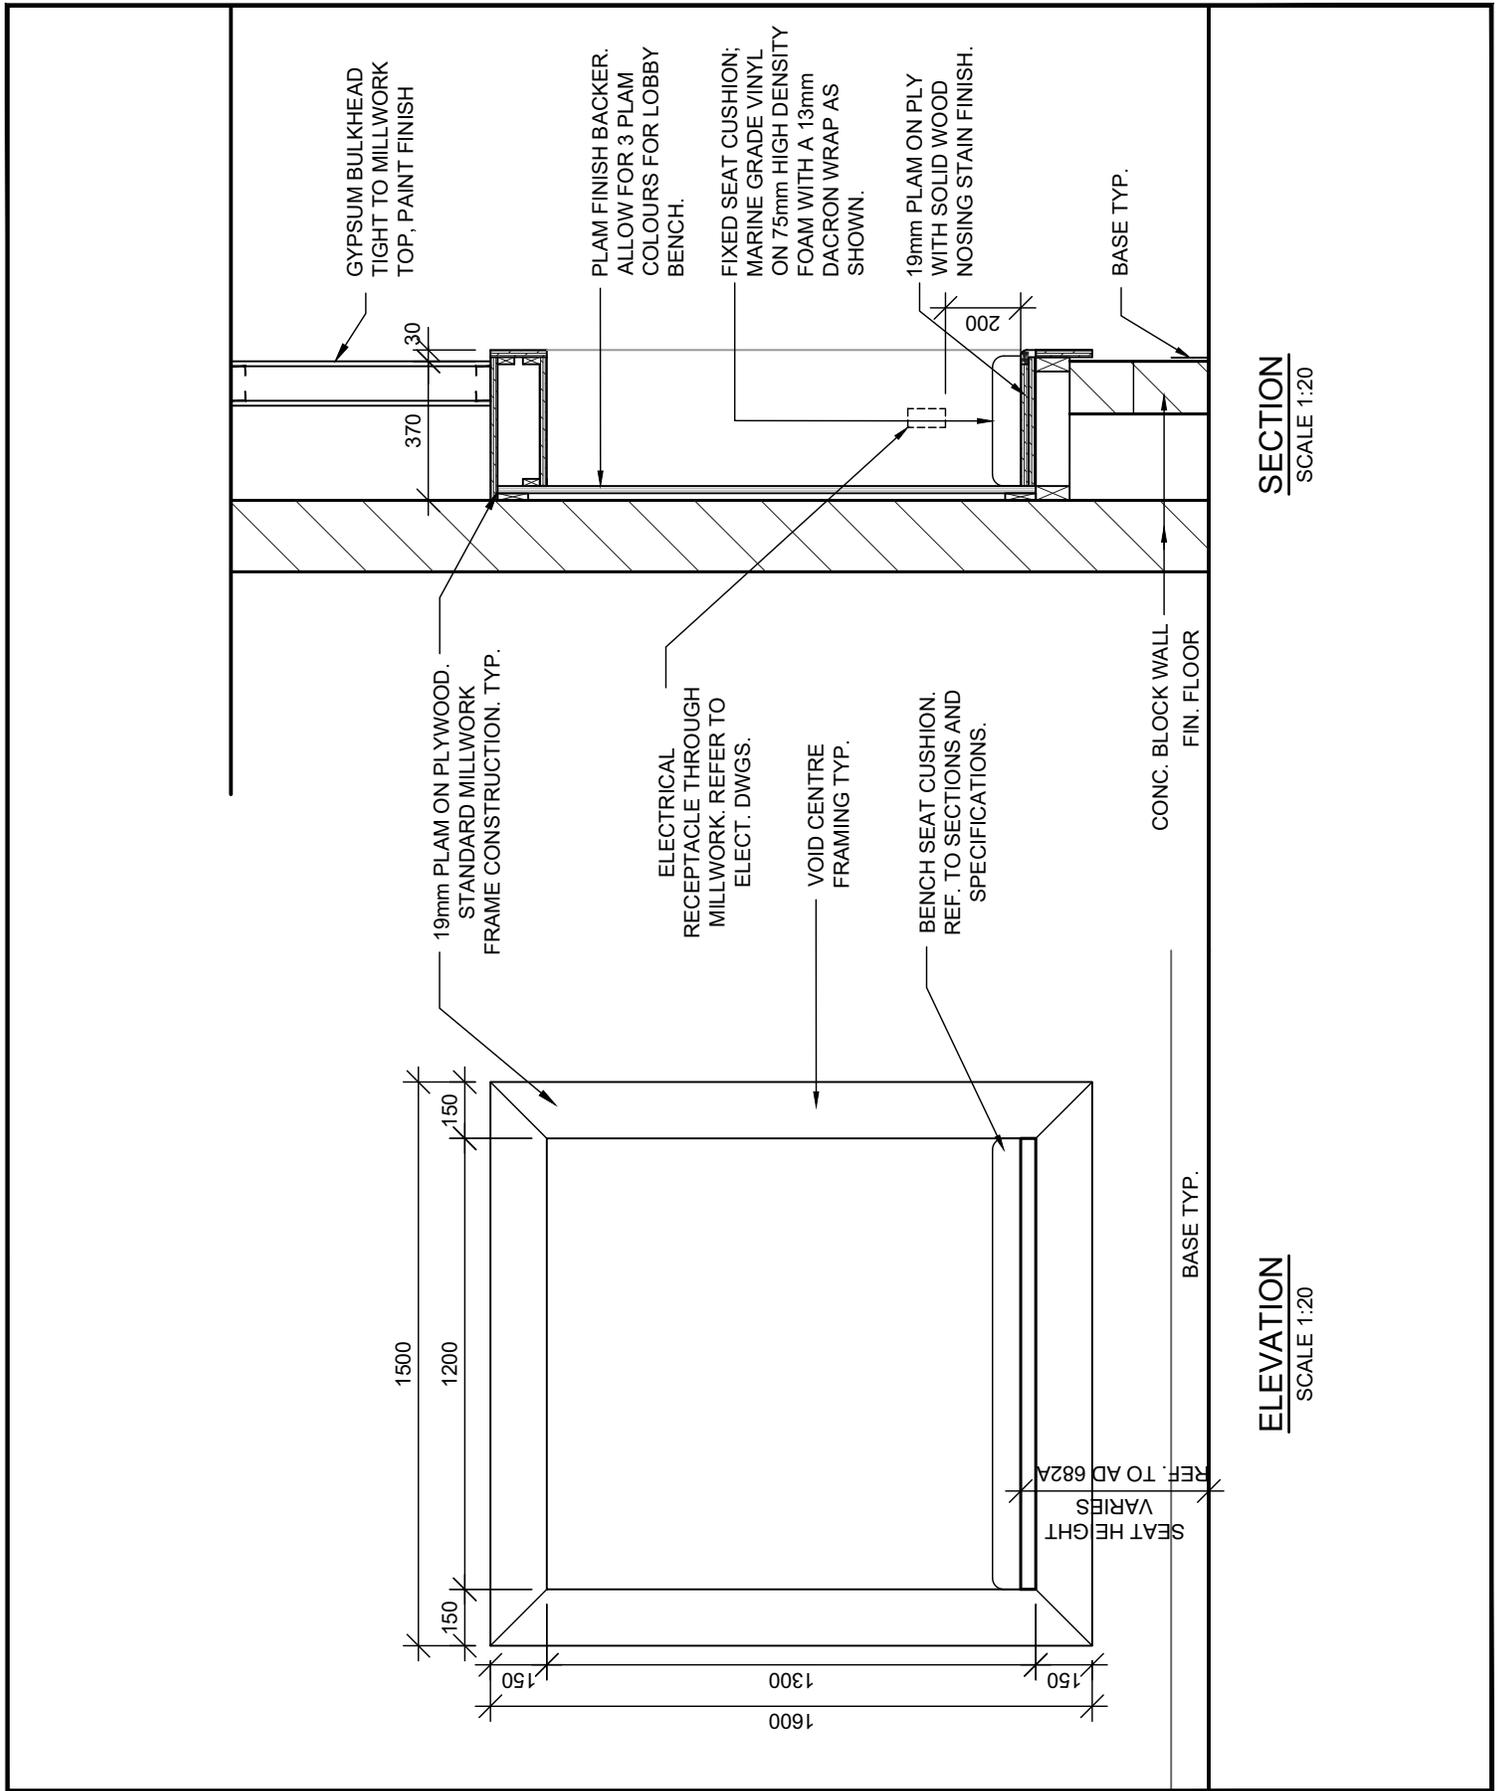

FEATURE WALL DISPLAY AND BENCH DETAILS - TYPE D2
LOBBY 102

PROJ: 22124
SCALE: NOTED
DRAWN: KB
DATE: 260105



ISSUE/REV.
00

AD
682C



FELT TACKBOARD SURFACING ON TACKBOARD BACK PANEL ON PLY.

19mm PLAM ON PLY. VERTICAL GABLE

13mm TEMPERED GLASS SHELF C/W SUPPORT BRACKETS & PILASTER STRIPS

ELEVATION

SCALE 1:20

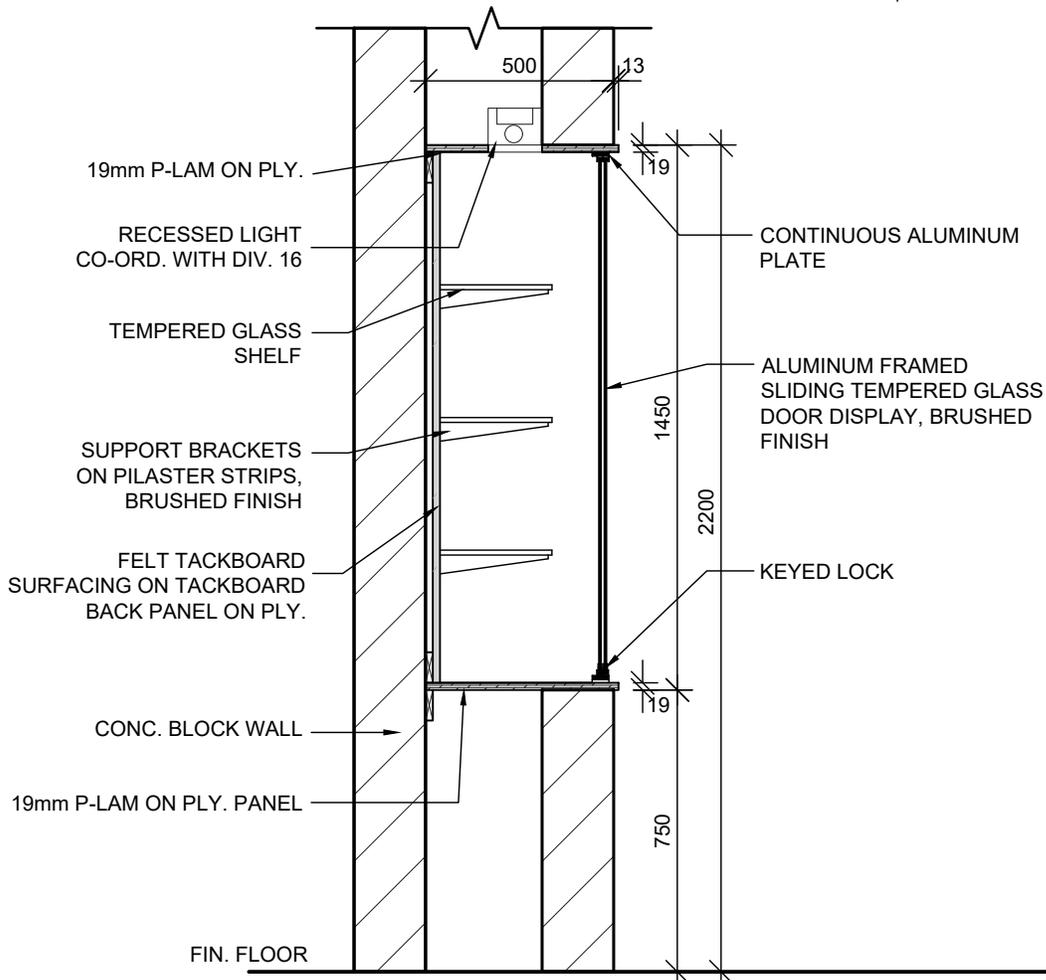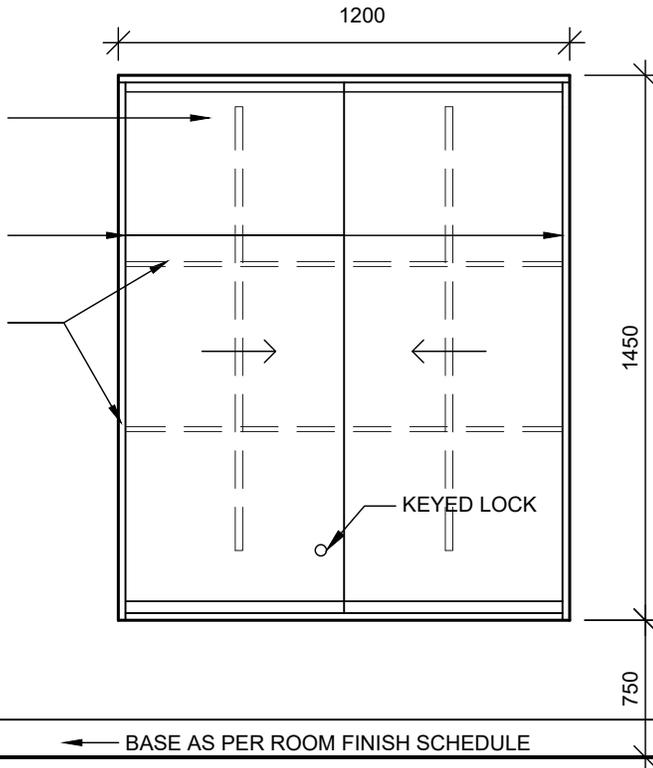


**RECESSED DISPLAY CASE
TYPE D4**

PROJ: 22124
SCALE: NOTED
DRAWN: KB
DATE: 260105



ISSUE/REV.
00


AD
684

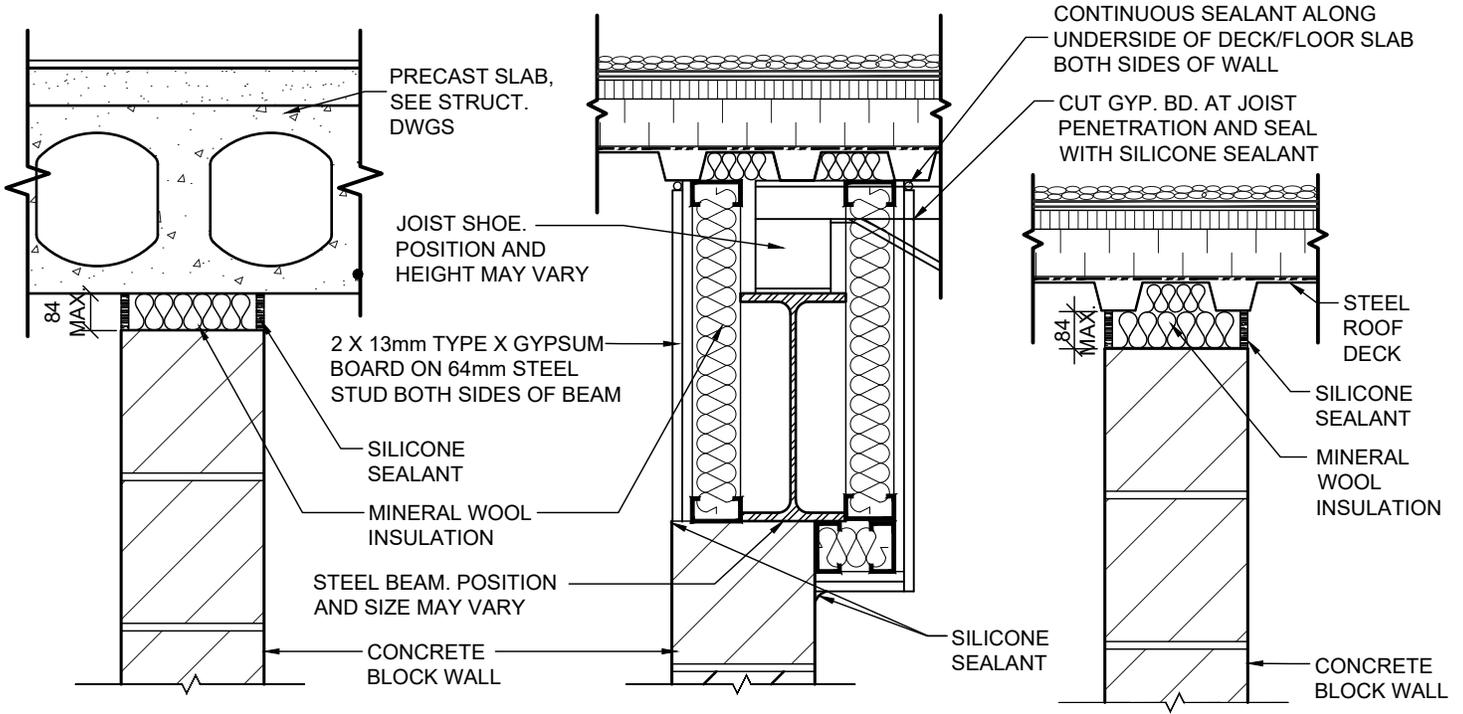

CONDITION AT FLOOR

CONDITION AT OFFSET BEAM / JOIST AT ROOF

CONDITION AT ROOF

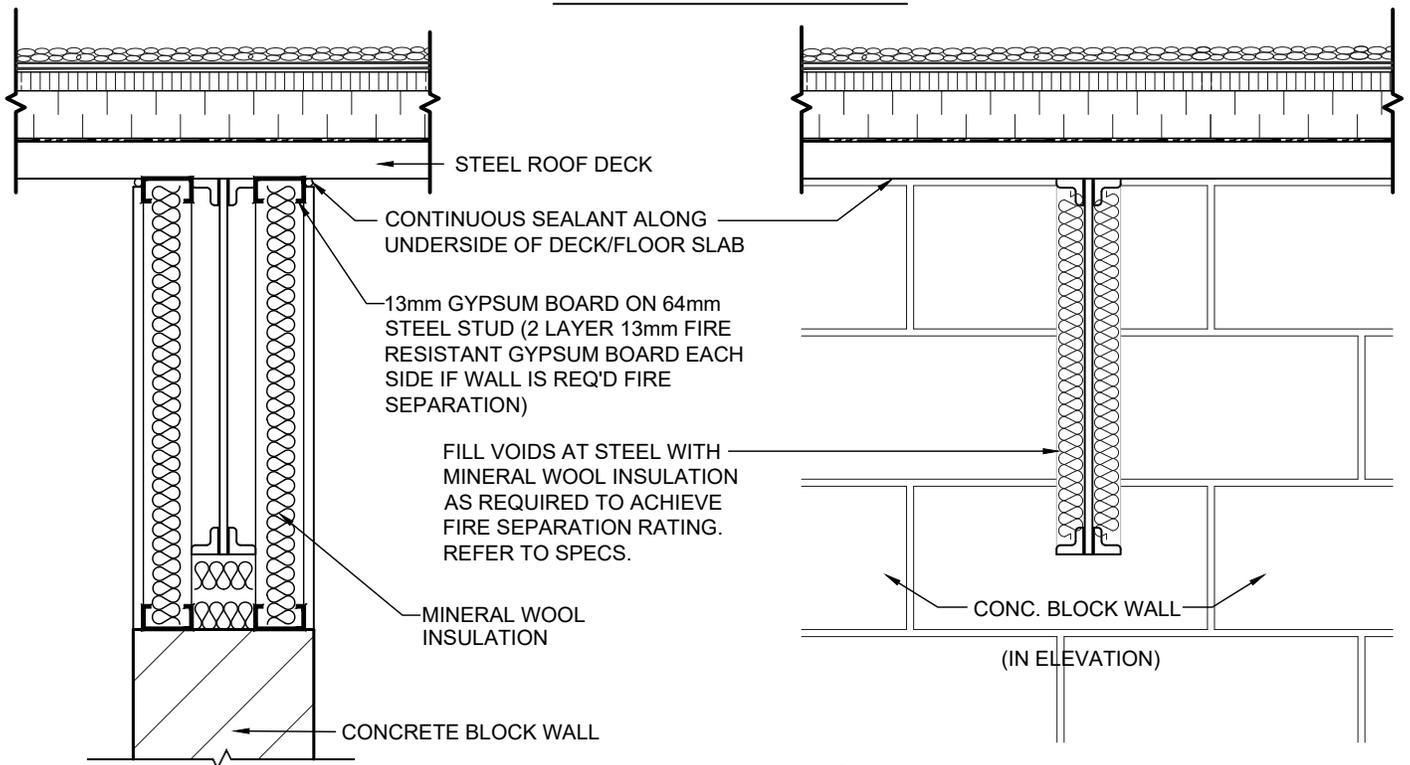

CONDITION AT PARALLEL JOIST OR BEAM

NOTE: ADJUST STEEL STUD SIZES TO SUIT BLOCK WALL CONDITION. MIN. 64mm STUD AT MAX. 400 O.C. REF. SPECS FOR FIRE-RATED SEALANTS

CONDITION AT PERPENDICULAR JOIST OR BEAM

TOP OF WALL CONSTRUCTION AT FIRE SEPARATION ASSEMBLY

PROJ: 22124

SCALE: 1:5

DRAWN: CC


DATE: 260105

HOSSACK ARCHITECTURE



ISSUE/REV. 00


AD 725

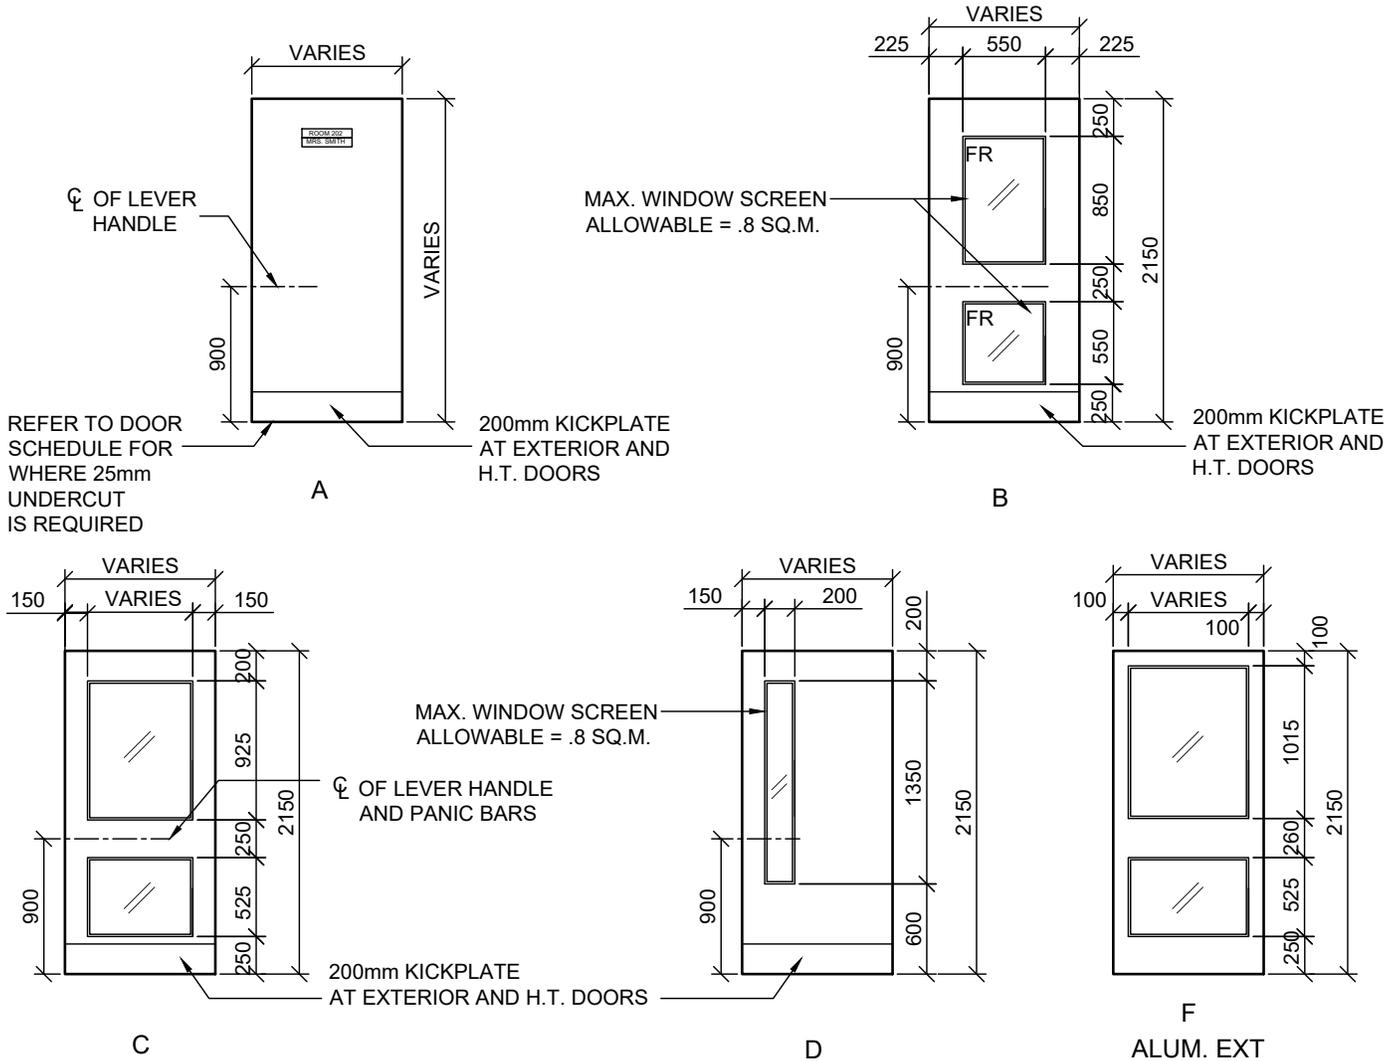

C **D** **F**
ALUM. EXT

NOTES:

1. GLAZING TO BE:
FIRE RATED GLASS AT FIRE RATED DOORS - REFER TO SPECIFICATIONS. 6mm TEMPERED PLATE GLASS AT NON-FIRE RATED DOORS.
2. ALL DOORS AND FRAMES ARE VIEWED FROM EXTERIOR OF ROOM OR AREA SERVED
3. REFER TO DOOR SCHEDULE FOR SOLID CORE WOOD DOORS W/PLASTIC LAMINATE FINISH OR HOLLOW METAL
4. EXTERIOR EXIT DOORS AND HEAVY TRAFFIC DOORS TO HAVE PIANO HINGES. SEE HARDWARE SCHEDULE
5. CL FOR HANDLE LEVERS ARE **ALWAYS** AT 900mm, PANIC BAR CL MAY DIFFER IN HEIGHT UNLESS THERE IS NO HANDLE, THEN PANIC BAR IS AT 900mm.

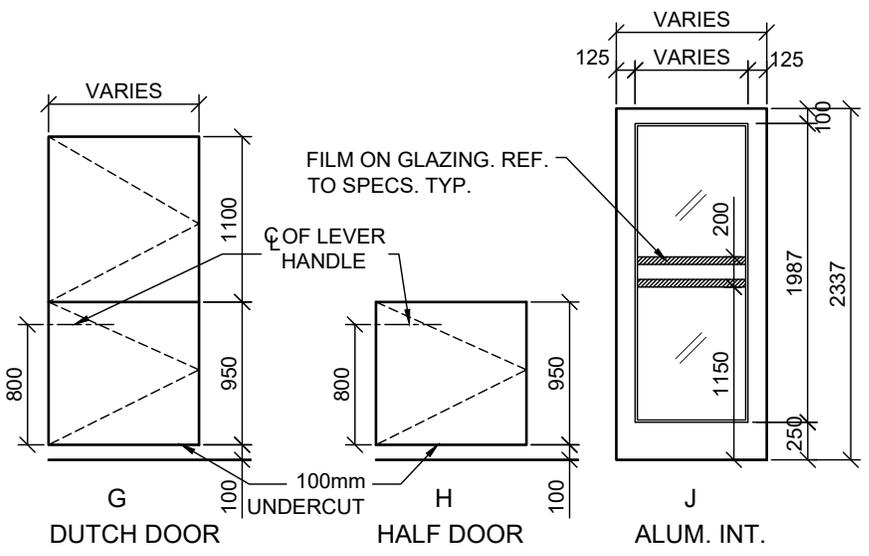


G **H** **J**
DUTCH DOOR HALF DOOR ALUM. INT.

DOOR TYPES


| | |
|--------|--------|
| PROJ: | 22124 |
| SCALE: | 1:50 |
| DRAWN: | AM/KB |
| DATE: | 260105 |




| | |
|------------|-----|
| ISSUE/REV. | 00 |
| AD | 800 |

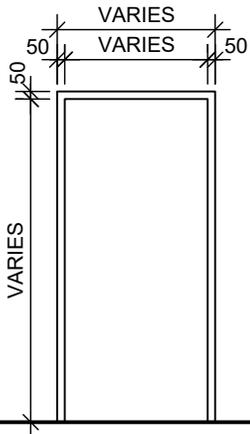

TYPE 1
H.M. INT/EXT

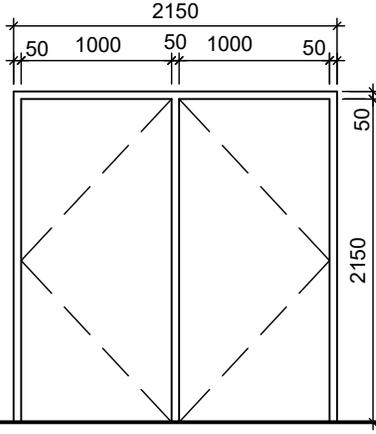


TYPE 2
H.M./ALUM.
INT/EXT

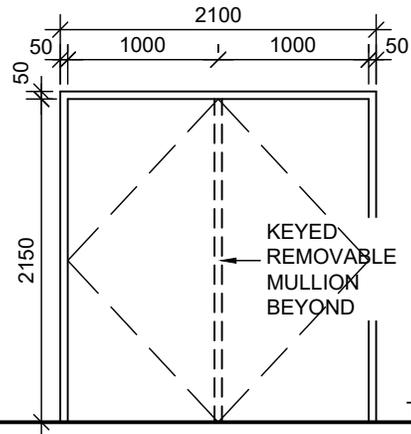

TYPE 3
H.M. INT/EXT.


TOP OF FIN. FLOOR

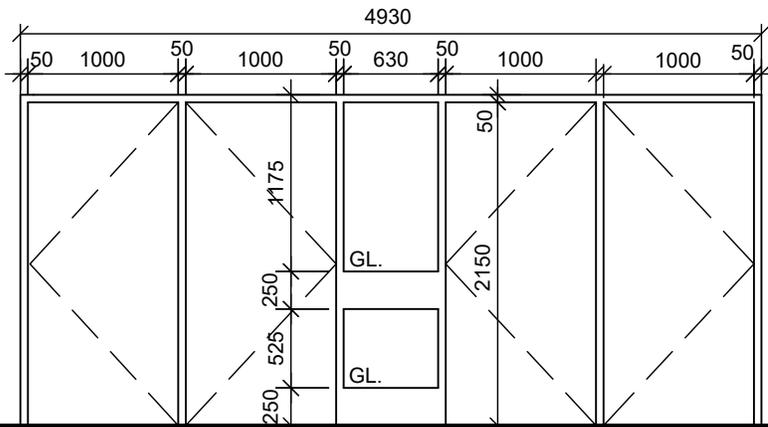


TYPE 4
H.M. INT

NOTE: REFER TO FIRE SEPARATION PLANS
FOR LOCATIONS OF FIRE RATED GLASS.


TOP OF FIN. FLOOR

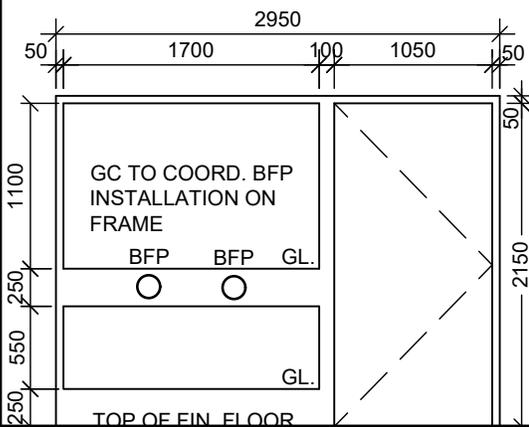

TYPE 5
H.M. INT

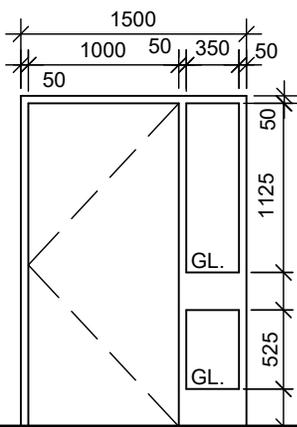

TYPE 6
H.M. EXT/INT

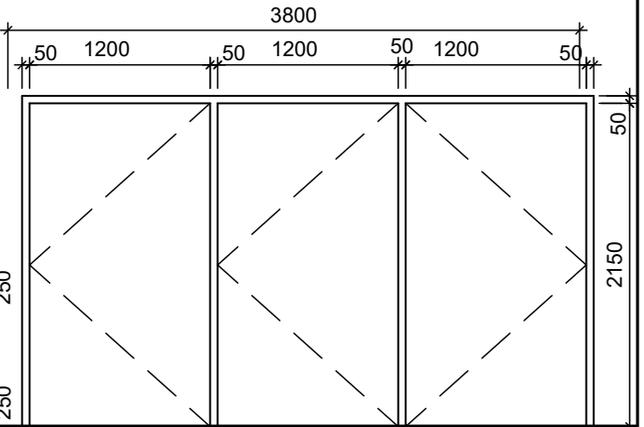

TYPE 7
H.M. INT


HOLLOW METAL FRAMES

PROJ: 22124
SCALE: 1:50
DRAWN: RS
DATE: 260105



ISSUE/REV.
00



AD
801A

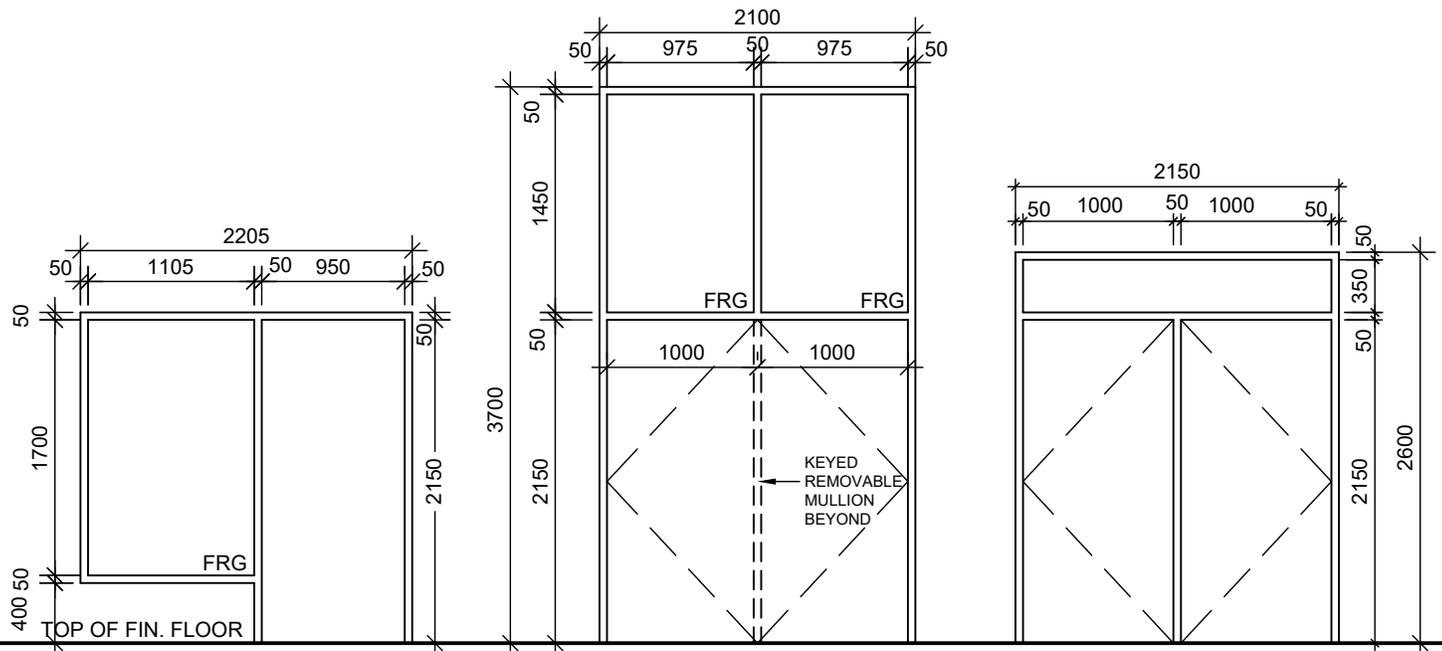

TYPE 8
H.M. INT


TYPE 9
H.M. INT

TYPE 10
H.M. EXT
1890

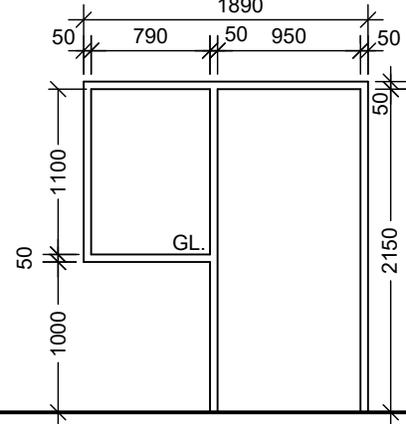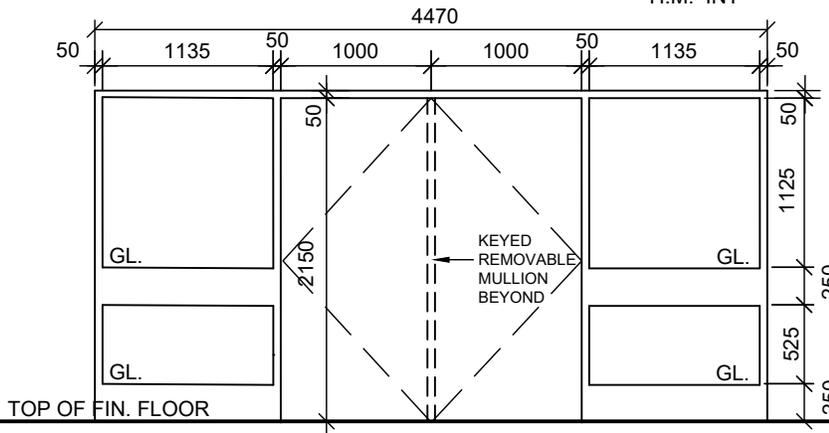

TYPE 11
H.M. INT

TYPE 12
H.M. INT

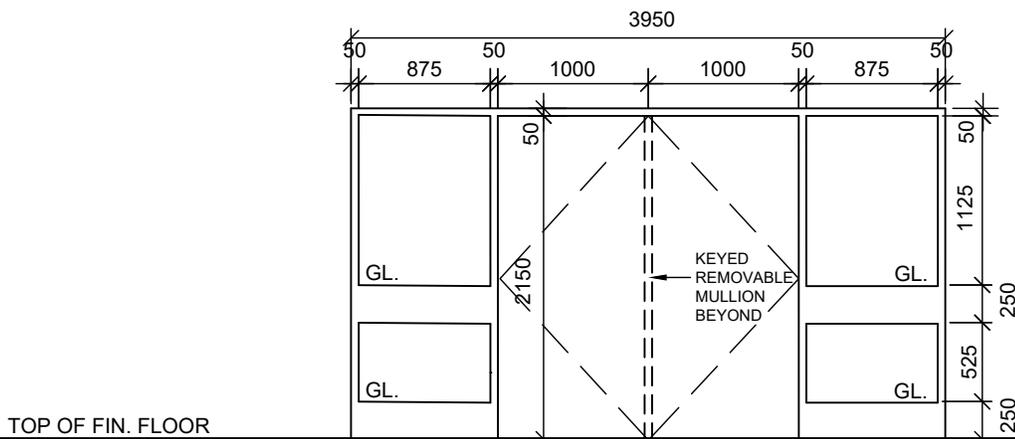

TYPE 13
H.M. INT


HOLLOW METAL FRAMES

PROJ: 22124
SCALE: 1:50
DRAWN: RS
DATE: 260105




ISSUE/REV.
00

AD
801B

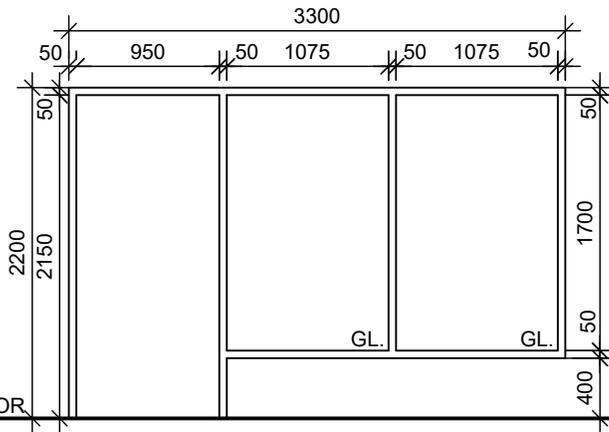

TYPE 14
H.M. INT

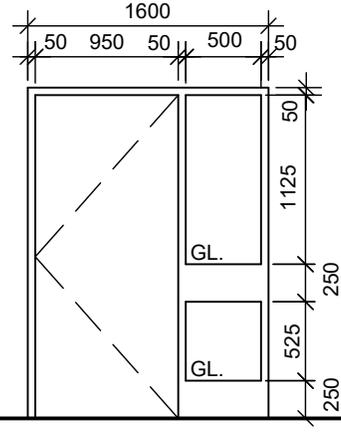

TYPE 15
H.M. EXT/INT

TOP OF FIN. FLOOR

TOP OF FIN. FLOOR


HOLLOW METAL FRAMES

PROJ: 22124
SCALE: 1:50
DRAWN: RS
DATE: 260105



ISSUE/REV.
00



AD
801C

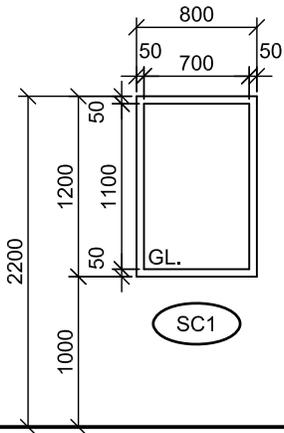



NOT USED

SC2

TOP OF FIN. FLOOR

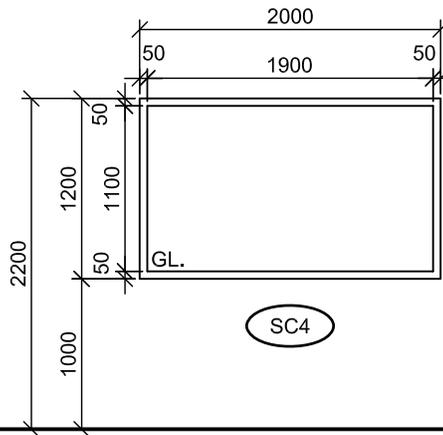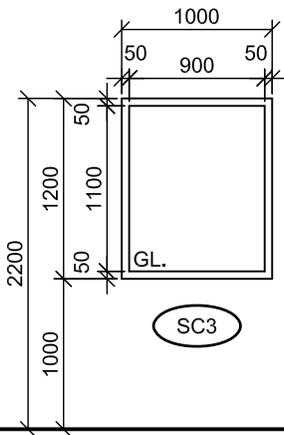

TOP OF FIN. FLOOR

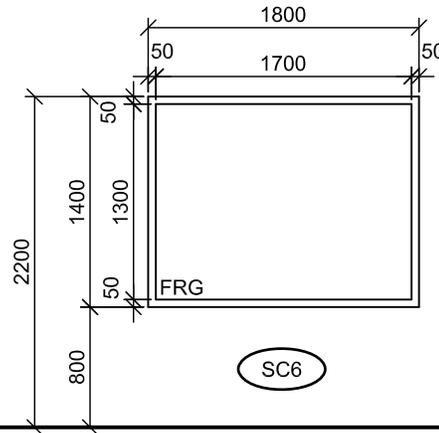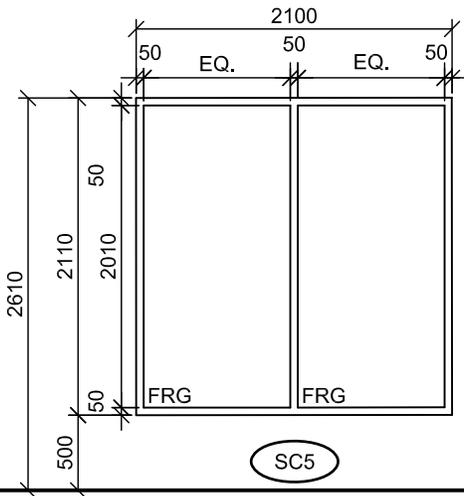

NOTE: REFER TO FIRE SEPARATION PLANS FOR REQUIRED FIRE RESISTANCE RATING AND LOCATIONS OF FIRE RATED GLASS .

TOP OF FIN. FLOOR

HOLLOW METAL SCREENS

PROJ: 22124

SCALE: 1:50


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ISSUE/REV.
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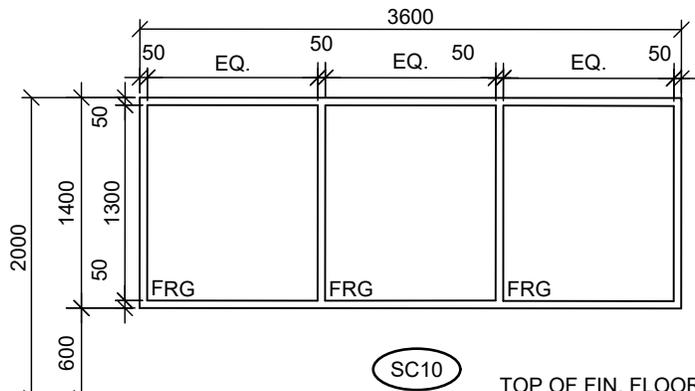
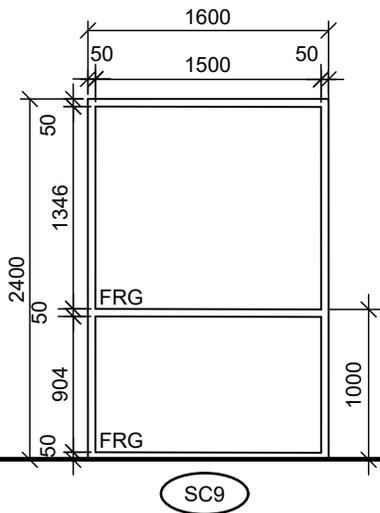
AD
801D



NOT USED

SC8

TOP OF FIN. FLOOR

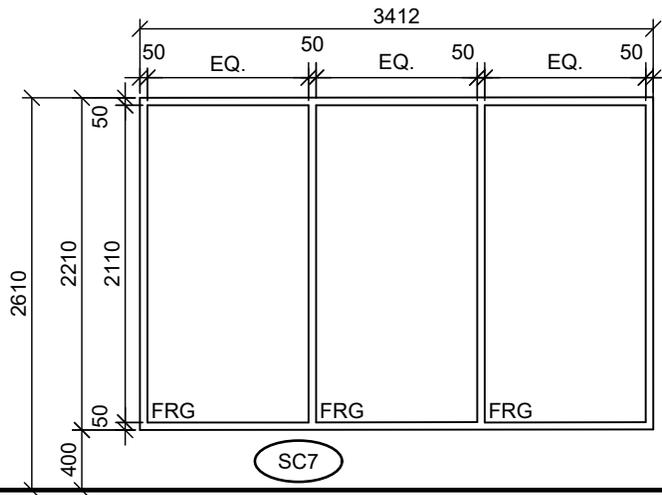

TOP OF FIN. FLOOR

NOTE: REFER TO FIRE SEPARATION PLANS FOR REQUIRED FIRE RESISTANCE RATING AND LOCATIONS OF FIRE RATED GLASS .

HOLLOW METAL SCREENS

PROJ: 22124

SCALE: 1:50


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DATE: 260105




ISSUE/REV.
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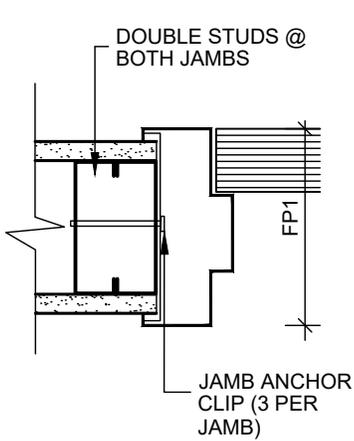
AD
801E




FRAME PROFILE FP1
METAL FRAME SECTION (MASONRY WALLS)
(NTS)

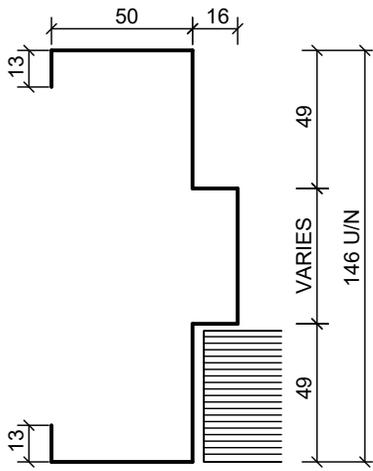

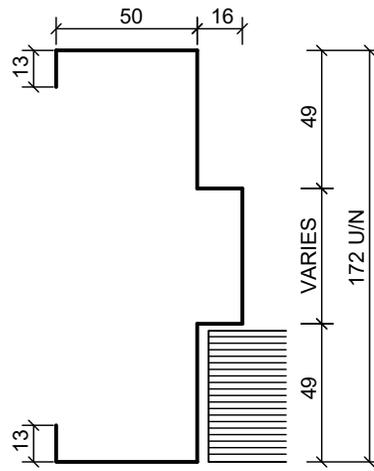
FRAME PROFILE FP2
METAL FRAME SECTION (MASONRY WALLS)
(NTS)




J1 (NTS)

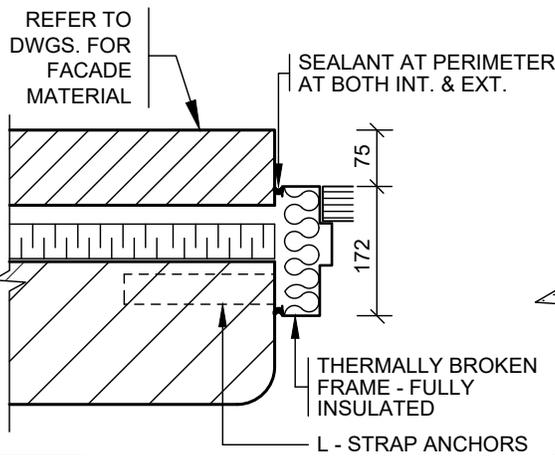


MF1 (NTS)

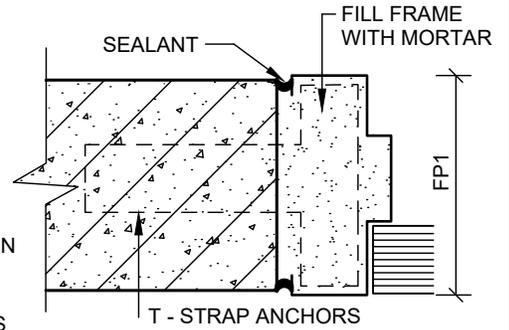

MF2 (NTS)

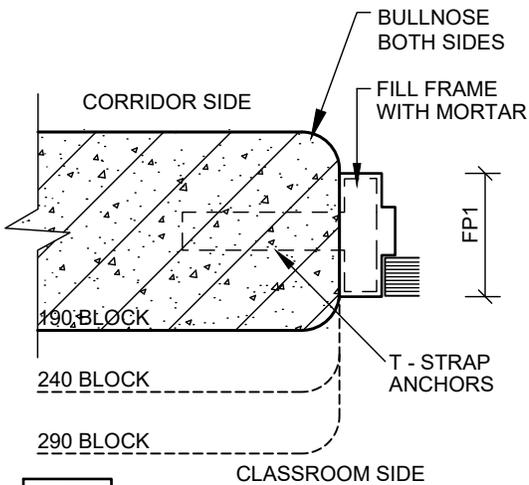

MF3 (NTS)

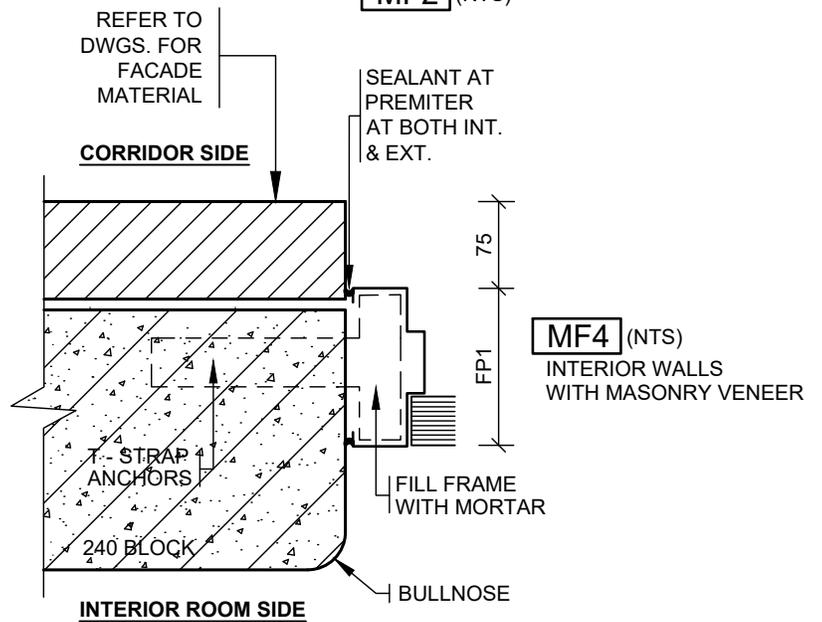

MF4 (NTS)
INTERIOR WALLS
WITH MASONRY VENEER


DOOR JAMB SECTIONS

PROJ: 22124
SCALE: NTS
DRAWN: KB
DATE: 260105




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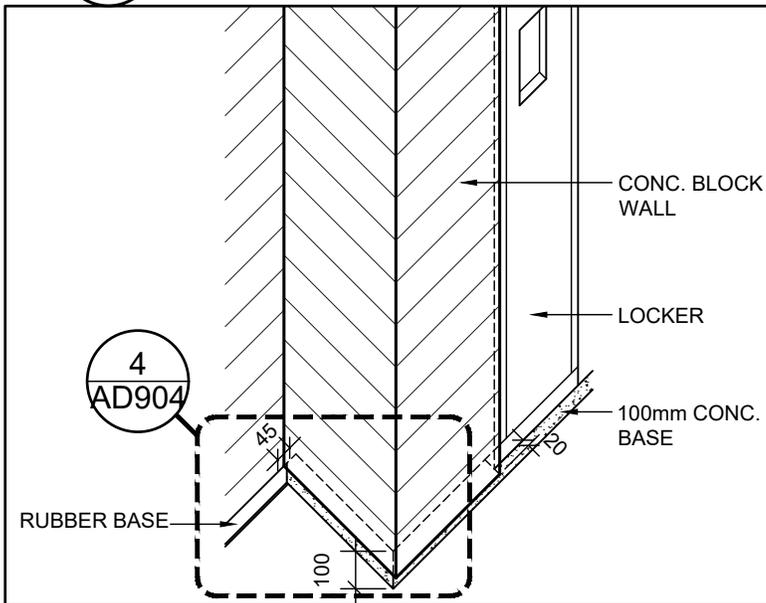
AD
802

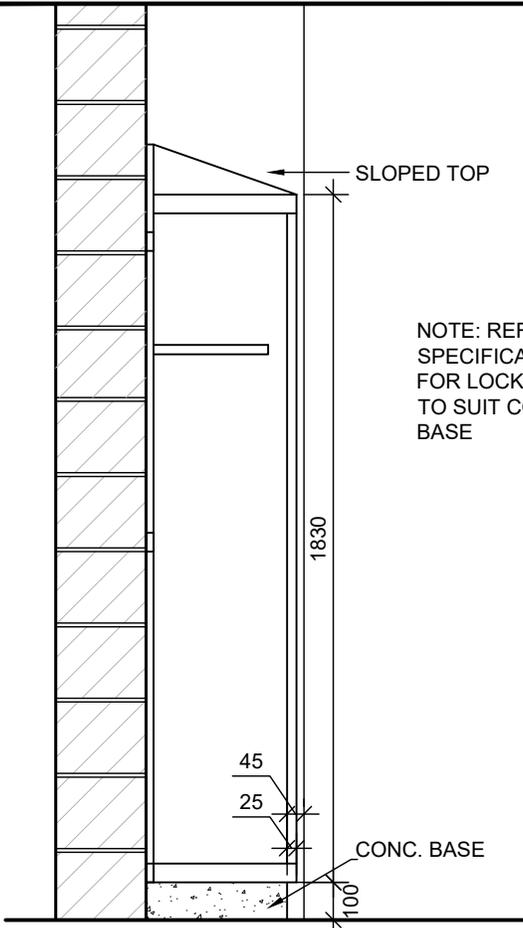


1 LOCKER SECTION
AD904 SCALE 1:20

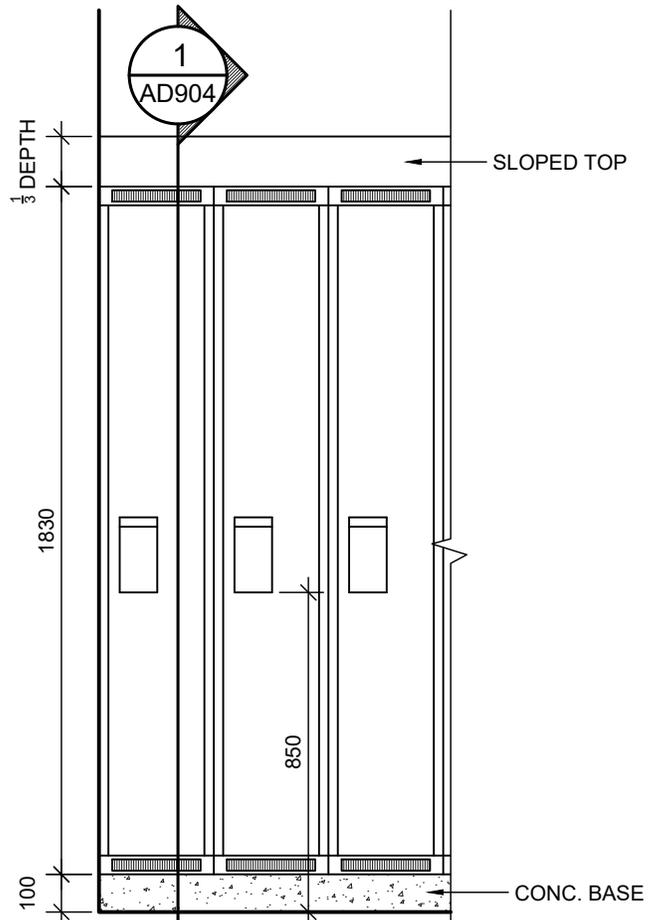

2 LOCKER ELEVATION
AD904 SCALE 1:20



3 LOCKER ISOMETRIC
AD904

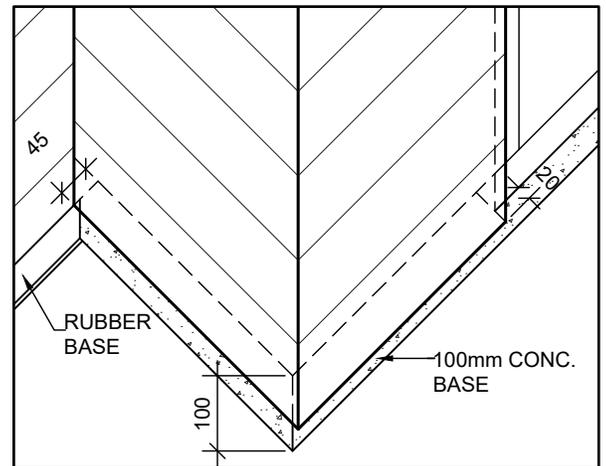

4 LOCKER BASE ISOMETRIC
AD904

LOCKER BASE DETAILS

PROJ: 22124
SCALE: 1:20
DRAWN: GB
DATE: 260105



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