


POWER DISTRIBUTION AND SMALL POWER	
	DUPLEX RECEPTACLE, WALL MOUNTED
	DUPLEX RECEPTACLE, ABOVE BACKSPLASH OF CABINET, COUNTERTOP OR SINK
	DUPLEX RECEPTACLE, FLUSH MTD IN CEILING
	HALF SWITCHED DUPLEX RECEPTACLE, WALL MOUNTED
	SPECIAL PURPOSE RECEPTACLE, WALL MOUNTED NEMA CONFIGURATION AS NOTED ON PLANS
	SHADING REPRESENTS RECEPTACLE ON LIFE SAFETY BRANCH
	SHADING REPRESENTS RECEPTACLE ON UPS BRANCH
	SHADING REPRESENTS RECEPTACLE WITH ISOLATED GROUND
	DISCONNECT SWITCH, REFER TO EQUIPMENT CONNECTION SCHEDULE FOR DISCONNECT TYPE, ION
	COMBINATION MOTOR STARTER DISCONNECT
	MOTOR STARTER
	VARIABLE FREQUENCY DRIVE
	DIRECT CONNECTION, WALL MOUNTED, SUBSCRIPT 'X' INDICATES UNIQUE IDENTIFIER, REFER TO EQUIPMENT CONNECTION SCHEDULE
	DIRECT CONNECTION, CEILING MOUNTED, SUBSCRIPT 'X' INDICATES UNIQUE IDENTIFIER, REFER TO EQUIPMENT CONNECTION SCHEDULE
	MOTOR, SUBSCRIPT 'X' DENOTES MOTOR DESIGNATION, REFER TO EQUIPMENT CONNECTION SCHEDULE
	GROUND BUS BAR
	FURNITURE OUTLET, WALL MOUNTED
	PANELBOARD
	TRANSFORMER
	FLOOR BOX, DUPLEX RECEPTACLE
	FLOOR BOX, DOUBLE DUPLEX RECEPTACLE
	SPECIAL FLOORBOX, "FB1" INDICATES UNIQUE FLOOR BOX TYPE
	X - RECEPTACLE TYPE
	12 - NUMBER INDICATES BRANCH CIRCUIT NUMBER
CIRCUITING	
	CIRCUIT NUMBER
	PANEL DESIGNATION
	CONDUIT SIZE
	GROUND CONDUCTOR QUANTITY AND SIZE
	CIRCUIT CONDUCTOR QUANTITY AND SIZE

LIGHTING, LIGHTING SWITCHING & CONTROLS	
	UPPER CASE LETTERS INDICATE LIGHTING FIXTURE TYPE NUMBER INDICATES CIRCUIT NUMBER, LOWER CASE LETTER INDICATES SWITCHLEG
	LIGHTING FIXTURE ON NORMAL BRANCH POWER - CEILING MOUNTED
	LIGHTING FIXTURE ON NORMAL BRANCH POWER - WALL MOUNTED
	STRIP LIGHTING FIXTURE ON NORMAL BRANCH POWER
	PENDANT LINEAR FIXTURE ON NORMAL BRANCH POWER
	WALL SCONCE LIGHTING FIXTURE ON NORMAL BRANCH POWER - WALL MOUNTED
	EXIT SIGN - SINGLE FACE - CEILING MOUNTED
	EXIT SIGN - SINGLE FACE - WALL MOUNTED
	LOW LEVEL EXIT SIGN - SINGLE FACE - WALL OR DOOR MOUNTED
	DUAL HEAD EMERGENCY LIGHT WITH INTEGRAL BATTERY PACK - WALL MOUNTED
	SINGLE REMOTE EMERGENCY LIGHT - WALL MOUNTED
	DUAL REMOTE EMERGENCY LIGHT - WALL MOUNTED
	SPST SWITCH, WALL MOUNTED. 'X' INDICATES INDIVIDUAL GANGED SWITCHES AND ASSOCIATED SWITCH LEGS CONTROLLED. SUBSCRIPT 'X' INDICATES: 2 - DOUBLE POLE 3 - THREE WAY 4 - FOUR WAY D - WALL BOX DIMMER LV - LOW VOLTAGE P - PILOT LIGHT T - WALL BOX TIMER WP - WEATHER PROOF
	OCUPANCY SENSOR, WALL MOUNTED - LEGRAND WATTSTOPPER DSW-301

DRAWING LIST	
DWG No.	DRAWING TITLE
E0.0	ELECTRICAL LEGEND, DRAWING LIST AND KEY PLAN
E1.0	PARTIAL FLOOR PLAN - UNIVERSAL WASHROOM - DEMOLITION PLANS
E1.1	PARTIAL FLOOR PLAN - BOILER ROOM - MECHANICAL - DEMOLITION PLAN
E2.0	PARTIAL FLOOR PLAN - UNIVERSAL WASHROOM - NEW PLANS
E2.1	PARTIAL FLOOR PLAN - BOILER ROOM - MECHANICAL - NEW PLAN
E3.0	ENTRANCE - LIGHTING, POWER & SYSTEMS DEMOLITION & PROPOSED PLAN
E4.0	CANOPY LIGHTING PLAN & DETAILS

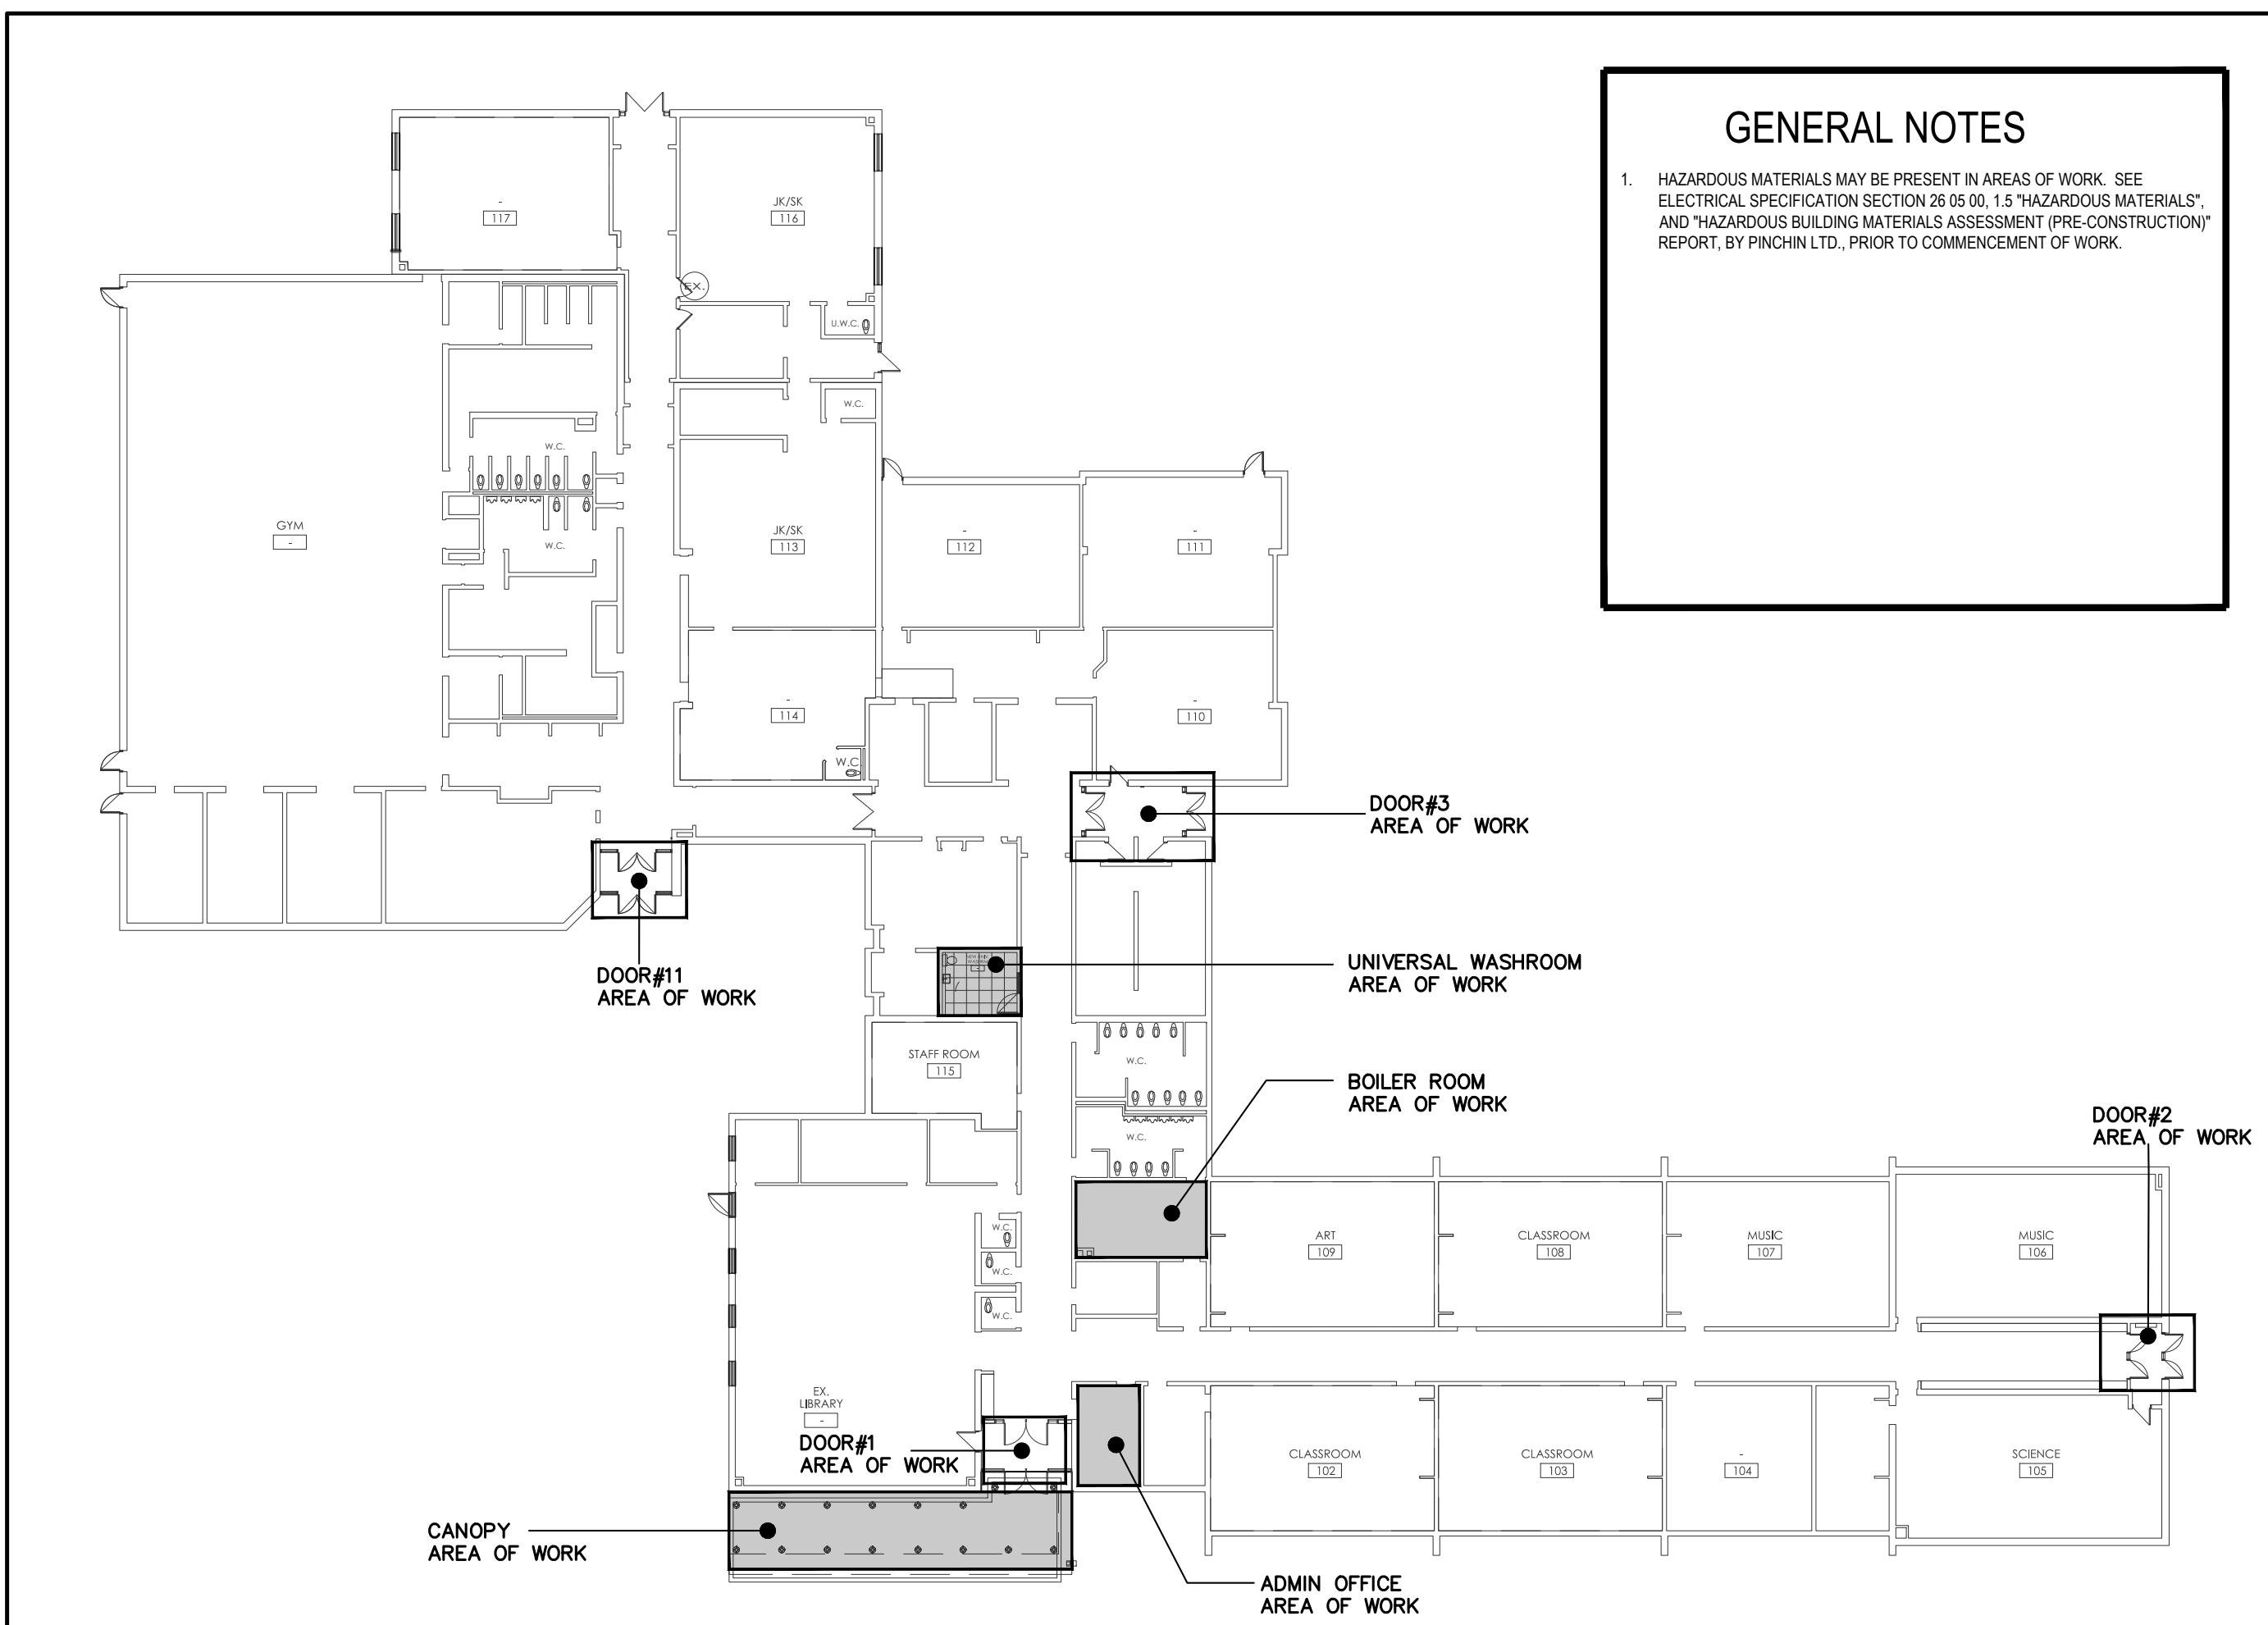

GENERAL NOTES

1. HAZARDOUS MATERIALS MAY BE PRESENT IN AREAS OF WORK. SEE ELECTRICAL SPECIFICATION SECTION 20.00, 1.3 "HAZARDOUS MATERIALS", AND 1.4 HAZARDOUS BUILDING MATERIALS ASSESSMENT (PRE-CONSTRUCTION) REPORT, BY PINCHIN LTD., PRIOR TO COMMENCEMENT OF WORK.

TELECOMMUNICATIONS SYSTEM	
	WALL MOUNT VOICE OUTLET
	WALL MOUNT DATA OUTLET
	WALL MOUNT DATA/VOICE OUTLET
	CEILING MOUNT VOICE OUTLET
	CEILING MOUNT DATA OUTLET
	CEILING MOUNT DATA/VOICE OUTLET
	NUMBER OF DATA JACKS NUMBER OF VOICE JACKS
NO SUBSCRIPT = (1) DATA/VOICE	
MOUNTING:	OUTLET MOUNTING HEIGHTS TO BE COORDINATED WITH INTERIOR DESIGNER DURING DD PHASE
FIRE ALARM SYSTEM	
	FIRE ALARM STROBE, WALL MOUNTED
	FIRE ALARM HORN, WALL MOUNTED
	FIRE ALARM CONTROL PANEL
	FIRE ALARM REMOTE ANNOUNCER PANEL
	HEAT DETECTOR, CEILING MOUNTED




PUBLIC ADDRESS SYSTEM	
DEVICE LEGEND	DEVICE TAG → AAA → M → MOUNTING TAG
ALL PUBLIC ADDRESS SYSTEM DEVICES ARE WALL MOUNTED UNLESS OTHERWISE INDICATED BY MOUNTING TAG	
	PAGING SPEAKERS OR HORN
	PAGING STATION

DEMOLITION	
	EXISTING TO BE REMOVED
	EXISTING TO BE RELOCATED
	EXISTING TO REMAIN
	EXISTING - NEW LOCATION
	DEMOLITION CONDUIT
	EXISTING TO REMAIN CONDUIT
	RELOCATED / NEW CONDUIT
	RELOCATED / NEW EQUIPMENT

SECURITY SYSTEM	
DEVICE LEGEND	DEVICE TAG → AAA → M → MOUNTING TAG → Secondary Attribute
ALL SECURITY SYSTEM DEVICES ARE WALL MOUNTED UNLESS OTHERWISE INDICATED BY MOUNTING TAG	
	ELECTRIC STRIKE
	PUSH PLATE
	INTERCOM
	PUSH BUTTON

TYPE	DESCRIPTION	MODEL NUMBER	MANUFACTURER	LAMP	VOLT	MOUNTING
R1	2 X 2' CFI EVOGRID RECESSED LED FIXTURE	2EVG45L840-2-D-UNV-DIM	SIGNIFY	LED 39W 4500 LUMENS 80CRI, 4000K	120V	RECESSED
R2	2 X 2' CFI FLUXPANEL RECESSED LED FIXTURE NOTE: PART#FMA14 FOR DRYWALL KIT	2FPZ-43L-840-4-DS-UNV	SIGNIFY	LED 30W 4300 LUMENS 80CRI, 4000K	120V	RECESSED
R3	1' X 4' CFI FLUXPANEL RECESSED LED FIXTURE	1FPZ-38L-840-4-DS-UNV	SIGNIFY	LED 30W 3800 LUMENS 80CRI, 4000K	120V	RECESSED
S1	4' LMNE-VL WRAP LED FIXTURE	LMNE-VL-48-LED840K037UNV	LEVITON	LED 26.8W 3700 LUMENS 80CRI, 4000K	120V	SURFACE
S2	SFC SLENDER 3' THIN CANOPY LED FIXTURE	SFC-MR-SW-48-250-NW-G2-UNV	GARDOO	LED 38.6W 4800 LUMENS 70CRI, 4000K	120V	SURFACE
D	4' EASILY LED DOWNLIGHT FIXTURE	Z4RD15940WOWH	SIGNIFY	LED 15W 1500 LUMENS 80CRI, 4000K	120V	RECESSED
E1	REMOTE LED EMERGENCY HEADS 24V 5 WATTS PER HEAD	SINGLE - MQMP1NXL15-SM	LUMACELL	24V CONFIRM ON SITE	120V	SURFACE
W	LITEPAK MID-SIZE LED WALLPACK	LNC3-24-4K-050-3-U-DB-PCU	HUBBELL	LED 21W 3991 LUMENS 80CRI, 4000K	120V	SURFACE
M1	KENDO M RECESSED - STATIC WHITE STRIP LED BFT (FOR MILLWORK)	KRM-96-72S0-41K-C-GS-WH	LUMINII	LED 21W 1770 LUMENS 90+CRI, 4000K	24VDC CLASS 2	RECESSED


REVISIONS	
Description/Date	ISSUED FOR REVIEW
1	ISSUED FOR TENDER SET 02/28/2025/03/31
2	ISSUED FOR PERMIT AND TENDER 02/25/2024/17
3	ISSUED FOR PERMIT AND TENDER 02/25/2024/12/01

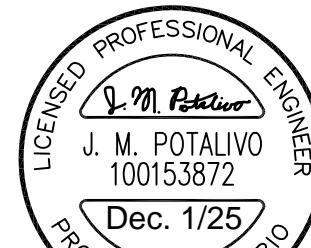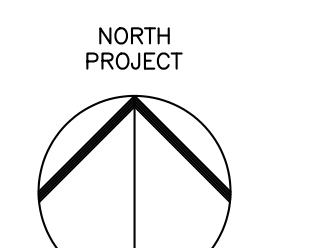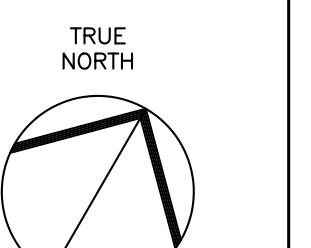

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Project Title:
KILBRIDE PUBLIC SCHOOL
6611 PANTON STREET
KILBRIDE, ONTARIO
Drawing Title:
ELECTRICAL LEGEND, DRAWING LIST AND KEY PLAN

Drawn: AC
Date: FEBRUARY, 2025
Scale: AS NOTED
Project Number: ALL-25001986-A0
This Set Contains Drawing Number: E0.0
Drawings
Revision: 0

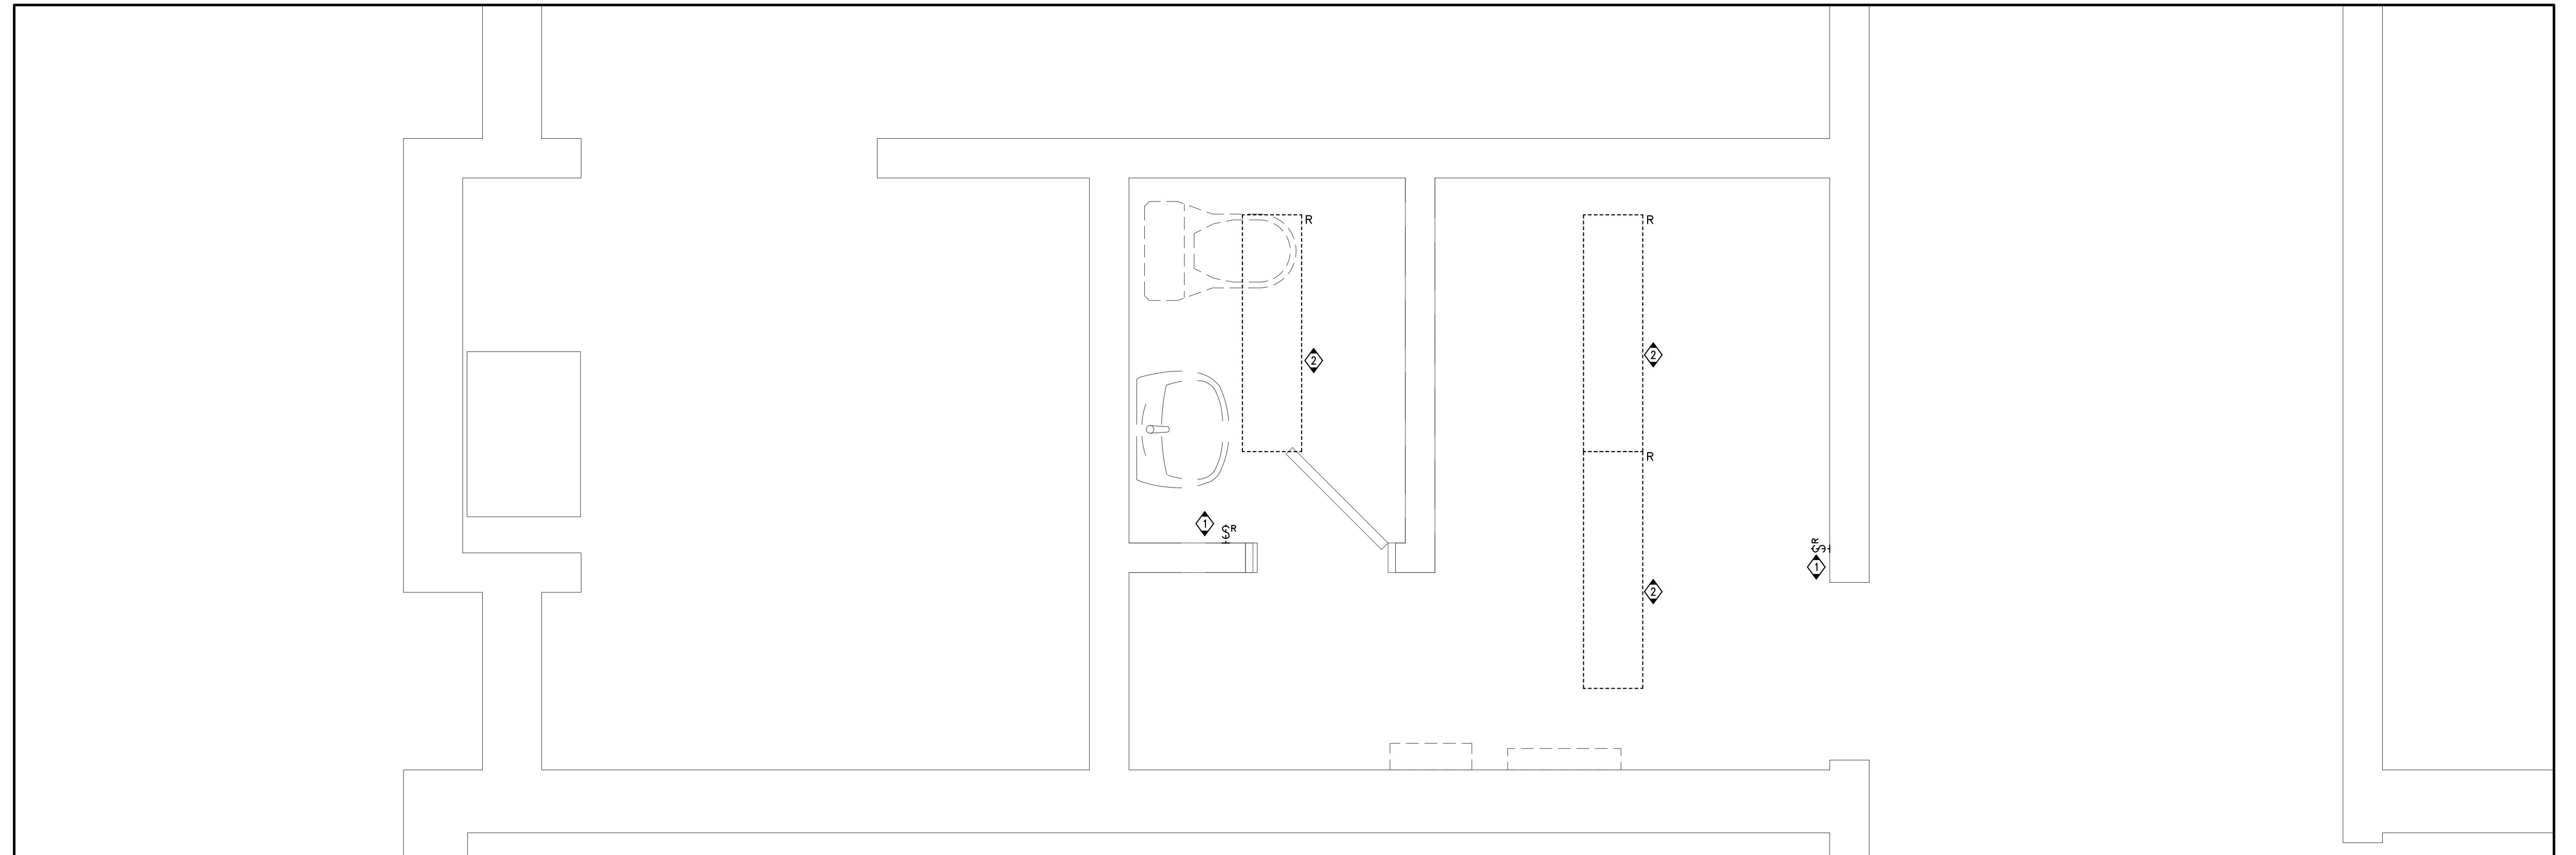

PARTIAL FLOOR PLAN – UNIVERSAL WASHROOM – LIGHTING – DEMOLITION PLAN


SCALE – 1:20
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DRAWING NOTES

- ① DISCONNECT AND REMOVE EXISTING LIGHT SWITCHES AND CONTROLS. PROTECT EXISTING CIRCUIT FOR RE-USE.
- ② DISCONNECT AND REMOVE EXISTING FIXTURES. PROTECT EXISTING CIRCUIT FOR RE-USE. REFER TO DRAWING E2.0 FOR NEW FIXTURE LOCATION.

GENERAL NOTES

1. THE ELECTRICAL CONTRACTOR SHALL, AS PART OF HIS WORK, PERFORM ALL RELATED DEMOLITION, MODIFICATIONS, RELOCATION OF ELECTRICAL DISTRIBUTION AND OTHER EQUIPMENT AND RELATED WORK, INCLUDING NEW WORK NECESSARY TO COMPLETE THE PROJECT.
2. THE ELECTRICAL CONTRACTOR SHALL VERIFY ALL FIELD CONDITIONS AND DIMENSIONS PRIOR TO SUBMITTING BIDS. REFER TO EXISTING DRAWINGS AND VISIT THE SITE TO DETERMINE THE EXTENT OF THE DEMOLITION AND NEW WORK REQUIRED.
3. LIGHTING FIXTURES: REMOVE LIGHTING FIXTURES AND SWITCH CONTROL WHEN THE FIXTURE IS SERVED BY A CIRCUIT THAT SUPPLIES FIXTURES IN OTHER AREAS THAT ARE TO REMAIN, THE ELECTRICAL CONTRACTOR SHALL MAINTAIN THE CONTINUITY OF THE CIRCUIT TO THE REMAINING FIXTURES.

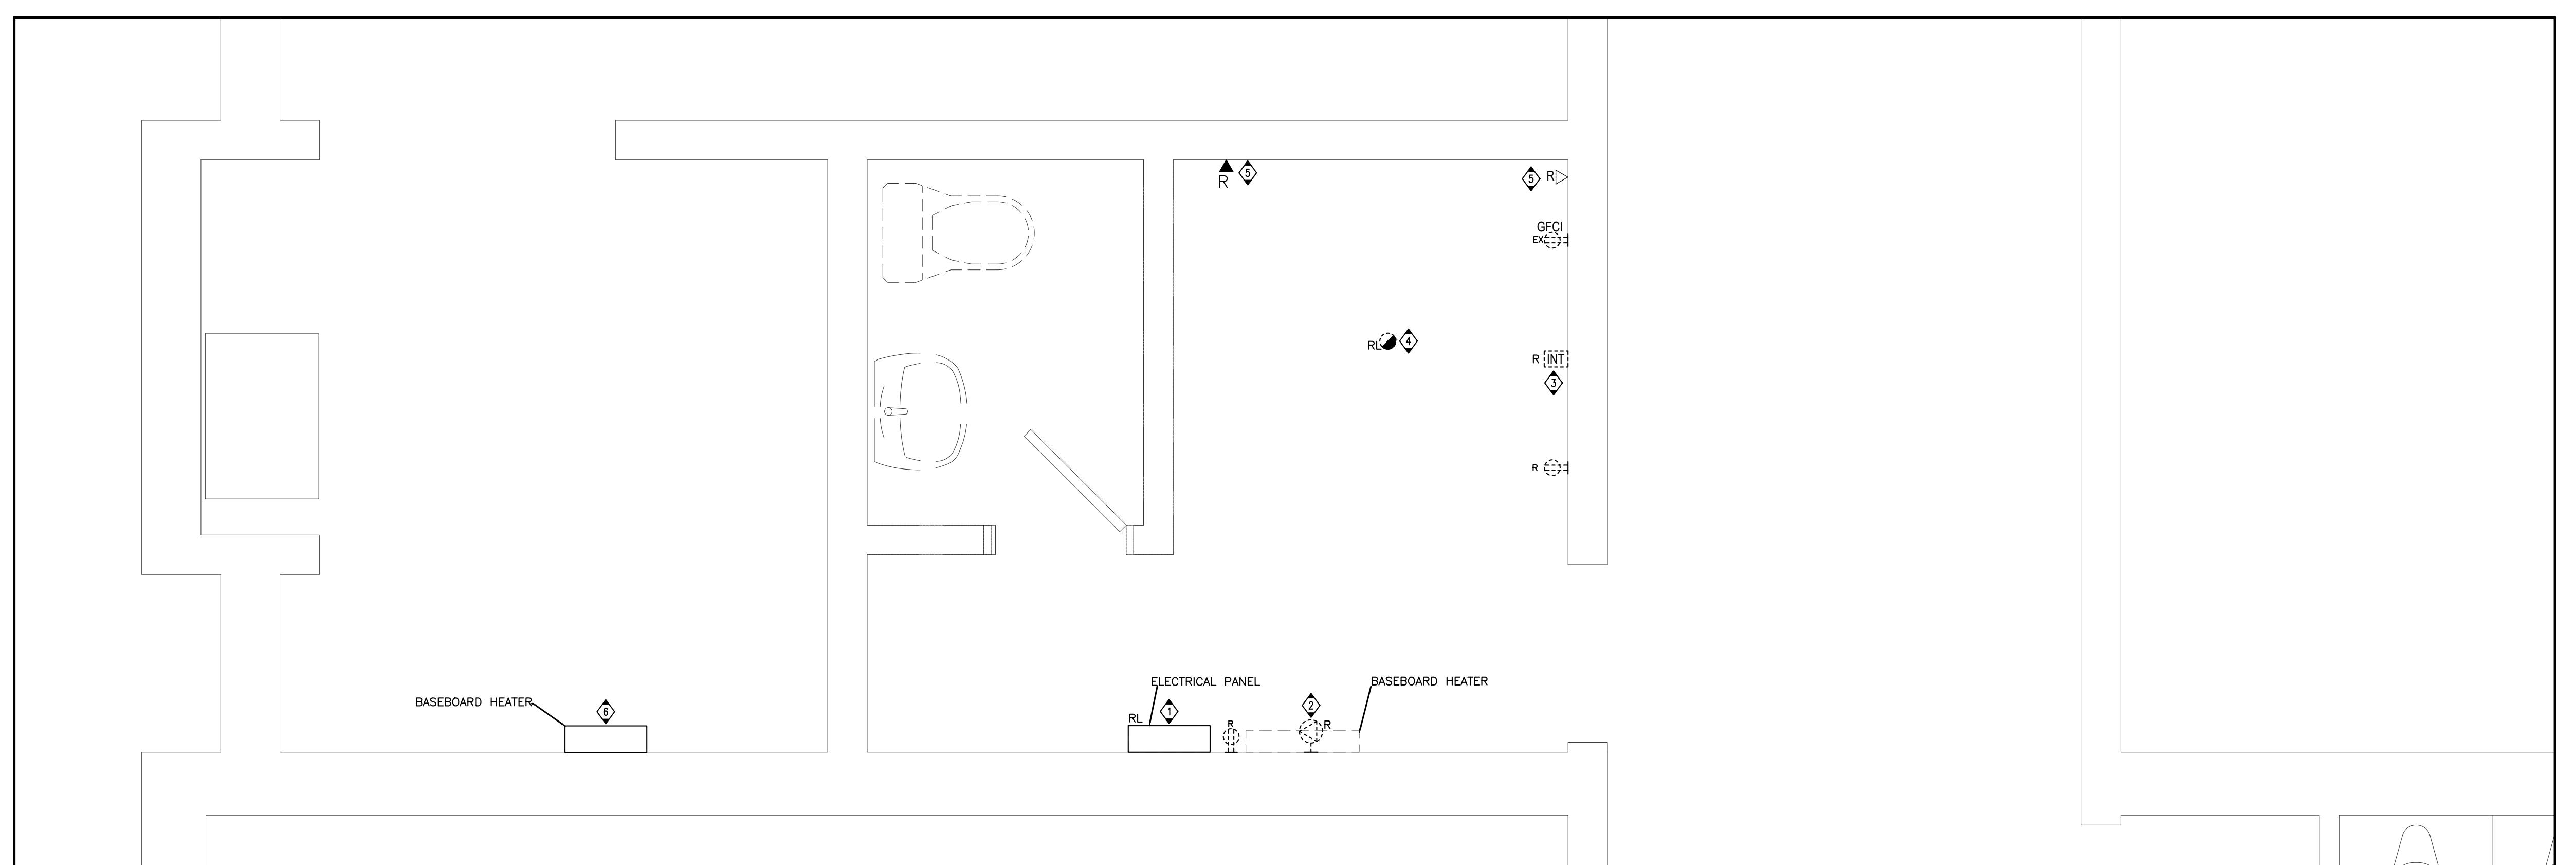

PARTIAL FLOOR PLAN – UNIVERSAL WASHROOM – POWER & SYSTEMS – DEMOLITION PLAN

SCALE – 1:20
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DRAWING NOTES




- ① DISCONNECT FEEDER TO EXISTING ELECTRICAL PANEL AND MAKE SAFE. FOR NEW FEEDER, FEEDER FROM EXISTING PANEL. CIRCUITS WHICH ARE TO BE MAINTAINED FOR BASEBOARD HEATERS CIRCUITS BEING MODIFIED TO SUIT. FOR TENDER PURPOSES, PROVISION FOR RELOCATION OF FEEDER SIZE UP TO 60A, 3-PHASE.
- ② DISCONNECT THE EXISTING ELECTRICAL BASEBOARD HEATER FROM THE SOURCE PANEL AND MAKE IT SAFE FOR REMOVAL. REMOVE ASSOCIATED CONDUIT AND WIRING.
- ③ INTERCOM SYSTEM SCOPE REMOVAL BY HAMILTON VIDEO & SOUND. THIS CONTRACTOR TO REMOVE CONDUIT.
- ④ DISCONNECT AND REMOVE EXISTING HEAT DETECTOR FOR RELOCATION INTO NEW CEILING.
- ⑤ EXISTING COMMUNICATIONS LINE/JACK TO BE REMOVED. INCLUDING BOX AND SURFACE MOUNTED RACEWAY.
- ⑥ EXISTING BASEBOARD HEATER CIRCUIT TO BE REWORKED FOR RELOCATION OF ELECTRICAL PANEL.

GENERAL NOTES

1. ALL WIRING, CABLES AND FEEDERS INCLUDING BOTH CONNECTED TO DEVICES AND EQUIPMENT TO BE DEMOLISHED AND EXISTING THAT ARE ADDED IN PLACE SHALL BE REMOVED BACK TO THEIR SOURCES. UNLESS NOTED OTHERWISE, CONDUIT SHALL BE REMOVED, WHERE NECESSARY, BE RE-CIRCUIT AROUND THE REMOVED PART KEEPING OCCUPIED PARTS OF THE BUILDING SYSTEM IN FULL SERVICE.
2. ALL EXISTING CONDUITS WHICH HAVE BEEN ABANDONED OR ARE UNUSED SHALL BE REMOVED.
3. PROVIDE BLANK METAL COVER PLATES FOR ALL JUNCTION/DEVICE BOXES NO LONGER IN USE THAT ARE EMBEDDED IN FLOOR SLAB OR MASONRY WALLS. PROVIDE PLUGS FOR ALL PANELS WHERE CONDUIT HAS BEEN REMOVED. COVER PLATES SHALL BE PAINTED TO MATCH EXISTING CONDITIONS.
4. POWER RECEPTACLES: REMOVE RECEPTACLES. WHEN THE RECEPTACLE TO BE REMOVED IS SERVED BY A CIRCUIT THAT SUPPLIES RECEPTACLES IN OTHER AREAS, THAT ARE TO REMAIN, THE ELECTRICAL CONTRACTOR SHALL MAINTAIN THE CONTINUITY OF THE CIRCUIT TO THE REMAINING RECEPTACLES.
5. FIRE ALARM SYSTEM: COORDINATE AND CONSULT WITH CURRENT FA SYSTEM CONTRACTOR OR THEIR QUALIFIED REPRESENTATIVE FOR ALL FIRE ALARM DEMOLITION AND MODIFICATIONS. OPERATION SHALL BE MAINTAINED OF EXISTING FIRE ALARM SYSTEM SPECIFICALLY AS IT RELATES TO ADJACENT AREAS WHICH ARE NOT INCLUDED IN THE SCOPE OF THIS PROJECT.

REVISIONS

No.	Description/Date	ISSUED FOR REVIEW	ISSUED FOR TENDER READY	ISSUED FOR PERMIT AND TENDER SET	ISSUED FOR PERMIT AND TENDER	ISSUED FOR PERMIT AND TENDER
1	2025/02/28					
2	2025/03/31					

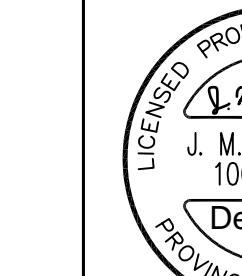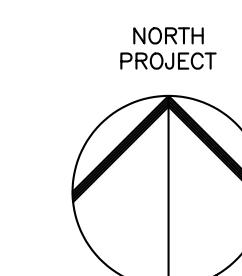
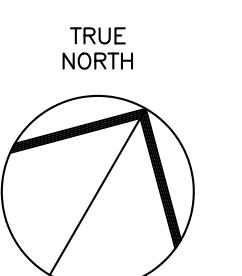


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LICENCED PROFESSIONAL ENGINEER
PROVINCE OF ONTARIO
J. M. POTALIVO
Dec. 1/25
Seal



Project Title:
KILBRIDE PUBLIC SCHOOL
6611 PANTON STREET
KILBRIDE, ONTARIO
Drawing Title:
PARTIAL FLOOR PLAN - BARRIER FREE WASHROOM - DEMOLITION PLANS

Drawn:	AC	Scale:	AS NOTED
Date:	FEBRUARY, 2025	Project Number:	ALL-25001986-A0
Checked:	JP	This Set Contains:	Drawing Number:
Date:	FEBRUARY, 2025	Drawings	E1.0

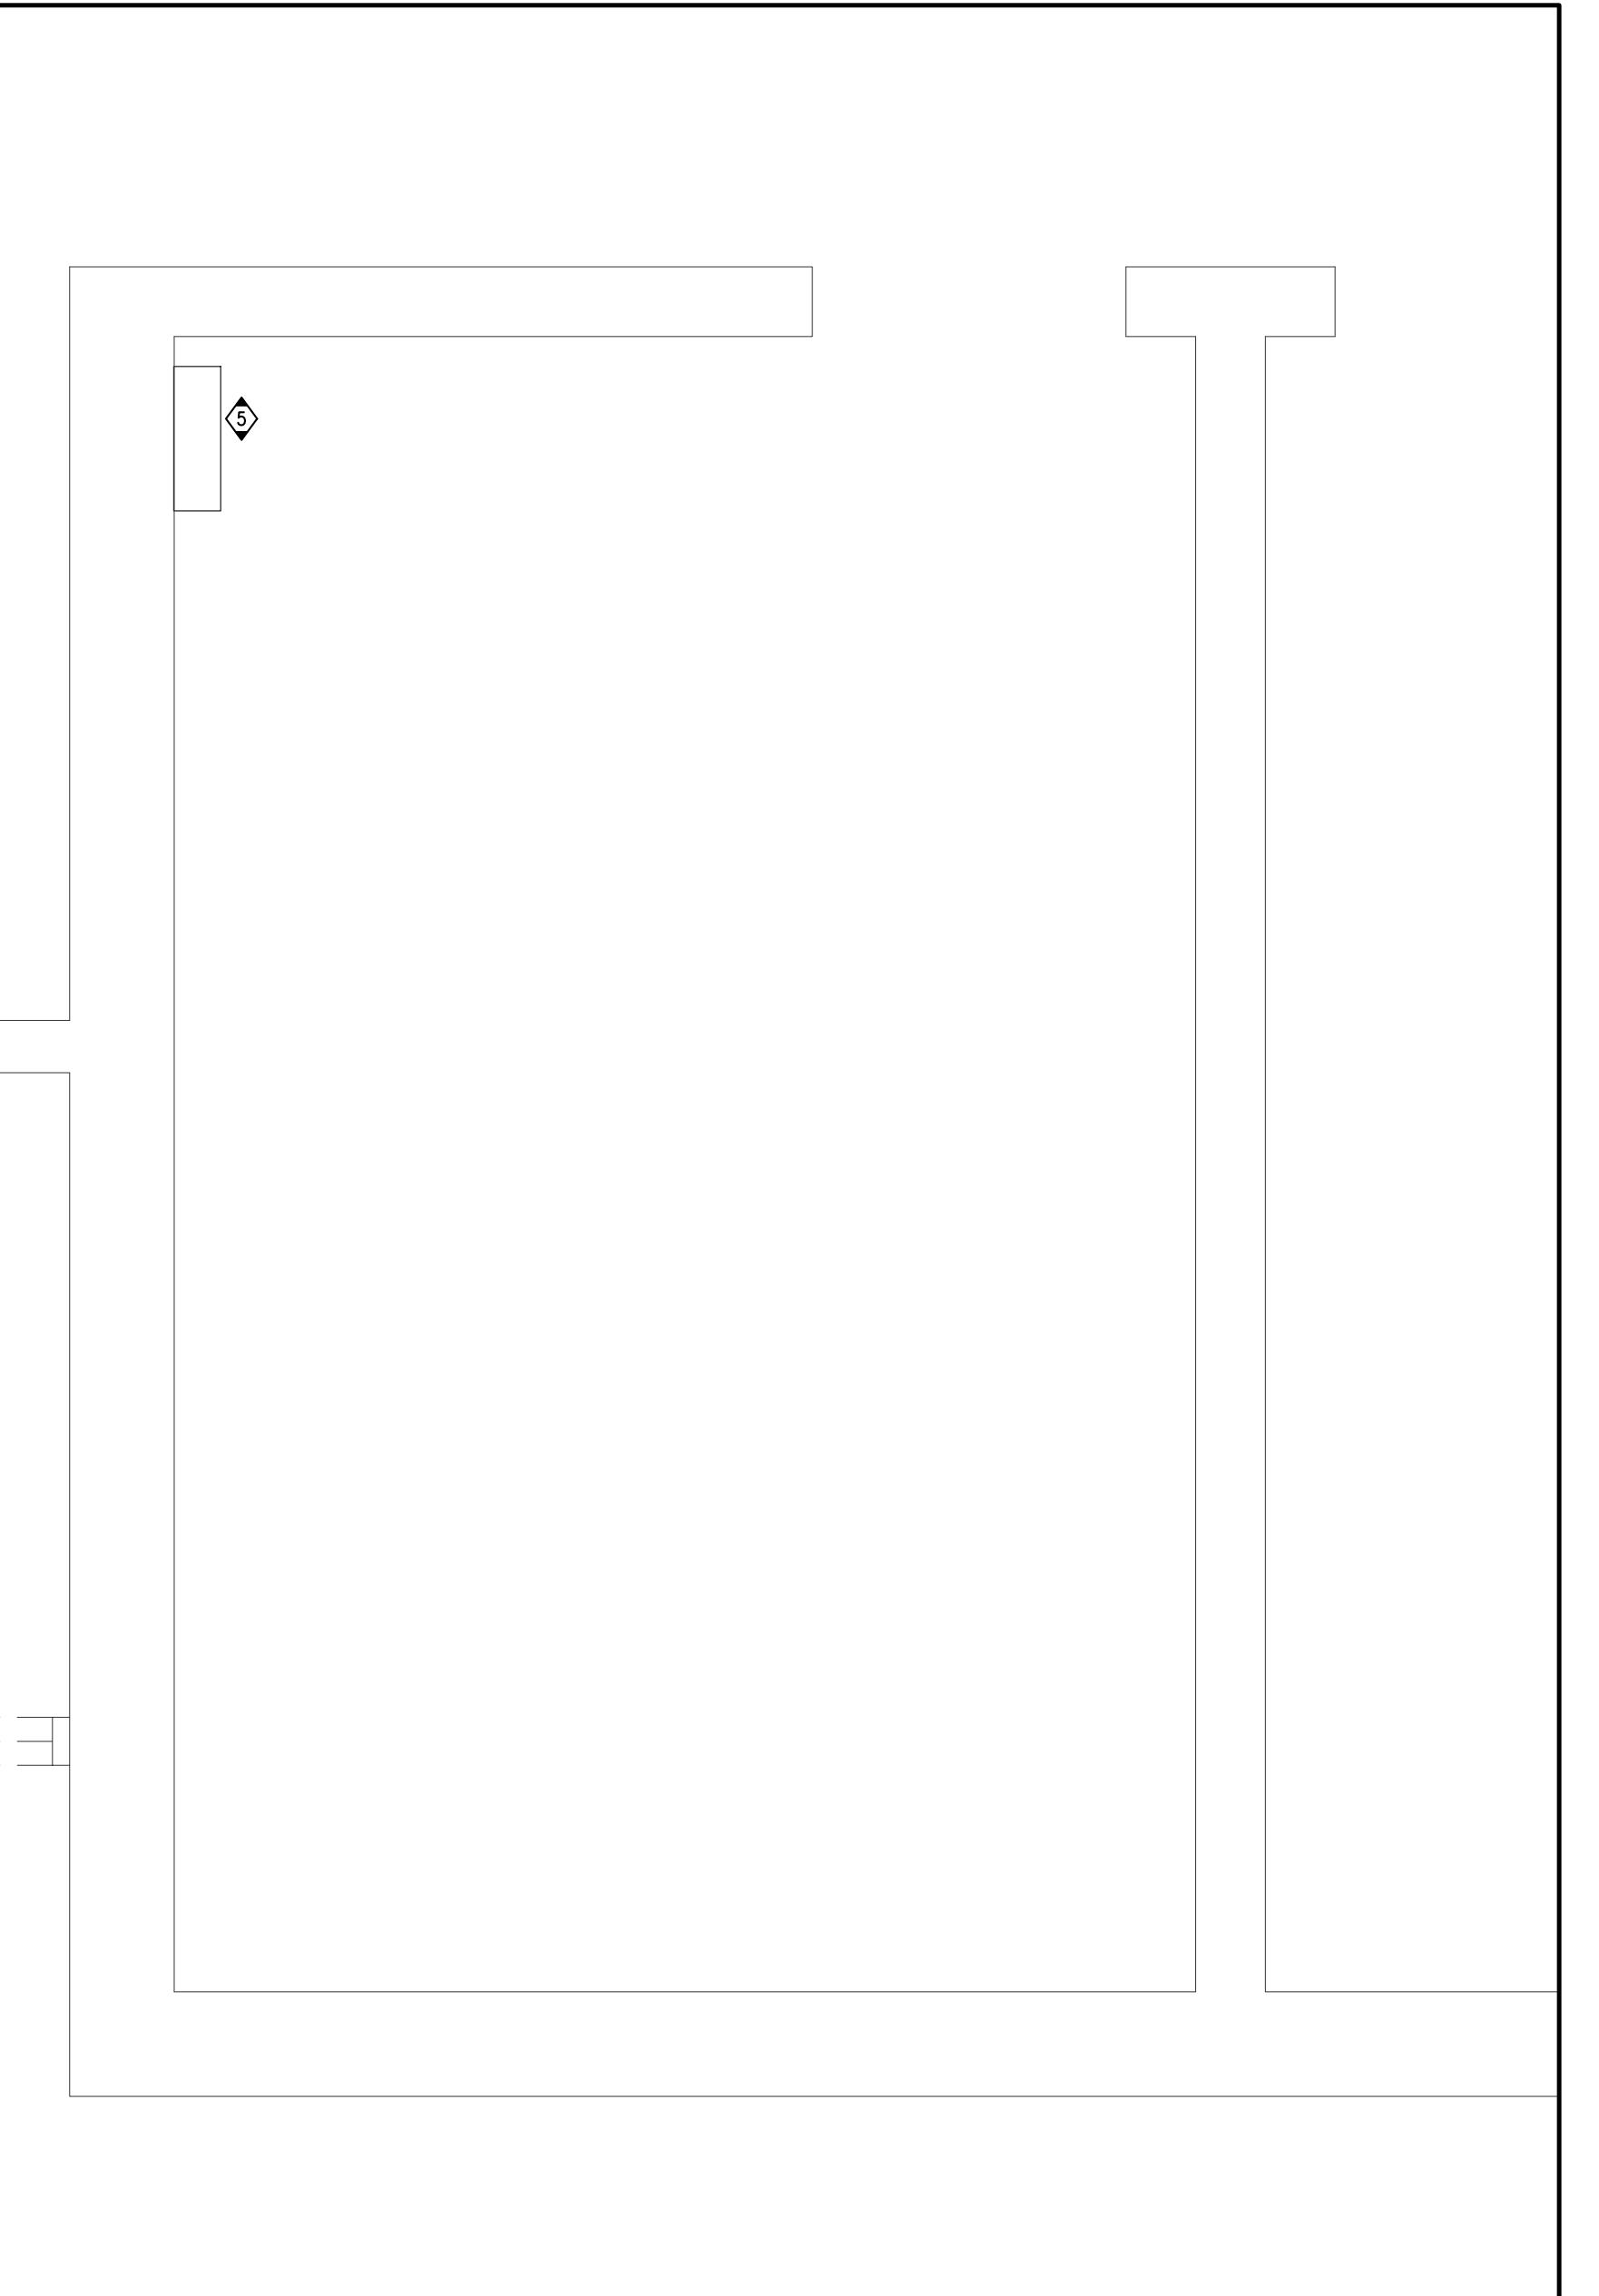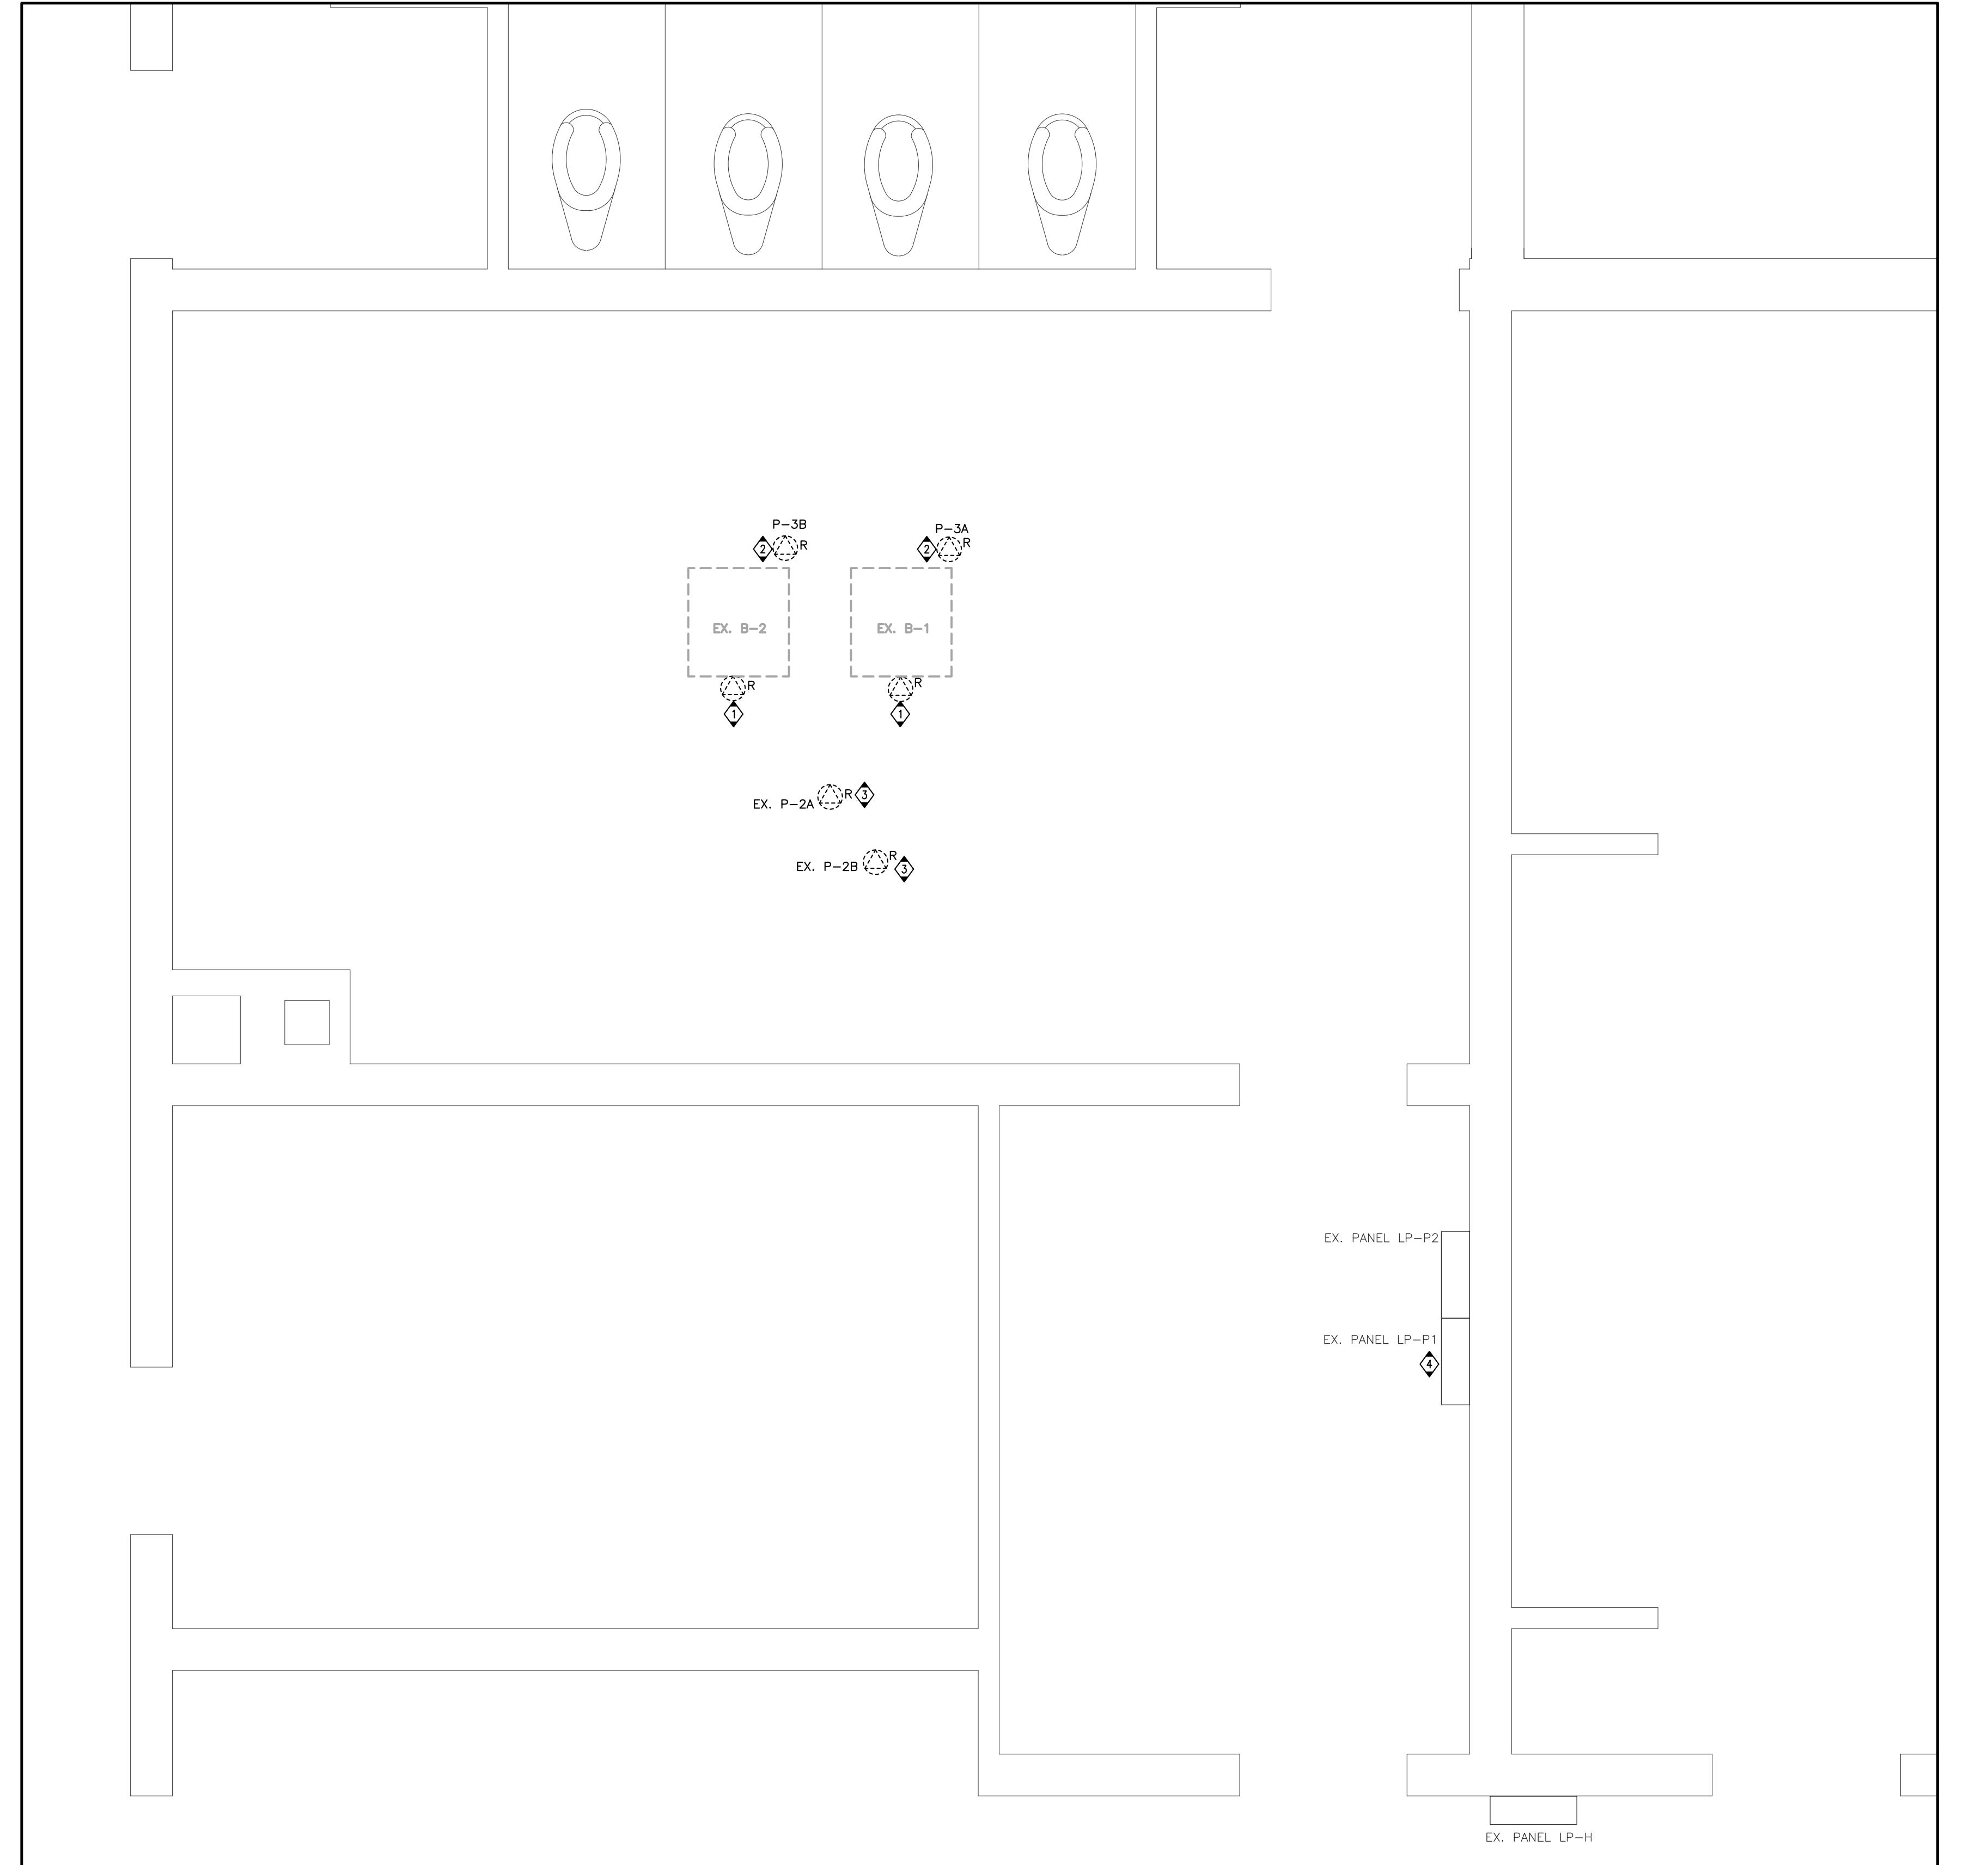




PARTIAL FLOOR PLAN - OFFICE - DEMOLITION PLAN

SCALE - 1:20
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PARTIAL FLOOR PLAN - BOILER ROOM - POWER & SYSTEMS DEMOLITION PLAN

SCALE - 1:20
 0 .5 1 1.5 2

REVISIONS		Date
No.	Description	Date
1	ISSUED FOR REVIEW	2025/02/28
2	ISSUED FOR TENDER READY SET	2025/03/31
3	ISSUED FOR PERMIT AND TENDER	2025/04/17
4	ISSUED FOR PERMIT AND TENDER	2025/12/01

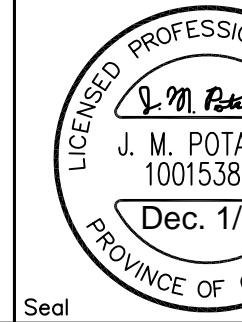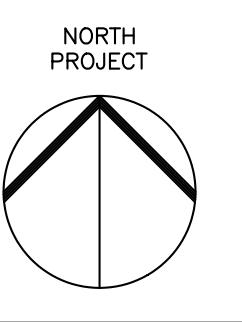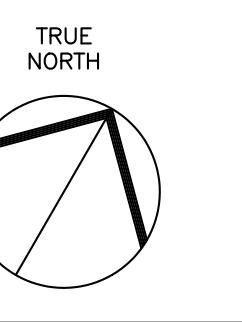

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Project Title:
KILBRIDE PUBLIC SCHOOL
6611 PANTON STREET
KILBRIDE, ONTARIO
Drawing Title:
PARTIAL FLOOR PLAN - BOILER ROOM -
MECHANICAL DEMOLITION PLAN




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Date:	FEBRUARY, 2025	Project Number:	ALL-25001986-A0
Checked:	JP	This Set Contains	Drawing Number:
			E1.1

DRAWING NOTES

- 1 DISCONNECT THE EXISTING BOILER CONTROL PANEL FROM THE SOURCE PANEL & MAKE IT SAFE FOR REMOVAL. RETAIN THE EXISTING CIRCUIT TO FEED THE NEW BOILERS. REFER TO MECHANICAL DRAWINGS FOR EXACT LOCATION.
- 2 DISCONNECT THE EXISTING PUMP FROM THE SOURCE PANEL & MAKE IT SAFE FOR REMOVAL. RETAIN THE EXISTING CIRCUIT TO FEED THE NEW BOILER PUMPS. REFER TO MECHANICAL DRAWINGS FOR EXACT LOCATION.
- 3 DISCONNECT THE EXISTING HEATING PUMP FROM THE SOURCE PANEL & MAKE IT SAFE FOR RELOCATION. PROTECT EXISTING CIRCUIT.
- 4 EXISTING BOILER, BOILER PUMPS & CIRCULATOR PUMPS ARE FED FROM LP-P1 PANEL.
- 5 EXISTING PA SYSTEM PANEL LOCATED IN OFFICE. PA SYSTEM TO BE REPLACED BY HAMILTON VIDEO & SOUND UNDER CASH ALLOWANCE.

GENERAL NOTES

- 1 THE ELECTRICAL CONTRACTOR SHALL, AS PART OF HIS WORK, PERFORM ALL RELATED DEMOLITION, MODIFICATIONS, RELOCATION OF ELECTRICAL DISTRIBUTION AND OTHER EQUIPMENT, RELATED WORK, INCLUDING NEW WORK NECESSARY TO COMPLETE THE PROJECT.
- 2 THE ELECTRICAL CONTRACTOR SHALL VERIFY ALL FIELD CONDITIONS AND DIMENSIONS PRIOR TO SUBMITTING BIDS. REFER TO EXISTING DRAWINGS AND VISIT THE SITE TO DETERMINE THE EXTENT OF THE DEMOLITION AND NEW WORK REQUIRED.
- 3 THE ELECTRICAL CONTRACTOR SHALL VERIFY ALL TECHNICAL DETAILS OF EQUIPMENT TO BE REMOVED, WHERE THERE IS A DISCREPANCY WITH THE TENDER DOCUMENTS, CONTRACTOR SHALL ENGAGE CONSULTANTS FOR DIRECTIONS. ELECTRICAL CONTRACTOR SHALL MAKE A LIST OF ALL EQUIPMENT TO BE REMOVED. THIS LIST SHALL BE WITH ALL FOLLOWING INFORMATION:
** MANUFACTURER
** TECHNICAL DETAILS
** LOCATION THIS LIST SHALL BE SUBMITTED TO THE OWNER FOR RECORD PURPOSES
- 4 THE ELECTRICAL CONTRACTOR SHALL NOT DISCONNECT EQUIPMENT AND ELECTRICAL CIRCUITS IN THE RENOVATION AREA OR ANY PART OF THE BUILDING WITHOUT PRIOR NOTIFICATION AND PERMISSION FROM THE OWNER. EXTREME CARE SHALL BE TAKEN TO MINIMIZE DISTURBANCE TO THE SURROUNDING AREA.
- 5 ITEMS REMOVED AND NOT SCHEDULED TO BE RELOCATED SHALL BE OFFERED TO THE OWNER FOR THEIR USE AND IF NOT ACCEPTED BY THE OWNER, THE ELECTRICAL CONTRACTOR SHALL DISPOSE OF THE MATERIAL FROM THE SITE IN ACCORDANCE WITH LOCAL REGULATIONS. THE ELECTRICAL CONTRACTOR SHALL DELIVER ITEMS ACCEPTED BY THE OWNER TO THE DESIGNATED LOCATIONS AS DIRECTED BY THE OWNER.
- 6 IN ALL CASES WHERE WORK IS REMOVED, THE ELECTRICAL CONTRACTOR SHALL PROVIDE ALL NECESSARY MATERIALS, EQUIPMENT AND LABOR TO SUSTAIN OPERATION OF ALL PARTS OF THE SYSTEM CONNECTING TO OR FROM THE PART REMOVED. COMPLETING ALL WORK IN STRICT ACCORDANCE WITH APPLICABLE CODES.
- 7 ALL WIRING, CABLES AND FEEDERS, INCLUDING BOTH CONNECTED TO DEVICES AND EQUIPMENT TO BE DEMOLISHED AND EXISTING THAT WERE ABANDONED IN PLACE SHALL BE REMOVED BACK TO THEIR SOURCES, UNLESS NOTED OTHERWISE. CONDUITS AND/OR WIRING SHALL, WHERE NECESSARY, BE RE-CIRCUIT AROUND REMOVED PART, KEEPING OCCUPIED PARTS OF THE BUILDING SYSTEM IN FULL SERVICE.
- 8 ALL EXISTING CONDUITS WHICH HAVE BEEN ABANDONED OR ARE UNUSED SHALL BE REMOVED.
- 9 PROVIDE BLANK METAL COVER PLATES FOR ALL JUNCTION DEVICE BOXES NO LONGER IN USE THAT ARE EMBEDDED IN FLOOR SLAB OR MASONRY WALLS. PROVIDE PLUGS FOR ALL PANELS WHERE CONDUIT HAS BEEN REMOVED. COVER PLATES SHALL BE PAINTED TO MATCH EXISTING CONDITIONS.
- 10 WHERE REQUIRED COORDINATE WITH THE CONSULTANTS/OWNER FOR EXISTING PARTS TO BE REMOVED TO FACILITATE WORK. DISCONNECT EACH CONDUIT WHICH SERVING DEVICES IN PARTITIONS TO BE REMOVED. MAINTAIN CONTINUITY OF CIRCUITS SERVING EXISTING DEVICES IN OTHER AREAS TO REMAIN.
- 11 POWER RECEPTACLES - REMOVE RECEPTACLES, WHEN THE RECEPTACLE TO BE REMOVED IS SERVED BY A CIRCUIT THAT SUPPLIES RECEPTACLES IN OTHER AREAS, THAT ARE TO REMAIN, THE ELECTRICAL CONTRACTOR SHALL MAINTAIN THE CONTINUITY OF THE CIRCUIT TO THE REMAINING RECEPTACLES.
- 12 FIRE ALARM SYSTEM: COORDINATE AND CONSULT WITH CURRENT F/A SYSTEM CONTRACTOR OR THEIR QUALIFIED REPRESENTATIVE FOR ALL FIRE ALARM DEMOLITION AND MODIFICATIONS. OPERATION SHALL BE MAINTAINED OF EXISTING FIRE ALARM SYSTEM SPECIFICALLY AS IT RELATES TO ADJACENT AREAS WHICH ARE NOT INCLUDED IN THE SCOPE OF THIS PROJECT.
- 13 ELECTRICAL CONTRACTOR SHALL PROVIDE UPDATED TYPE WRITTEN PANEL DIRECTORIES FOR ALL PANELS AFFECTED BY THE DEMOLITION AND/OR NEW WORK. CIRCUIT BREAKERS NOT USED FOR NEW WORK SHALL BE LABELED AS SPARE.
- 14 FOR EXISTING DEVICES/CIRCUITRY THAT ARE INDICATED TO BE REMOVED BACK TO POINT OF ORIGIN, THESE ITEMS ARE TO BE REMOVED BACK TO POINT OF ORIGIN. THIS INCLUDES CIRCUITRY THAT IS CONNECTED TO DEVICES THAT ARE LOCATED OUTSIDE AREA OF WORK THAT ARE TO REMAIN. IN THAT CASE, REMOVE THE EXISTING DEVICES/CIRCUITRY IN AREA OF WORK BACK TO THESE EXISTING DEVICES TO REMAIN. ALL DEVICES/CIRCUITRY IN SURROUNDING AREAS THAT ARE TO REMAIN ARE TO BE KEPT ENERGIZED. FOR REMOVAL OF CONDUIT AND WIRING OUTSIDE AREA OF WORK, COORDINATE AND SCHEDULE WITH OWNER PRIOR TO PERFORMING WORK.

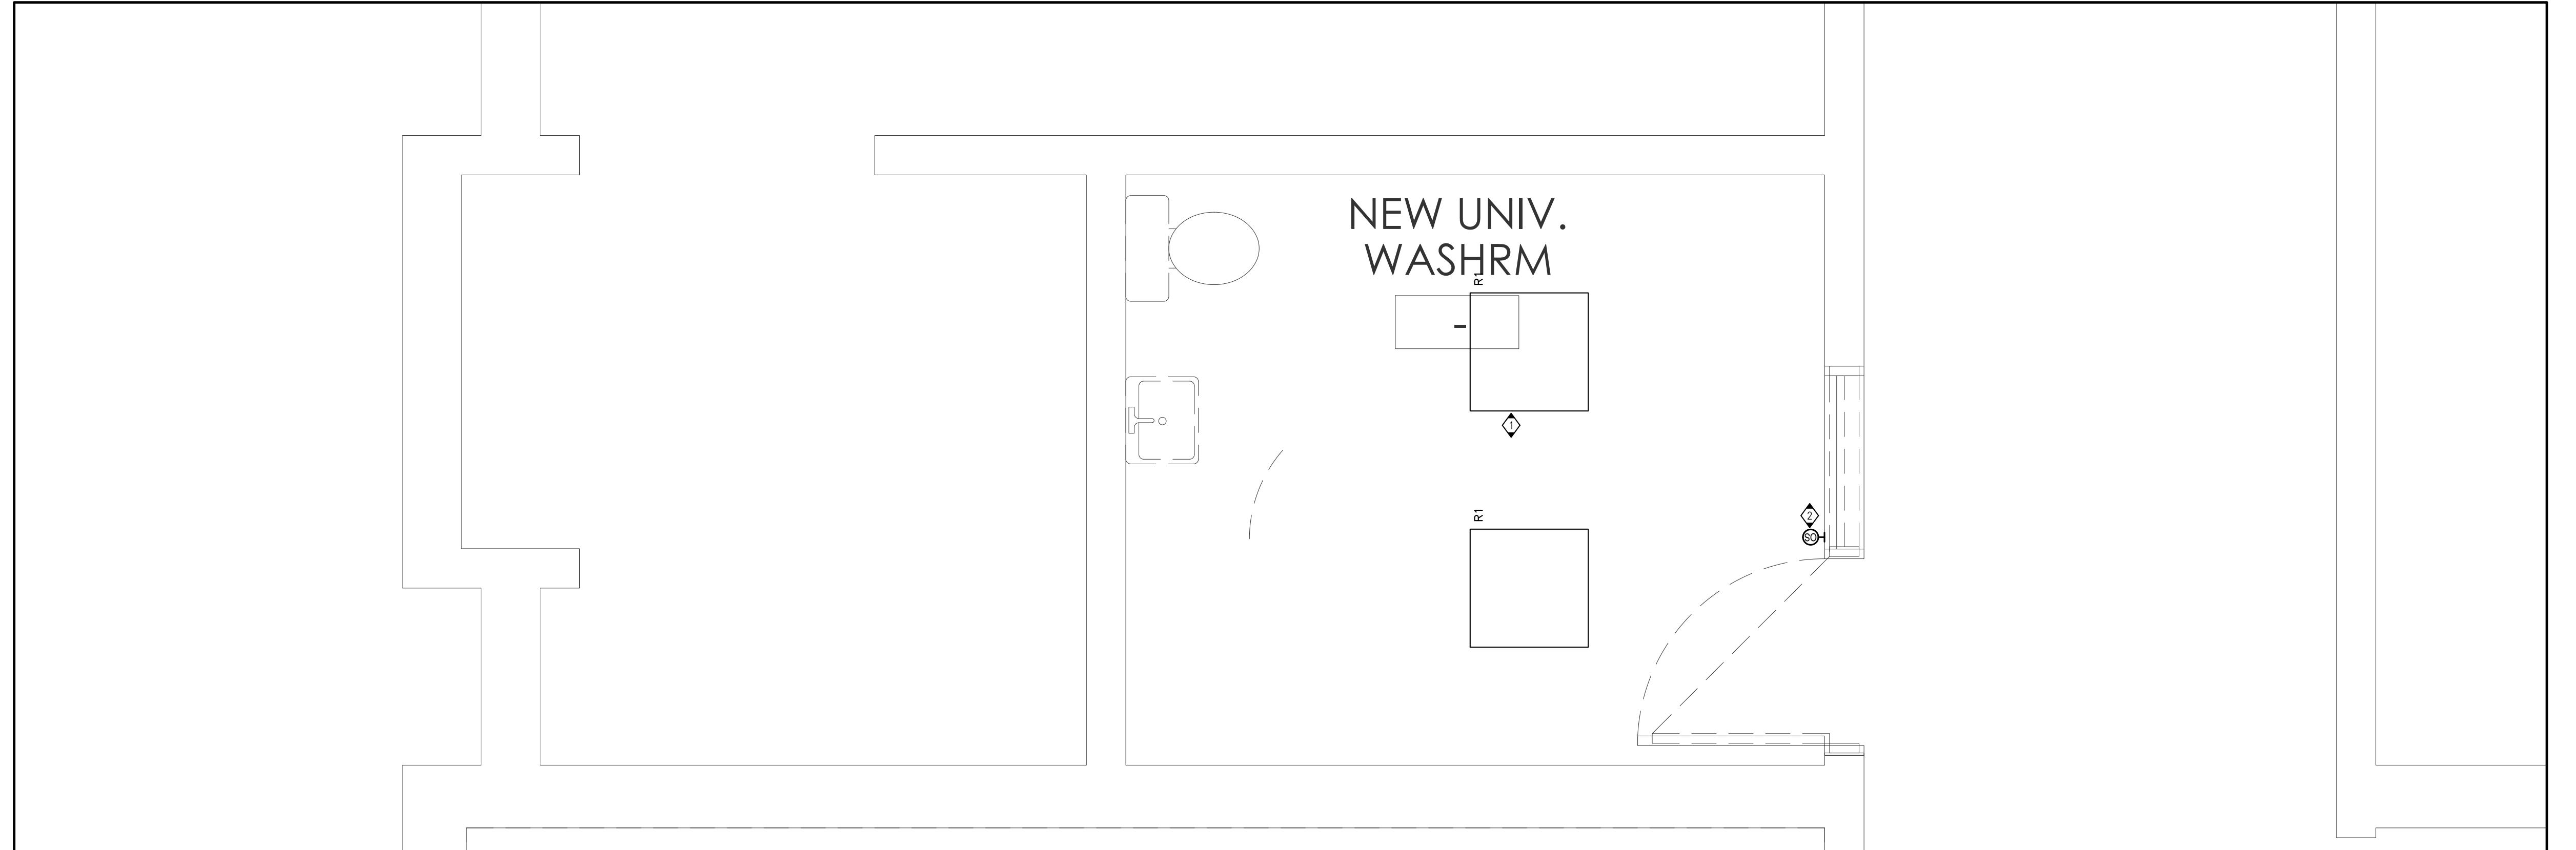


PARTIAL FLOOR PLAN – BARRIER FREE WASHROOM – LIGHTING – PROPOSED PLAN

SCALE – 1:20
 0 .5 1 1.5 2

DRAWING NOTES

- ◆ PROVIDE ADDITIONAL CONDUIT/WIRING AS REQUIRED TO TIE NEW LIGHTING FIXTURE INTO LOCAL LIGHTING CIRCUIT.
- ◆ PROVIDE LINE VOLTAGE OCCUPANCY SENSOR AS SHOWN. PROVIDE CONDUIT/WIRING AS REQUIRED.

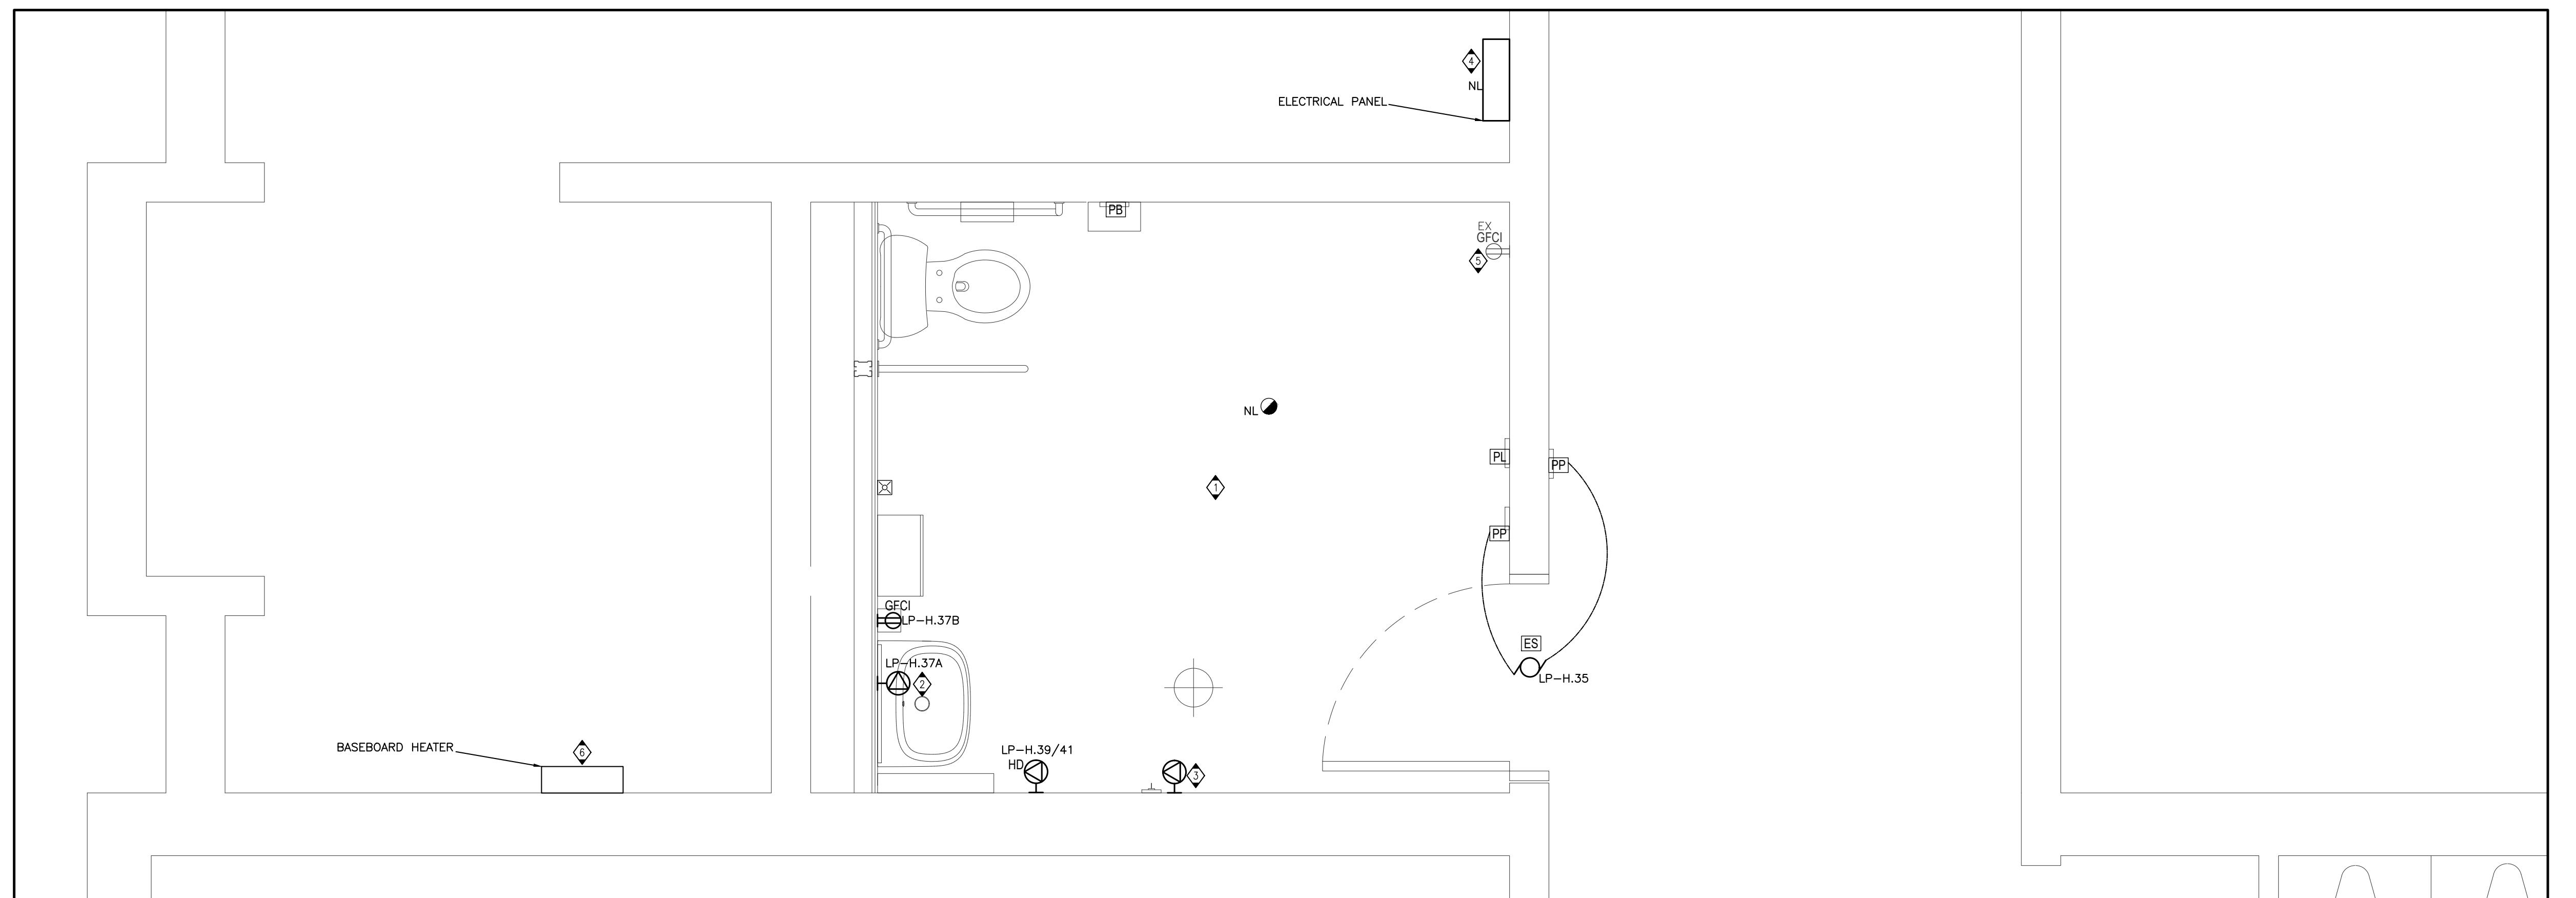

PARTIAL FLOOR PLAN – BARRIER FREE WASHROOM – POWER & SYSTEMS – PROPOSED PLAN

SCALE – 1:20
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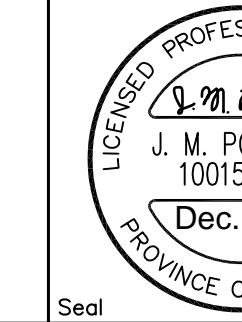
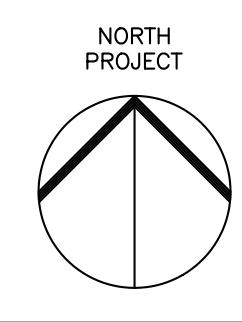
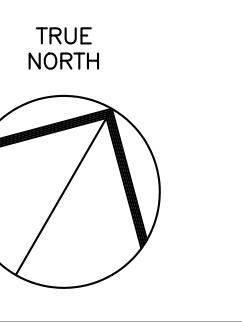
DRAWING NOTES

- ◆ REFER TO TYPICAL BARRIER FREE WASHROOM MOTOR OPERATED DOOR CONTROL SCHEMATIC ON E4.0.
- ◆ MECHANICAL CONTRACTOR SHALL SUPPLY 10 MINUTE TIMER TO CONTROL SOLENOID VALVE FOR FAUCETS. WIRE TIMER TO ROOM LIGHTING CIRCUIT SUCH THAT TIMER IS ENERGIZED WHEN LIGHTS ARE ENERGIZED.
- ◆ RE-USE THE EXISTING CIRCUIT TO FEED THE NEW BASEBOARD HEATER. PROVIDE ADDITIONAL CONDUIT/WIRING AS REQUIRED.
- ◆ INSTALL EXISTING PANEL FEEDING THE NEW BASEBOARD HEATER IN THE BARRIER FREE WASHROOM IN REVISED LOCATION AS SHOWN. PROVIDE NEW WIRING AND ADDITIONAL CONDUIT AS REQUIRED TO REWORK FEEDER AND BRANCH CIRCUITS.
- ◆ EXISTING RECEPTACLE TO REMAIN DEDICATED FOR ADULT CHANGE TABLE (FUTURE).
- ◆ EXISTING BASEBOARD HEATER, REWIRED FROM RELOCATED PANEL.

GENERAL NOTES

- A. PRIOR TO BIDDING, ELECTRICAL CONTRACTOR SHALL VISIT SITE AND BE FAMILIAR WITH ALL EXISTING CONDITIONS INCLUDING BUT NOT LIMITED TO EQUIPMENT LOCATIONS AND OTHER POSSIBLE INSTALLATION DIFFICULTIES. PAY AND OBTAIN ANY PERMITS REQUIRED INCLUDING ESA.
- B. ALL CONDUIT ROUTES SHOWN ON DRAWINGS ARE APPROXIMATE AND NOT FINAL. CONTRACTOR SHALL VERIFY ROUTES AND DO A WALK-THROUGH BEFORE BID. CONTRACTOR SHALL ACCOUNT FOR POSSIBLE DAMAGE AND REPAIR TO EXISTING CEILING AND LIGHT FIXTURES. ALL MAIN CONDUIT RUNS SHALL BE IN CORRIDOR CEILING SPACE.
- C. EXTEND/PROVIDE NEW WIRING/CONDUIT FOR ALL DEVICES THAT ARE RELOCATED.
- D. REMOVE AND RE-INSTALL ALL REQUIRED T-BAR OR DRY TYPE CEILINGS TO FACILITATE ELECTRICAL INSTALLATIONS. ANY DAMAGES TO T-BAR SHALL BE RE-INSTALLED.
- E. UNLESS OTHERWISE NOTED WITH A CIRCUIT NUMBER, RE-USE EXISTING CIRCUITS THAT HAD BECOME SPARE FROM THE DEMOLITION TO FEED NEW RECEPTACLES. MAXIMUM 6 DUPLEX RECEPTACLES PER CIRCUIT UNLESS OTHERWISE NOTED.
- F. CONTRACTOR SHALL ACCOUNT FOR POSSIBLE DAMAGE AND REPAIR TO CEILING TILES FOR CONDUIT RUNS FROM PANELS TO NEW ELECTRICAL DEVICES.
- G. CIRCUIT NUMBERS SHOWN ON THIS PLAN ARE FOR CIRCUITING PURPOSE ONLY. RE-USE EXISTING SPARE BREAKERS OR EXISTING BREAKERS MADE SPARE FROM DEMOLITION AND/OR REPLACE OBSOLETE BREAKERS WITH NEW ADD/OR ADD NEW BREAKERS IN AVAILABLE SPACES IN EXISTING ELECTRICAL PANELS AS REQUIRED OR REPLACE EXISTING PANELS WITH NEW AS INDICATED. CONFIRM EXISTING CONDITIONS ON SITE.

REVISIONS	
No.	Description/Date
1	ISSUED FOR REVIEW 2025/02/28
2	ISSUED FOR TENDER READY SET 2025/03/31
3	ISSUED FOR PERMIT AND TENDER 2025/04/17
4	ISSUED FOR PERMIT AND TENDER 2025/12/01




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Project Title: KILBRIDE PUBLIC SCHOOL
 6611 PANTON STREET
 KILBRIDE, ONTARIO
 Drawing Title: PARTIAL FLOOR PLAN - BARRIER FREE WASHROOM - NEW PLANS




Drawn: AC Scale: AS NOTED
 Date: FEBRUARY, 2025 Project Number: ALL-25001986-A0
 Checked: JP This Set Contains Drawing Number: E2.0
 Date: FEBRUARY, 2025 Drawings Revision:



PARTIAL FLOOR PLAN - BOILER ROOM - POWER & SYSTEMS - PROPOSED PLAN

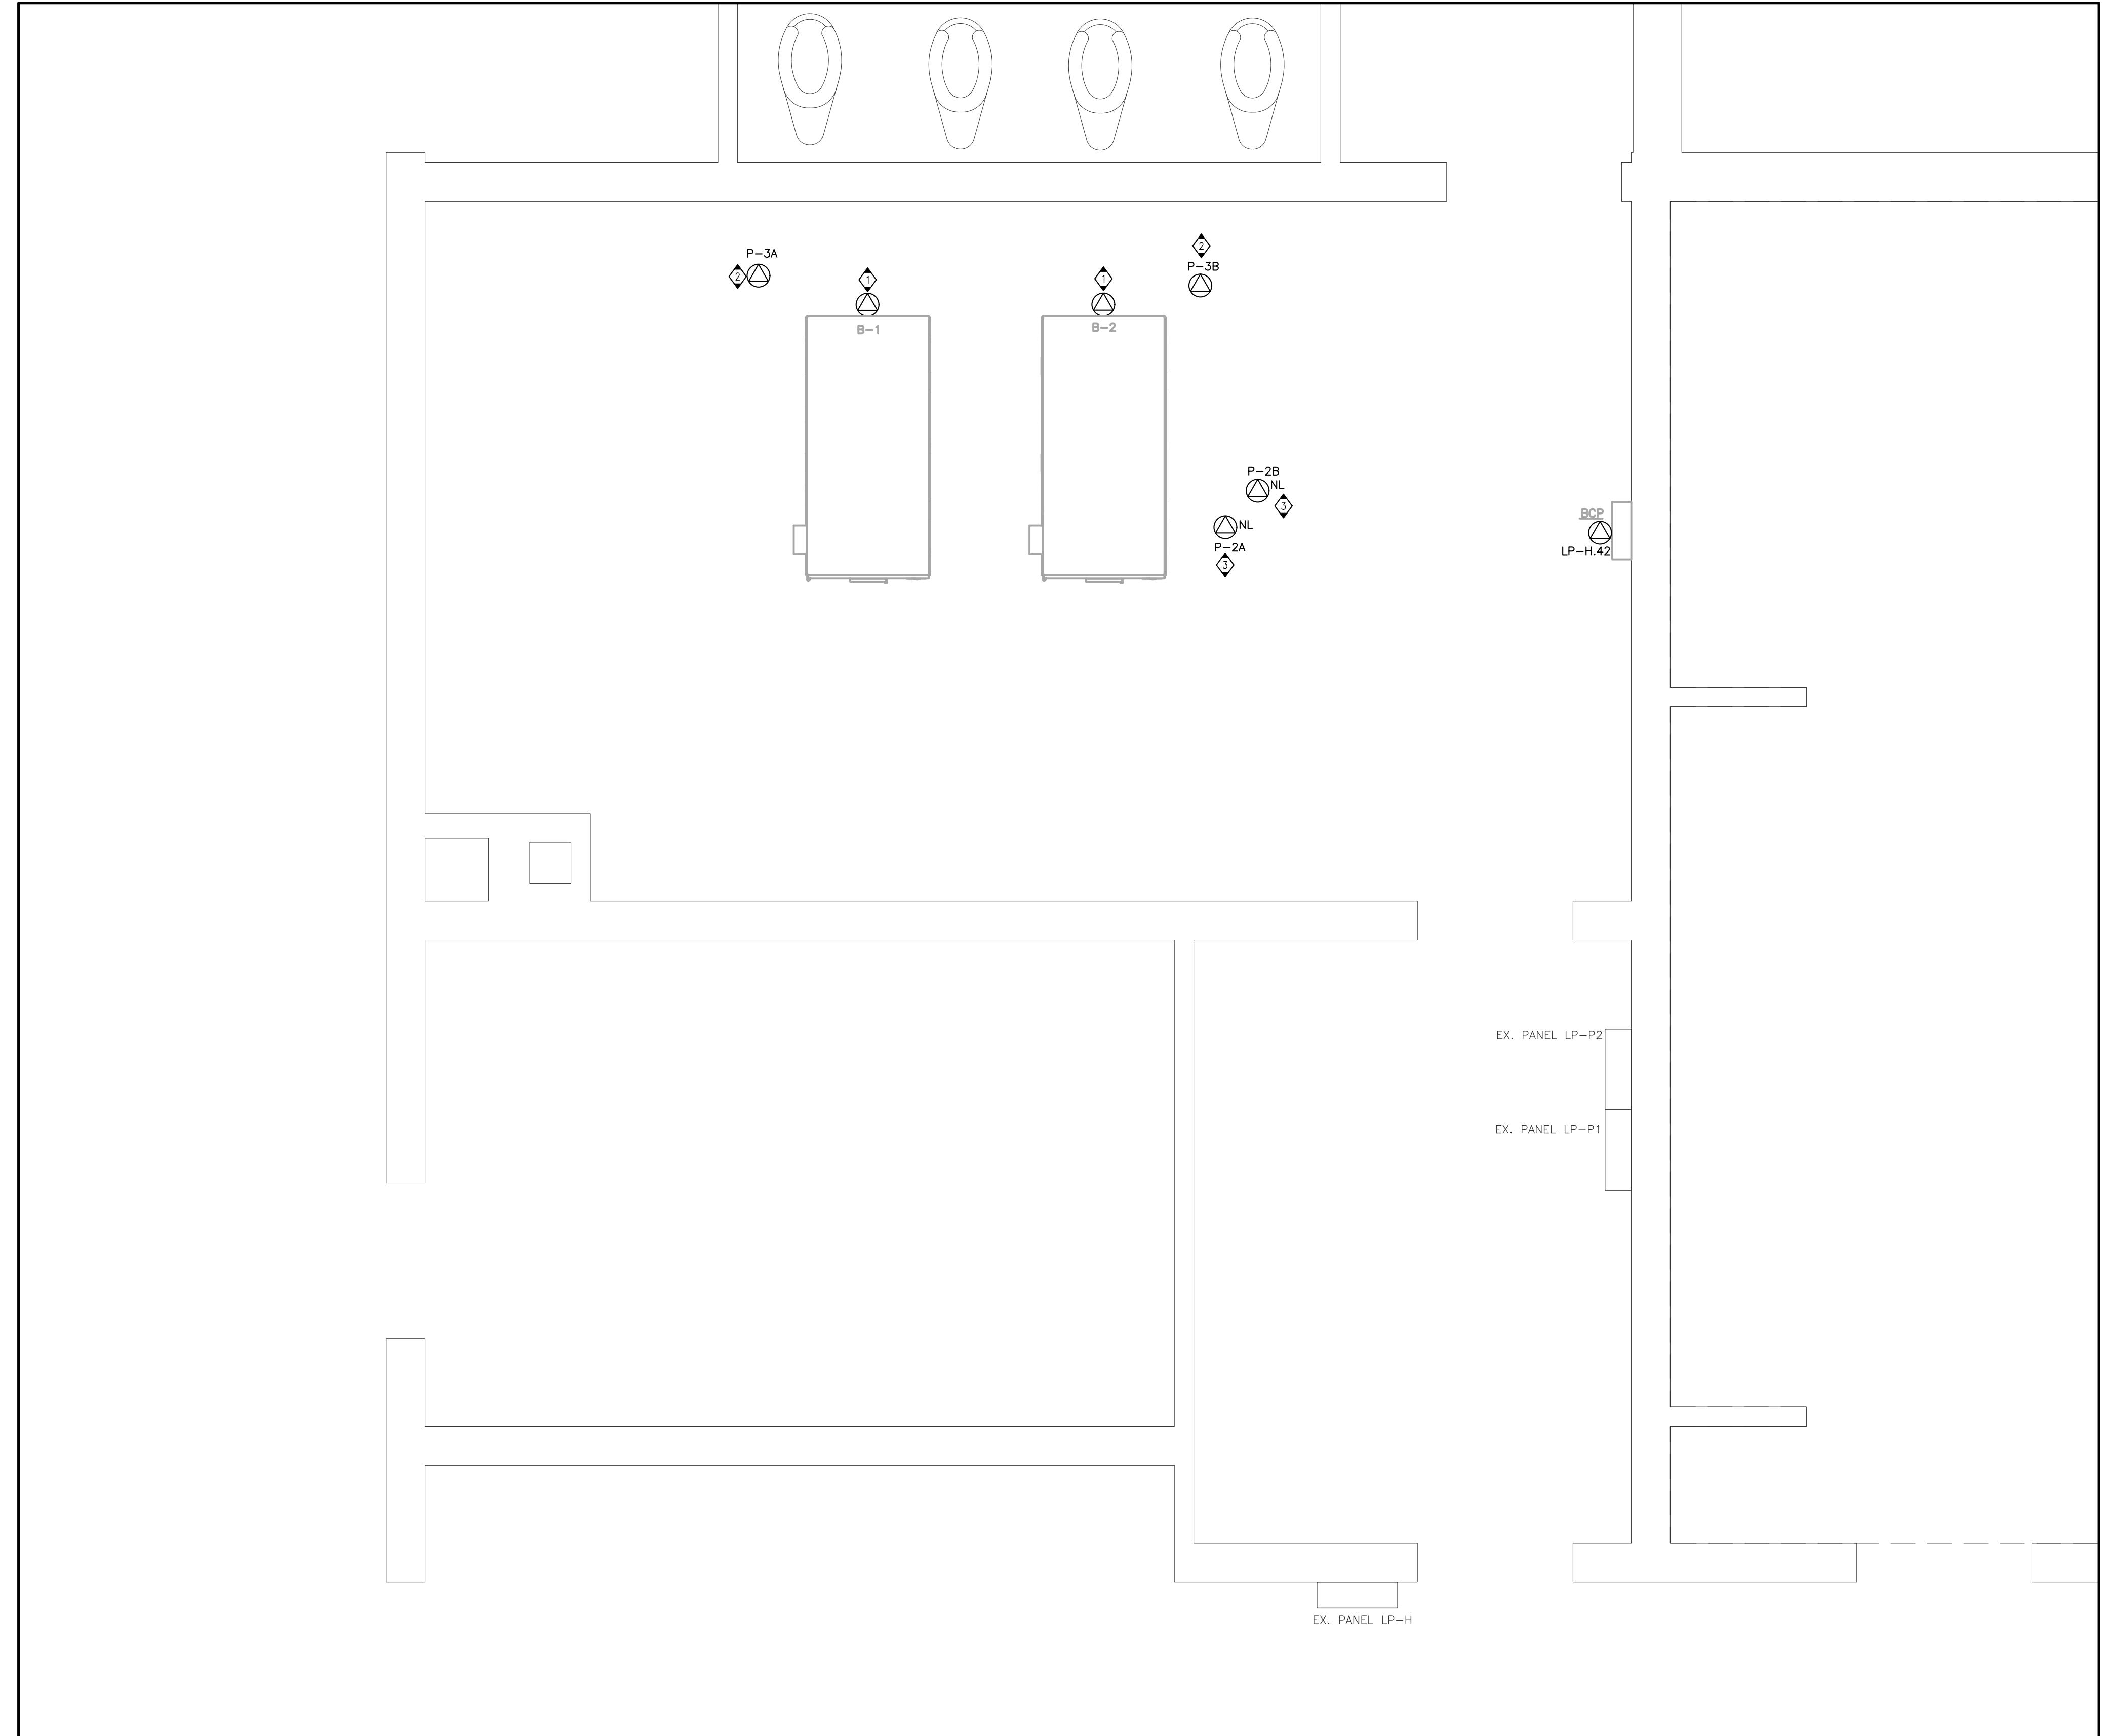SCALE - 1:20
 0 .5 1 1.5 2

REVISIONS		Date	Description
1	ISSUED FOR REVIEW	2025/02/28	ISSUED FOR TENDER READY
2	ISSUED FOR PERMIT AND TENDER SET	2025/03/31	ISSUED FOR PERMIT AND TENDER
3	ISSUED FOR PERMIT AND TENDER	2025/04/17	ISSUED FOR PERMIT AND TENDER
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Project Title: KILBRIDE PUBLIC SCHOOL
 6611 PANTON STREET
 KILBRIDE, ONTARIO
 Drawing Title: PARTIAL FLOOR PLAN - BOILER ROOM - MECHANICAL NEW PLAN


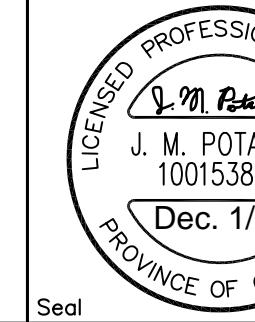
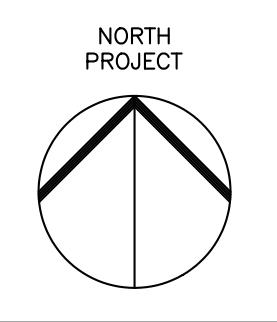
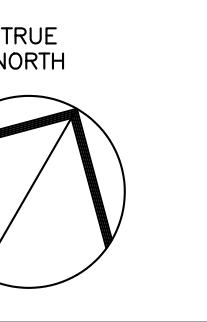
Drawn: AC Scale: AS NOTED
 Date: FEBRUARY, 2025 Project Number: ALL-25001986-A0
 Checked: JP This Set Contains Drawing Number: E2.1
 Date: FEBRUARY, 2025 Drawings Revision:

DRAWING NOTES

- 1 USE THE EXISTING CIRCUIT TO FEED THE NEW BOILERS. PROVIDE ADDITIONAL CONDUIT/WIRING AS REQUIRED.
- 2 USE THE EXISTING CIRCUIT TO FEED THE NEW BOILERS CIRCULATOR PUMPS. PROVIDE ADDITIONAL CONDUIT/WIRING AS REQUIRED.
- 3 PROVIDE ADDITIONAL CONDUIT/WIRING AS REQUIRED TO REWORK BRANCH CIRCUIT FOR EXISTING PUMP AS SHOWN.

GENERAL NOTES

- A. PRIOR TO BIDDING, ELECTRICAL CONTRACTOR SHALL VISIT SITE AND BE FAMILIAR WITH ALL EXISTING CONDITIONS INCLUDING BUT NOT LIMITED TO EQUIPMENT LOCATIONS AND OTHER POSSIBLE INSTALLATION DIFFICULTIES. PAY AND OBTAIN ANY PERMITS REQUIRED INCLUDING ESA.
- B. ALL CONDUIT ROUTES SHOWN ON DRAWINGS ARE APPROXIMATE AND NOT FINAL. CONTRACTOR SHALL VERIFY ROUTES AND DO A WALKTHROUGH BEFORE BID. CONTRACTOR SHALL ACCOUNT FOR POSSIBLE DAMAGE AND REPAIR TO EXISTING CEILING AND LIGHT FIXTURES. ALL MAIN CONDUIT RUNS SHALL BE IN CORRIDOR CEILING SPACE.
- C. EXTEND/PROVIDE NEW WIRING/CONDUIT FOR ALL DEVICES THAT ARE RELOCATED.
- D. ALL NEW RECEPTACLES IN THE SCHOOL SHALL BE TAMPER RESISTANT TYPE.
- E. CONTRACTOR SHALL ACCOUNT FOR POSSIBLE DAMAGE AND REPAIR TO CEILING TILES FOR CONDUIT RUNS FROM PANELS TO NEW ELECTRICAL DEVICES.
- F. CIRCUIT NUMBERS SHOWN ON THIS PLAN ARE FOR CIRCUITING PURPOSE ONLY. REUSE EXISTING SPARE BREAKERS OR EXISTING BREAKERS MADE SPARE FROM DEMOLITION AND/OR REPLACE OBSOLETE BREAKERS WITH NEW ADDITIONAL SPARE BREAKERS. REPLACE EXISTING ELECTRICAL PANELS AS REQUIRED OR REPLACE EXISTING PANELS WITH NEW AS INDICATED. CONFIRM EXISTING CONDITIONS ON SITE.

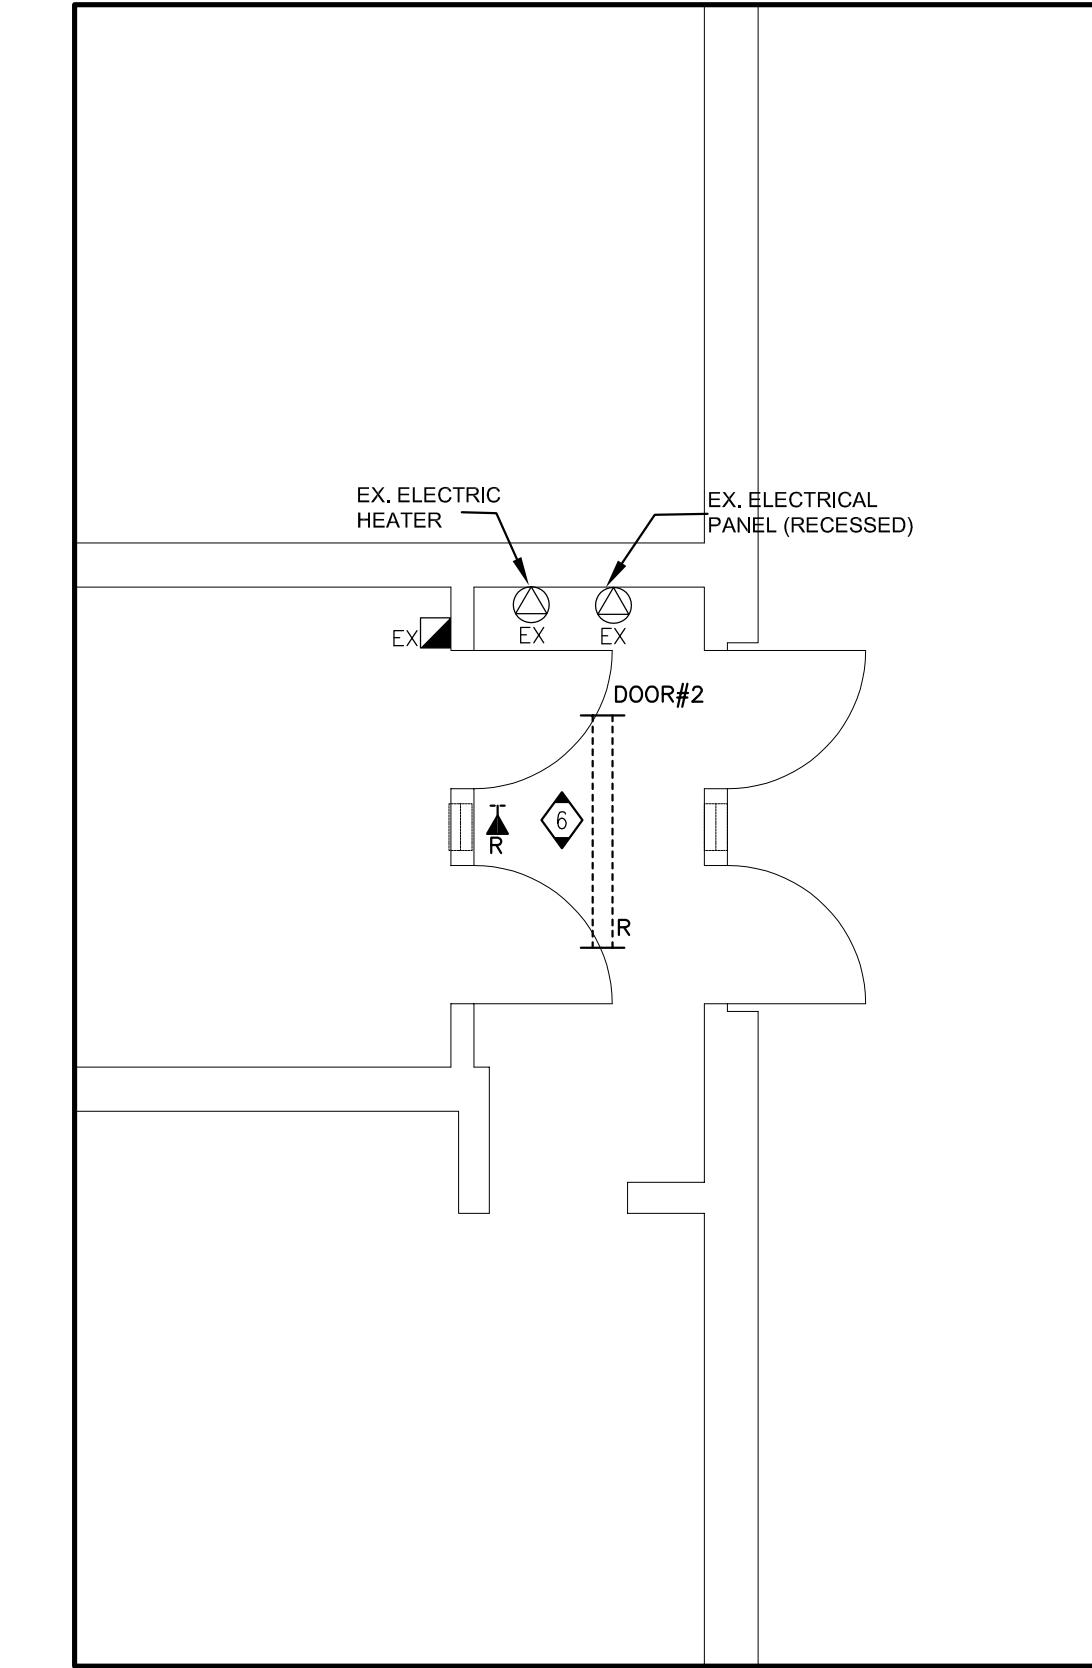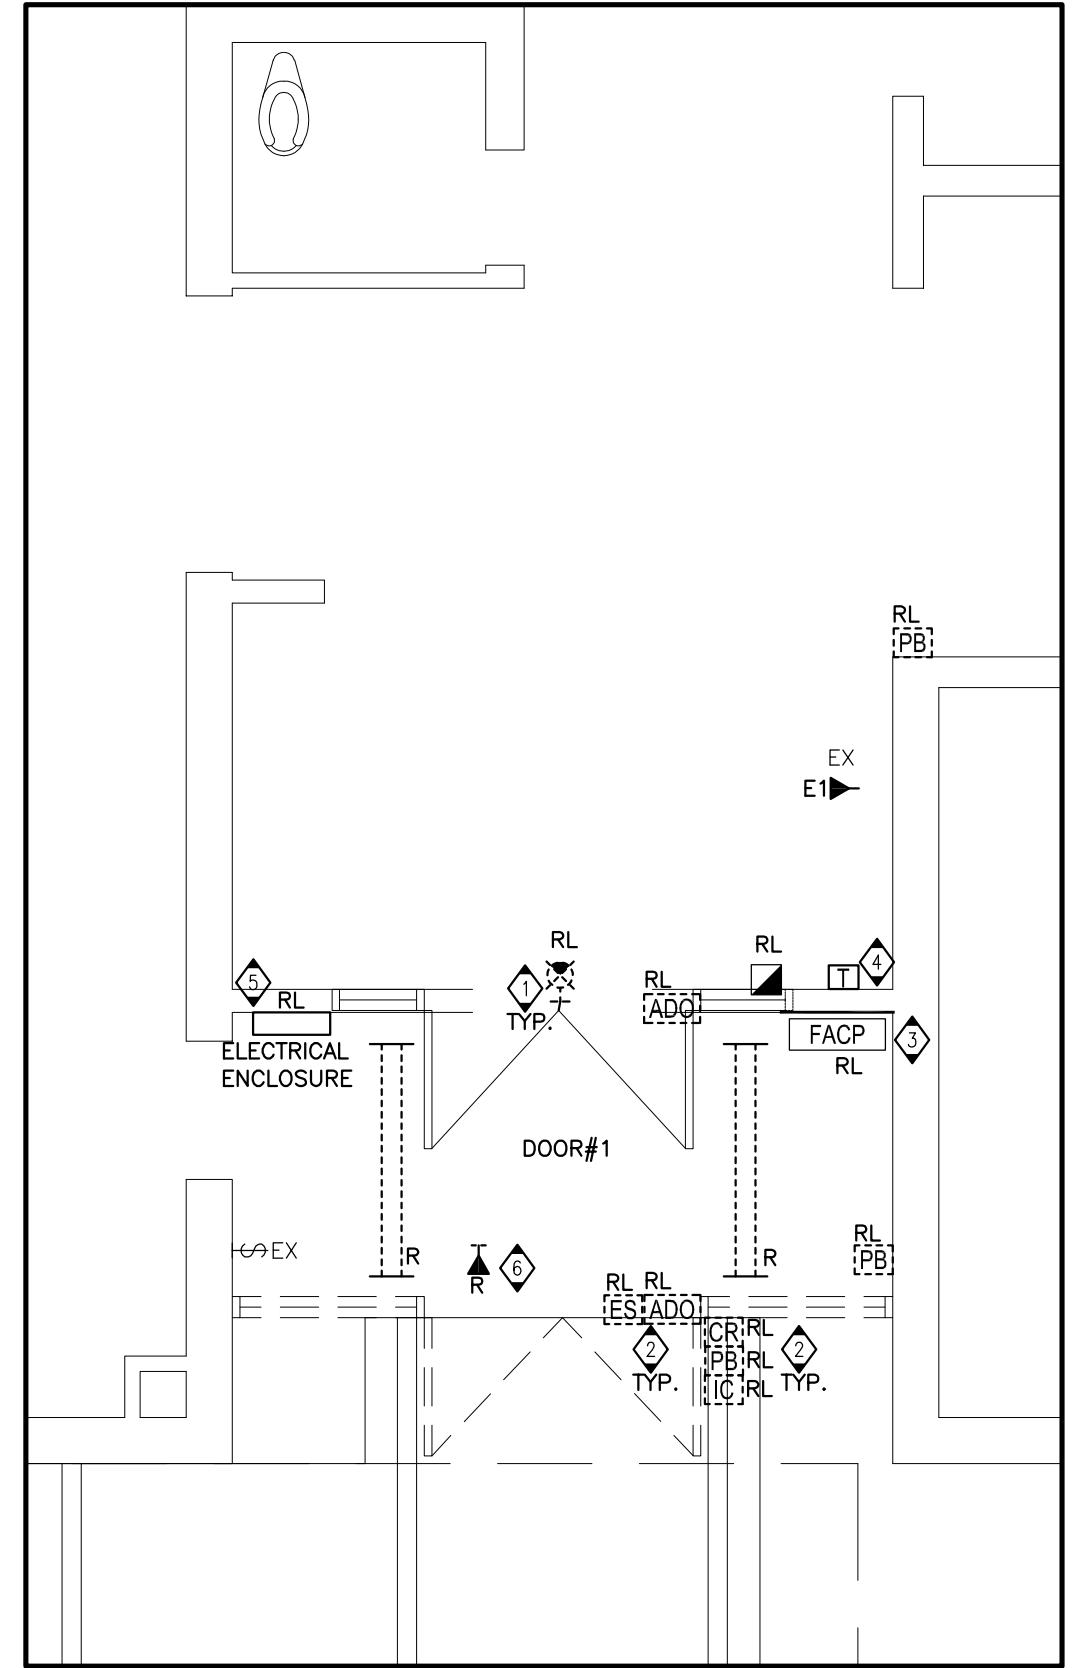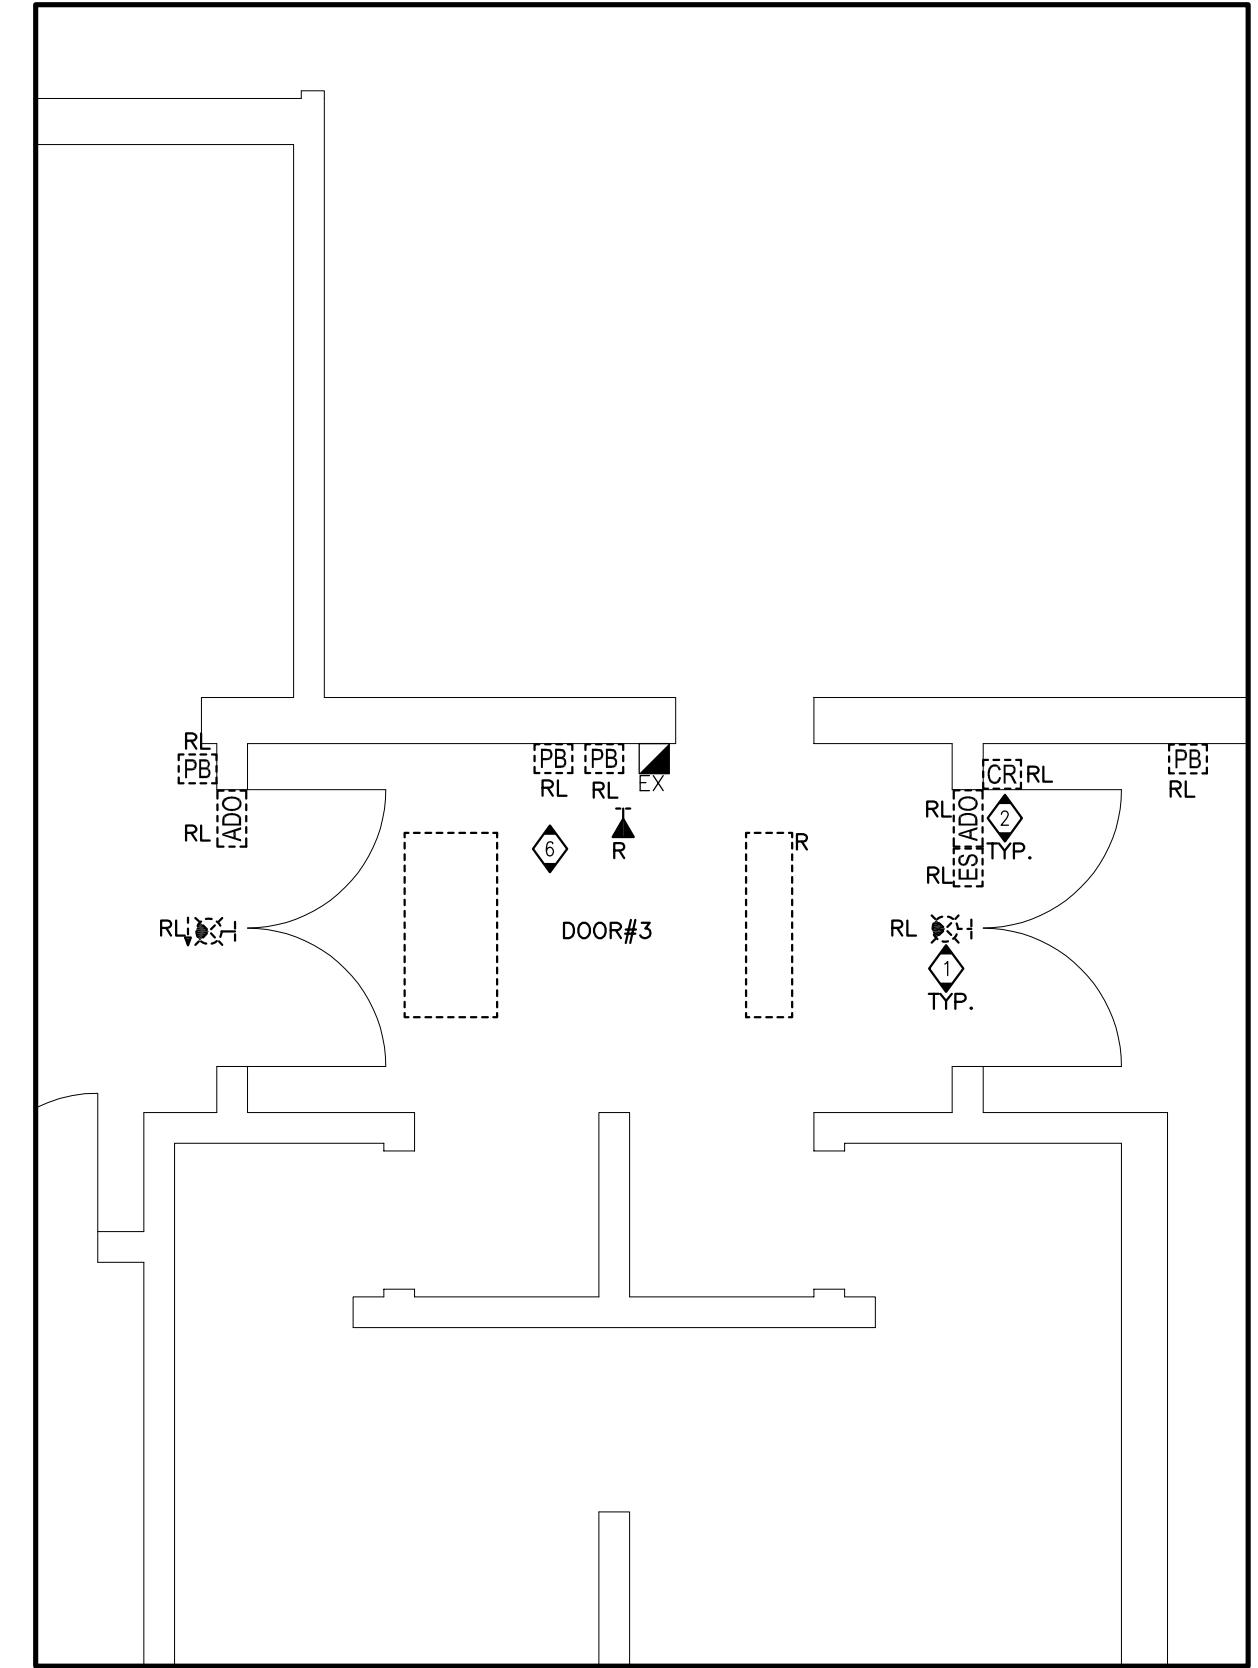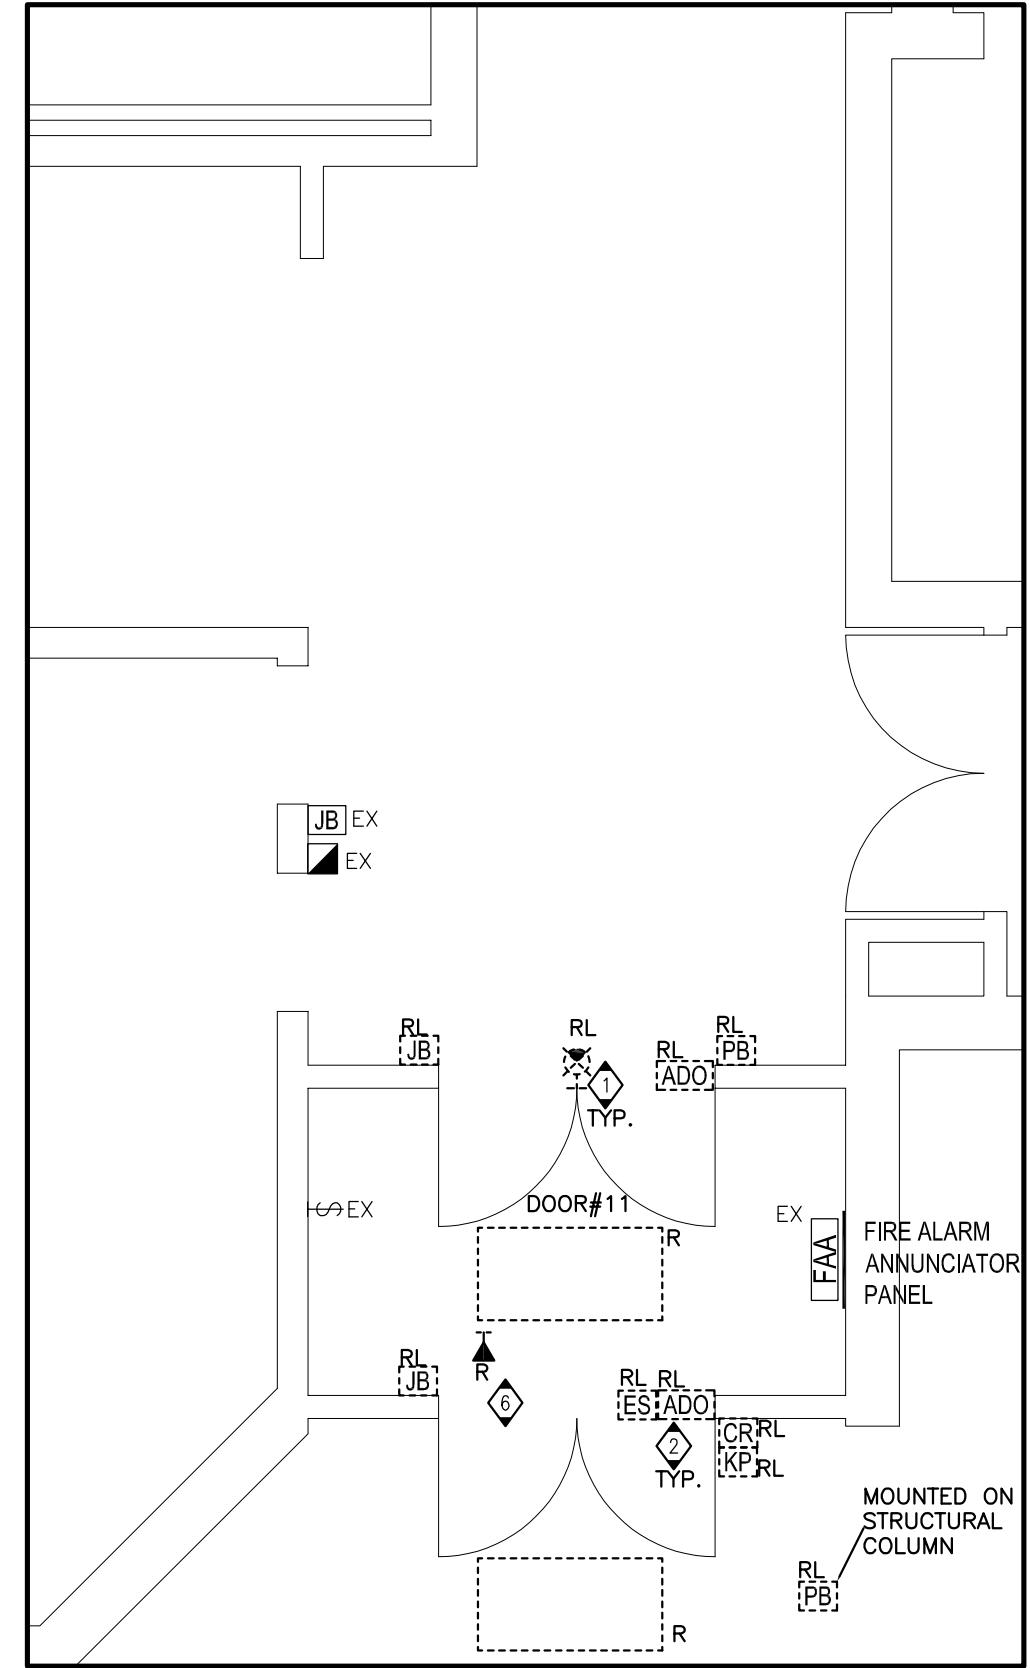

VESTIBULES – DEMOLITION PLAN





SCALE – 1:20
0 .5 1 1.5 2

DRAWING NOTES

- 1 DISCONNECT AND REMOVE EXISTING EXIT SIGN, STORE THE DEVICE SAFE FOR REINSTALLATION.
- 2 DISCONNECT AND REMOVE EXISTING DOOR HARDWARE DEVICES. STORE THE DEVICE SAFE FOR REINSTALLATION. PROTECT THE EXISTING CONDUIT/WIRING.
- 3 FIRE ALARM PANEL TO BE DISCONNECT AND RELOCATED IN THE VESTIBULE. MIRCOM FX-2000. PROTECT CONDUCTORS AND MAINTAINS FUNCTIONALITY THROUGHOUT CONSTRUCTION.
- 4 THERMOSTAT RELOCATION BY MECHANICAL TRADE.
- 5 ELECTRICAL COMMUNICATION PANEL ENCLOSURE TO BE RELOCATED IN THE VESTIBULE. DETAILS TO BE PROVIDED.
- 6 TURN EXISTING FIXTURE OVER TO THE OWNER.

GENERAL NOTES

ELECTRICAL CONTRACTOR IS TO REMOVE DEVICE BOXES AND CONDUIT AS REQUIRED FOR LOW VOLTAGE SYSTEMS (ACCESS CONTROL, DOOR OPERATORS, INTERCOMPA SYSTEM), AND INCLUDE THIS WORK IN THE TENDER BID. HAMILTON VIDEO AND SOUND WILL DISCONNECT DEVICES AND REMOVE WIRING FOR THESE SYSTEMS. UNDER CASH ALLOWANCE.

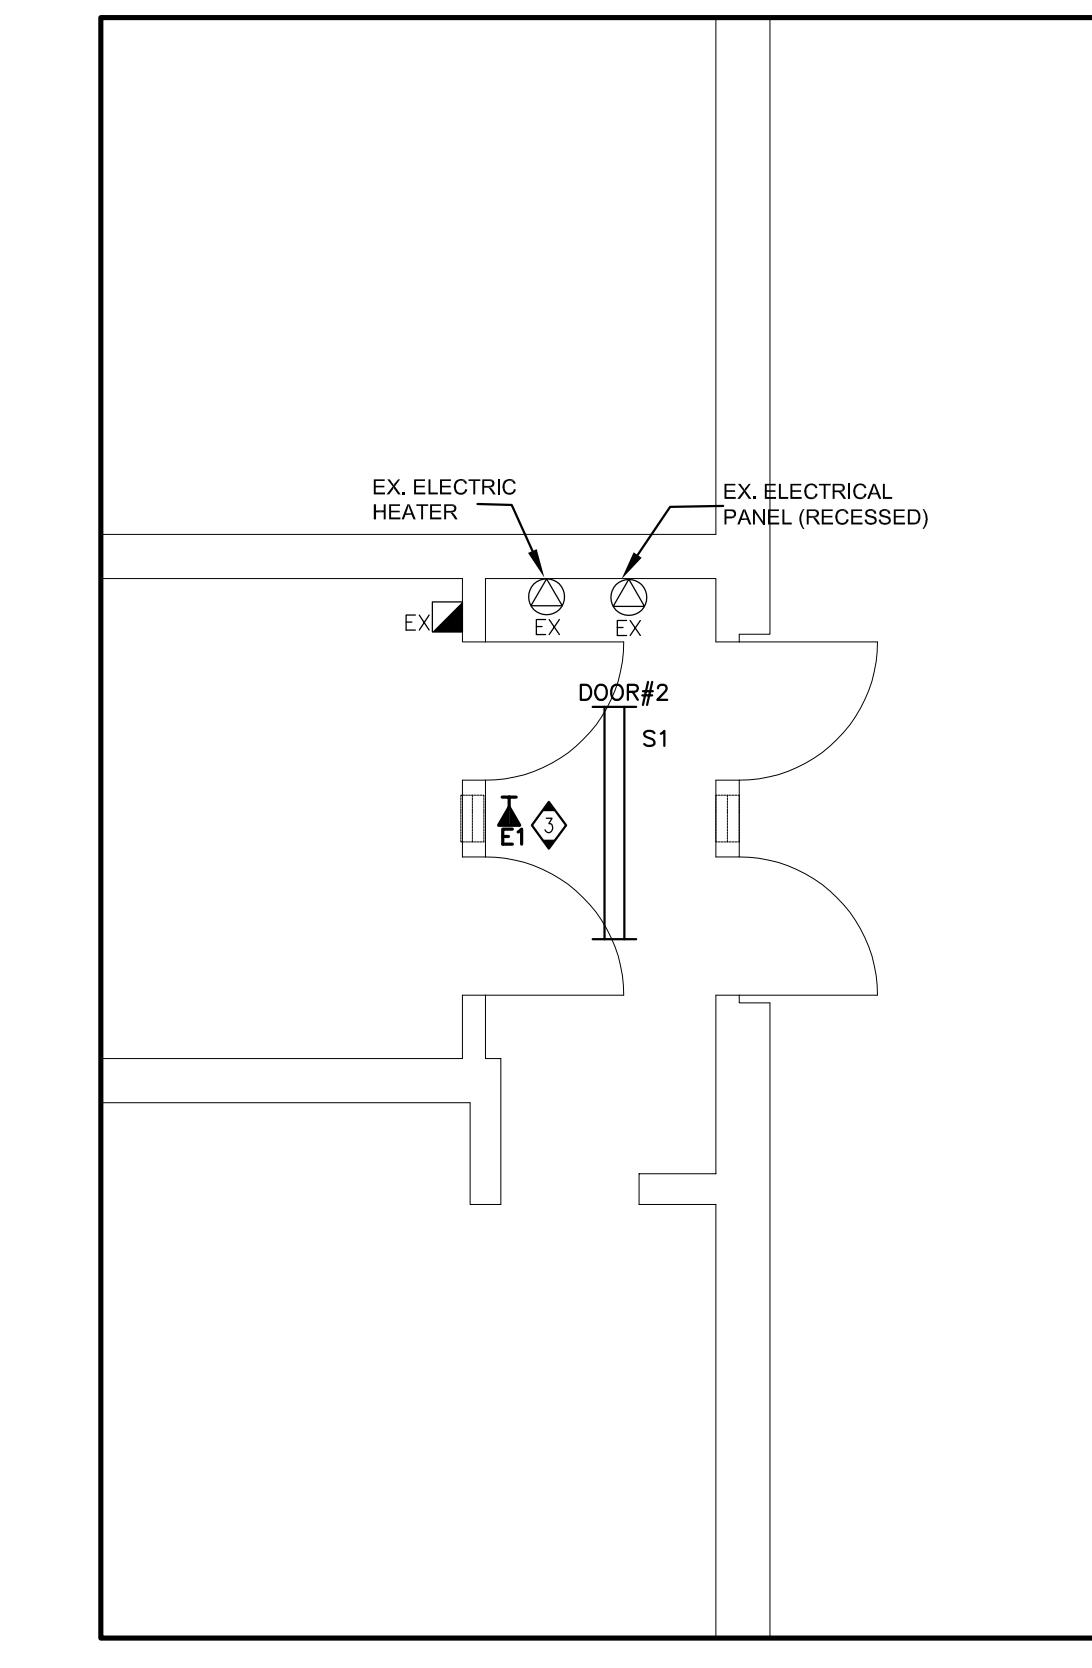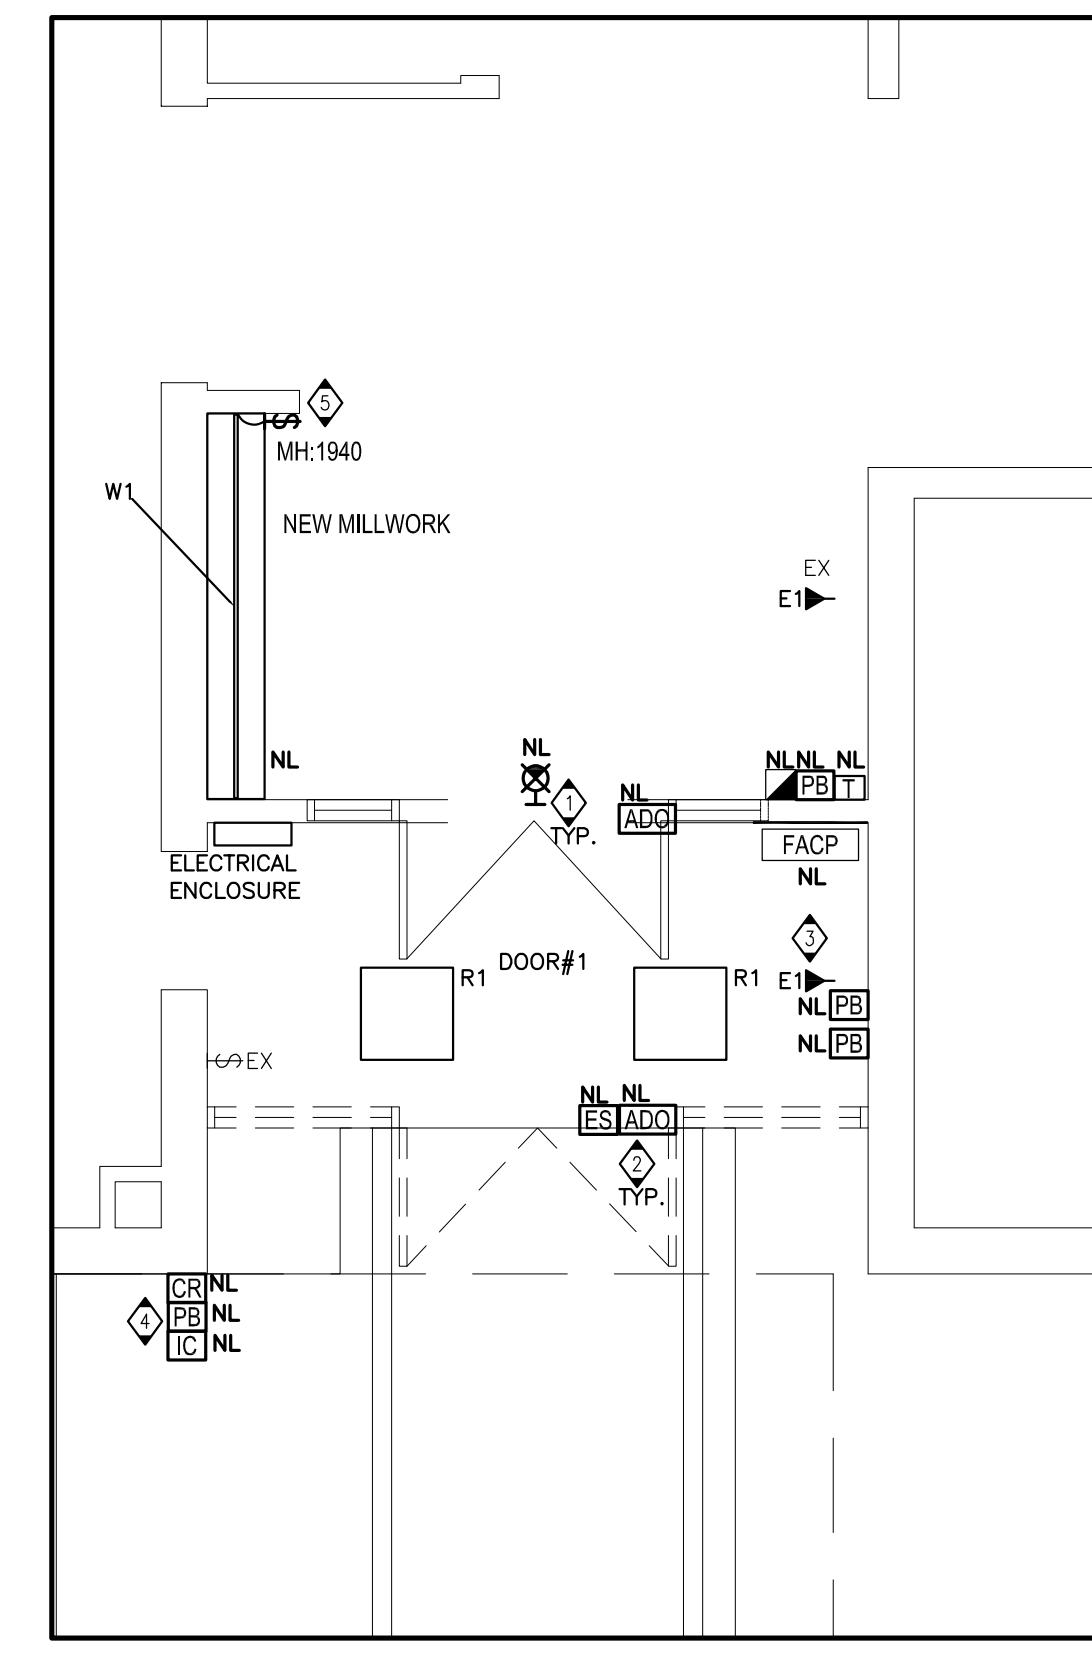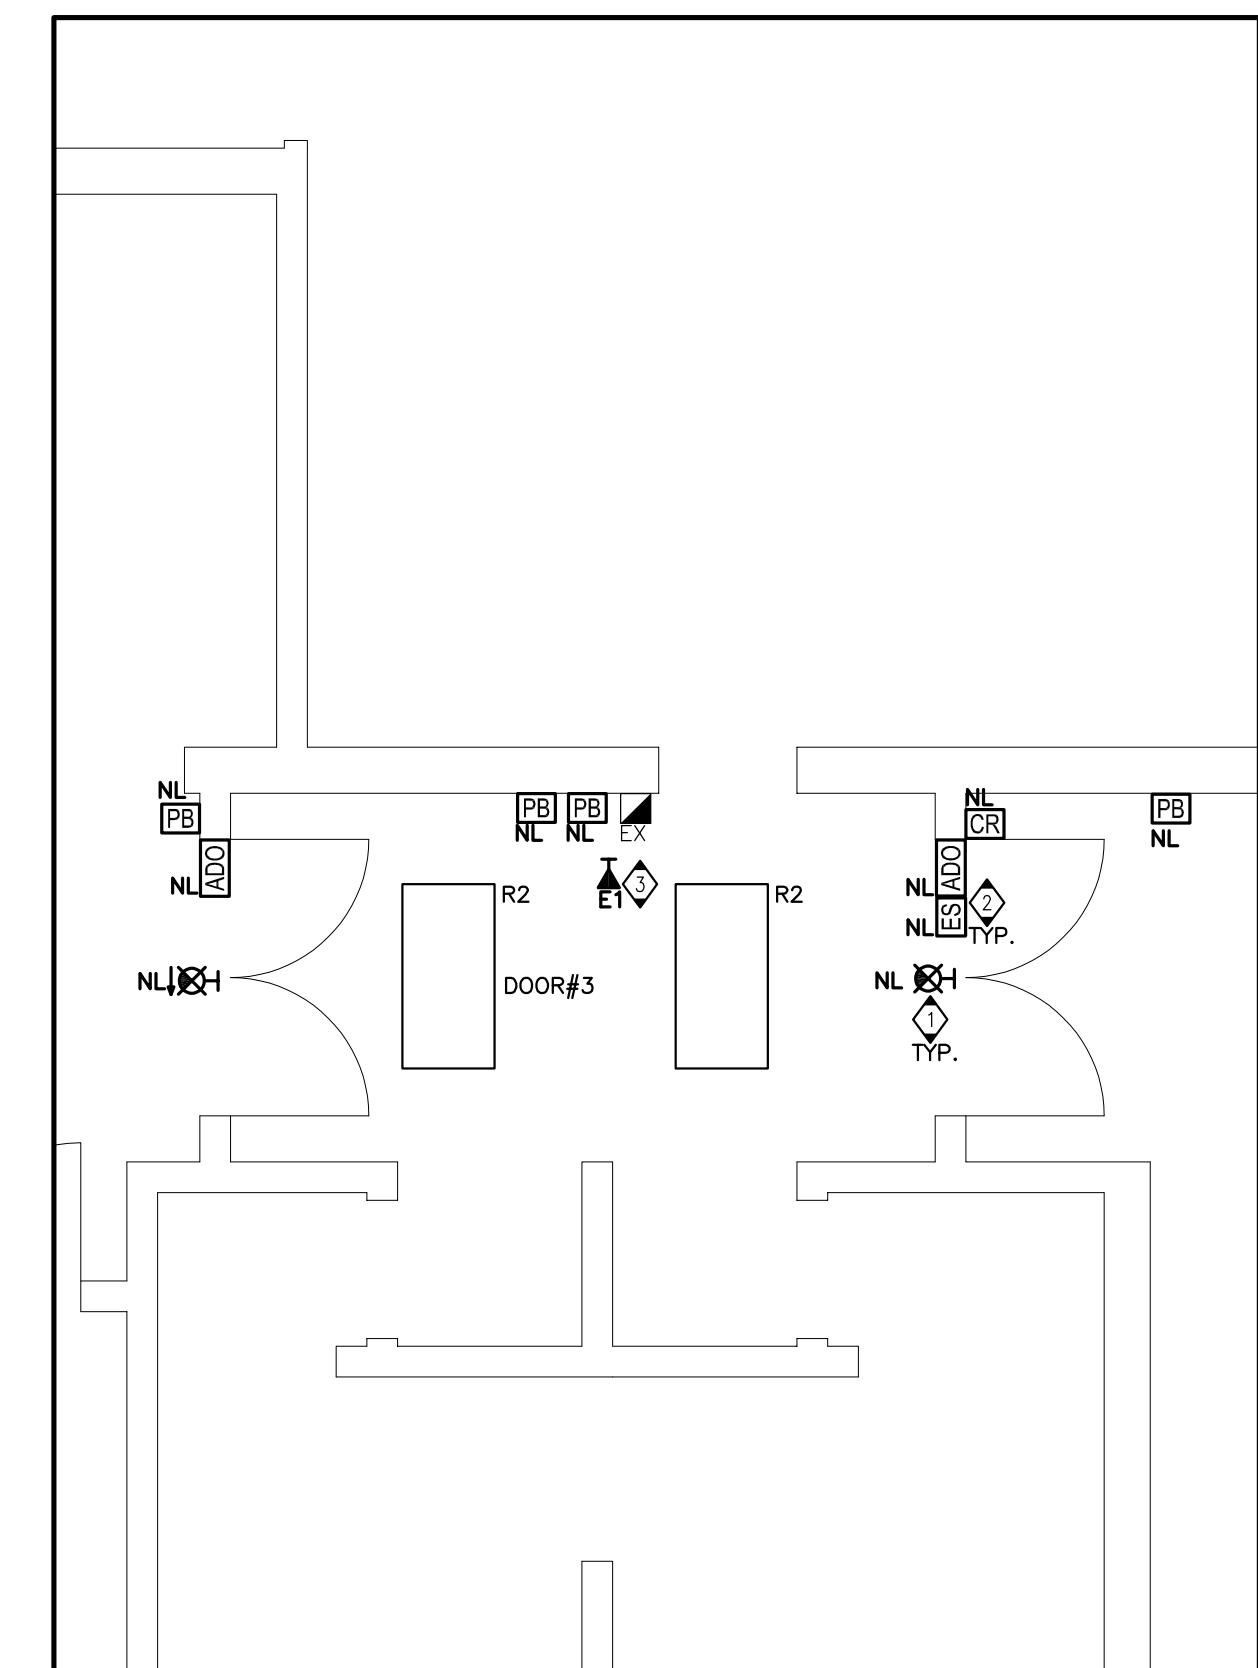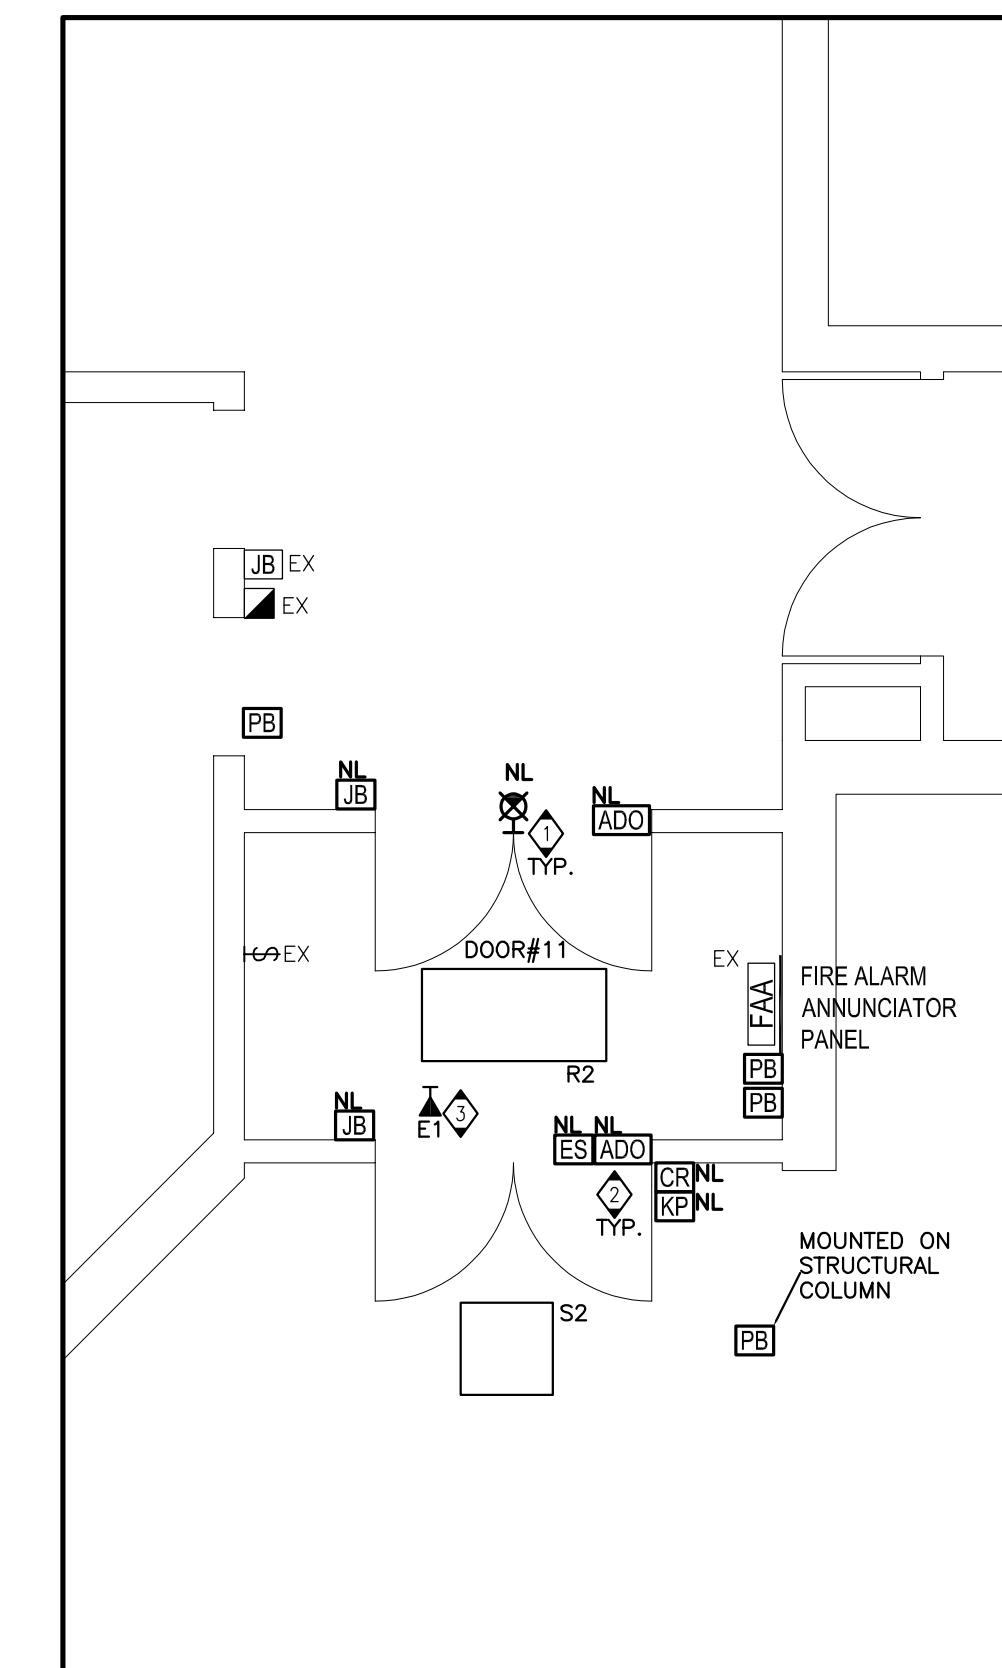

VESTIBULES – PROPOSED PLAN

SCALE – 1:20
0 .5 1 1.5 2

DRAWING NOTES




- 1 RE-INSTALL EXISTING EXIT SIGN. PROVIDE ADDITIONAL CONDUIT/WIRING IF REQUIRED.
- 2 RE-INSTALL EXISTING DOOR HARDWARE DEVICES. PROVIDE ADDITIONAL CONDUIT IF REQUIRED.
- 3 CONTRACTOR TO VERIFY THE VOLTAGE OF EMERGENCY REMOTE HEAD ON SITE PRIOR TO INSTALLATION. TERMINATE TO NEAREST EMERGENCY CIRCUIT DEVICE WHERE NEW.
- 4 RE-INSTALL EXISTING DOOR HARDWARE DEVICES IN NEW LOCATION ON WALL WITH SIMILAR ARRANGEMENT AS EXISTING (PUSH BUTTON LOCATED 1100MM ABOVE GRADE. EXACT LOCATION AND HEIGHTS TO BE COORDINATED WITH ARCHITECT PRIOR TO INSTALLATION). PROVIDE ADDITIONAL CONDUIT IF REQUIRED.
- 5 PROVIDE RECESSED LIGHTING FIXTURE OWN WIRING DEVICE. CONDUIT/WIRING AND ALL ASSOCIATED ELECTRICAL CONNECTIONS FOR NEW MILLWORK. CONNECT FIXTURE TO THE CLOSEST EXISTING LIGHTING CIRCUIT. COORDINATE AND CONFIRM WITH TRADE FOR DETAILS; SEE DETAIL ON DRAWING E4.0 FOR REFERENCE ONLY AND THE LIGHTING FIXTURE SCHEDULE ON DRAWING E0.0.

GENERAL NOTES

ELECTRICAL CONTRACTOR IS TO PROVIDE DEVICE BOXES AND CONDUIT AS REQUIRED FOR LOW VOLTAGE SYSTEMS (ACCESS CONTROL, DOOR OPERATORS, INTERCOMPA SYSTEM). AND INCLUDE THIS WORK IN THE TENDER BID. HAMILTON VIDEO AND SOUND WILL INSTALL WIRING. TERMINATE AND TEST THESE SYSTEMS. UNDER CASH ALLOWANCE.

REVISIONS

No.	Description/Date	ISSUED FOR REVIEW	ISSUED FOR TENDER READY	ISSUED FOR PERMIT AND TENDER	ISSUED FOR PERMIT AND TENDER	ISSUED FOR TENDER AND
1	2025/02/28					
2	2025/03/31					
3	2025/04/17					
4	2025/12/01					

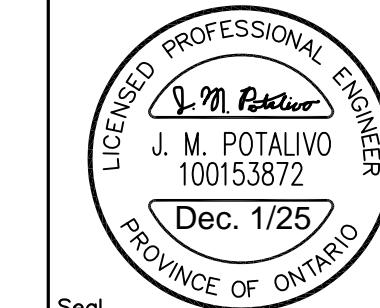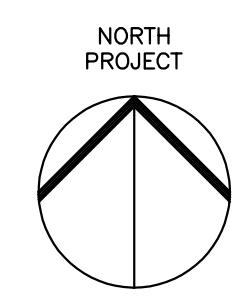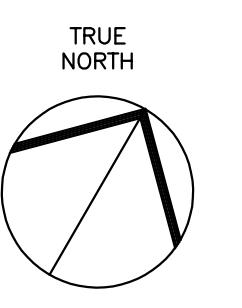


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Project Title: KILBRIDE PUBLIC SCHOOL
6611 PANTON STREET
KILBRIDE, ONTARIO
Drawing Title: ENTRANCE - LIGHTING, POWER & SYSTEMS
DEMOLITION & PROPOSED PLANS



Drawn: AC
Date: FEBRUARY, 2025
Project Number: ALL-25001986-A0
Checked: JP
Date: FEBRUARY, 2025
This Set Contains Drawing Number: E3.0
Drawings Revision

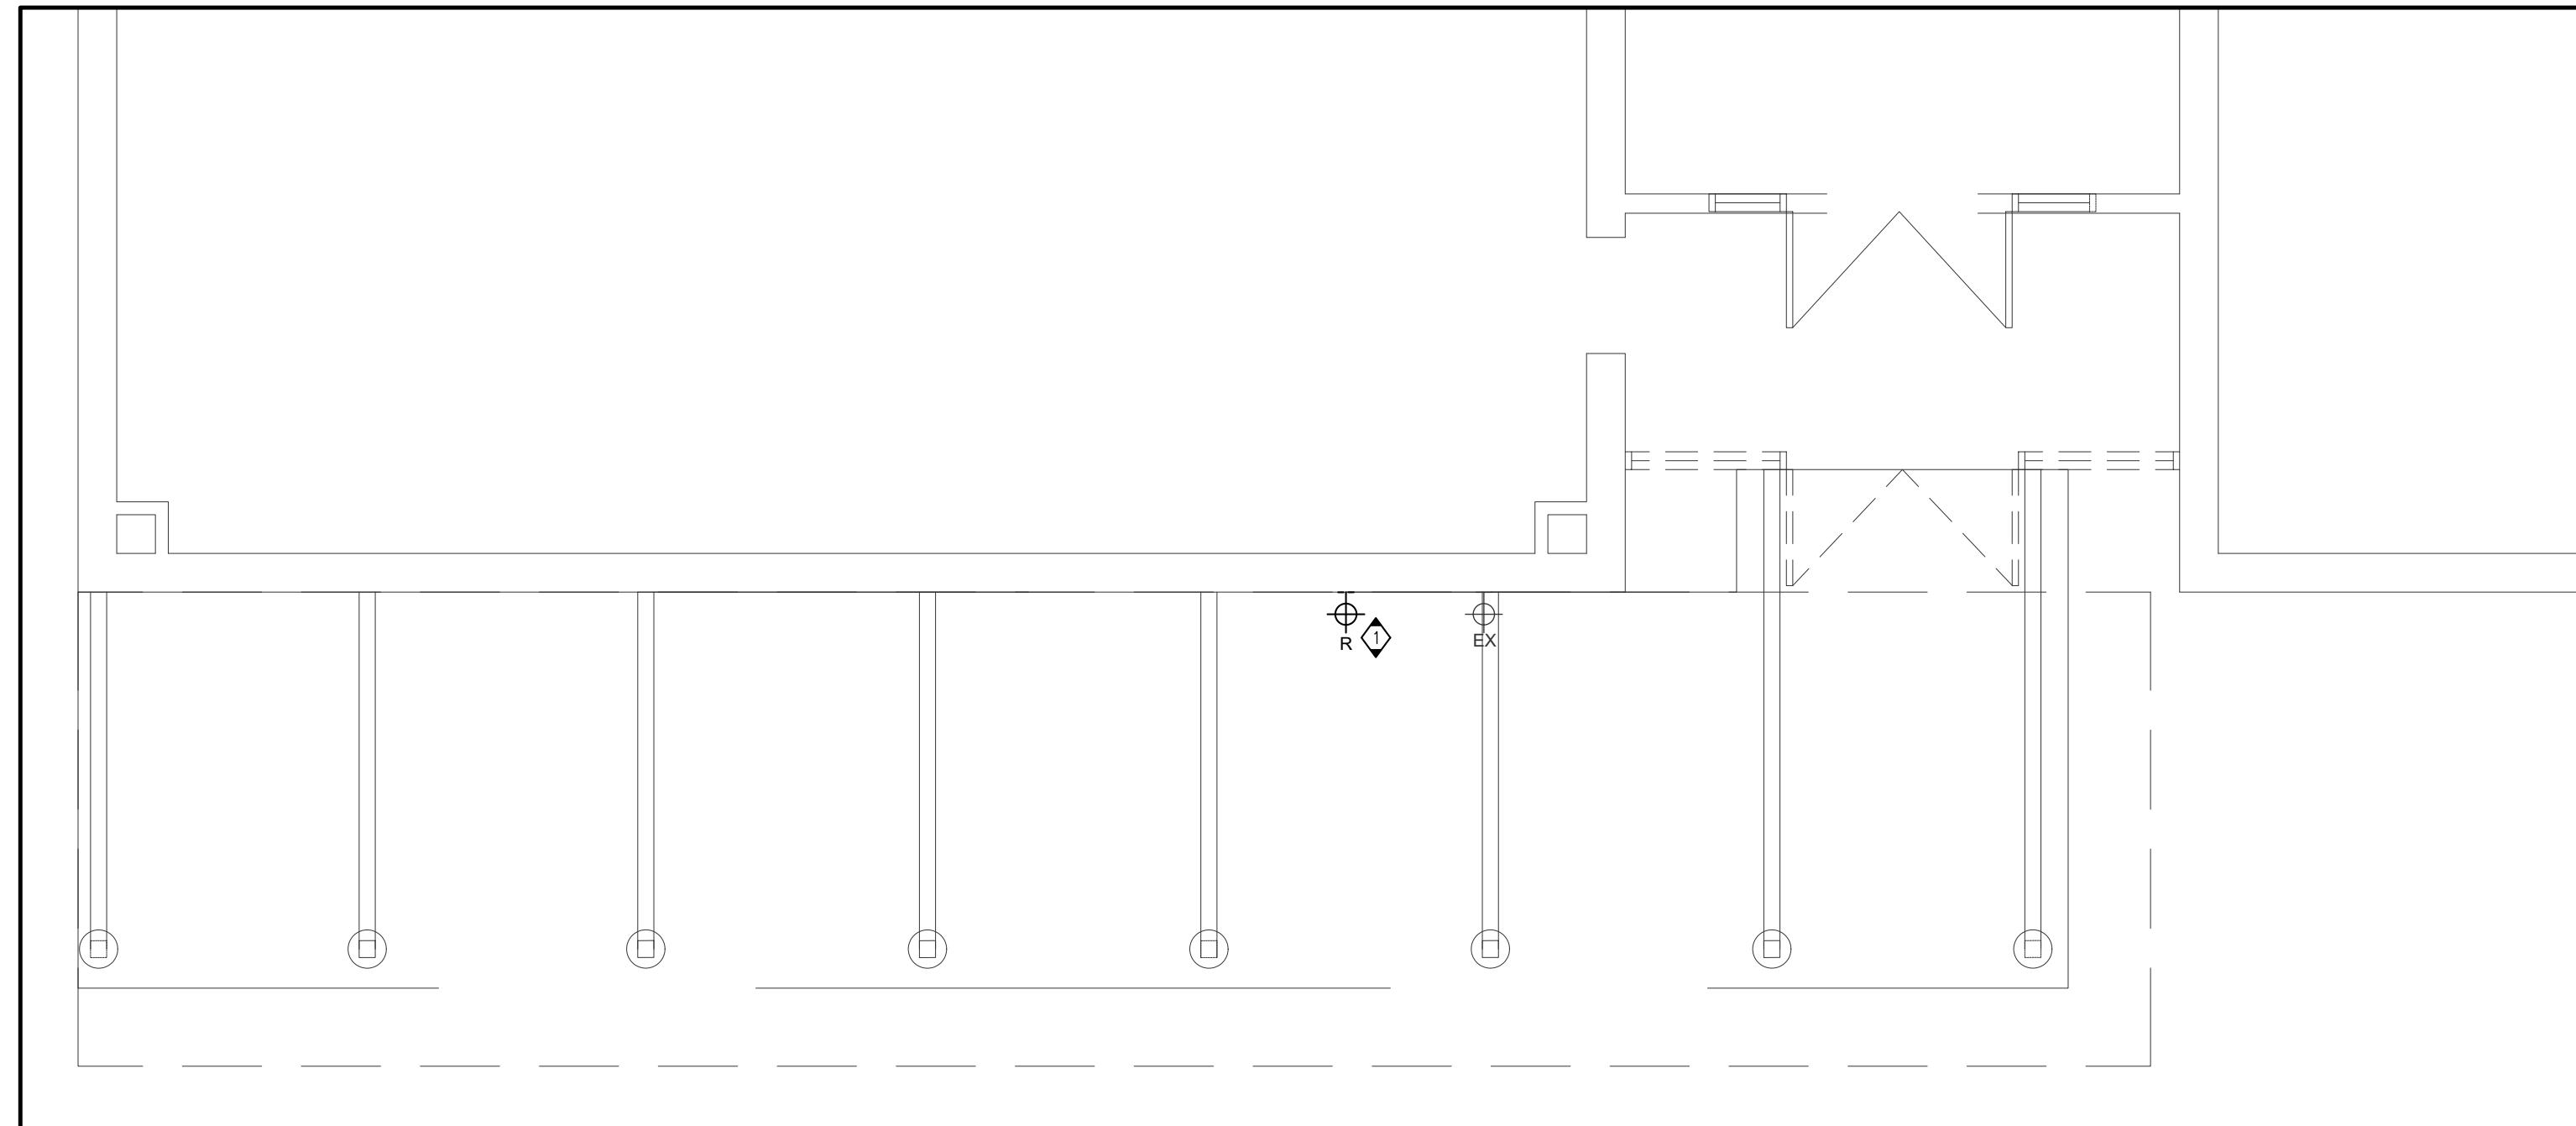

PARTIAL FLOOR PLAN – CANOPY – DEMOLITION LIGHTING PLAN


NORTH
SCALE - 1:50

0 1 2 3 4

DRAWING NOTES

DISCONNECT AND REMOVE WALL MOUNT FIXTURE. RETAIN THE EXISTING CIRCUIT FOR INSTALLATION OF NEW FIXTURE.

GENERAL NOTES

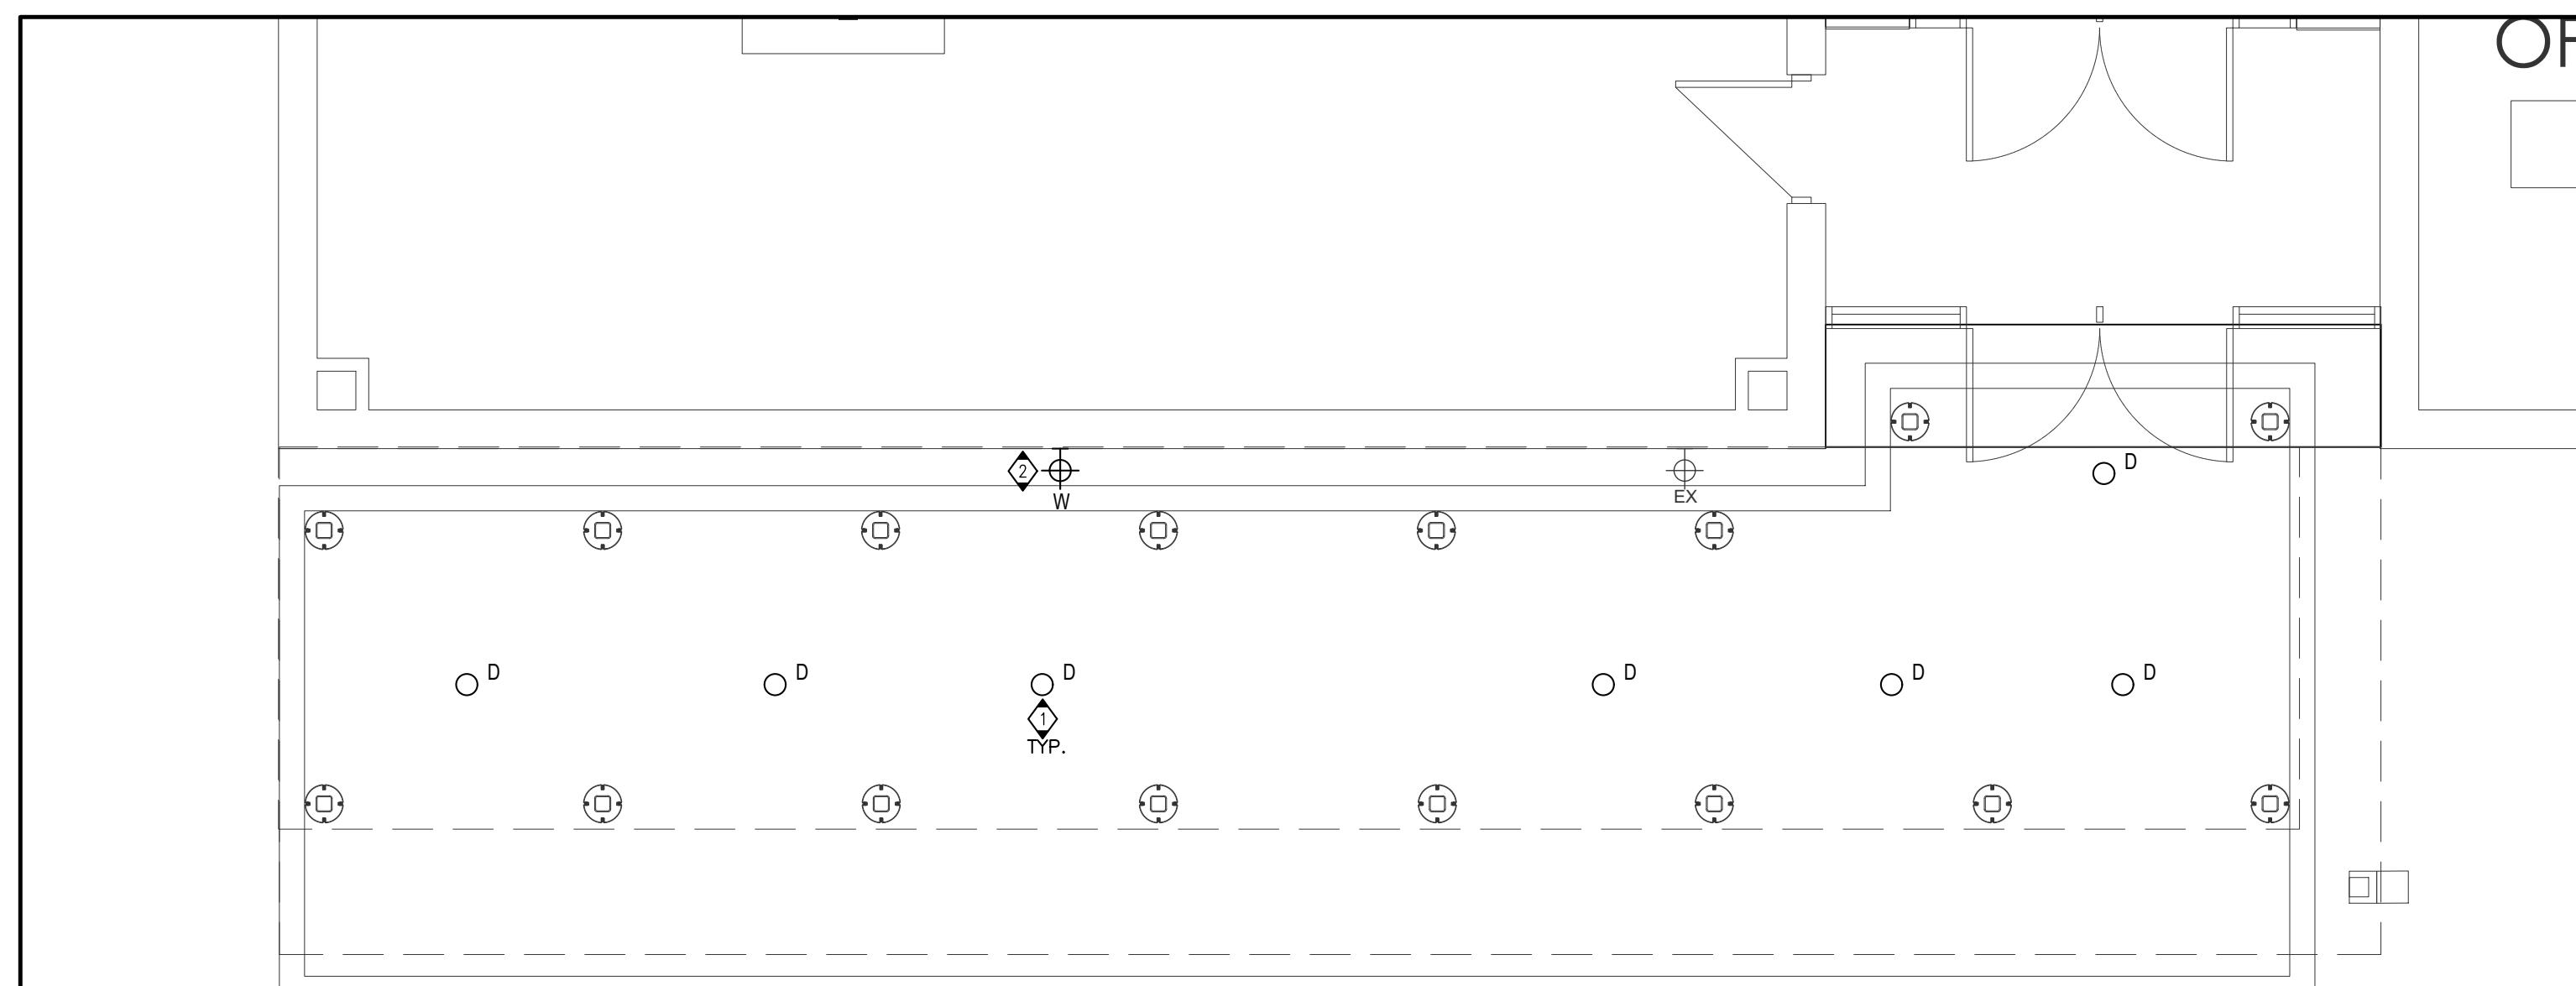

PARTIAL FLOOR PLAN – CANOPY – PROPOSED LIGHTING PLAN

NORTH
SCALE - 1:50


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DRAWING NOTES

CONNECT THE NEW LIGHT FIXTURES TO THE EXISTING WALL PACK CIRCUITS AND TIE INTO EXISTING EXTERIOR LIGHTING CONTROLS.


GENERAL NOTES

INSTALL NEW WALL MOUNT FIXTURE AS SHOWN. PROVIDE ADDITIONAL CONDUIT/WIRING AS REQUIRED TO CONNECT IT TO THE EXISTING WALL PACK CIRCUIT.

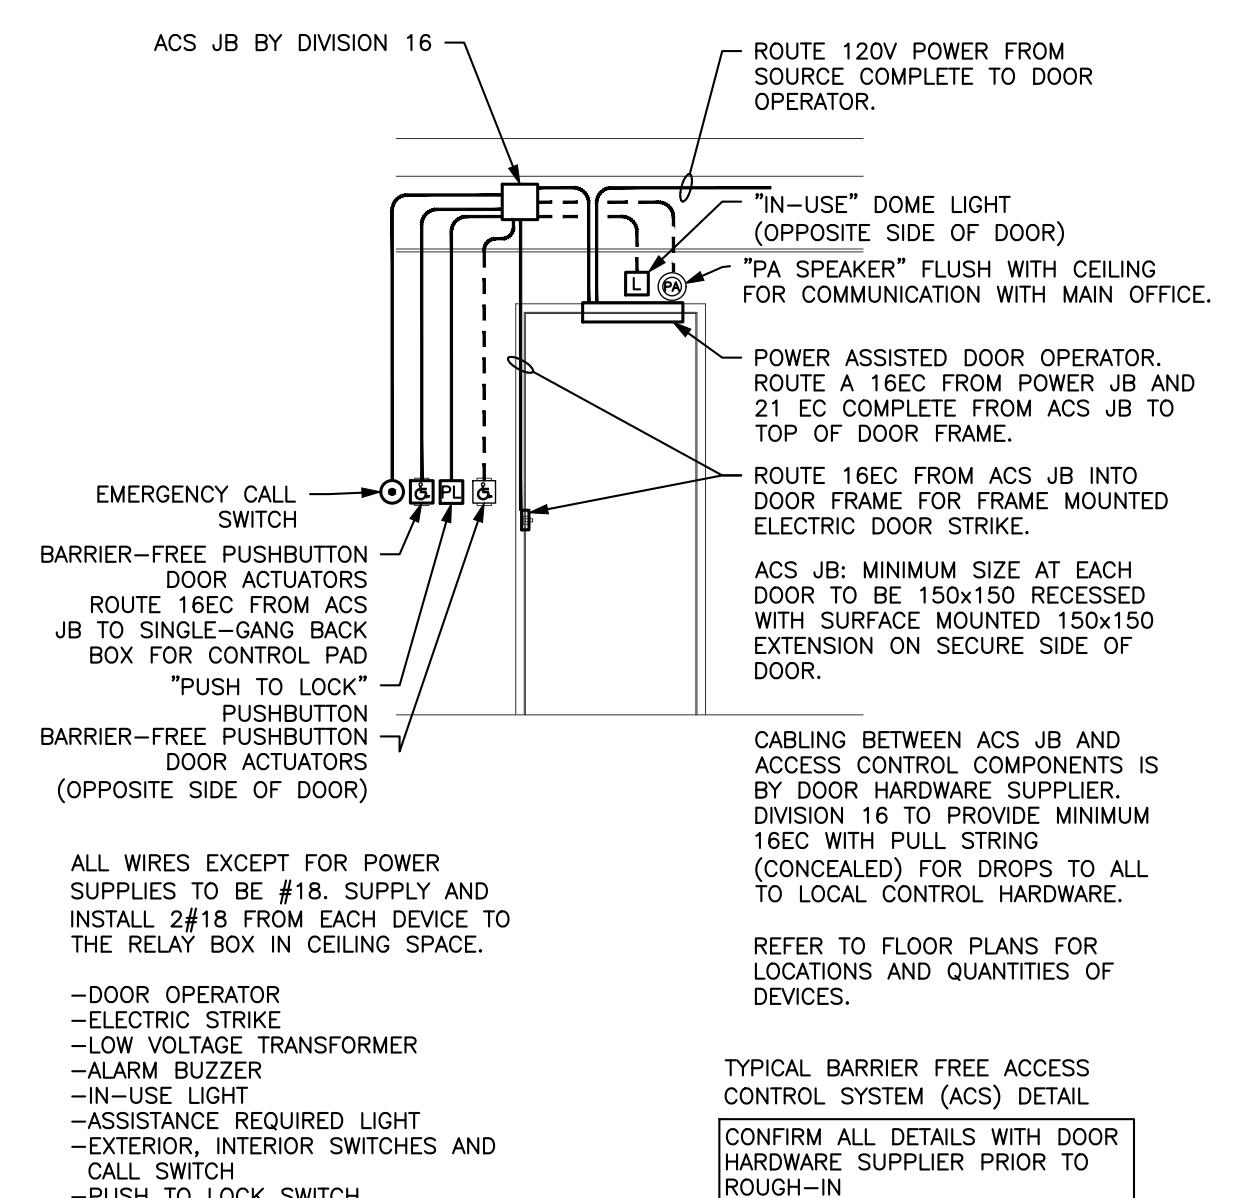

TYPICAL BARRIER FREE WASHROOM MOTOR OPERATED DOOR CONTROL SCHEMATIC

SCALE N.T.S.

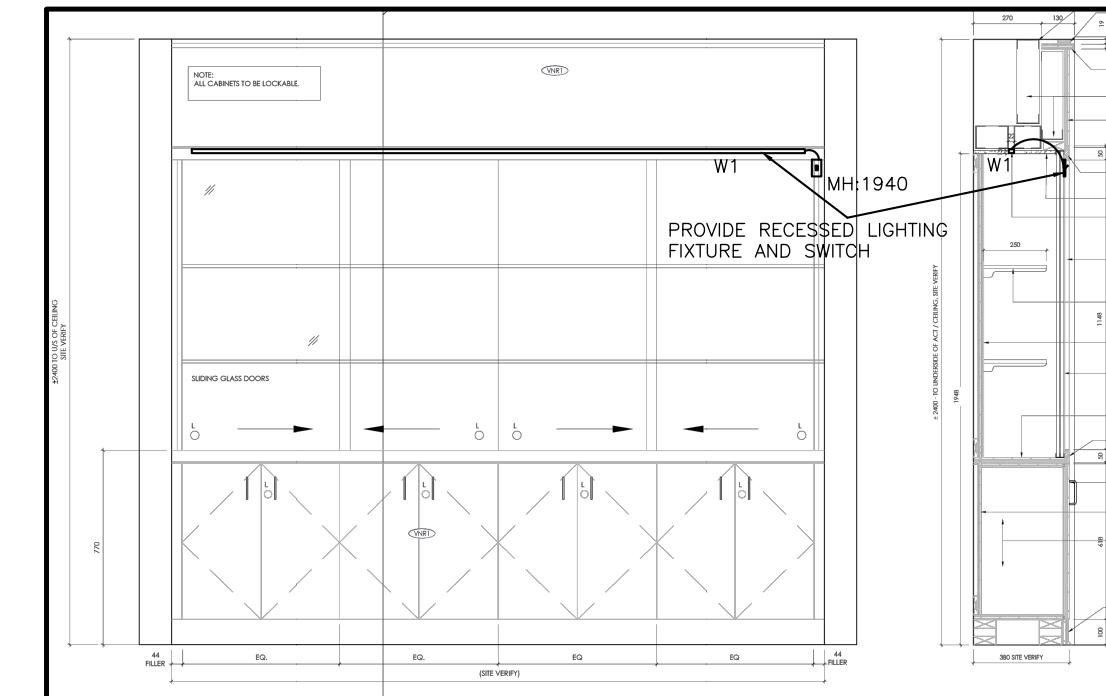


MILLWORK DISPLAY CASE WITH LIGHTING FIXTURE INSTALLED

SCALE N.T.S.

PANEL SCHEDULE																																																																																																																																															
PANEL NAME: LP-H MOUNTING: SURFACE PANEL LOCATION: CORRIDOR MAINS: 100A 120/208V 3Ø 4W BUSING: COPPER OTHER:																																																																																																																																															
42 CIRCUIT PANELBOARD ENCLOSURE: TYPE-1 (SPRINKLER PROOF) SCCR=14KA																																																																																																																																															
<table border="1"> <thead> <tr> <th>LOAD DESCRIPTION</th> <th>VA</th> <th>BRKR 15A</th> <th>BRKR 15A</th> <th>VA</th> <th>LOAD DESCRIPTION</th> </tr> </thead> <tbody> <tr><td>EXISTING LOAD</td><td>-</td><td>1</td><td>15A</td><td>2</td><td>EXISTING LOAD</td></tr> <tr><td>EXISTING LOAD</td><td>-</td><td>3</td><td>15A</td><td>4</td><td>EXISTING LOAD</td></tr> <tr><td>EXISTING LOAD</td><td>-</td><td>5</td><td>15A</td><td>6</td><td>EXISTING LOAD</td></tr> <tr><td>EXISTING LOAD</td><td>-</td><td>7</td><td>15A</td><td>8</td><td>EXISTING LOAD</td></tr> <tr><td>EXISTING LOAD</td><td>-</td><td>9</td><td>15A</td><td>10</td><td>EXISTING LOAD</td></tr> <tr><td>EXISTING LOAD</td><td>-</td><td>11</td><td>15A</td><td>12</td><td>EXISTING LOAD</td></tr> <tr><td>EXISTING LOAD</td><td>-</td><td>13</td><td>15A</td><td>14</td><td>EXISTING LOAD</td></tr> <tr><td>EXISTING LOAD</td><td>-</td><td>15</td><td>15A</td><td>16</td><td>EXISTING LOAD</td></tr> <tr><td>EXISTING LOAD</td><td>-</td><td>17</td><td>15A</td><td>18</td><td>EXISTING LOAD</td></tr> <tr><td>EXISTING LOAD</td><td>-</td><td>19</td><td>15A</td><td>20</td><td>EXISTING LOAD</td></tr> <tr><td>EXISTING LOAD</td><td>-</td><td>21</td><td>15A</td><td>22</td><td>EXISTING LOAD</td></tr> <tr><td>EXISTING LOAD</td><td>-</td><td>23</td><td>15A</td><td>24</td><td>EXISTING LOAD</td></tr> <tr><td>EXISTING LOAD</td><td>-</td><td>25</td><td>15A</td><td>26</td><td>EXISTING LOAD</td></tr> <tr><td>EXISTING LOAD</td><td>-</td><td>27</td><td>15A</td><td>28</td><td>EXISTING LOAD</td></tr> <tr><td>EXISTING LOAD</td><td>-</td><td>29</td><td>15A</td><td>30</td><td>EXISTING LOAD</td></tr> <tr><td>EXISTING LOAD</td><td>-</td><td>31</td><td>15A</td><td>32</td><td>EXISTING LOAD</td></tr> <tr><td>EXISTING LOAD</td><td>-</td><td>33</td><td>15A</td><td>34</td><td>EXISTING LOAD</td></tr> <tr><td>B.F. WASHROOM ADD</td><td>600VA</td><td>35</td><td>15A/20A</td><td>36</td><td>EXISTING LOAD</td></tr> <tr><td>B.F. WR FAUCETS</td><td>50VA</td><td>37A</td><td>15A</td><td>38</td><td>EXISTING LOAD</td></tr> <tr><td>B.F. WR RECEPT.</td><td>180VA</td><td>37B</td><td>15A</td><td>39</td><td>100VA B.F. WR. EMR. CALL KIT</td></tr> <tr><td>B.F. WASHROOM HAND DRYER</td><td>1000VA</td><td>39</td><td>15A</td><td>40</td><td>100VA BOILER CONTROL PANEL</td></tr> <tr><td>CONNECTED LOAD (L.H.)</td><td>-</td><td>41</td><td>-</td><td>-</td><td>CONNECTED LOAD (R.H.)</td></tr> </tbody> </table>						LOAD DESCRIPTION	VA	BRKR 15A	BRKR 15A	VA	LOAD DESCRIPTION	EXISTING LOAD	-	1	15A	2	EXISTING LOAD	EXISTING LOAD	-	3	15A	4	EXISTING LOAD	EXISTING LOAD	-	5	15A	6	EXISTING LOAD	EXISTING LOAD	-	7	15A	8	EXISTING LOAD	EXISTING LOAD	-	9	15A	10	EXISTING LOAD	EXISTING LOAD	-	11	15A	12	EXISTING LOAD	EXISTING LOAD	-	13	15A	14	EXISTING LOAD	EXISTING LOAD	-	15	15A	16	EXISTING LOAD	EXISTING LOAD	-	17	15A	18	EXISTING LOAD	EXISTING LOAD	-	19	15A	20	EXISTING LOAD	EXISTING LOAD	-	21	15A	22	EXISTING LOAD	EXISTING LOAD	-	23	15A	24	EXISTING LOAD	EXISTING LOAD	-	25	15A	26	EXISTING LOAD	EXISTING LOAD	-	27	15A	28	EXISTING LOAD	EXISTING LOAD	-	29	15A	30	EXISTING LOAD	EXISTING LOAD	-	31	15A	32	EXISTING LOAD	EXISTING LOAD	-	33	15A	34	EXISTING LOAD	B.F. WASHROOM ADD	600VA	35	15A/20A	36	EXISTING LOAD	B.F. WR FAUCETS	50VA	37A	15A	38	EXISTING LOAD	B.F. WR RECEPT.	180VA	37B	15A	39	100VA B.F. WR. EMR. CALL KIT	B.F. WASHROOM HAND DRYER	1000VA	39	15A	40	100VA BOILER CONTROL PANEL	CONNECTED LOAD (L.H.)	-	41	-	-	CONNECTED LOAD (R.H.)
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Dec. 1/25
Seal EV

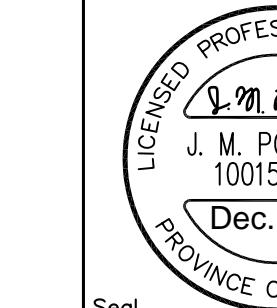

Project Title: KILBRIDE PUBLIC SCHOOL
6611 PANTON STREET
KILBRIDE, ONTARIO
Drawing Title: CANOPY LIGHTING PLAN & DETAILS

Drawn: AC
Date: FEBRUARY, 2025
Scale: AS NOTED
Project Number: ALL-25001986-A0
This Set Contains Drawing Number: E4.0
Drawings Revision