

Architects

2050 Guelph Line Burlington, ON.


Snyder Architects Inc. 100 Broadview Ave, Suite 301, Toronto, ON M4M 3H3 t. 416.966.5444, w. snyderarchitects.ca




The contractor shall verify all dimensions and report all errors and discrepancies to the Consultant before commencement of the work. The drawings show general arrangement of services. Follow as closely as actual building construction will permit. Obtain approval for relocation of services for the services of services. commencement of the work. The drawings do not indicate all offsets fitting and accessories which may be required. Provide the same to meet the required conditions. Drawings and specifications, etc., prepared and issued by the consultant are the property of the consultant and must be returned at the completion of the project. These documents are not to be duplicated or copied without the consent of the Consultant.

Do not scale this drawing. © 2024 DEI Consulting Engineers Inc.


As Built Drawings

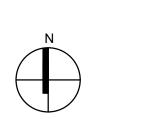

True North Date ISSUED FOR CONSTRUCTION ISSUED FOR SPA SUBMISSION 2024.02.2 ISSUED FOR SPA REVIEW SET 2024.02.0

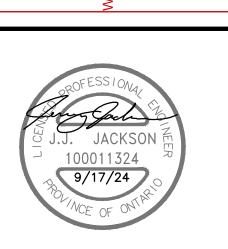

LEGEND, SITE PLAN, NOTES AND KEY

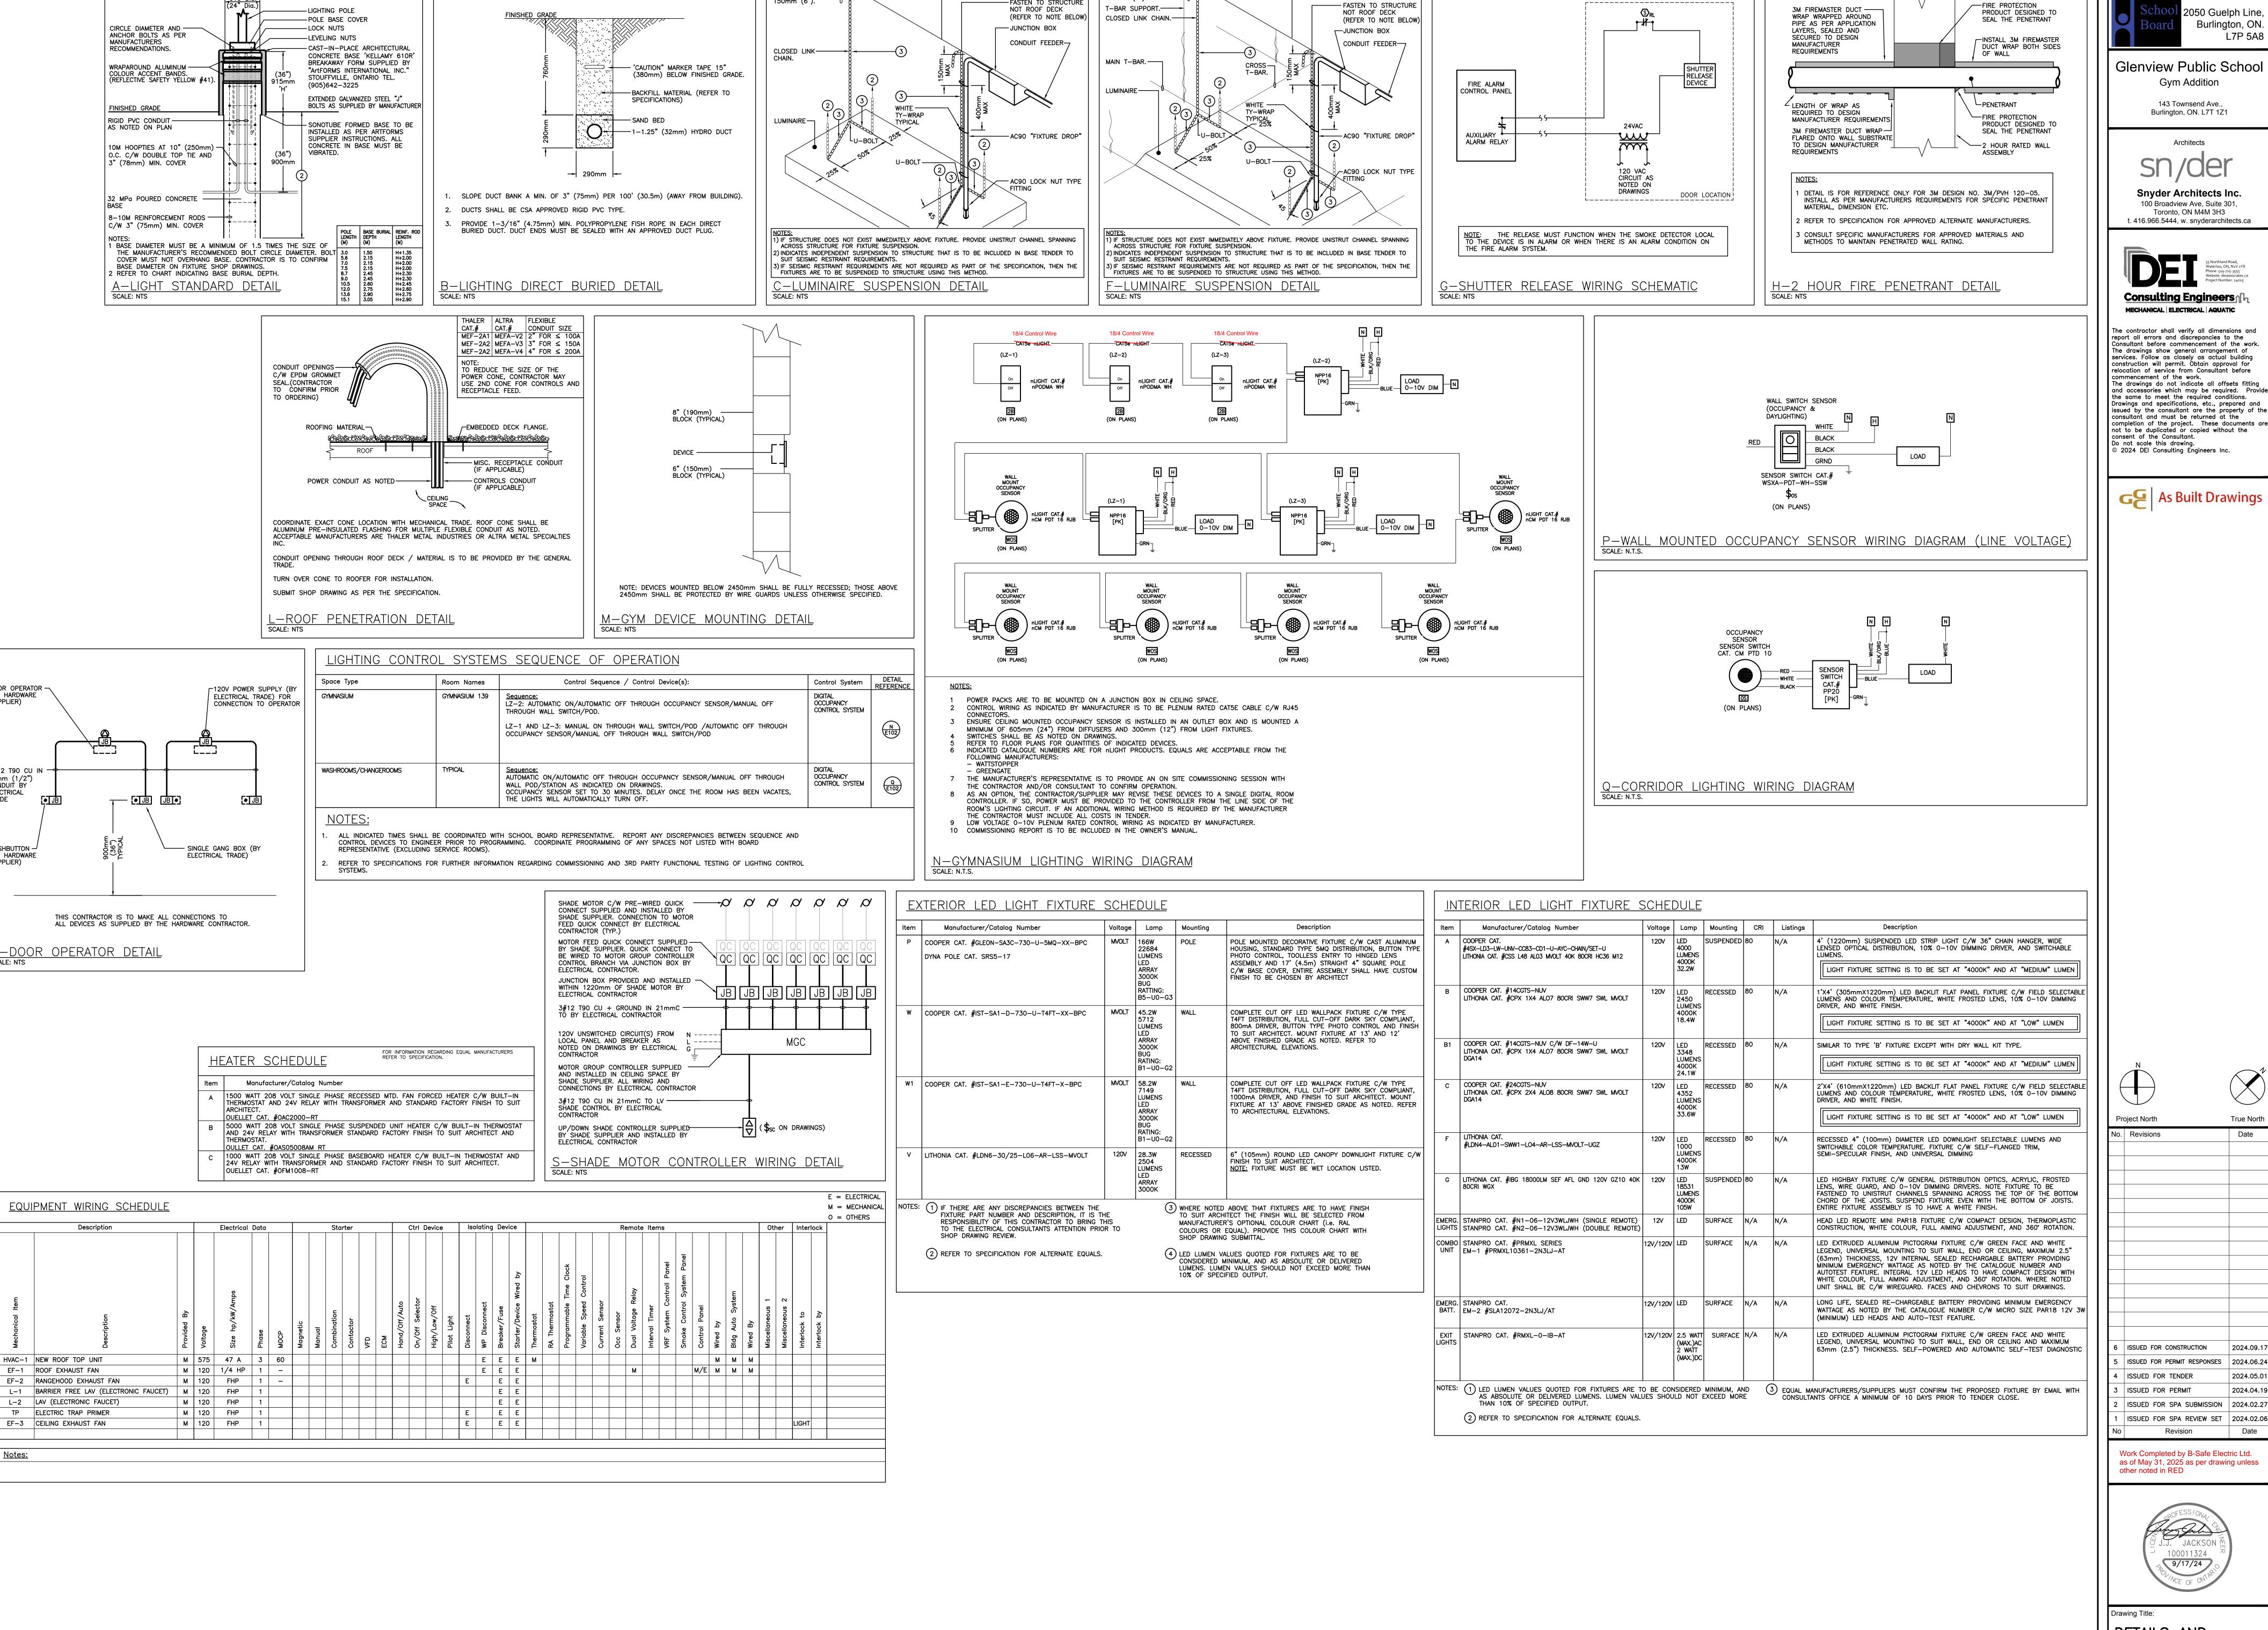

-STRUCTURE(1)

NOT ROOF DECK

150mm (6").

BY HARDWARE

SUPPLIER)

CONDUIT BY

PUSHBUTTON -

(BY HARDWARE SUPPLIER)

<u>Notes:</u>

ELECTRICAL

LOOP CHAIN -

150mm (6").

T-BAR SUPPORT. ----

· STRUCTURE (1)

— FASTEN TO STRUCTURE

2050 Guelph Line

3M FIREMASTER DUCT ——




The contractor shall verify all dimensions and report all errors and discrepancies to the Consultant before commencement of the work. The drawings show general arrangement of services. Follow as closely as actual building construction will permit. Obtain approval for relocation of service from Consultant before The drawings do not indicate all offsets fitting and accessories which may be required. Provide the same to meet the required conditions. Drawings and specifications, etc., prepared and issued by the consultant are the property of the consultant and must be returned at the completion of the project. These documents a not to be duplicated or copied without the consent of the Consultant.


G As Built Drawings

True North Date 2024.09.17 ISSUED FOR PERMIT RESPONSES 2024.06.24 2024.05.01 2024.04.19 ISSUED FOR SPA SUBMISSION 2024.02.27

DETAILS AND SCHEDULES

Scale: AS NOTED Date: MAY 2024 Checked by: RV Drawn by: SB Job No.

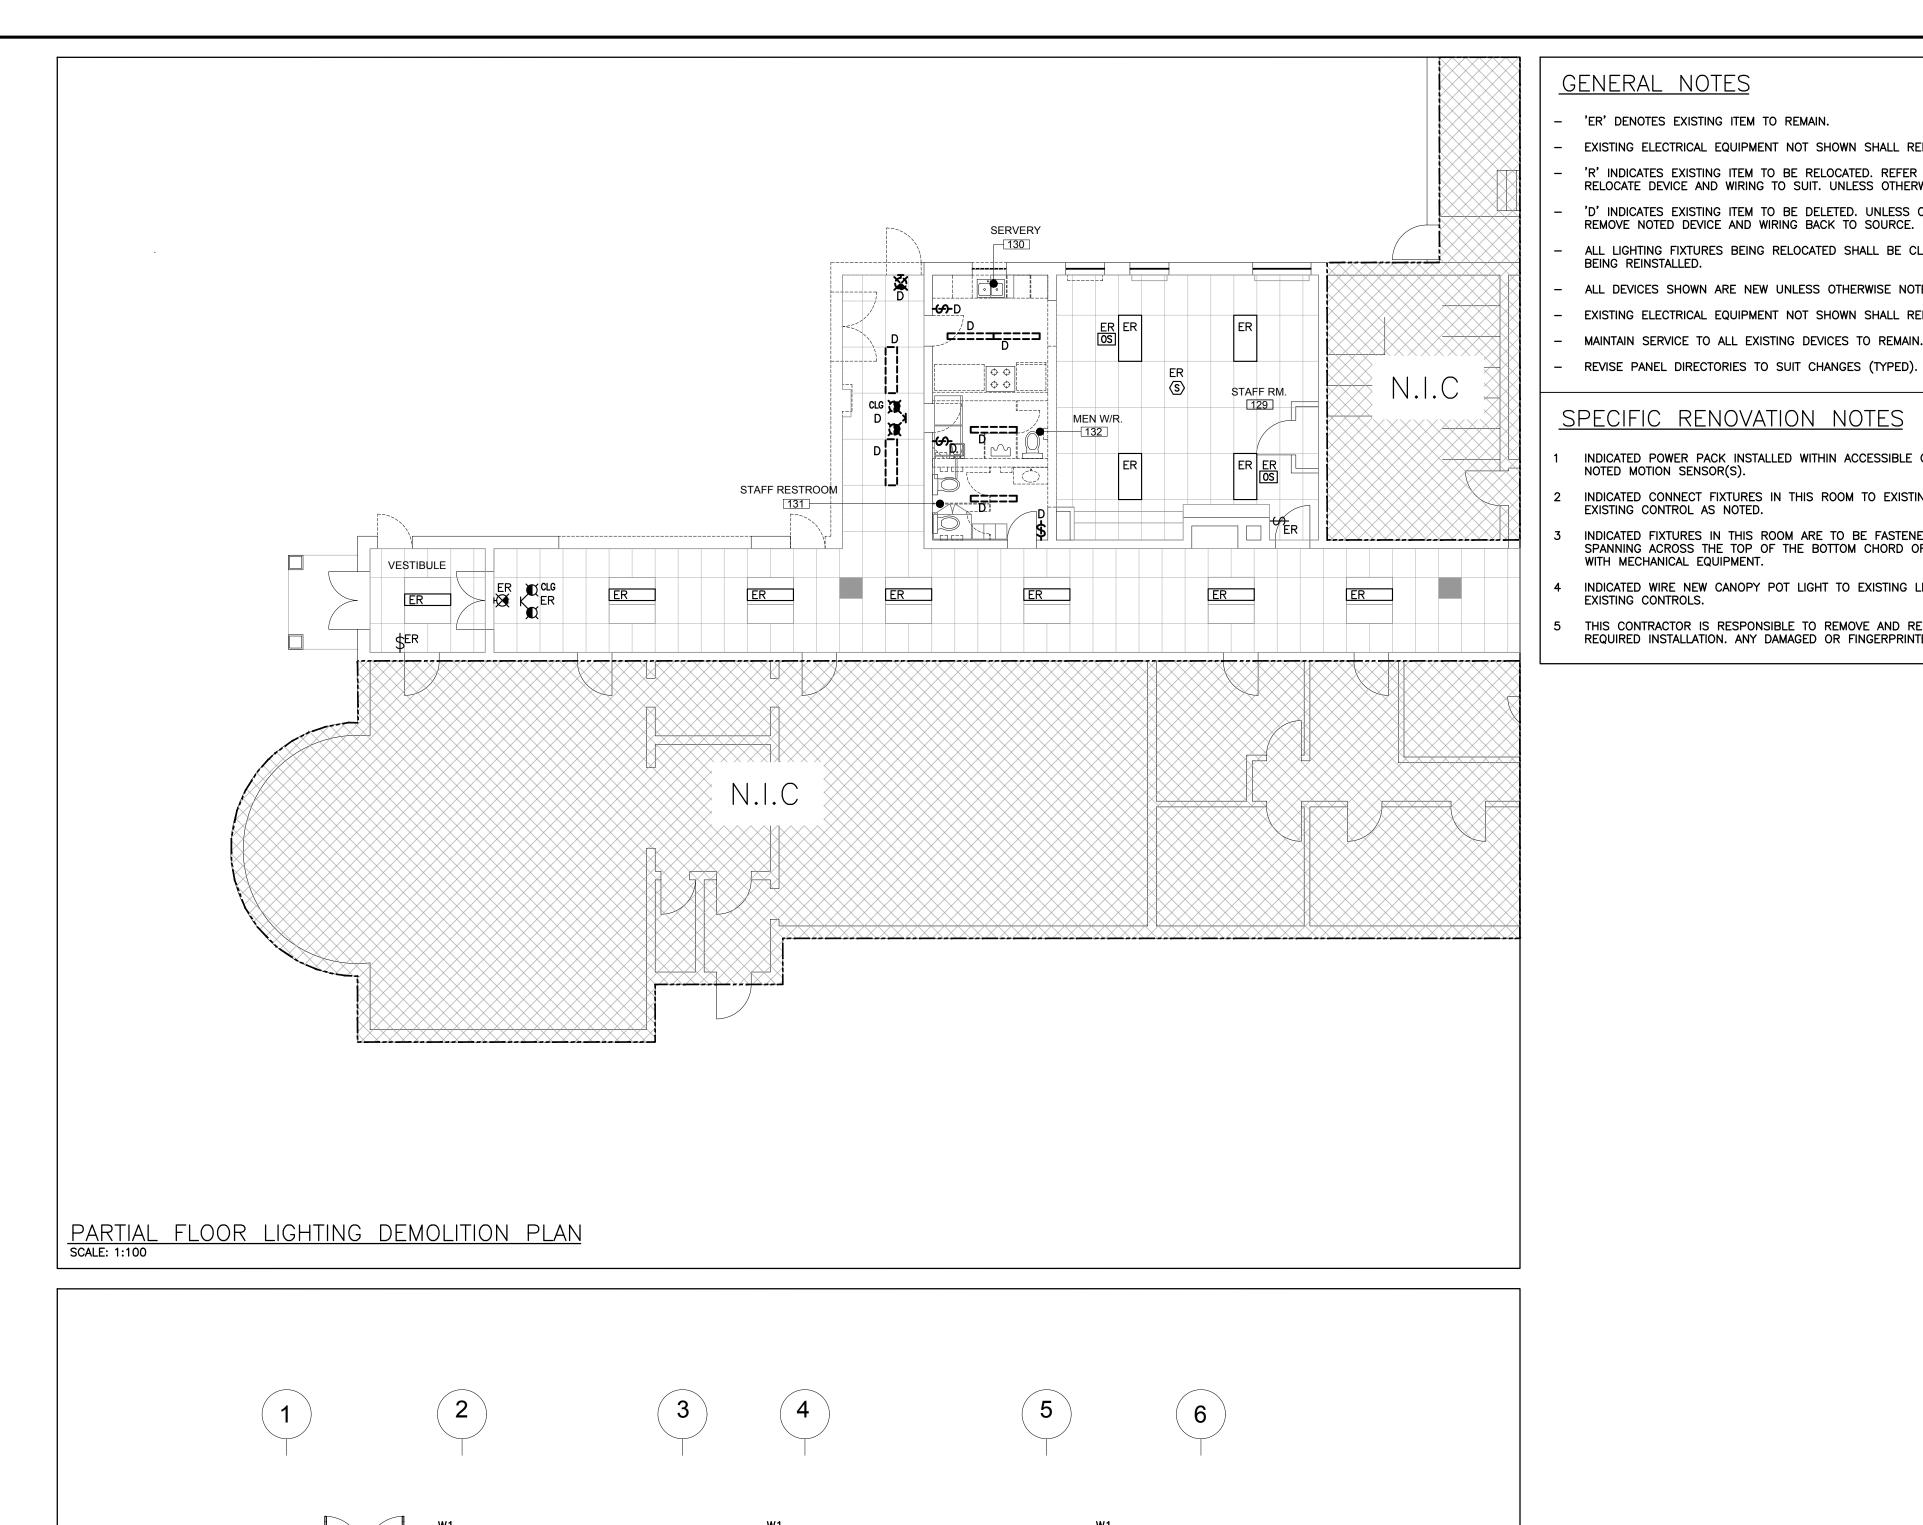

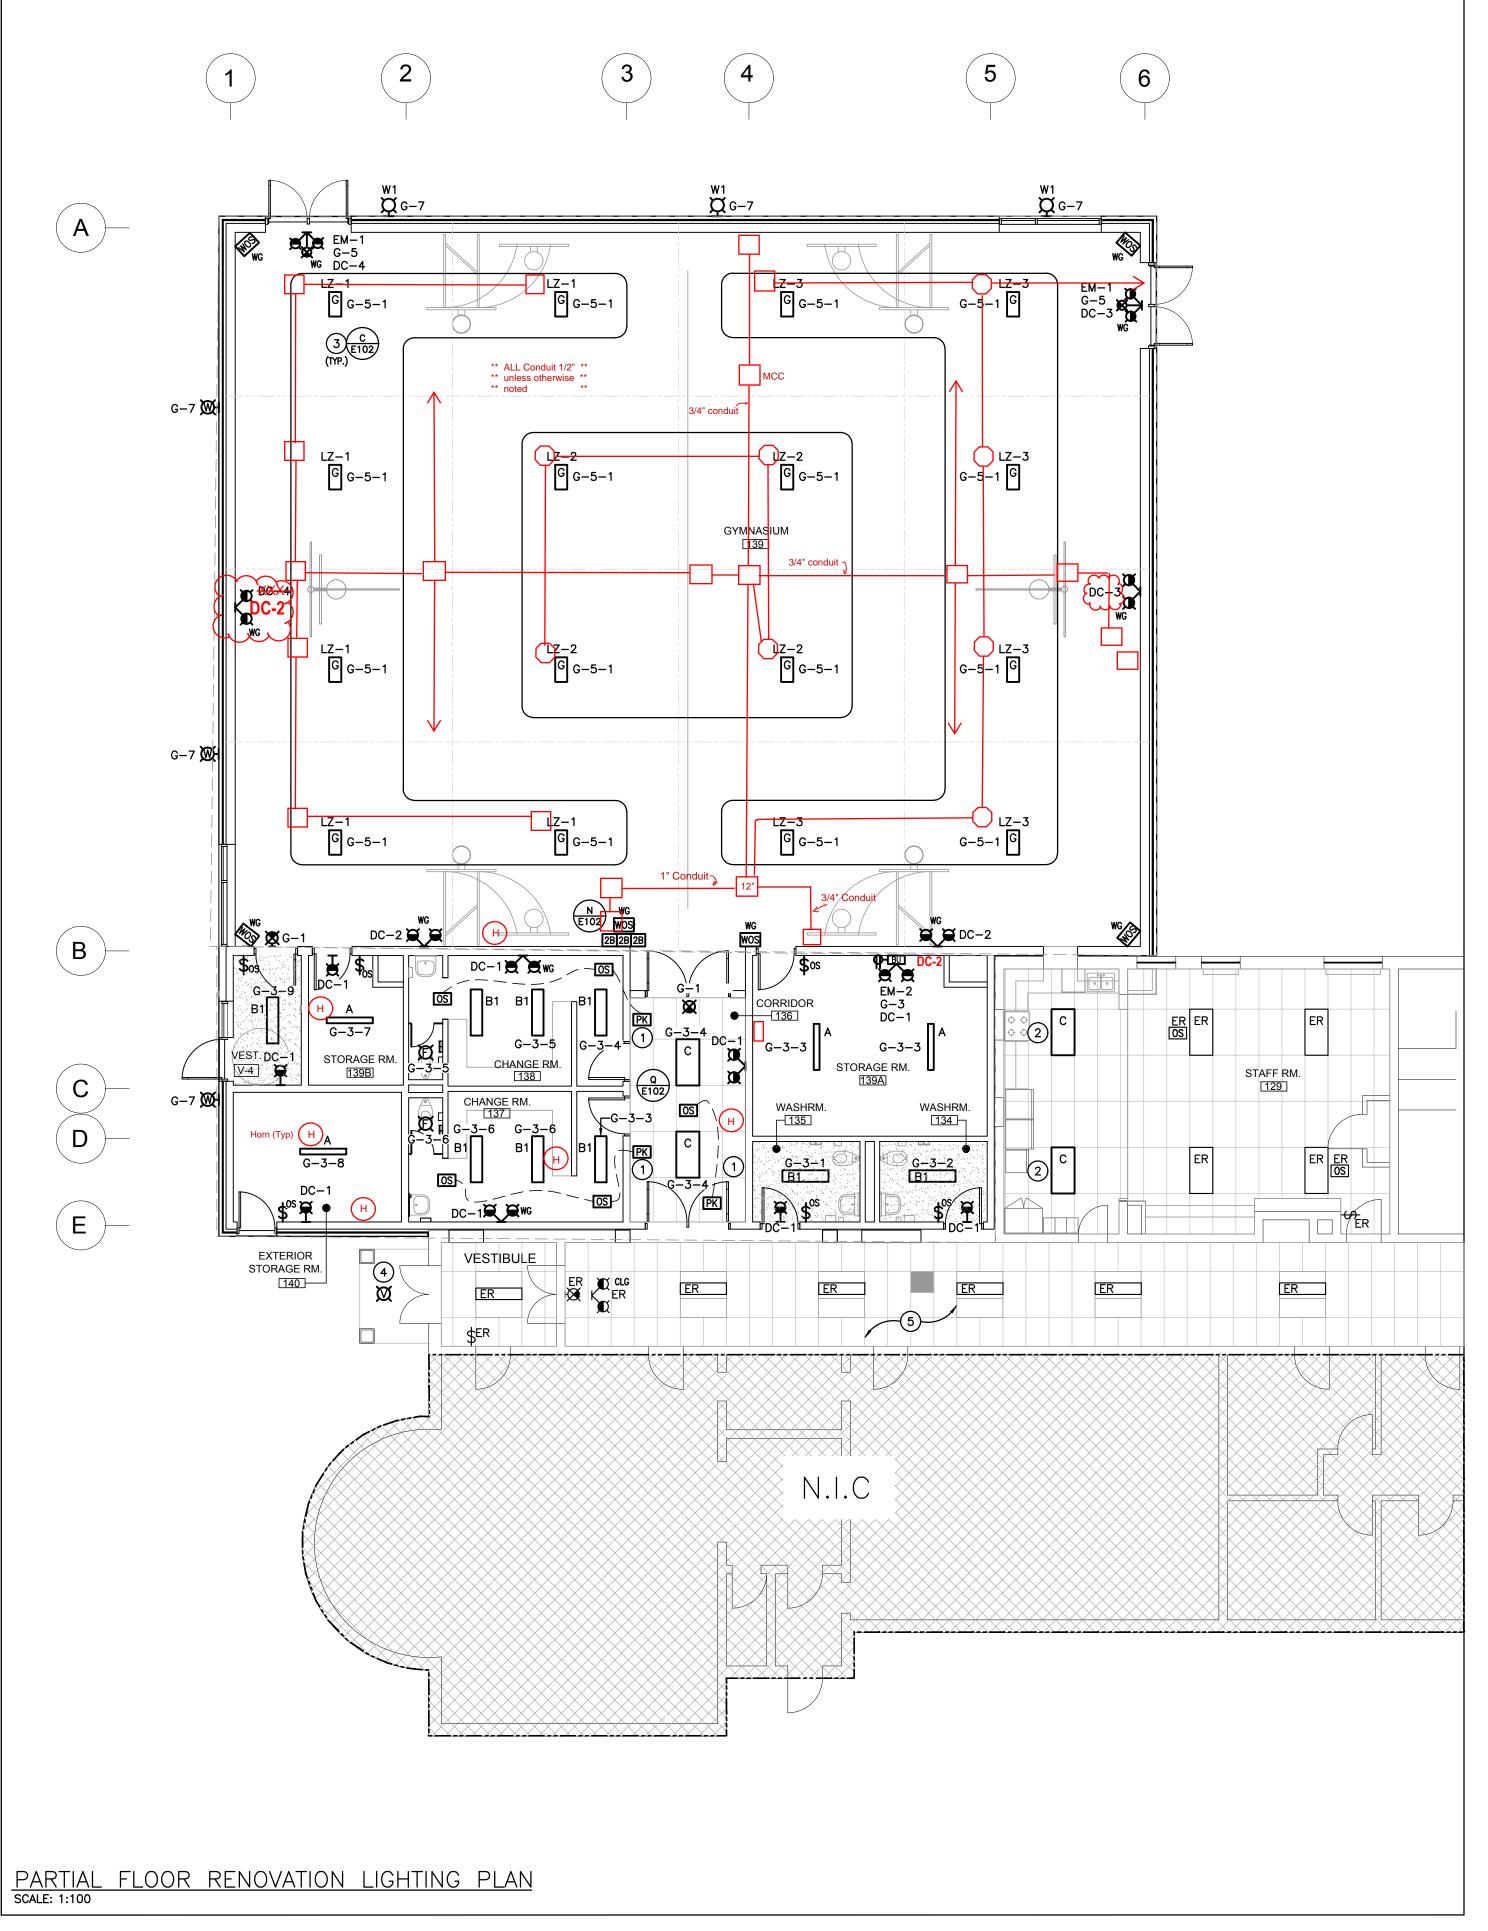

GENERAL NOTES

- 'ER' DENOTES EXISTING ITEM TO REMAIN.
- EXISTING ELECTRICAL EQUIPMENT NOT SHOWN SHALL REMAIN UNLESS NOTED OTHERWISE. 'R' INDICATES EXISTING ITEM TO BE RELOCATED. REFER TO RENOVATION DRAWINGS AND RELOCATE DEVICE AND WIRING TO SUIT. UNLESS OTHERWISE NOTED. 'D' INDICATES EXISTING ITEM TO BE DELETED. UNLESS OTHERWISE NOTED DISCONNECT AND
- REMOVE NOTED DEVICE AND WIRING BACK TO SOURCE. ALL LIGHTING FIXTURES BEING RELOCATED SHALL BE CLEANED AND CHECKED PRIOR TO BEING REINSTALLED. ALL DEVICES SHOWN ARE NEW UNLESS OTHERWISE NOTED.
- EXISTING ELECTRICAL EQUIPMENT NOT SHOWN SHALL REMAIN UNLESS OTHERWISE NOTED. MAINTAIN SERVICE TO ALL EXISTING DEVICES TO REMAIN.

SPECIFIC RENOVATION NOTES

- INDICATED POWER PACK INSTALLED WITHIN ACCESSIBLE CEILING SPACE FOR CONTROL OF NOTED MOTION SENSOR(S).
- INDICATED CONNECT FIXTURES IN THIS ROOM TO EXISTING LOCAL LIGHTING CIRCUIT AND EXISTING CONTROL AS NOTED.
- INDICATED FIXTURES IN THIS ROOM ARE TO BE FASTENED TO UNISTRUT CHANNELS SPANNING ACROSS THE TOP OF THE BOTTOM CHORD OF JOISTS. COORDINATE LOCATION
- WITH MECHANICAL EQUIPMENT. INDICATED WIRE NEW CANOPY POT LIGHT TO EXISTING LIGHTING CIRCUIT. CONTROL VIA
- THIS CONTRACTOR IS RESPONSIBLE TO REMOVE AND RE-INSTALL CEILING TILE TO SUIT REQUIRED INSTALLATION. ANY DAMAGED OR FINGERPRINTED TILE MUST BE REPLACED.

Snyder Architects Inc. 100 Broadview Ave, Suite 301, Toronto, ON M4M 3H3 t. 416.966.5444, w. snyderarchitects.ca

Glenview Public School

Gym Addition

143 Townsend Ave.,

Burlington, ON. L7T 1Z1

Architects

2050 Guelph Line,

Burlington, ON.

L7P 5A8



The contractor shall verify all dimensions and

The contractor shall verify all dimensions and report all errors and discrepancies to the Consultant before commencement of the work. The drawings show general arrangement of services. Follow as closely as actual building construction will permit. Obtain approval for relocation of service from Consultant before commencement of the work.


The drawings do not indicate all offsets fitting and accessories which may be required. Provide the same to meet the required conditions. the same to meet the required conditions.

Drawings and specifications, etc., prepared and issued by the consultant are the property of the consultant and must be returned at the completion of the project. These documents are not to be duplicated or copied without the consent of the Consultant.

Do not scale this drawing.

© 2024 DEI Consulting Engineers Inc.


As Built Drawings

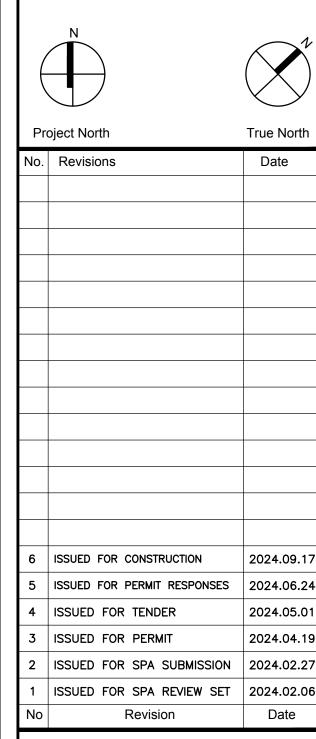


Work Completed by B-Safe Electric Ltd. as of May 31, 2025 as per drawing unless other noted in RED

PARTIAL FLOOR PLAN LIGHTING DEMOLITION AND RENOVATION

23	1	5 2	\cap 1	
Job No.		Drawin	g No.	
Drawn by:	SB	Checke	ed by:	RV
Scale: AS	NOTED	Date:	MAY	2024

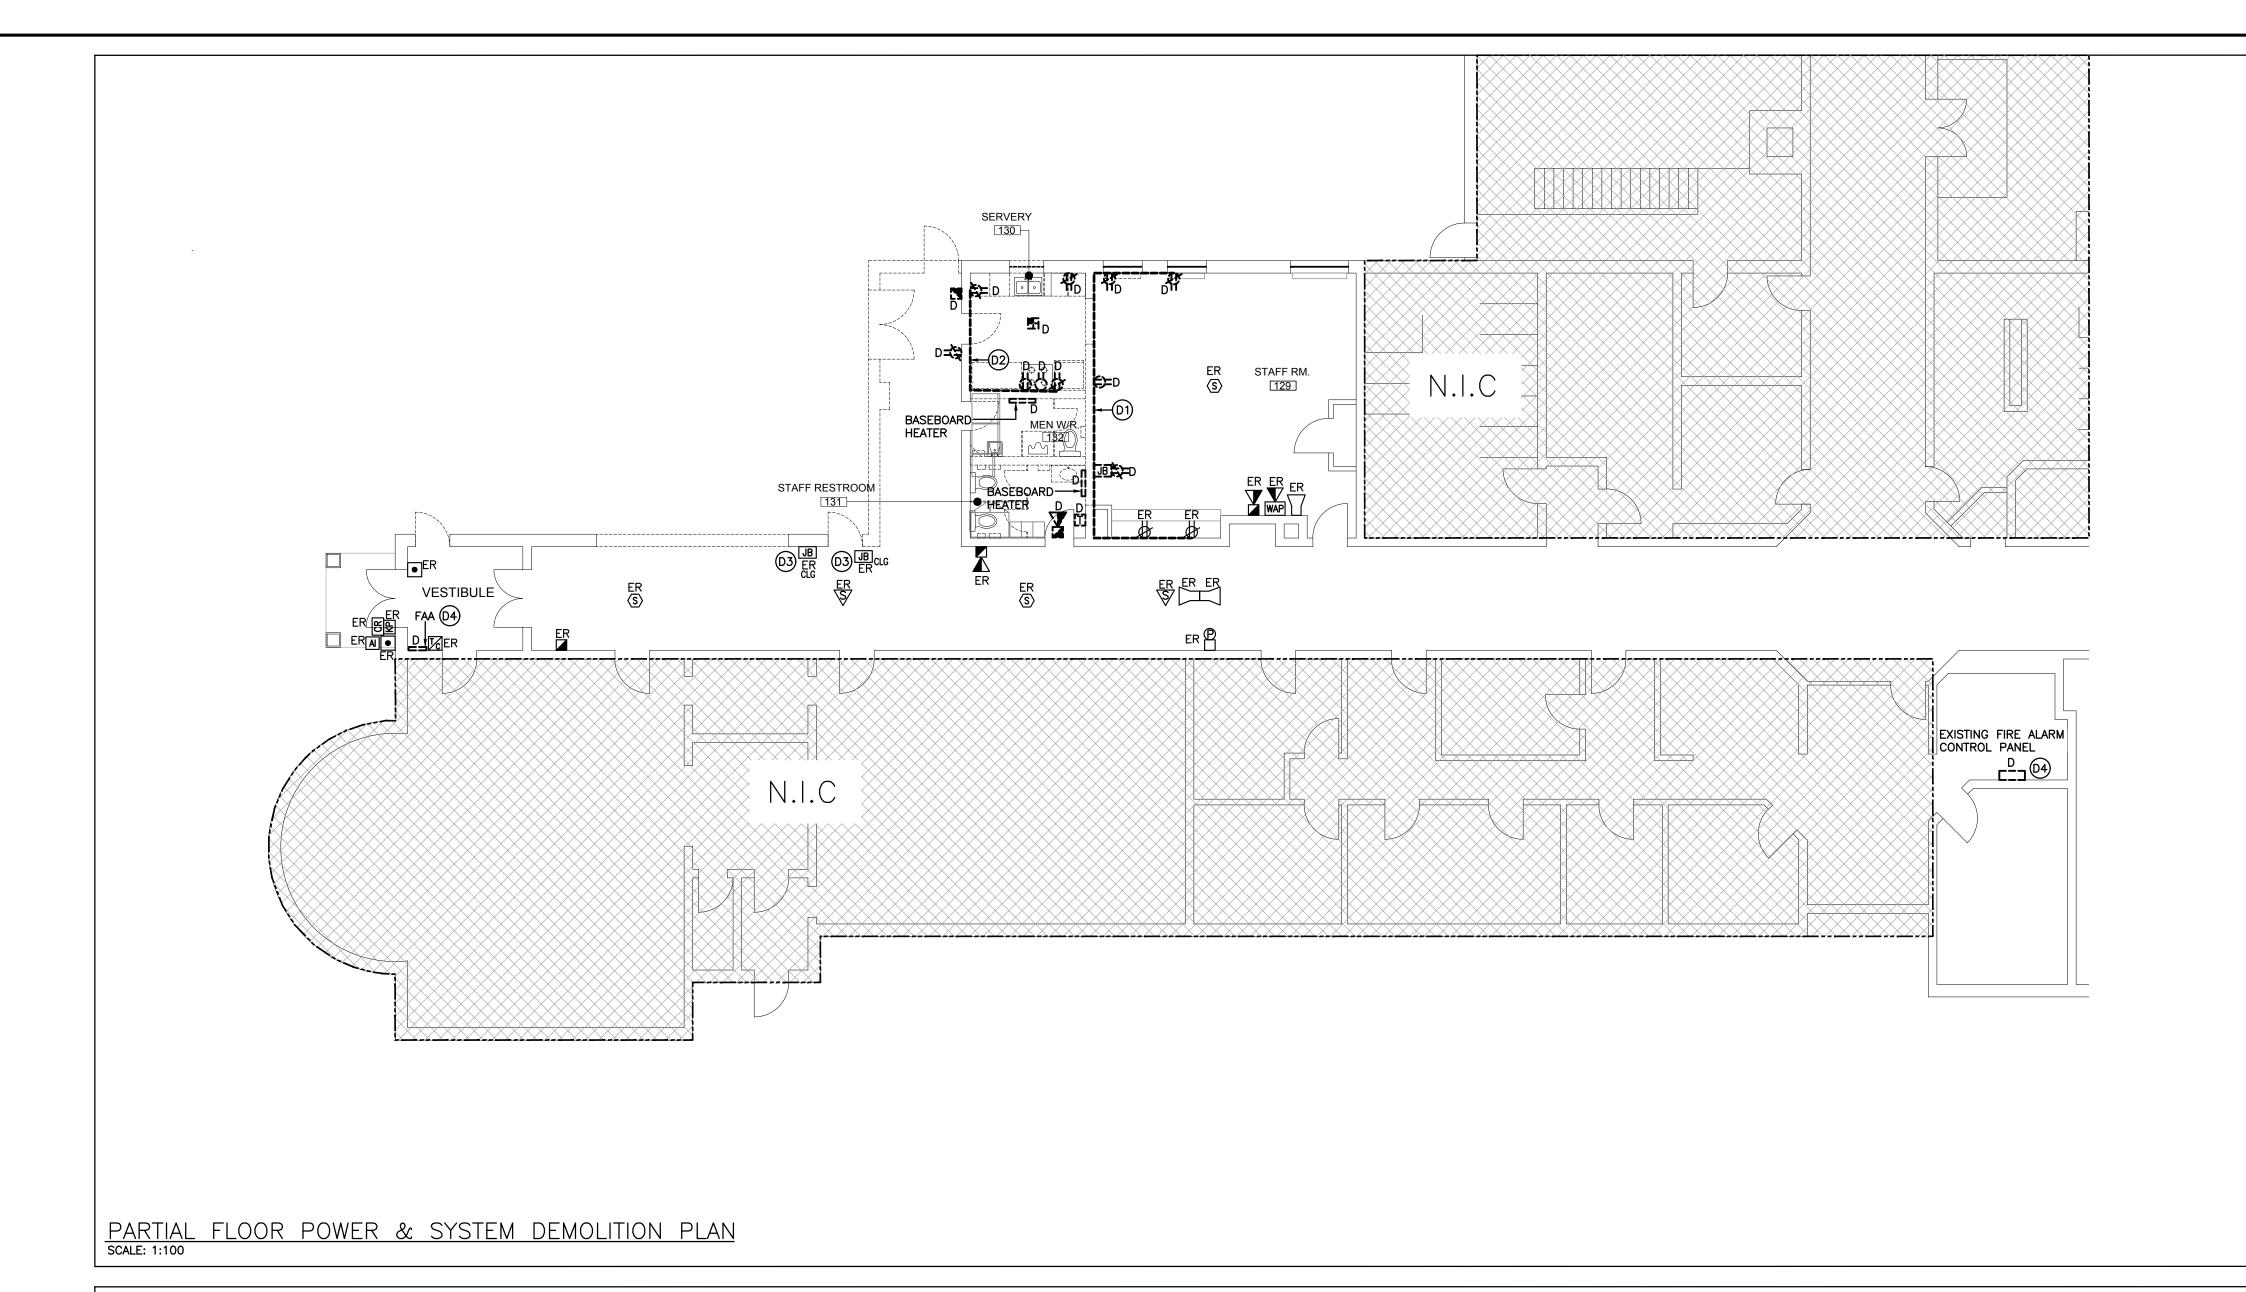

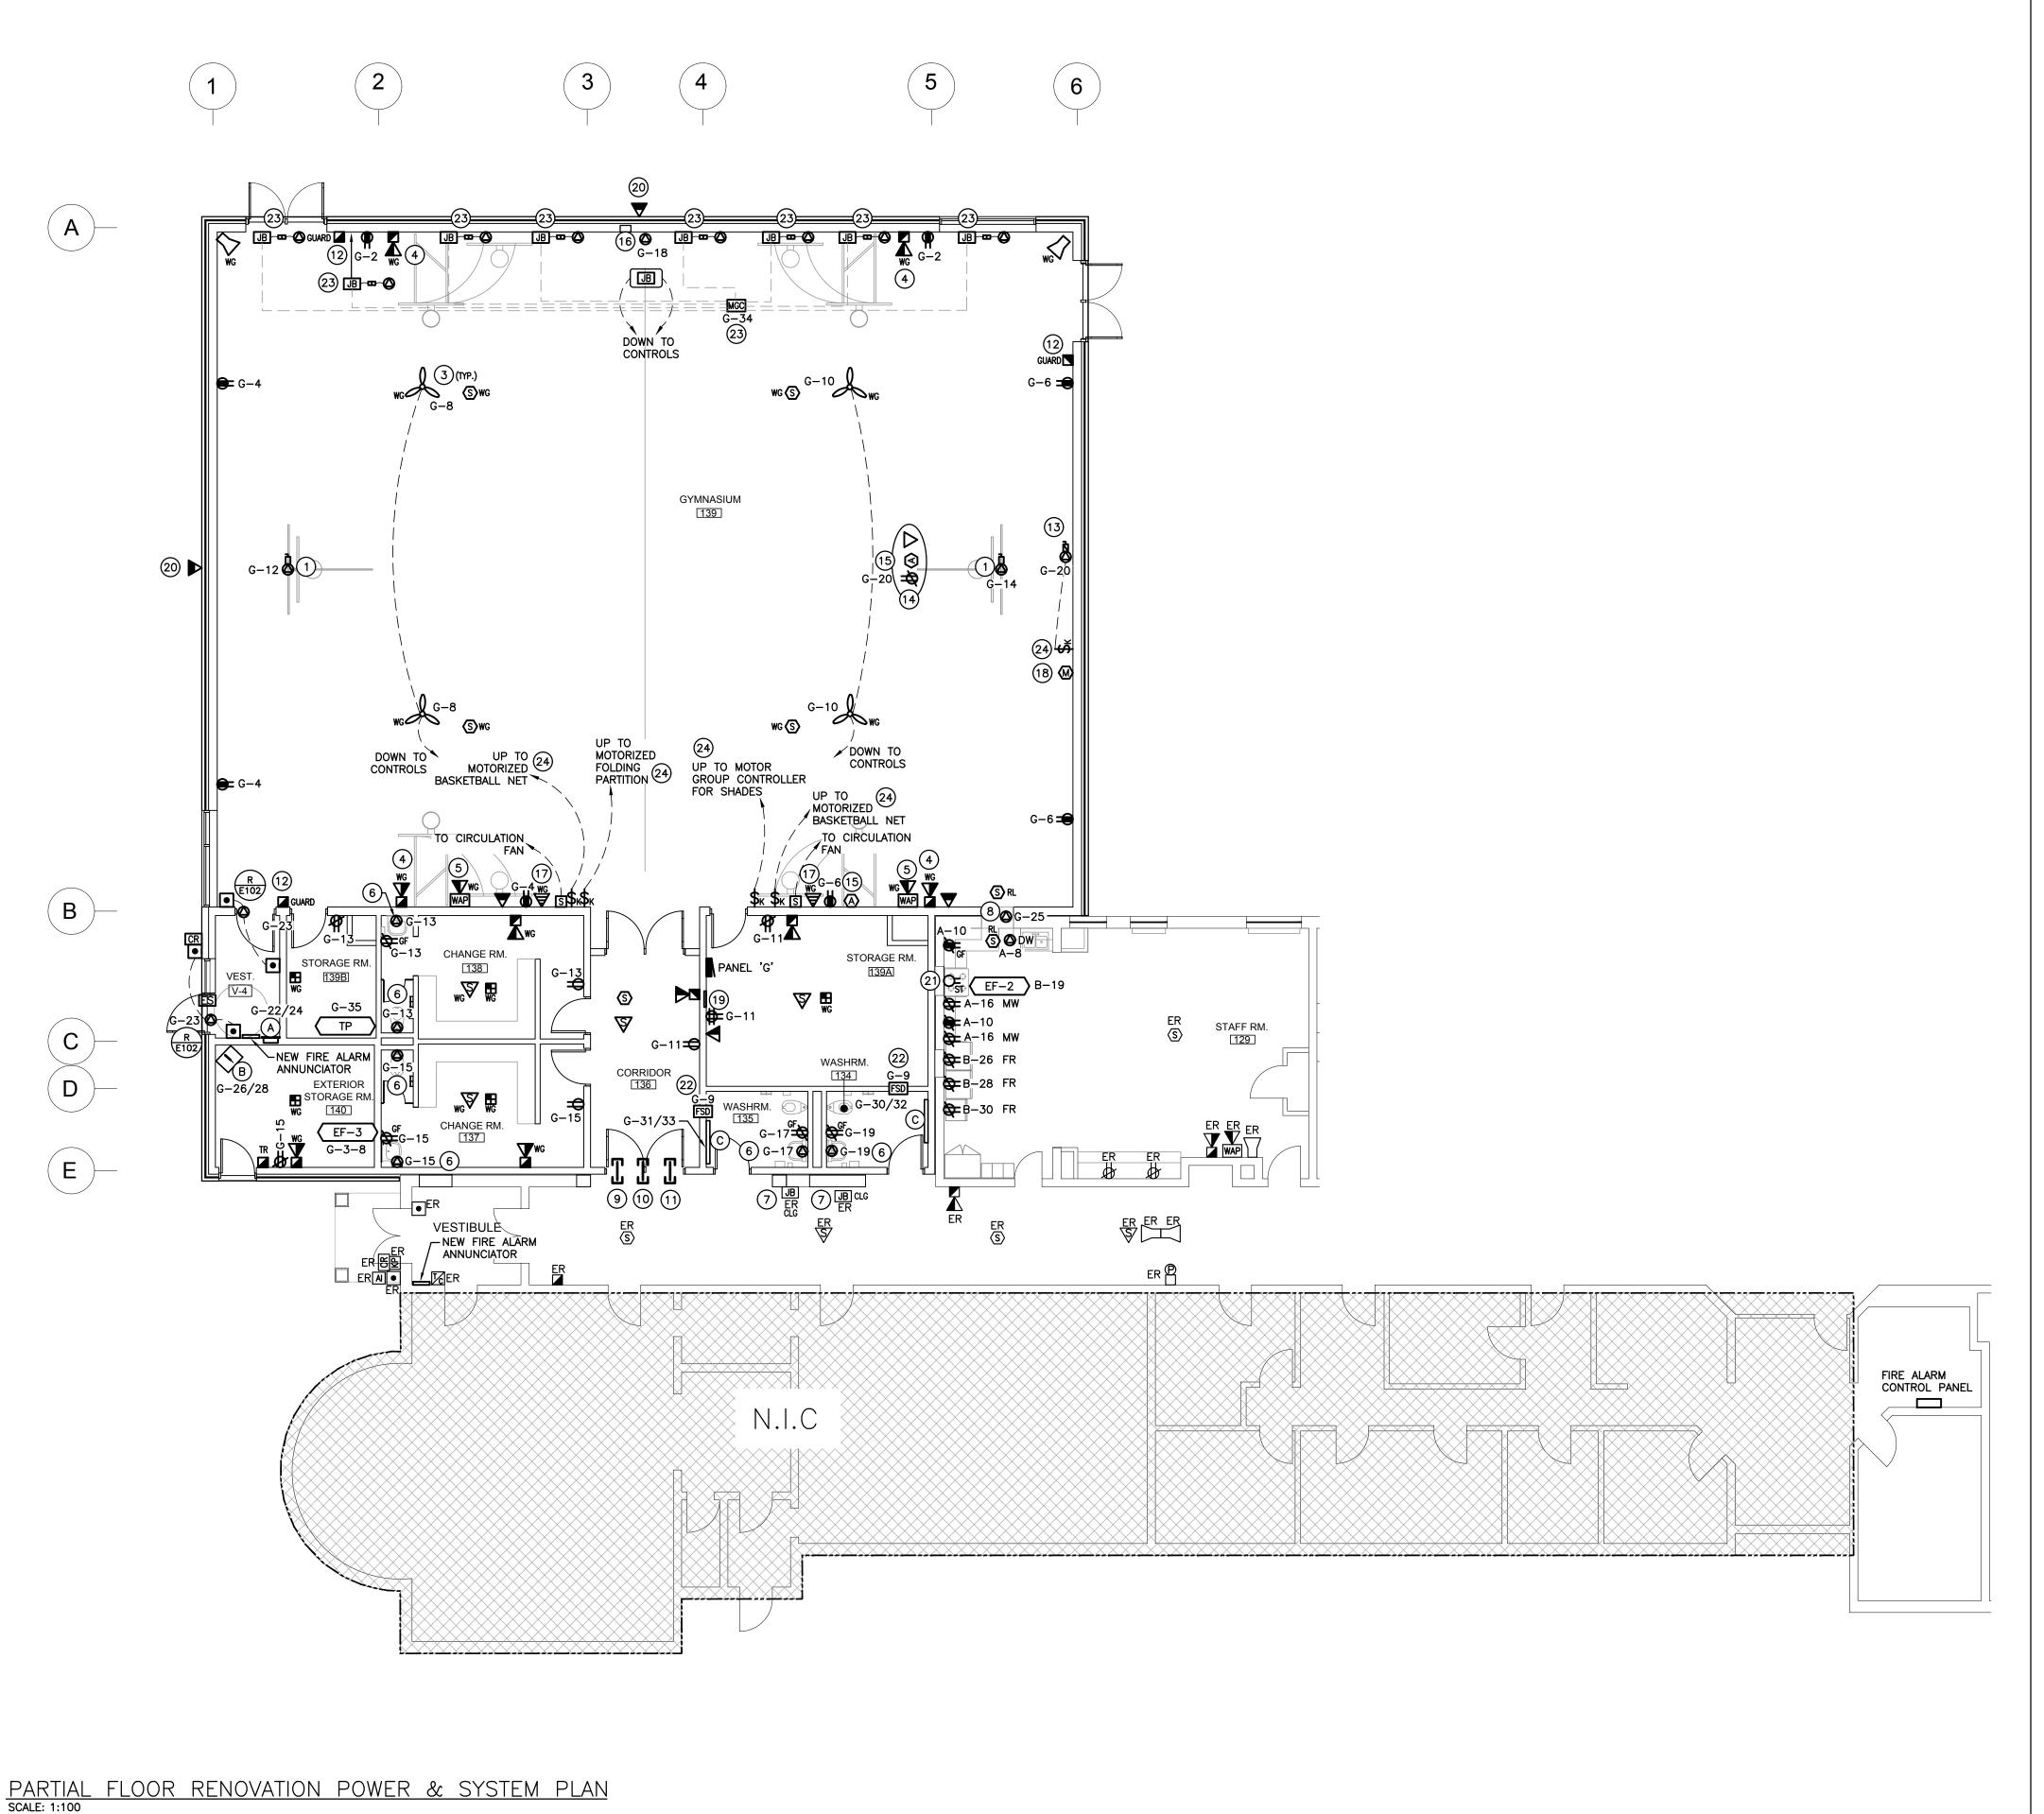

GENERAL NOTES

- 'ER' DENOTES EXISTING ITEM TO REMAIN.
- EXISTING ELECTRICAL EQUIPMENT NOT SHOWN SHALL REMAIN UNLESS NOTED OTHERWISE. 'R' INDICATES EXISTING ITEM TO BE RELOCATED. REFER TO RENOVATION DRAWINGS AND RELOCATE DEVICE AND WIRING TO SUIT. UNLESS OTHERWISE NOTED.
- 'D' INDICATES EXISTING ITEM TO BE DELETED. UNLESS OTHERWISE NOTED DISCONNECT AND REMOVE NOTED DEVICE AND WIRING BACK TO SOURCE. ALL LIGHTING FIXTURES BEING RELOCATED SHALL BE CLEANED AND CHECKED PRIOR TO BEING REINSTALLED.
- ALL DEVICES SHOWN ARE NEW UNLESS OTHERWISE NOTED.
- EXISTING ELECTRICAL EQUIPMENT NOT SHOWN SHALL REMAIN UNLESS OTHERWISE NOTED. MAINTAIN SERVICE TO ALL EXISTING DEVICES TO REMAIN. REVISE PANEL DIRECTORIES TO SUIT CHANGES (TYPED).

SPECIFIC DEMOLITION NOTES

- D1 INDICATED EXISTING SURFACE MOUNTED CONDUIT, JUNCTION BOX AND RECEPTACLES TO BE DELETED. EXISTING WIRING TO BE CUT BACK AND MAKE SAFE FOR NEW DEVICES.
- D2 INDICATED EXISTING SURFACE MOUNTED CONDUIT AND RECEPTACLES TO BE DELETED. RECEPTACLES ARE FED FROM BASEMENT ELECTRICAL ROOM AREA. EXISTING WIRING TO BE CUT AND MAKE SAFE FOR NEW DEVICES.
- D3 INDICATED JUNCTION BOXES LOCATED IN CEILING SPACE TO REMAIN. JUNCTION BOXES WERE FEEDING EXISTING GYM PANEL AND MUA-3.
- D4 INDICATES EXISTING FIRE ALARM CONTROL PANEL MIRCOM SERIES 200 CONVENTIONAL SYSTEM WITH 2 SPARE ZONES TO BE REPLACED WITH NEW. EXISTING FIRE ALARM ANNUNCIATOR IS LOCATED IN THE SIDE PARKING LOT VESTIBULE. EXISTING FIRE RESET KEYPAD IS LOCATED IN THE CUSTODIAN'S OFFICE. FIRE ALARM ANNUNCIATOR AND FIRE

SPECIFIC RENOVATION NOTES

RESET KEYPAD IS TO BE REMOVED COMPLETE.

- INDICATED DIRECT CONNECTION FOR MOTORIZED BASKETBALL NET. PROVIDE 20A-120V DEDICATED CIRCUIT. THIS CONTRACTOR IS TO PROVIDE SINGLE GANG BOX ROUGH-IN WITH 12/3 AWG. CU, IN 3/4"C TO BASKETBALL NET MOTOR. KEY SWITCH OPERATOR AT 1200mm A.F.F. COORDINATE WITH BASKETBALL NET SUPPLIER AND REFER TO SHOP DRAWINGS FOR ANY ADDITIONAL REQUIREMENTS.
- INDICATED CONNECTION FOR NEW MOTORIZED CENTRE DIVIDER CURTAIN. CONFIRM EXACT REQUIREMENTS AND CO-ORDINATE WORK WITH CURTAIN INSTALLER. THIS CONTRACTOR TO PROVIDE A 4X4 JUNCTION BOX AND 1/2"C TO DEEP SINGLE GANG BOX (KEYSWITCH BY OTHERS). 3 POSITION MOMENTARY KEYSWITCH BY OTHERS. WIRING BY THIS CONTRACTOR. DEDICATED 20A-120V CIRCUIT REQUIRED.
- INDICATED GYM DESTRATIFICATION FAN TO BE STEM MOUNTED WITH BOTTOM OF FAN LEVEL WITH LIGHTING. WIRE FAN TO SPEED CONTROLLER AS INDICATED.
- INDICATED DEVICE IS TO BE C/W A 60 CANDELA STROBE.
- PROVIDE A WALL FLUSH MOUNTED OCTAGON BOX WITH 19mm CONDUIT TO CORRIDOR CEILING SPACE FOR DATA WIRING OF WIRELESS ACCESS POINT (AP). INDICATED CONNECTION FOR AUTOMATIC PLUMBING FIXTURE. PROVIDE WIRING FOR
- CENTRALLY MOUNTED JUNCTION BOX LOCATED WITHIN CEILING SPACE TO FEED SENSOR. COORDINATE EXACT REQUIREMENTS WITH OTHER TRADES PRIOR TO ROUGH-IN. INDICATES EXTEND FEED TO NEW PANEL 'G' FED FROM EXISTING PANEL 'DP-X'. EXISTING WIRING FEEDING EXISTING MUA-1 WILL REMAIN AND EXISTING BREAKER WILL NEED TO
- REMAIN LOCKED-OFF. REFER TO DETAIL H/E102. PROVIDE 120V POWER AND FIRE ALARM CONNECTIONS TO FIRE SHUTTER. PROVIDE WIRING FROM 24V MOTOR LINK TO SMOKE DETECTOR BUILT-IN RELAY.
- PROVIDE 1.5" SLEEVE THRU THE FIREWALL FOR PA AND SECURITY WIRING. REFER TO
- 10 PROVIDE 1.5" SLEEVE THRU THE FIREWALL FOR VOICE/DATA WIRING. REFER TO DETAIL H/E102. 11 PROVIDE 1.5" SLEEVE THRU THE FIREWALL FOR FIRE ALARM WIRING. REFER TO DETAIL H/E102.
- 12 MOUNT INDICATED DEVICE(S) IN BLOCK RECESS. REFER TO DETAIL M/E101. INDICATES CONNECTION FOR MOTORIZED PROJECTION SCREEN, THIS CONTRACTOR TO WIRE TO EQUIPMENT MOTOR FROM THE REMOTE LINE VOLTAGE CONTROL SWITCH LOCATED AS

SHOWN. COORDINATE MOTOR PLACEMENT ON SITE WITH SUPPLIER. ALL COMPONENTS INCLUDING REMOTE LINE VOLTAGE SWITCH AND COVER PLATE TO BE PROVIDED BY

- 14 INDICATES APPROXIMATE LOCATION OF CEILING MOUNTED OUTLETS FOR GYM PROJECTOR (DUPLEX RECEPTACLE, SINGLE DATA, AND HDMI AUXILIARY). DATA DROP CONDUIT TO BE
- 15 INDICATES HDMI AUXILIARY CEILING AND WALL OUTLETS FOR CEILING PROJECTOR C/W "RAPID RUN" WIRING HARNESS SOLUTION CONTAINING HDMI RUNNER CABLES, FLYING LEADS (CONNECTIONS AND WALL PLATES AT EACH OUTLET LOCATION). PROVIDE 27mmC BETWEEN WALL AND CEILING OUTLET LOCATIONS.
- 16 INDICATES COORDINATE WITH SCOREBOARD SUPPLIER ON EXACT LOCATION OF SCOREBOARD. THIS CONTRACTOR TO PROVIDE 20A-1P HARD WIRED CONNECTION FOR SCOREBOARD AND (2) DOUBLE-GANG BOX WITH 1"C BETWEEN SCOREBOARD AND ROUGH-IN AT RECEPTACLE HEIGHT FOR SCOREBOARD CONTROLS. COORDINATE EXACT REQUIREMENTS WITH SCOREBOARD SUPPLIER.
- 17 INDICATES WALL MOUNTED SOUND SYSTEM SPEAKER ROUGH—IN. PROVIDE SINGLE GANG BOX WITH 3/4"C TO STORAGE ROOM 139A. TERMINATE IN A 200mmX200mm FLUSH MOUNTED JUNCTION BOX.
- 18 INDICATES WALL MOUNTED MICROPHONE OUTLET ROUGH-IN. PROVIDE SINGLE GANG BOX WITH 3/4"C TO STORAGE ROOM 139. TERMINATE IN A 200mmX200mm FLUSH MOUNTED
- 19 INDICATES GYM SOUND SYSTEM PATCH PANEL INSTALLED AS 200mmX200mm FLUSH MOUNTED JUNCTION BOX C/W COVER PLATE AND KNOCKOUTS TO SUIT SPEAKERS, MICROPHONE AND ANTENNA PORTS. COORDINATE WITH PUBLIC ADDRESS SUB CONTRACTOR.
- 20 MOUNT INDICATED DEVICE AT HEIGHT AS PER ARCHITECTURAL DRAWINGS. 21 INDICATES REWORK EXISTING STOVE WIRING FOR NEW STOVE LOCATION.
- 22 PROVIDE FIRE ALARM CONNECTION TO SMOKE DAMPER INTEGRAL DUCT DETECTOR. PROVIDE DUAL INPUT MONITOR/CONTACTOR MODULE AND DUAL VOLTAGE RELAY. FROM ONE SET OF CONTACTS MONITOR INTEGRAL DUCT DETECTOR ALARM SIGNAL. ALARM SIGNAL SHALL BE PROGRAMMED AS AN ALARM ZONE. FROM ONE SET OF CONTACTS MONITOR DUAL VOLTAGE RELAY FOR AC POWER LOSS. AC POWER LOSS IS TO BE MONITORED AS A TROUBLE
- 23 INDICATES MOTORIZED WINDOWS SHADES. PROVIDE CONNECTION TO MOTOR GROUP CONTROLLER. COORDINATE EXACT LOCATION WITH SHADE SUPPLIER ON SITE. REFER TO
- 24 PROVIDE LAMACOID LABEL INDICATING WHAT THE KEY SWITCH IS INTENDED TO CONTROL.



2050 Guelph Line, Burlington, ON. L7P 5A8

Glenview Public School Gym Addition

> 143 Townsend Ave., Burlington, ON. L7T 1Z1

Architects **Snyder Architects Inc.**




100 Broadview Ave, Suite 301, Toronto, ON M4M 3H3


t. 416.966.5444, w. snyderarchitects.ca

The contractor shall verify all dimensions and report all errors and discrepancies to the Consultant before commencement of the work. The drawings show general arrangement of services. Follow as closely as actual building construction will permit. Obtain approval for relocation of service from Consultant before commencement of the work. The drawings do not indicate all offsets fitting and accessories which may be required. Provide the same to meet the required conditions. Drawings and specifications, etc., prepared and issued by the consultant are the property of the consultant and must be returned at the completion of the project. These documents are not to be duplicated or copied without the consent of the Consultant.

Do not scale this drawing. © 2024 DEI Consulting Engineers Inc.




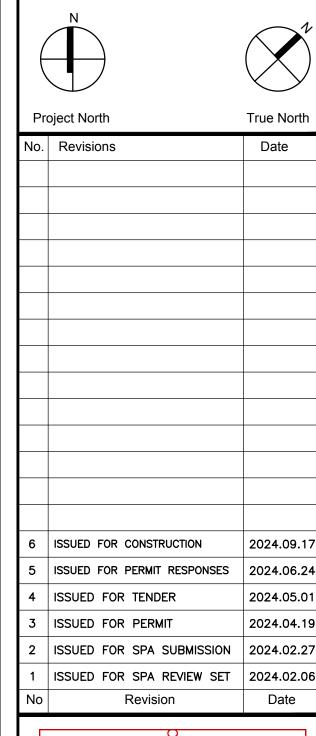

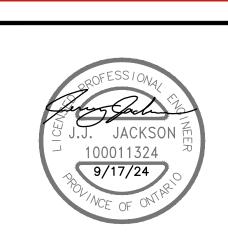

PARTIAL FLOOR PLAN POWER DEMOLITION AND RENOVATION

Drawn by: SB Checked by: RV Job No. Drawing No.
Drawn by: SB Checked by: RV
Scale: AS NOTED Date: MAY 2024

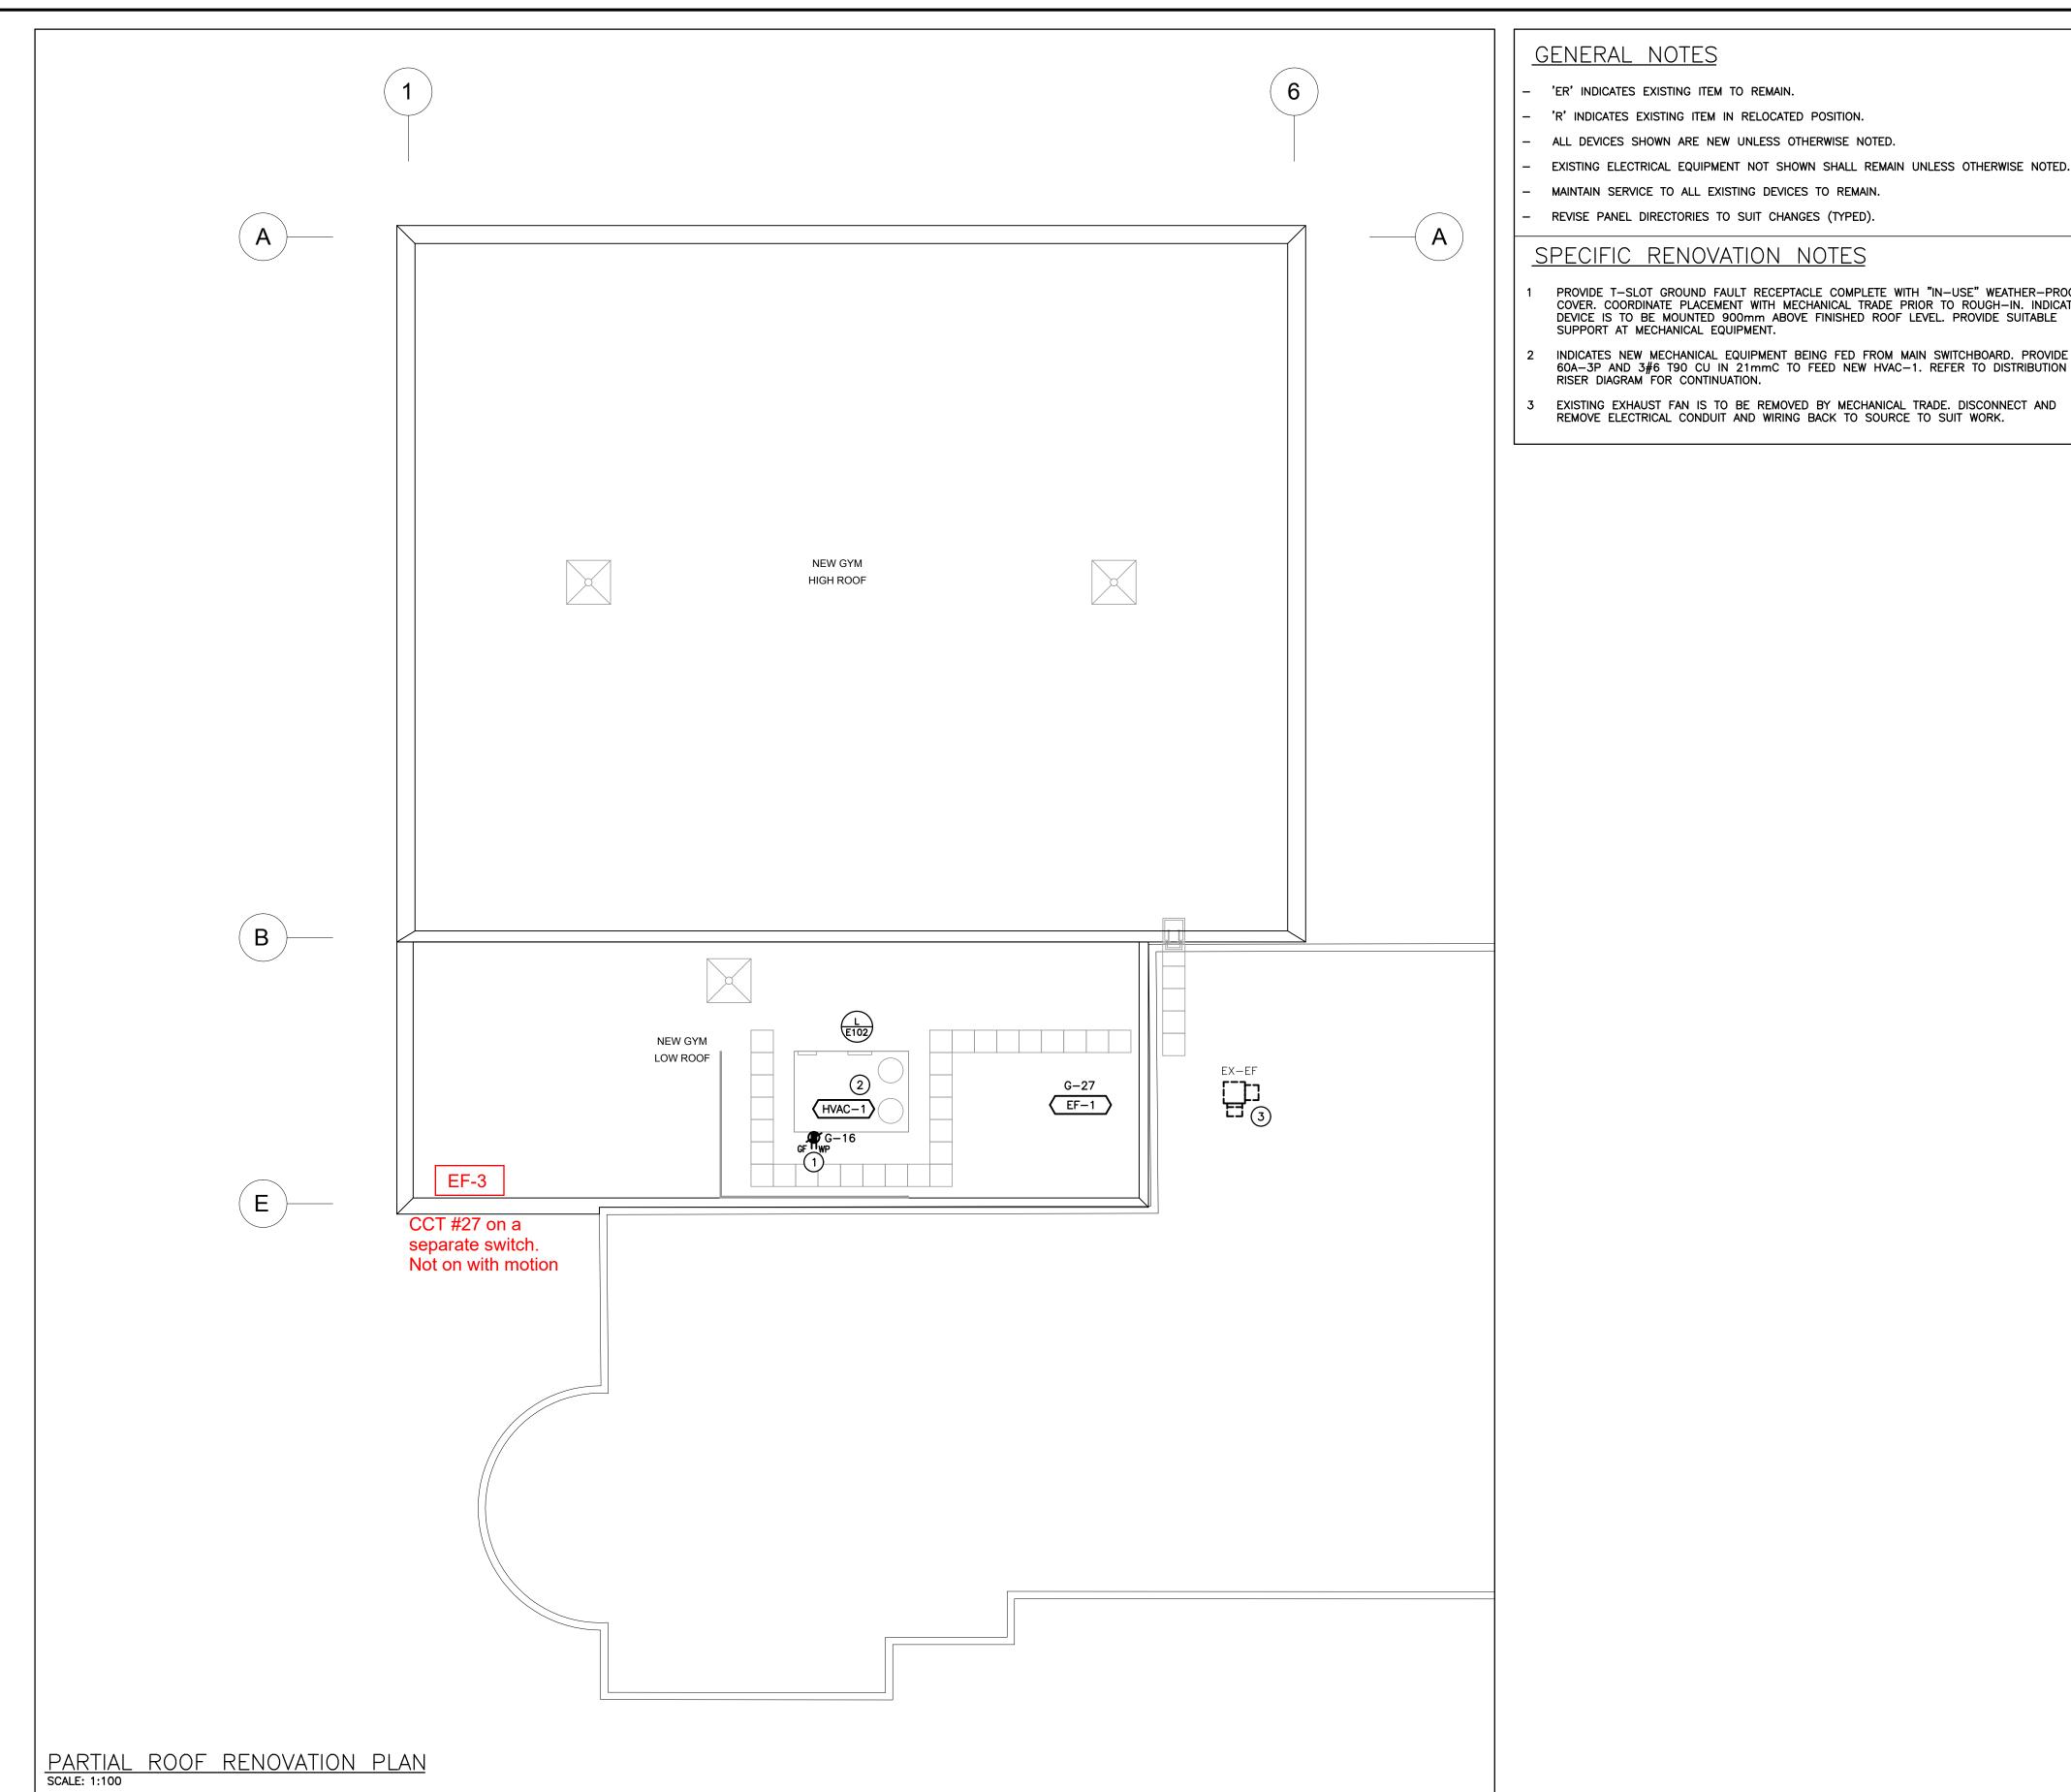

GENERAL NOTES

- 'ER' INDICATES EXISTING ITEM TO REMAIN.
- 'R' INDICATES EXISTING ITEM IN RELOCATED POSITION. ALL DEVICES SHOWN ARE NEW UNLESS OTHERWISE NOTED.
- EXISTING ELECTRICAL EQUIPMENT NOT SHOWN SHALL REMAIN UNLESS OTHERWISE NOTED. MAINTAIN SERVICE TO ALL EXISTING DEVICES TO REMAIN. REVISE PANEL DIRECTORIES TO SUIT CHANGES (TYPED).

SPECIFIC RENOVATION NOTES

PROVIDE T-SLOT GROUND FAULT RECEPTACLE COMPLETE WITH "IN-USE" WEATHER-PROOF COVER. COORDINATE PLACEMENT WITH MECHANICAL TRADE PRIOR TO ROUGH-IN. INDICATED DEVICE IS TO BE MOUNTED 900mm ABOVE FINISHED ROOF LEVEL. PROVIDE SUITABLE SUPPORT AT MECHANICAL EQUIPMENT. Architects INDICATES NEW MECHANICAL EQUIPMENT BEING FED FROM MAIN SWITCHBOARD. PROVIDE 60A-3P AND 3#6 T90 CU IN 21mmC TO FEED NEW HVAC-1. REFER TO DISTRIBUTION RISER DIAGRAM FOR CONTINUATION.

Snyder Architects Inc. 100 Broadview Ave, Suite 301, Toronto, ON M4M 3H3 t. 416.966.5444, w. snyderarchitects.ca



Glenview Public School

Gym Addition

143 Townsend Ave.,

Burlington, ON. L7T 1Z1

2050 Guelph Line,

Burlington, ON.

L7P 5A8


The contractor shall verify all dimensions and report all errors and discrepancies to the Consultant before commencement of the work. The drawings show general arrangement of services. Follow as closely as actual building construction will permit. Obtain approval for relocation of service from Consultant before commencement of the work.


The drawings do not indicate all offsets fitting and accessories which may be required. Provide the same to meet the required conditions. Drawings and specifications, etc., prepared and issued by the consultant are the property of the consultant and must be returned at the completion of the project. These documents are not to be duplicated or copied without the consent of the Consultant.

Do not scale this drawing.

© 2024 DEI Consulting Engineers Inc.


As Built Drawings

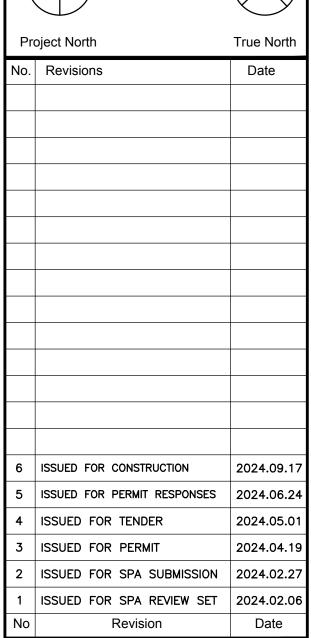


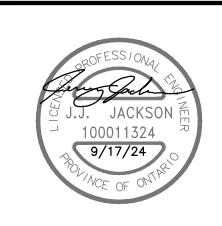

PARTIAL ROOF RENOVATION PLAN

Scale: AS NOTED Date: MAY 2024

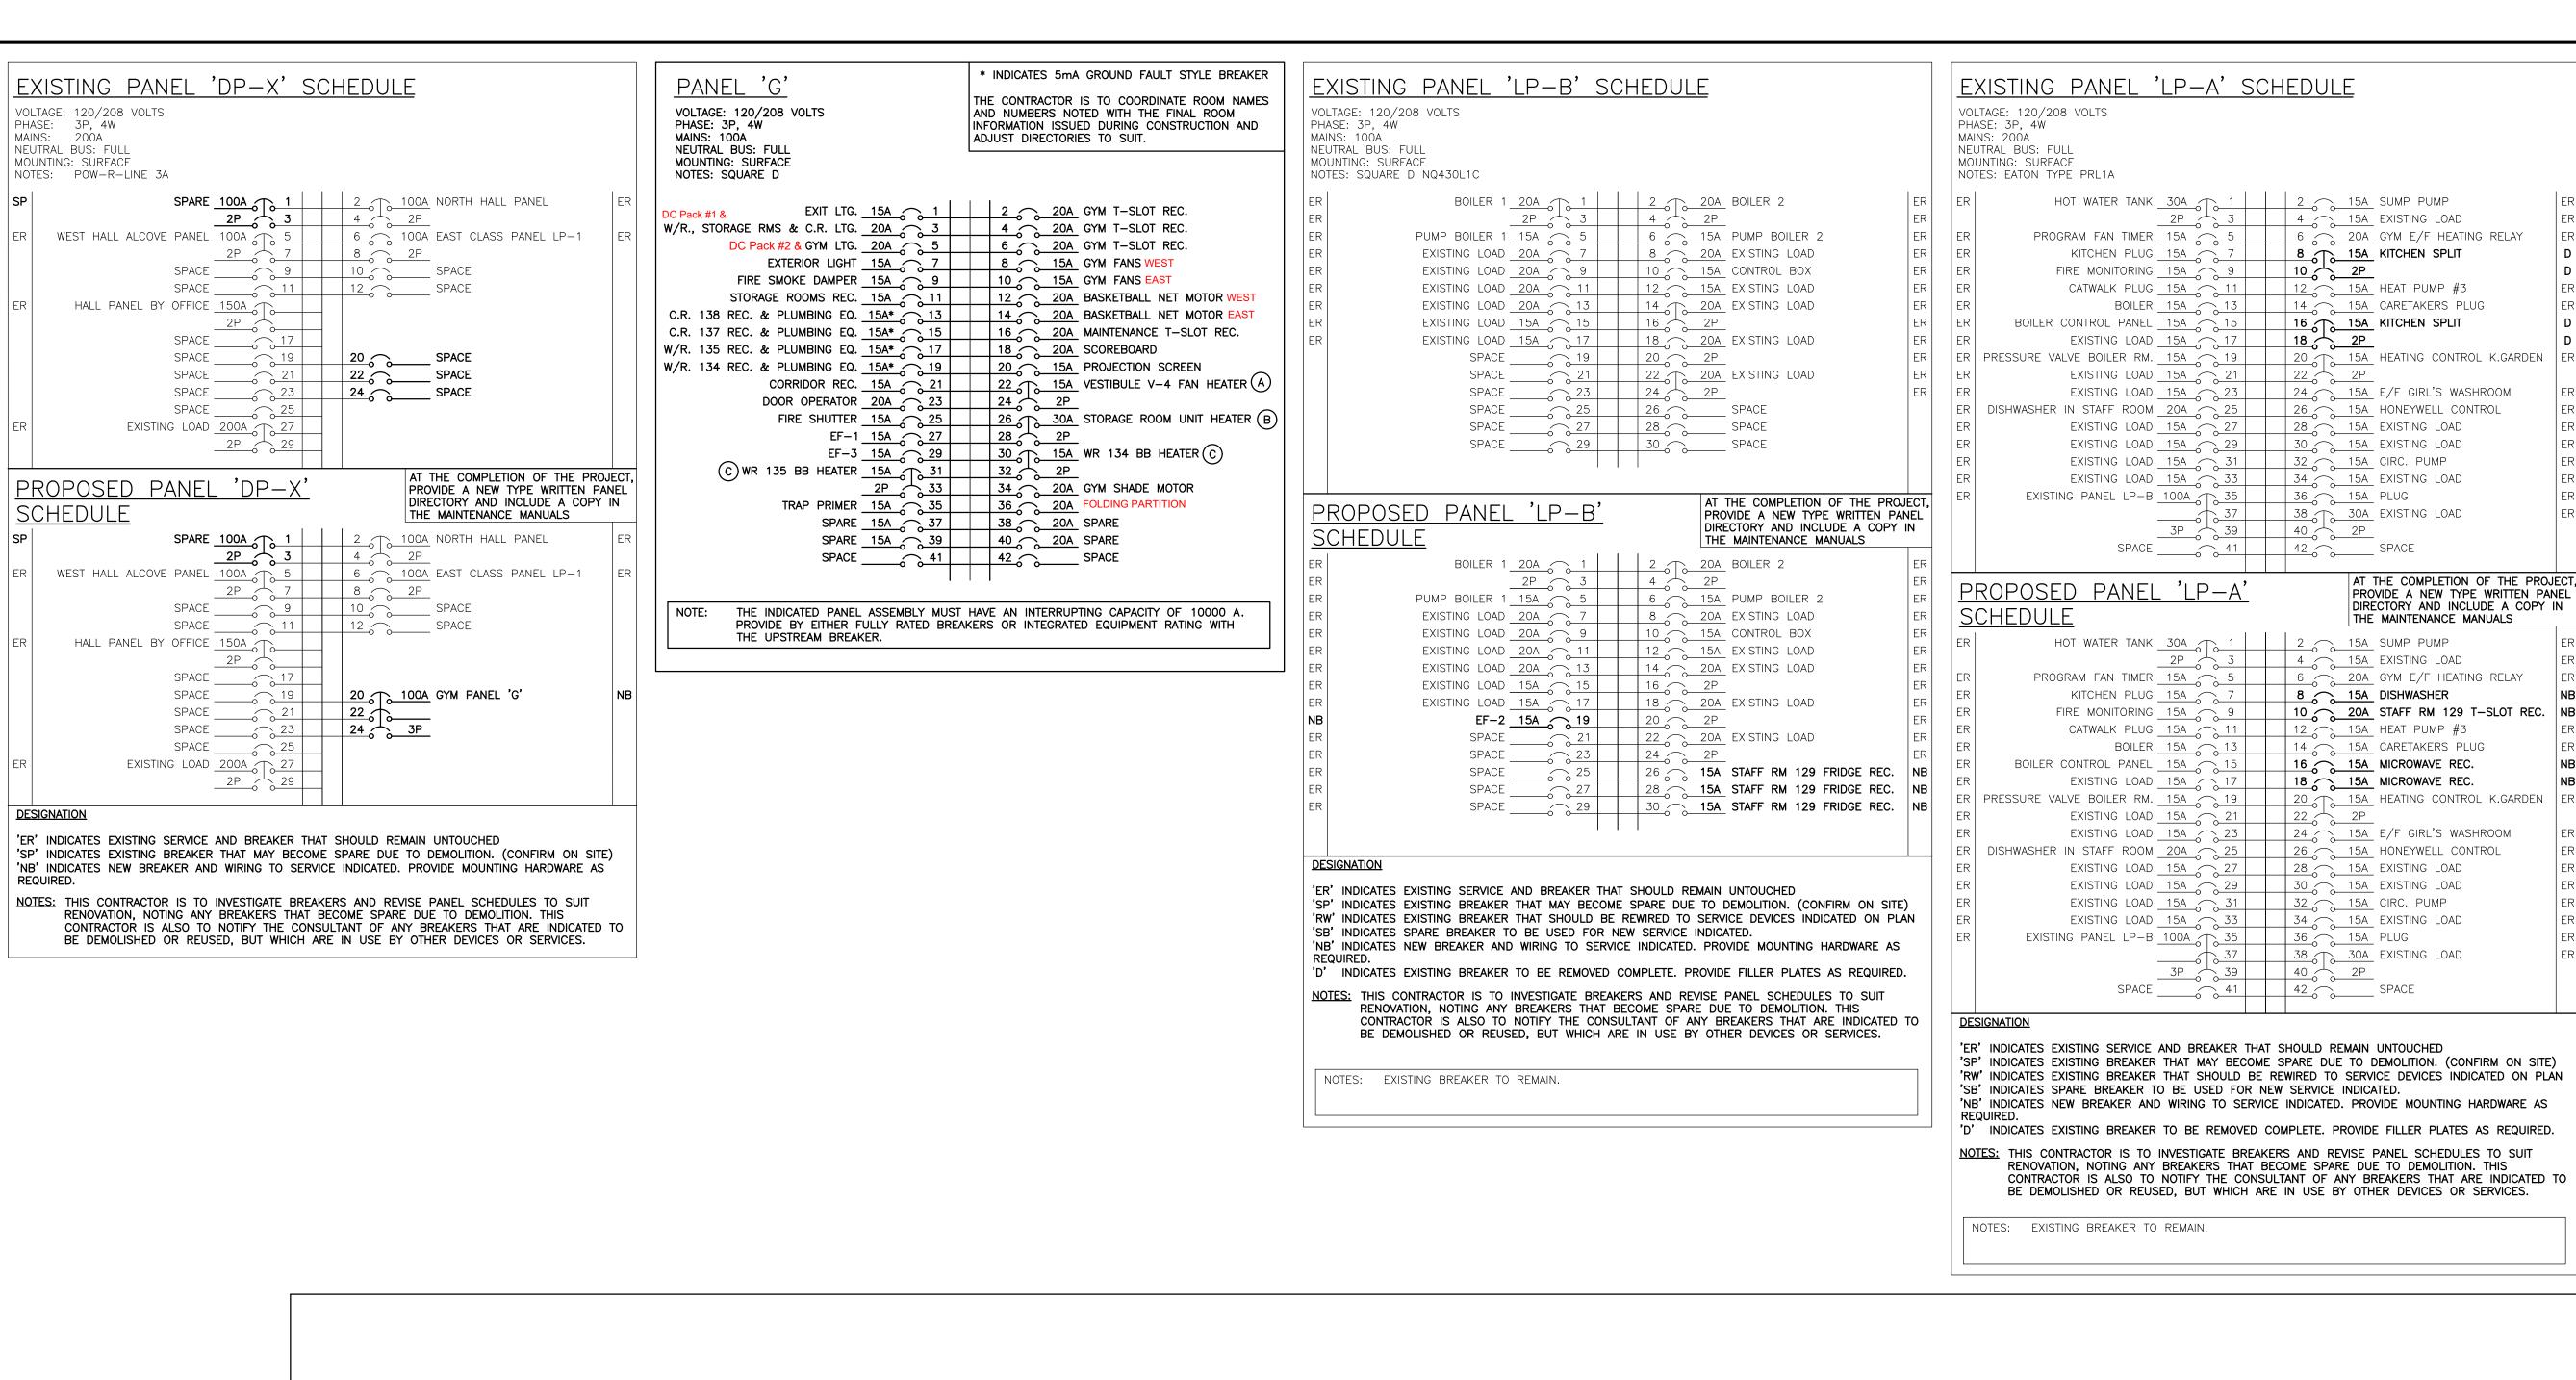

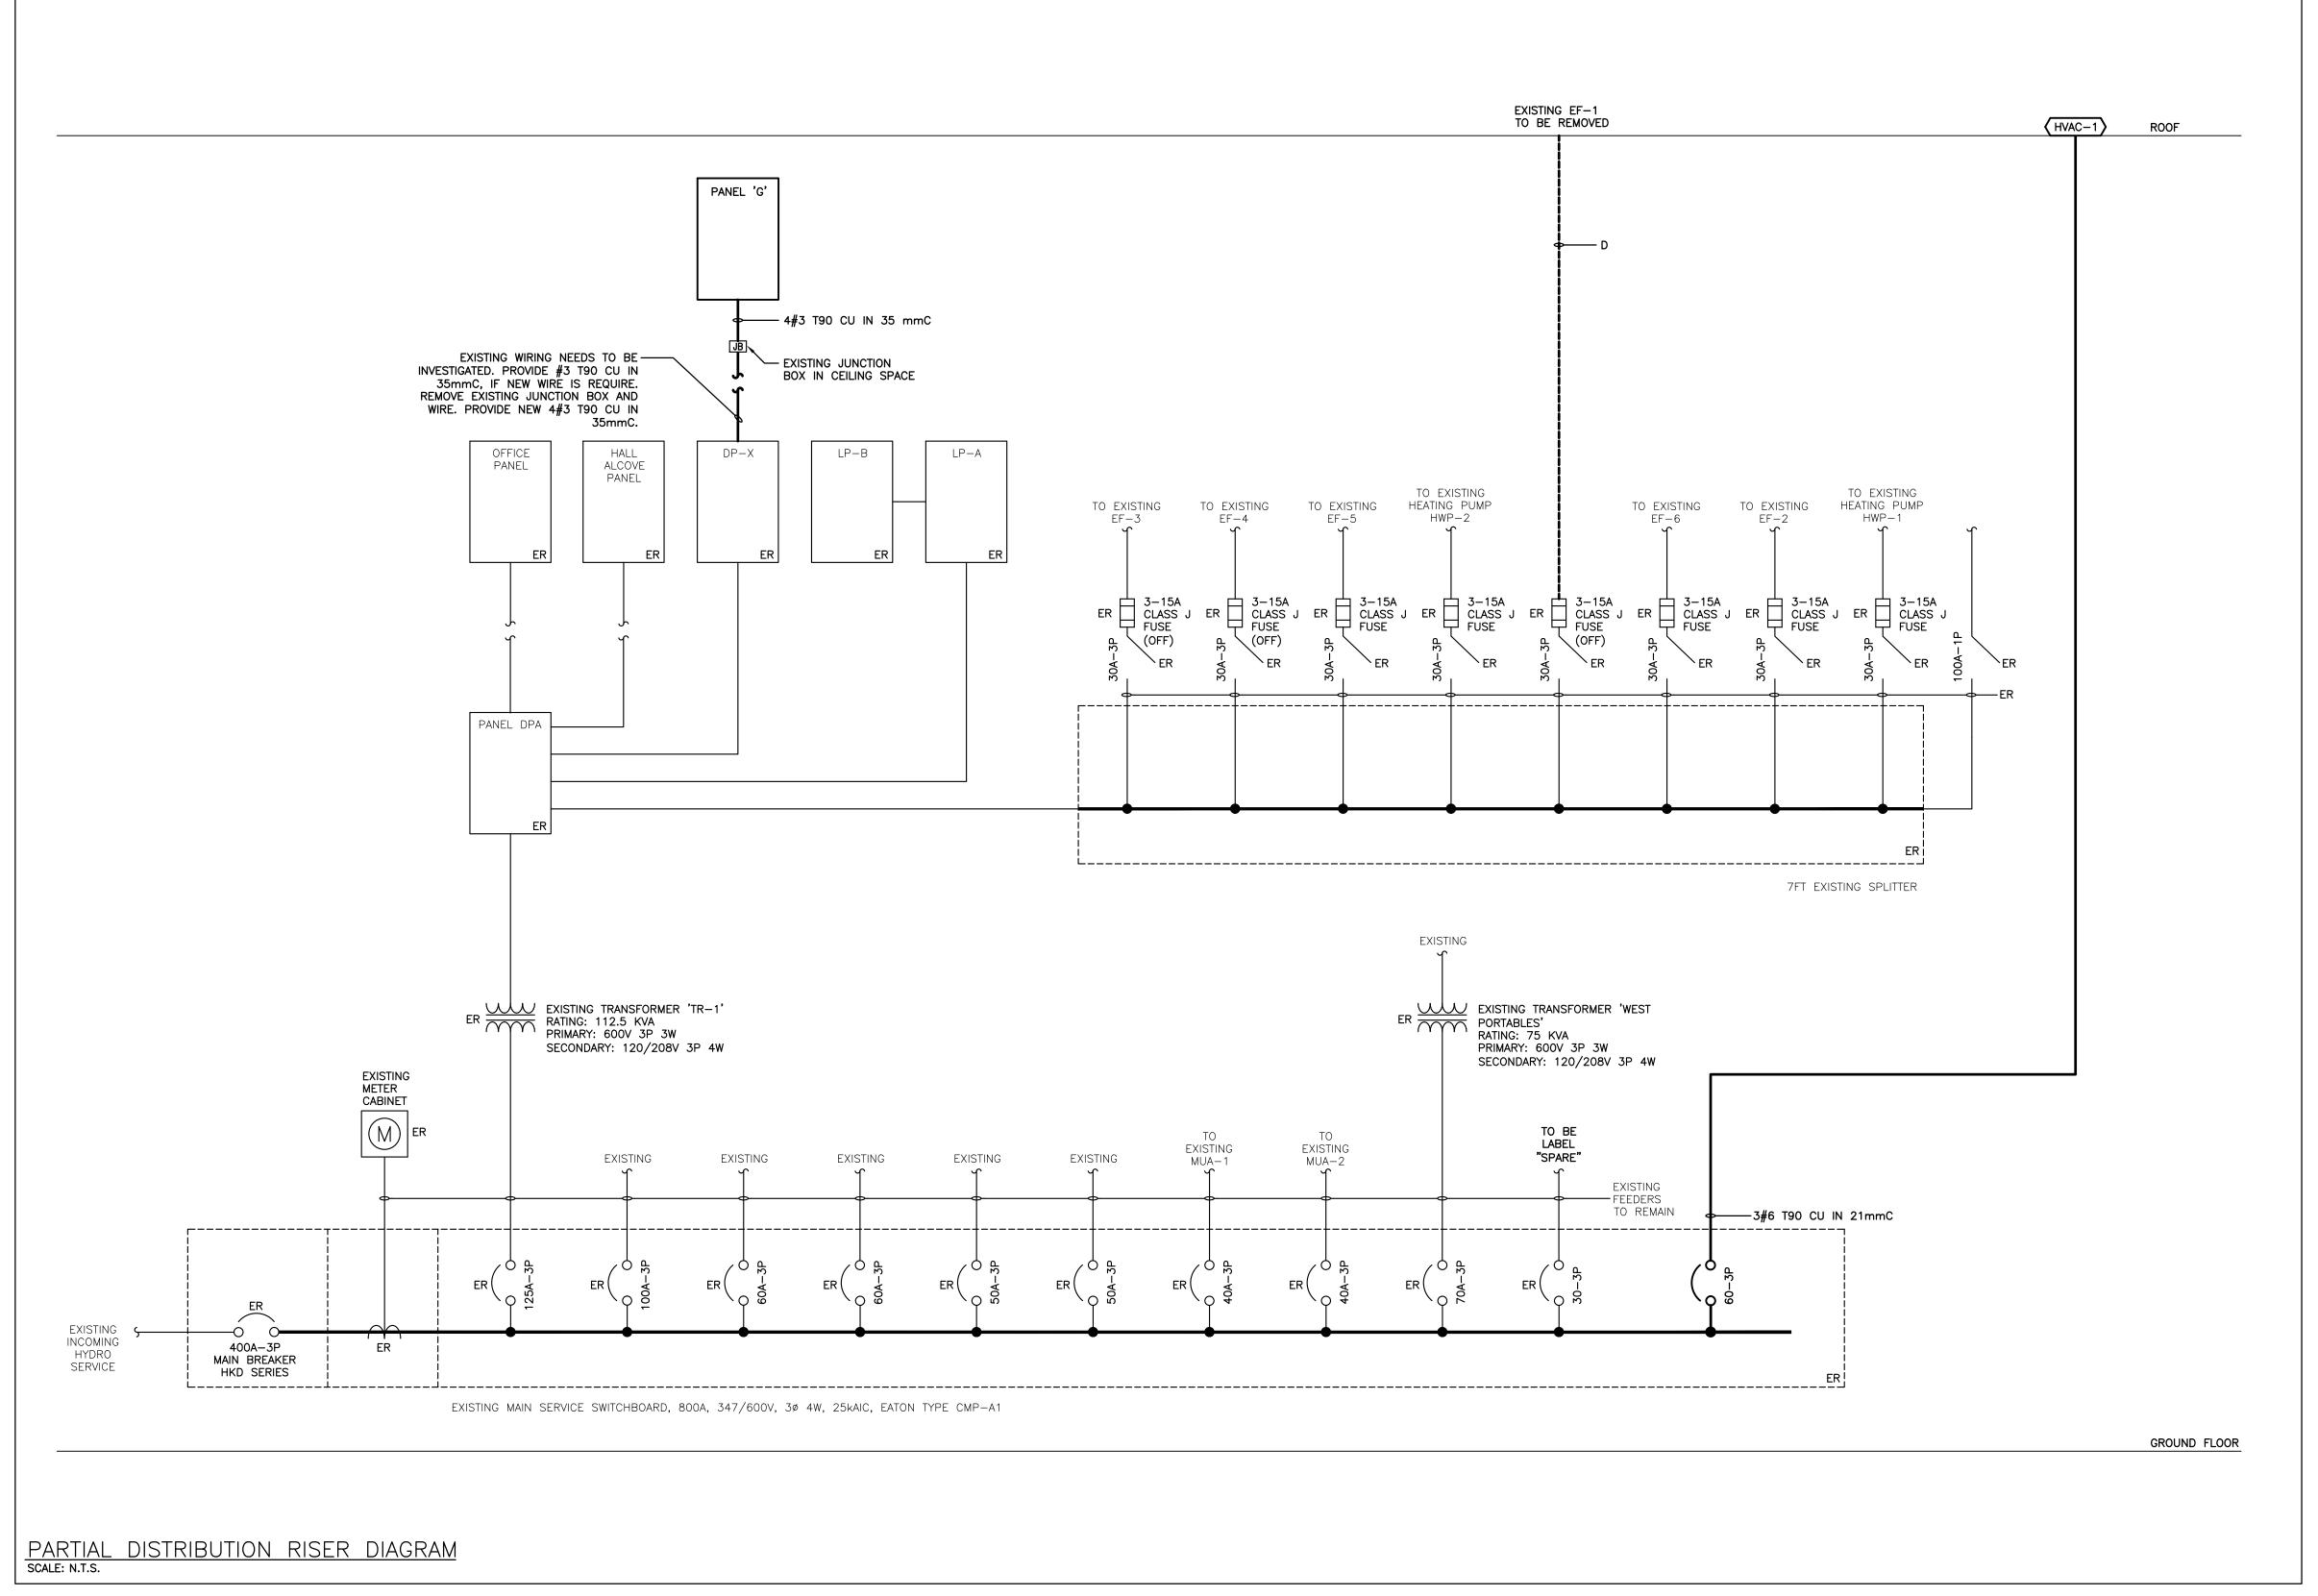



2050 Guelph Line, Burlington, ON. L7P 5A8

Glenview Public School
Gym Addition

143 Townsend Ave.,

Burlington, ON. L7T 1Z1

Architects

SN/der

Snyder Architects Inc.
100 Broadview Ave, Suite 301,



Toronto, ON M4M 3H3

t. 416.966.5444, w. snyderarchitects.ca


The contractor shall verify all dimensions and report all errors and discrepancies to the Consultant before commencement of the work. The drawings show general arrangement of services. Follow as closely as actual building construction will permit. Obtain approval for relocation of service from Consultant before commencement of the work.


The drawings do not indicate all offsets fitting and accessories which may be required. Provide the same to meet the required conditions. Drawings and specifications, etc., prepared and issued by the consultant are the property of the consultant and must be returned at the completion of the project. These documents are not to be duplicated or copied without the consent of the Consultant.

Do not scale this drawing.

© 2024 DEI Consulting Engineers Inc.


As Built Drawings

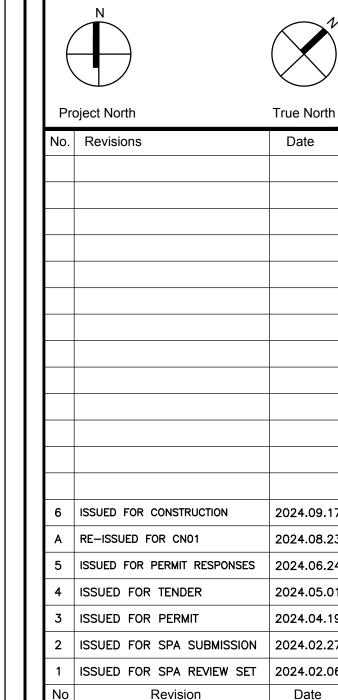


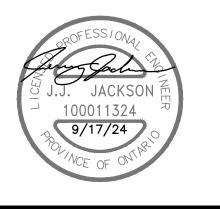

DISTRIBUTION RISER
DIAGRAM AND PANEL
SCHEDULE


2314	E301
Job No.	Drawing No.
Drawn by: SB	Checked by: RV
Scale: AS NOTED	Date: MAY 2024

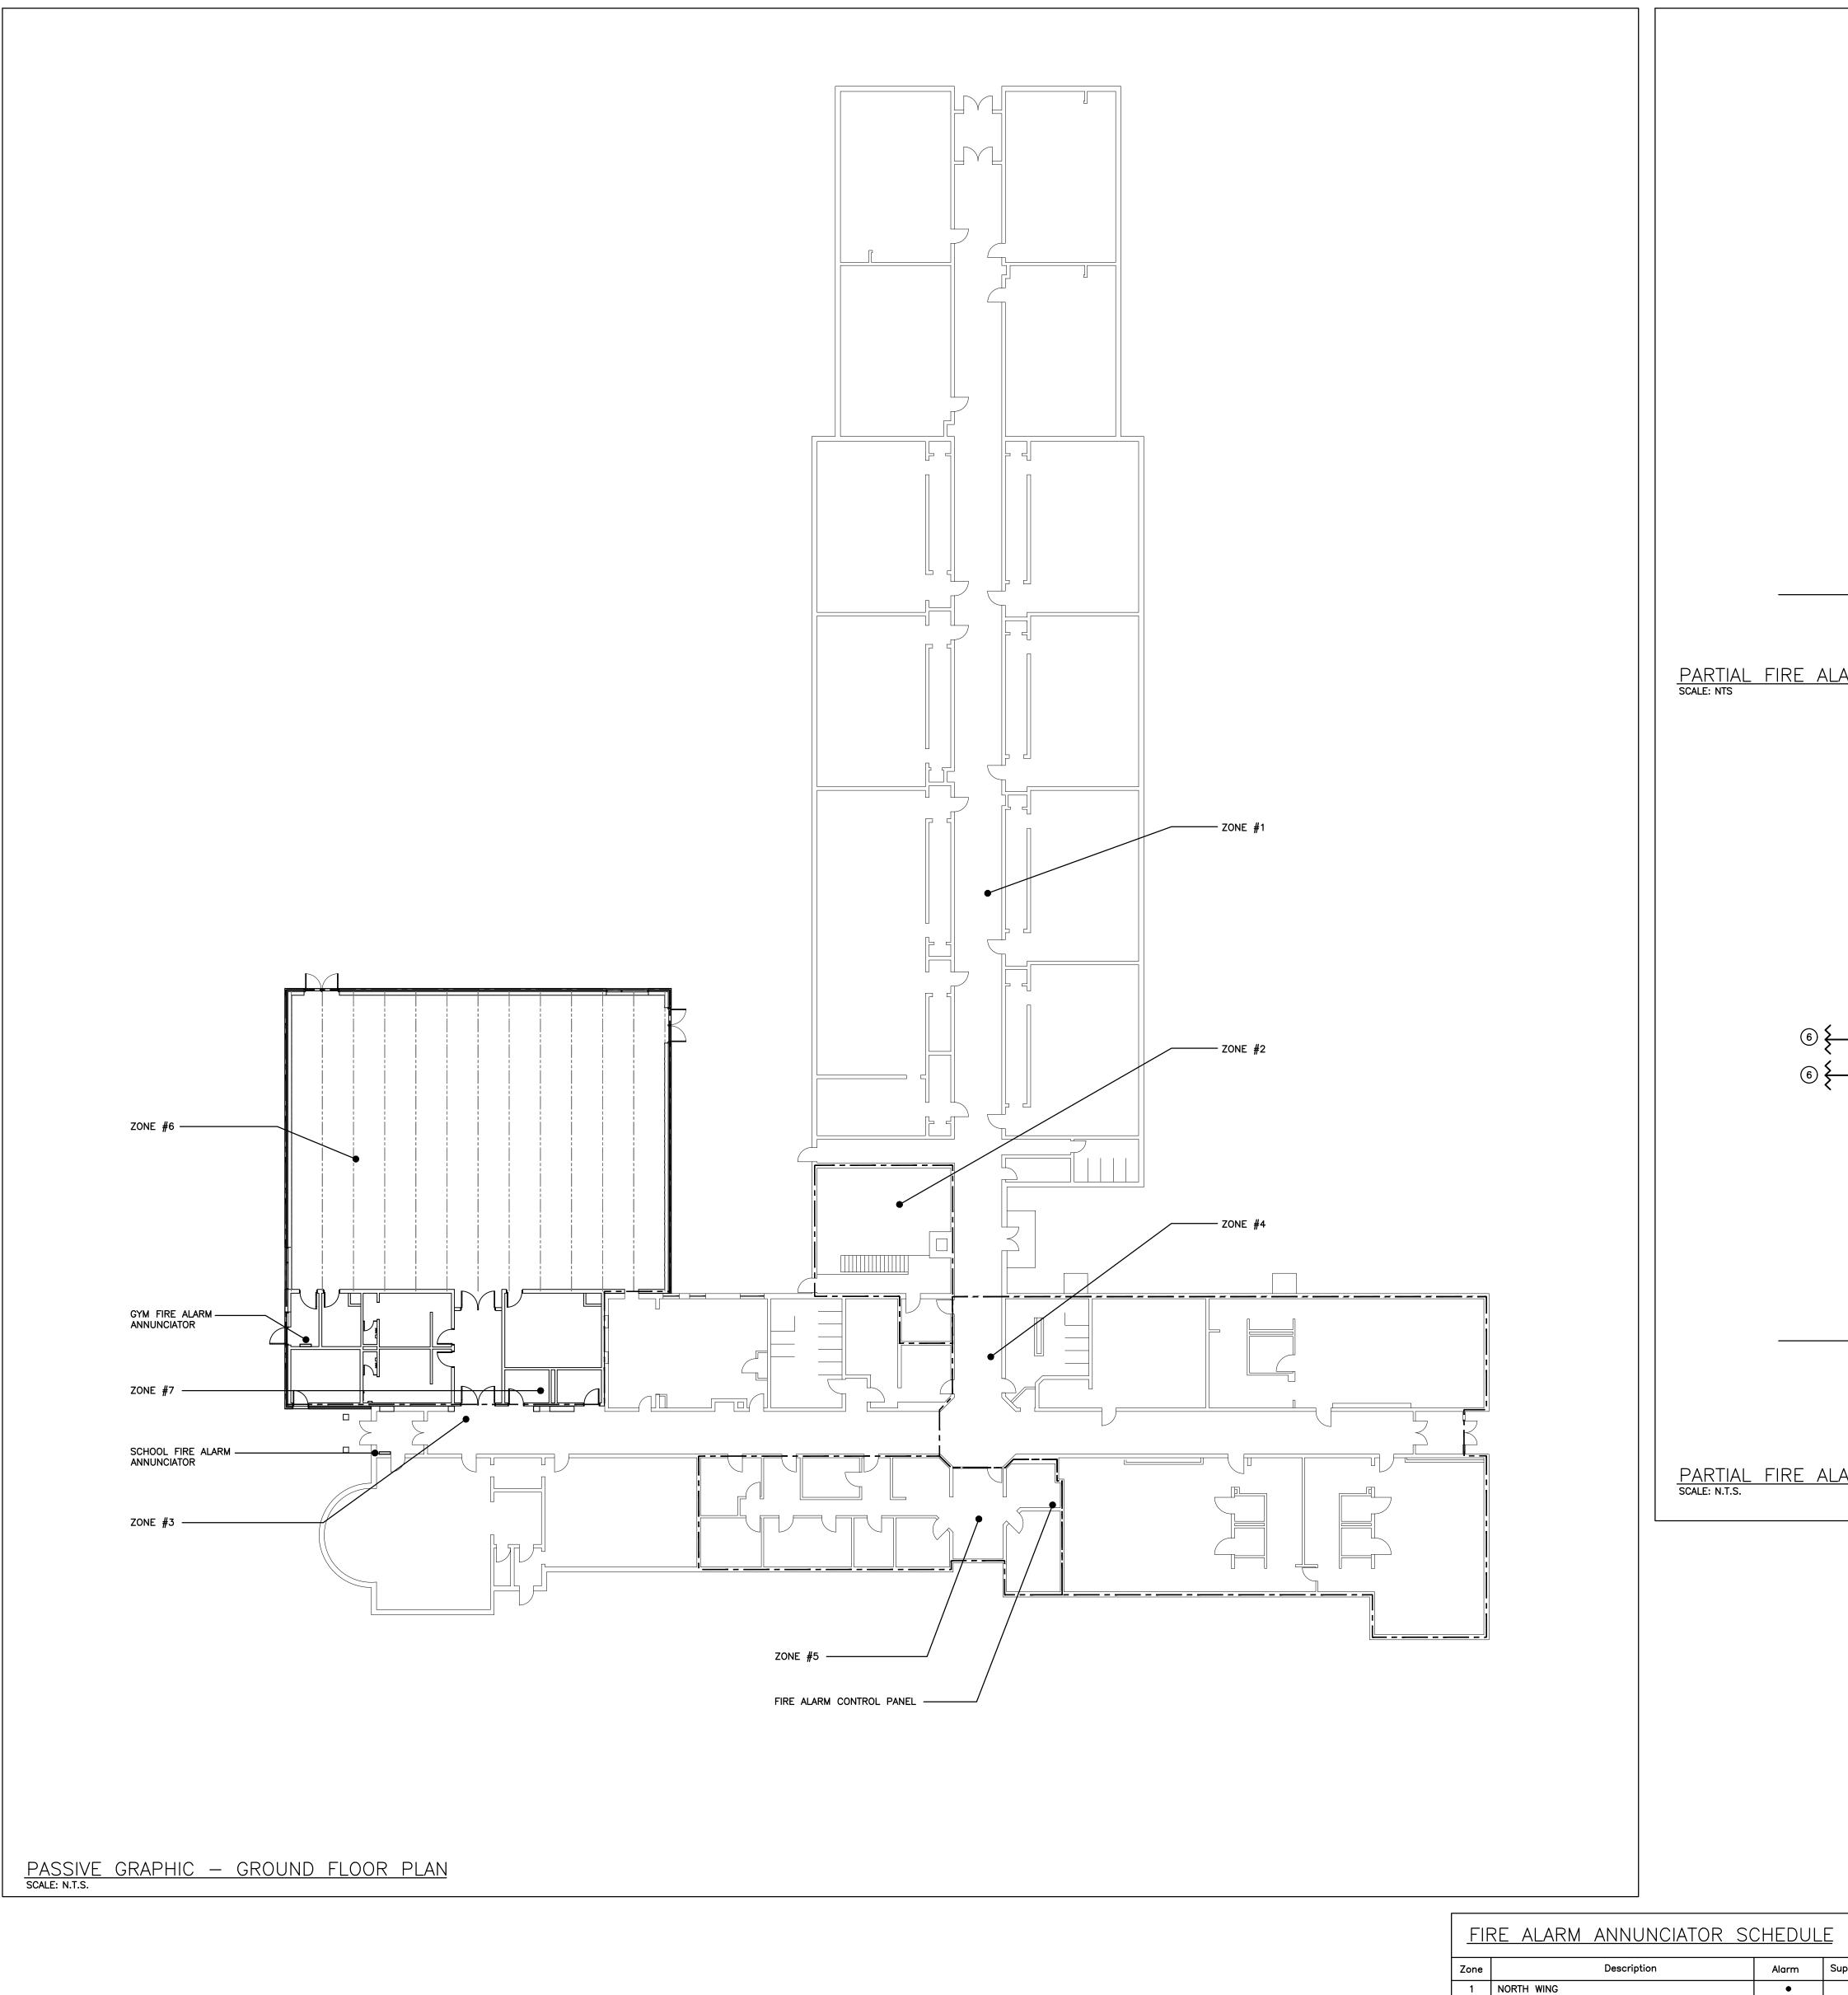

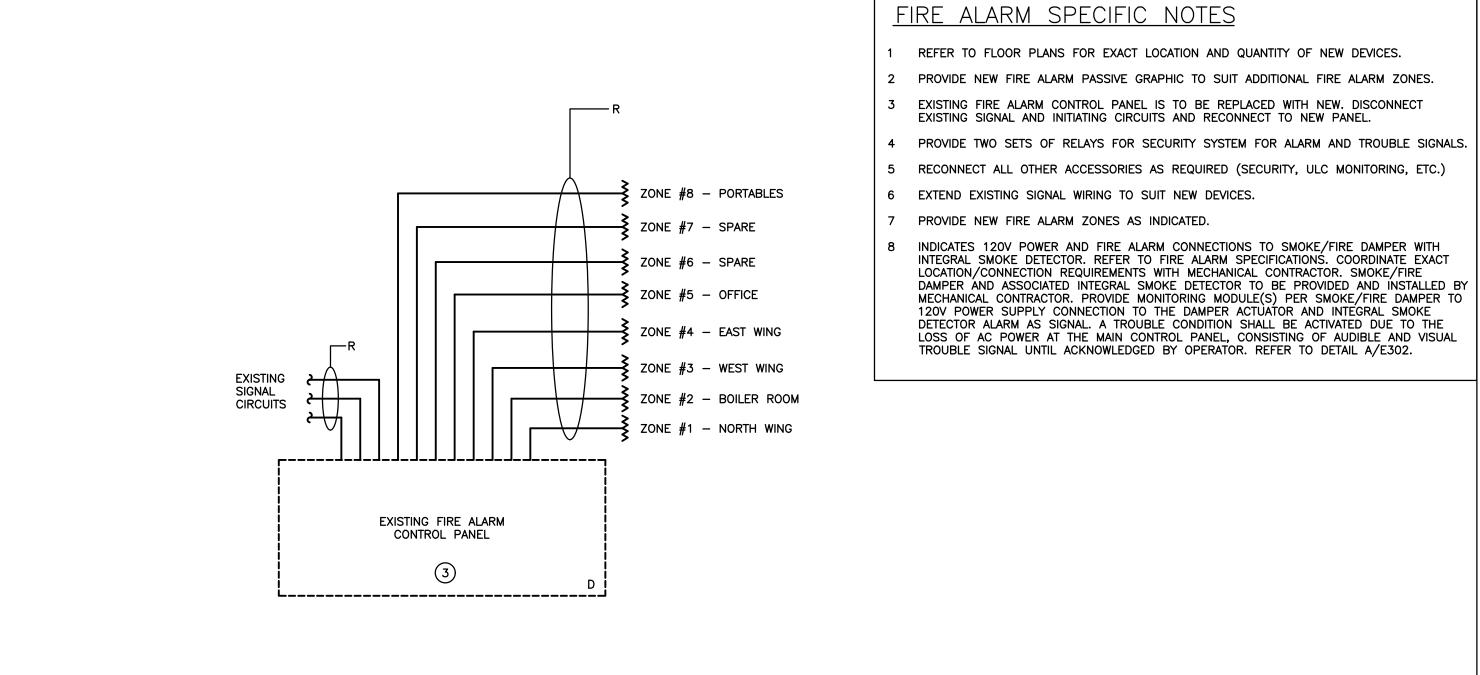

GROUND FLOOR

PARTIAL FIRE ALARM RISER DIAGRAM — DEMOLITION SCALE: NTS

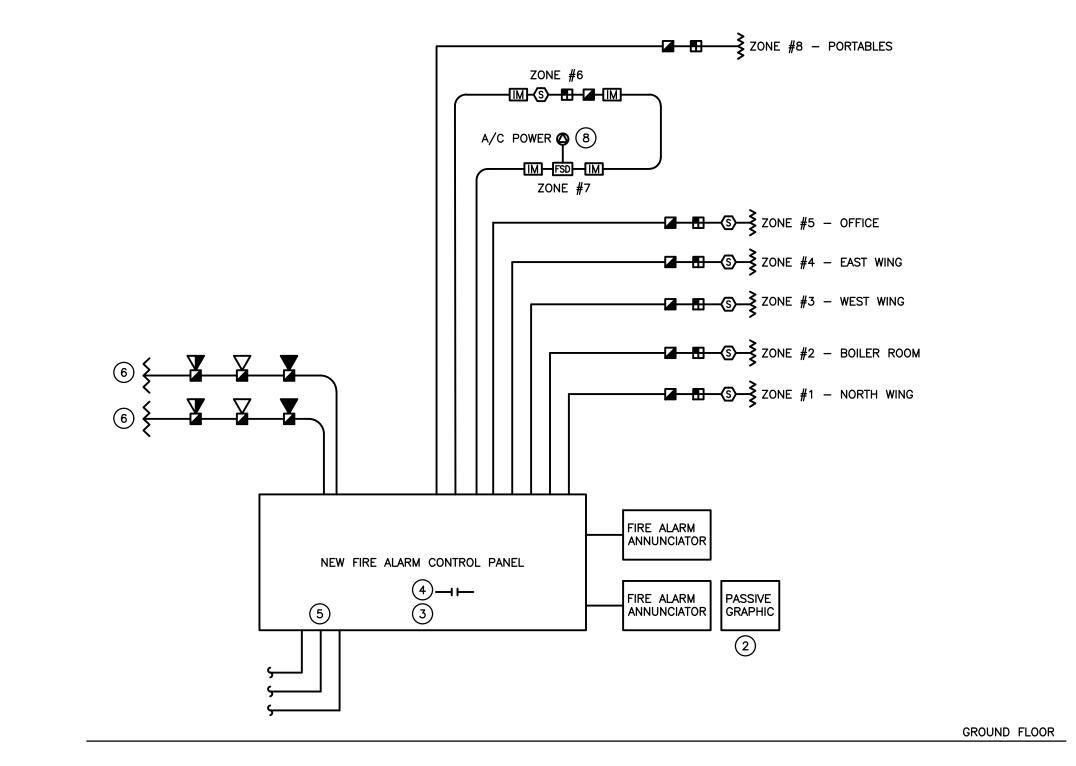

PARTIAL FIRE ALARM RISER DIAGRAM — RENOVATION scale: n.t.s.

Alarm | Supervisory

•

•

2 BOILER ROOM


7 FIRE SMOKE DAMPER

3 WEST WING

4 EAST WING

5 OFFICE 6 GYMNASIUM

8 PORTABLES 9 SPARE 10 SPARE 11 SPARE 12 SPARE

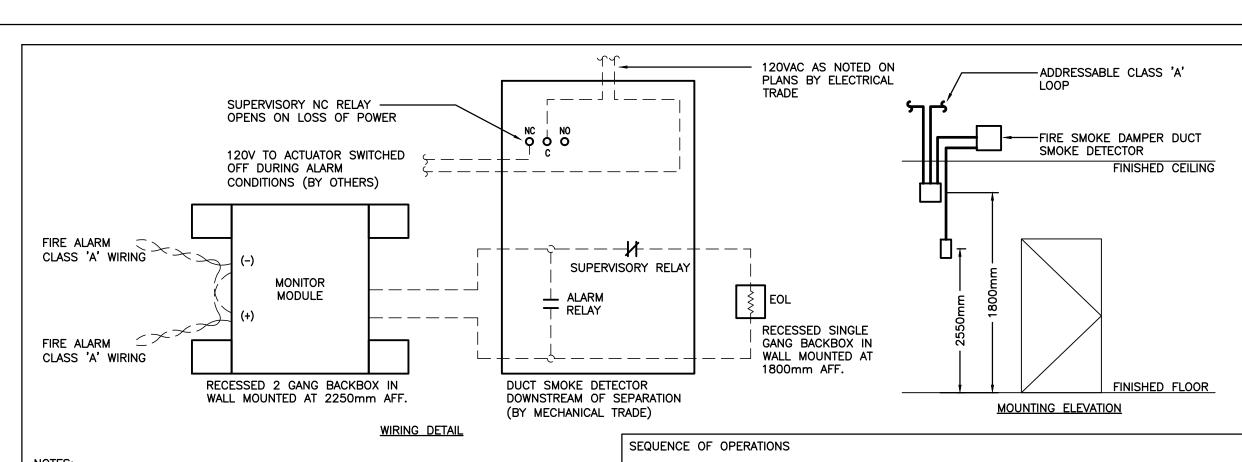

MONITOR MODULE AND END OF LINE RESISTOR DEVICE MOUNTING HEIGHTS SHALL BE PER CAN/ULC S524 (LATEST EDITION).

2. MOUNT DEVICES WITHIN ACCESSIBLE LOCATIONS IN SERVICE ROOMS, WHERE POSSIBLE. IN THE VICINITY OF RESPECTIVE FIRE SMOKE DAMPER. DEVICES IN FINISHED SPACES TO BE C/W FLUSH MOUNT DEVICE BOXES AND COVERS. DEVICE COVERS TO BE LABELLED PER CAN/ULC S524 (LATEST EDITION). A-FIRE/SMOKE DAMPER INSTALLATION DETAIL scale: NTS

NORMAL CONDITION:
ALARM CONTACT OPEN, AUXILIARY CONTACT CLOSED, AC POWER IS PROVIDED TO DAMPER ACTUATO DAMPER IS OPEN. ALARM CONDITION:
ALARM CONTACT CLOSES, BUILDING FIRE ALARM IS ACTIVATED, AUXILIARY CONTACT OPENS, AC POWE REMOVED FROM DAMPER ACTUATOR. SUPERVISION:
LOSS OF AC POWER, COVER LEFT OFF, WIRING ISSUE WILL CAUSE TROUBLE CONDITION. SUPERVISOR CONTACT OPENS, MAIN FIRE ALARM CONTROL PANEL WILL INDICATE TROUBLE, ADDRESSABLE MODULE WILL INDICATE DAMPER LOCATION. DAMPER POSITION IS NOT MONITORED BY FIRE ALARM CONTROL

	Pro	oject North	True North	
	No.	Revisions	Date	
-				
TOR,				
OWER IS				
SORY ULE L				
L				
		ICCUED FOR CONCEDUCTION	0004 00 47	
	5	ISSUED FOR CONSTRUCTION ISSUED FOR PERMIT RESPONSES	2024.09.17	
	4	ISSUED FOR TENDER	2024.06.24	
	I -	1930ED LOW TEMPER	2024.00.01	

3 ISSUED FOR PERMIT

2050 Guelph Line,

Glenview Public School

Gym Addition

143 Townsend Ave.,

Burlington, ON. L7T 1Z1

Architects

Snyder Architects Inc.

100 Broadview Ave, Suite 301, Toronto, ON M4M 3H3

t. 416.966.5444, w. snyderarchitects.ca

Consulting Engineers MECHANICAL | ELECTRICAL | AQUATIC

The contractor shall verify all dimensions and

The contractor shall verify all dimensions and report all errors and discrepancies to the Consultant before commencement of the work. The drawings show general arrangement of services. Follow as closely as actual building construction will permit. Obtain approval for relocation of service from Consultant before commencement of the work.

The drawings do not indicate all offsets fitting and accessories which may be required. Provide the same to meet the required conditions.

the same to meet the required conditions.

Drawings and specifications, etc., prepared and issued by the consultant are the property of the consultant and must be returned at the completion of the project. These documents are not to be duplicated or copied without the consent of the Consultant.

Do not scale this drawing.

© 2024 DEI Consulting Engineers Inc.

As Built Drawings

Burlington, ON.

L7P 5A8

Revision Work Completed by B-Safe Electric Ltd. as of May 31, 2025 as per drawing unless other noted in RED

2 ISSUED FOR SPA SUBMISSION 2024.02.27

I ISSUED FOR SPA REVIEW SET 2024.02.06

2024.04.19



FIRE ALARM RISER DIAGRAM AND PASSIVE GRAPHIC

2314	E302
Job No.	Drawing No.
Drawn by: SB	Checked by: RV
Scale: AS NOTED	Date: MAY 2024