
		Connection Sizes		Fixture		Trim		Accessories
tem	Туре	HW CW TW Drain Ven	nt Acceptable Manufacturer	Fixture Description	Acceptable Manufacturer	Trim Description	Acceptable Manufacturer	1
WC-1	BARRIER-FREE FLOOR MOUNTED FLUSH VALVE WATER CLOSET	25 80 40	AMERICAN STANDARD MADERA KOHLER CRANE	FLOOR-MOUNTED, FLUSH VALVE, FOR BARRIER-FREE. TOP OF SEAT TO BE BETWEEN 400 MM (16") AND 450 MM (18") FROM FINISHED FLOOR. VITREOUS CHINA, FLOOR MOUNTED, SYPHON JET, ELONGATED RIM, TOP SPUD FOR FLUSH VALVE, BOLT CAPS.	SLOAN	EXPOSED, POLISHED CHROME, EXTERNALLY ADJUSTABLE, DUAL FLUSH DIAPHRAGM TYPE WITH NPS 25 MM (1") SCREWDRIVER ANGLE STOP, OSCILLATING HANDLE, FLUSH CONNECTION AND COUPLING FOR NPS 40 MM (1 1/2") TOP SPUD, WALL AND SPUD ESCUTCHEONS, SEAT BUMPER AND VACUUM BREAKER. ULTRA LOW FLUSH CYCLE: ADJUSTABLE FROM 3.8 — 17 LITRES (1.0 — 4.5 GAL)/FLUSH, FACTORY SET TO 5.7 LITRES (1.5 GAL)/FLUSH.	SEAT: CENTOCO HL820STS BEMIS OLSONITE	SEAT: WHITE 50 MM (2") LIFT, ELONGATED, OPEN FRONT, ANTIMICROBIAL, WITH COVER, MOLDED SOLID PLASTIC, COVER, STAINLESS STEEL CHECK HINGES, STAINLESS STEEL OR SOLID BRASS INSERT POST.
/C-2	FLOOR MOUNTED FLUSH VALVE WATER CLOSET	25 80 40	AMERICAN STANDARD MADERA KOHLER CRANE	FLOOR-MOUNTED, TOP SPUD, ULTRA-LOW FLUSH, MAXIMUM 6 LITRES (1.6 GAL)/FLUSH. VITREOUS CHINA, SIPHON JET, ELONGATED RIM.	ZURN Z6000AV-WS1-DF SLOAN MOEN COMMERCIAL	EXPOSED, POLISHED CHROME, EXTERNALLY ADJUSTABLE, DUAL FLUSH DIAPHRAGM TYPE WITH NPS 25 MM (1") SCREWDRIVER ANGLE STOP, OSCILLATING HANDLE, FLUSH CONNECTION AND COUPLING FOR NPS 40 MM (1 1/2") TOP SPUD, WALL AND SPUD ESCUTCHEONS, SEAT BUMPER AND VACUUM BREAKER. ULTRA LOW FLUSH CYCLE: ADJUSTABLE FROM 3.8 - 17 LITRES (1.0 - 4.5 GAL)/ FLUSH, SET TO 5.7 LITRES	SEAT: CENTOCO AM500STSCC BEMIS OLSONITE	SEAT: HEAVY-DUTY, WHITE, ELONGATED, OPEN FRONT, ANTIMICROBIAL, MOULDED SOLID PLASTIC, LESS COVER, STAINLESS STEEL CHECK HINGES, STAINLESS STEEL OR SOLID BRASS INSERT POST.
L-1	BARRIER-FREE WALL MOUNTED LAVATORY (C/W FLOOR MOUNTED WALL CARRIER)	15 15 32 32	AMERICAN STANDARD MURRO KOHLER CRANE		DELTA 591T1250 ZURN MOAN COMMERCIAL	TRIM BARRIER-FREE ELECTRONIC FAUCET. ACTIVATED BY [INFRA-RED] SENSOR RESPONDING TO PRESENCE OF PERSON'S HANDS IN LAVATORY. SENSOR: WATERPROOF, [INCORPORATED IN BODY OF UNIT DECK-MOUNTED] WITH IMPACT-RESISTANT PLASTIC LENS WITH ANTI-SCRATCH COATING, SENSITIVITY ADJUSTABLE FROM 100 MM TO 450 MM (4" TO 18"). WATER CONSERVATION: 30 SECOND MAXIMUM RUN TIME. CONTROLS: VANDAL-PROOF. SPOUT: CHROME PLATED, WITH AERATOR HAVING INTEGRAL FLOW CONTROL FOR 8.35 L/MIN (2.2 GPM) AT 413 KPA (60 PSI) MAXIMUM. UNDER-COUNTER TEMPERATURE THERMOSTATIC MIXING CONTROL VALVE. (POWERS OR EQUAL). SUITABLE FOR 120/1/60.	INSULATION: MCGUIRE PROWRAP TRUEBRO	INSULATE WASTE AND SUPPLIES WITH UL LISTED PREFORMED INSULATION SYSTEM COMPLETE WITH SEAMLESS JACKET. PROVIDE POWERS HYDROGUARD SERIES LFLM495 OR EQUAL THERMOSTATIC MIXING VALVE TO LIMIT THE HOT WATER SUPPLY TEMPERATURE. WASTE FITTING: GRID STRAINER. PROVIDE OFFSET P/O + GUARD FOR BARRIER FREE. COMPLETE WITH PLUG—IN TRANSFORMER SUITABLE FOR 120/1/60. PROVIDE FLOOR MOUNTED WALL CARRIER
L-2	WALL MOUNTED LAVATORY (C/W FLOOR MOUNTED WALL CARRIER)	15 15 32 32	AMERICAN STANDARD LUCERNE KOHLER CRANE	DEPRESSIONS, SUPPLY OPENINGS ON 100 MM (4") CENTRES, OVERFLOW.	DELTA 591T1250 ZURN MOAN COMMERCIAL	TRIM BARRIER-FREE ELECTRONIC FAUCET. ACTIVATED BY [INFRA-RED] SENSOR RESPONDING TO PRESENCE OF PERSON'S HANDS IN LAVATORY. SENSOR: WATERPROOF, [INCORPORATED IN BODY OF UNIT DECK-MOUNTED] WITH IMPACT-RESISTANT PLASTIC LENS WITH ANTI-SCRATCH COATING, SENSITIVITY ADJUSTABLE FROM 100 MM TO 450 MM (4" TO 18"). WATER CONSERVATION: 30 SECOND MAXIMUM RUN TIME. CONTROLS: VANDAL-PROOF. SPOUT: CHROME PLATED, WITH AERATOR HAVING INTEGRAL FLOW CONTROL FOR 8.35 L/MIN (2.2 GPM) AT 413 KPA (60 PSI) MAXIMUM. UNDER-COUNTER TEMPERATURE THERMOSTATIC MIXING CONTROL VALVE. (POWERS OR EQUAL). SUITABLE FOR 120/1/60.	MCGUIRE PROWRAP TRUEBRO	INSULATE WASTE AND SUPPLIES WITH UL LISTED PREFORMED INSULATION SYSTEM COMPLETE WITH SEAMLESS JACKET. PROVIDE POWERS HYDROGUARD SERIES LFLM495 OR EQUAL THERMOSTATIC MIXING VALVE TO LIMIT THE HOT WATER SUPPLY TEMPERATURE. WASTE FITTING: NPS 32 MM (1½") OFFSET WASTE WITH GRID STRAINER. COMPLETE WITH PLUG—IN TRANSFORMER SUITABLE FOR 120/1/60. PROVIDE FLOOR MOUNTED OR WALL CARRIER
D-1	GENERAL DUTY FLOOR DRAIN	NOTED 40	ZURN ZN-415-B MIFAB F1100C WATTS DRAINAGE FD-100-C-AS-1 OR FD-100-C-LS-1 JAY R. SMITH 2005-A05NB	GENERAL DUTY CAST IRON BODY, ADJUSABLE HEAD, NICKEL BRONZE STRAINER, INTEGRAL SEEPAGE PAN, AND CLAMPING COLLAR. USE SQUARE STRAINER IN TILED AREAS AND ROUND STRAINER ELSEWHERE. C/W TRAP PRIMER				
RD-1	ROOF DRAIN	NOTED	ZURN ZA121-CR MIFAB R1200-BU CONTOUR C1000DMP WATTS RD-100-BED-K SMITH 1015-C-R-AD	STANDARD ROOF DRAIN WITH CAST IRON BODY WITH ALUMINUM DOME, UNDER-DECK CLAMP TO SUIT ROOF CONSTRUCTION, ROOF SUMP RECIEVER, FLASHING CLAMP WITH INTEGRAL GRAVEL STOP.				

	Туре	Noi		Nominal Capacity		ESP	Motor	or Electrical Data		a	Acceptable	Netos
Item		tons	cfm	Heat MBH	Cool MBH	⊣ .		Voltage	MCA	моср	Manufacturer	Notes
VAC-1	PACKAGED ROOFTOP HVAC UNIT	20	7000	400	242	1.5	2.9	575/3/60	47	60	TRANE DHJ240AWSAH	HIGH HEAT, DOWN DISCHARGE & RETURN. INTEGRAL AIR/SOURCE HEAT PUMP OPERATION C/W NATURAL GAS BACKUP, 24" HIGH ROOF CURB WITH VIBRATION ISOLATION RAIL.

<u>G</u> F	RILLE SCHEDULE	=			CAPACITY INDICATED ON SCHEDULE REFER TO SPECIFICATION FOR CONSTRUCTION STANDARDS, ACCESSORIES AND ADDITIONAL INFORMATION.
Item	Туре	Manufacturer & Model	Finish	Remarks	
D1	ROUND CEILING SUPPLY	KRUEGER RA2	BAKED OFF WHITE	C/W SAFETY CHAINS. SLIDING ADJUSTMENT NOT ACCEPTABLE	
D2	ROUND SUPPLY	KRUEGER RA2	BAKED OFF WHITE	C/W SAFETY CHAINS & GUARD. SLIDING ADJUSTMENT NOT ACCEPTABLE	
R1	CEILING RETURN/EXHAUST	KRUEGER EGC5	BAKED OFF WHITE	C/W SCREWED FASTENING	
R2	GYMNASIUM RETURN	KRUEGER S480	BAKED OFF WHITE	C/W SCREWED FASTENING	

FAN SCHEDULE ACCESSORIES AND ADDITIONAL INFORM									
Item	Туре	Service	Exh Capacity cfm	aust Air Size hp	Data SP in. wc	Voltage	Manufacturer	Model	Remarks
EF-1	ROOF MOUNTED EXHAUST	WASHROOM EXHAUST	400	1/4	0.75	120/1/60	PENN BARRY		C/W 600mm (24") HIGH INSULATED ROOF CURB & BACKDRAFT DAMPER. DVR BY BAS CONTRACTOR
EF-2	RANGEHOOD (DUCTED)	STAFF ROOM	210	Fhp 3 SPD	0.20	120/1/60	BROAN	SAHALE BKDF1	CONTOURED STEEL HOUSING, FULLY ENCLOSED BOTTOM, TOP DISCHARGE, CENTIFUGAL BLOWER WHEELS, WASHABLE ALUMINUM FILTERS, 3 SPEED BLOWER CONTROL, PROVIDE 2 LEVEL LED LIGHTING. COLOUR SELECTED BY CONSULTANT.
EF-3	CEILING EXHAUST FAN	EXTERIOR STORAGE RM.	100	Fhp	0.20	120/1/60	BROAN	L100	ACOUSTICALLY INSULATED STEEL HOUSING, CENTIFUGAL BLOWER WHEEL, 90° DISCHARGE OUTLET W/BACKDRAFT DAMPER, C/W WHITE PAINTED ENAMEL STEEL CRILLE VIRRATION ISOLATORS 1.1 SONES

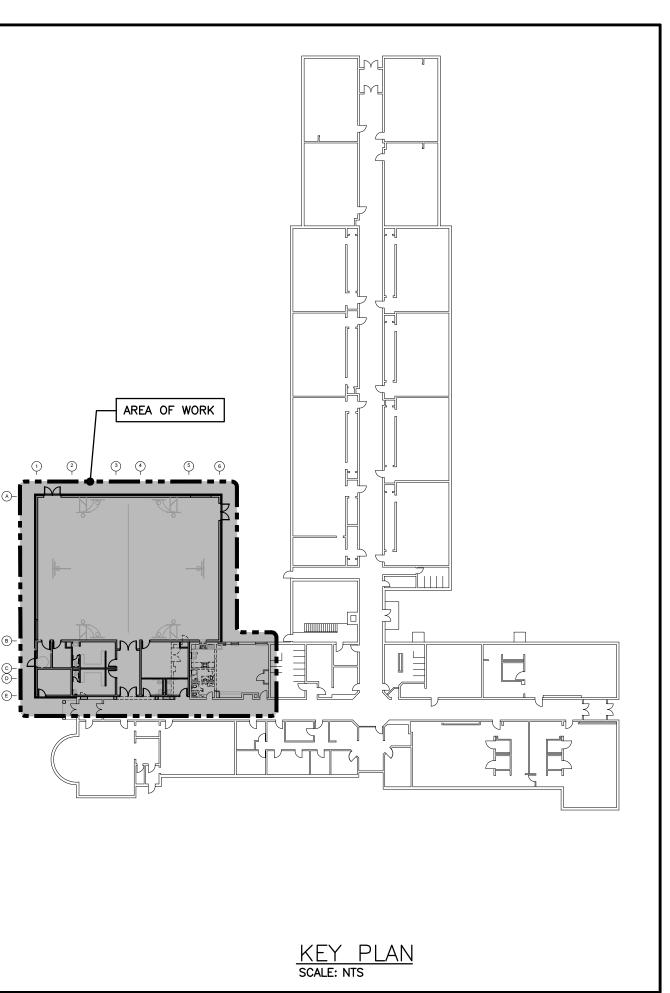

Item	Description	ltem	Description
	CUT EXISTING & CONNECT NEW PIPING	o	INLINE PUMP
—	FLOW DIRECTION	TCV	TEMPERATURE CONTROL VALVE
	DOMESTIC COLD WATER PIPING	□ FE	RECESSED CABINET MOUNTIERE EXTINGUISHER
	DOMESTIC HOT WATER PIPING	▼ FE	WALL MOUNTED FIRE EXTINGUISHER
	DOMESTIC HOT WATER RECIRC. PIPING	[] ғв	FIRE BLANKET IN CABINE
	EXISTING DOMESTIC COLD WATER PIPING	o ^{co}	FLOOR CLEANOUT
	EXISTING DOMESTIC HOT WATER PIPING	СФ	THERMOSTAT (WITH OR WITHOUT GUARD)
	EXISTING DOMESTIC HOT WATER RECIRC. PIPING)))))	TURNING VANES
EX-SAN-	EXISTING SANITARY PIPING ABOVE FLOOR		BETRUREN / ADVAHADULAST AIR DU
— —EX—SAN—	EXISTING SANITARY PIPING BELOW FLOOR		
— — SAN — —	SANITARY PIPING ABOVE FLOOR	-	ACOUSTIC DUCT LINING
——SAN——	SANITARY PIPING BELOW FLOOR		BRERMALLINEUSATIONN CO
—ST-·—	EXISTING STORM PIPING ABOVE FLOOR] _[/ ₁ , ,	C/W BALANCING DAMPER
—ST-·—	EXISTING STORM PIPING BELOW FLOOR		TRUNK MAIN BRANCH CO
—sr-·—	STORM PIPING ABOVE FLOOR		C/W BALANCING DAMPER
sr	STORM PIPING BELOW FLOOR		
——SP——	SPRINKLER PIPING	— BD	BALANCING DAMPER
——н w s——	HEATING WATER SUPPLY PIPING	— OBD	OPPOSED BLADE DAMPER
— —HWR— —	HEATING WATER RETURN PIPING	— FD	FIRE DAMPER
——G——	NATURAL GAS PIPING		FLEXIBLE ROUND DUCT
——HPG——	HIGH PRESSURE NATURAL GAS PIPING		RIGID ROUND DUCT
FD G F →	FLOOR DRAIN	Type Size Cap.	DIFFUSER/GRILLE SIZE (in TYPE & CAPACITY (cfm)
O-P-	TRAP PRIMER	Size 1	HYDRONIC HEATING SIZE,
	TEE CONNECTION	Capacity	TYPE & CAPACITY
c—	PIPE DOWN	AD	ACCESS DOOR
o —	PIPE UP		EXPANSION COMPENSATOR/JOINT
	SCREWED OR WELDED PIPE CAP	RIC	RETURN IN CABINET
——I © I———	BALL VALVE	AFF	ABOVE FINISHED FLOOR
pa BV	BALANCING VALVE	——ЕХ——	EXISTING DUCT (SIZE AS INDICATED)

GENERAL NOTES

- A. ALL DRAWINGS ARE TO BE READ IN CONJUNCTION WITH THE PREPARED SPECIFICATION.
- B. CONTRACTOR TO INCLUDE COST FOR CONSULTANT TO COMPLETE ELECTRONIC CAD AS-BUILT DWGS (ALL PAGES). REFER TO SPEC SECTION 20 02 51 RECORD DWGS.
- C. ALL PIPING, DUCTWORK, AND EQUIPMENT IS TO BE RESTRAINED TO MEET SEISMIC CODE REQUIREMENTS. SUPPLY AND INSTALL ALL SEISMIC RESTRAINT MATERIALS TO MANUFACTURER'S WRITTEN INSTRUCTIONS. REFER TO SPECIFICATION.
- D. SANITARY VENT PIPING IS NOT SHOWN. PROVIDE ALL NECESSARY VENT PIPING FROM ALL FIXTURES FOR A COMPLETE SYSTEM TO ALL LOCAL PLUMBING CODE & LOCAL AUTHORITY REQUIREMENTS, CONNECTED TO EXISTING VENTS OR NEW VENTS AS REQUIRED. CO—ORDINATE VENT LOCATION(S) WITH GENERAL CONTRACTOR. MAINTAIN MIN 14'—0" FROM ANY AIR INLET. INSTALL VENT PIPING HIGH IN JOIST SPACE.
- E. WHERE DUCTWORK PENETRATES CORRIDOR WALL, CENTER DUCT(S) BETWEEN OWSJ.
- F. CO-ORDINATE WITH THE GENERAL CONTRACTOR ANY OWSJ BRIDGING/CROSS BRACING RELOCATION OR REMOVAL/REPLACEMENT REQUIRED FOR INSTALLATION OF DUCTWORK.

 G. CONTRACTOR TO LOCATE ISOLATION VALVES / FREEZE PIPING / OR OTHERWISE DRAIN SYSTEMS TO ALLOW PROPOSED WORK TO PROCEED. REFILL SYSTEMS AS INDICATED.
- H. UPON COMPLETION OF THE PROJECT OR UPON COMPLETION OF EACH INDIVIDUAL PHASE OF THE PROJECT THE CONTRACTORS SHALL PROVIDE THE FOLLOWING CERTIFICATES BEFORE CONFORMANCE LETTERS ARE ISSUED BY THE CONSULTANT:
- CONFORMANCE LETTERS ARE ISSUED BY THE CONSULTANT:

 POTABLE WATER TEST (SEE SPEC 22 11 16 PART 3)

 COPY OF MANDATORY TSSA/CSA-B149 GAS PRESSURE TEST TAG

 MECHANICAL SEISMIC RESTRAINT ENGINEER'S INSPECTION/CONFORMANCE LETTER
- ALL CERTIFICATES ARE TO BE SUBMITTED TOGETHER IN A SINGLE PACKAGE.

IMPORTANT NOTES

- A. SEISMIC RESTRAINT IS REQUIRED FOR THIS PROJECT.
- B. ALL PIPING, DUCTWORK AND EQUIPMENT IS TO BE RESTRAINED TO MEET CODE REQUIREMENTS. THE SEISMIC RESTRAINT MANUFACTURER SHALL PROVIDE DOCUMENTATION ON MAXIMUM RESTRAINT SPACING FOR VARIOUS RESTRAINT SIZES AND ANCHORS, AS WELL AS "WORST CASE" REACTION LOADS FOR EACH RESTRAINT AND/OR ANCHOR SIZE.
- C. SUBMIT SHOP DRAWING AND DESIGN CALCULATION TO CALCULATE REQUIREMENTS FOR SELECTING SEISMICALLY RATED VIBRATION ISOLATORS AND SEISMIC RESTRAINTS. CERTIFICATION DOCUMENTS
 TO BE SIGNED AND SEALED BY A QUALIFIED PROFESSIONAL ENGINEER WITH AT LEAST 5 YEARS OF EXPERIENCE IN THE DESIGN OF SEISMIC RESTRAINTS. PROFESSIONAL ENGINEER SHALL HAVE
 LOCAL JURISDICTION AND PROVIDE PERIODIC FIELD REVIEW AND FINAL CERTIFICATION UPON COMPLETION OF THE PROJECT. ALL COSTS AND FEES ASSOCIATED WITH THE ENGINEERING SHALL BE
 THE RESPONSIBILITY OF THIS CONTRACTOR.
- D. REFER TO SPECIFICATION FOR ADDITIONAL REQUIREMENTS.



2050 Guelph Line, Burlington, ON. L7P 5A8

Glenview Public School

Gym Addition

143 Townsend Ave.,

Burlington, ON. L7T 1Z1

Architects





The contractor shall verify all dimensions and report all errors and discrepancies to the Consultant before commencement of the work. The drawings show general arrangement of services. Follow as closely as actual building construction will permit. Obtain approval for relocation of service from Consultant before commencement of the work.


The drawings do not indicate all offsets fitting and accessories which may be required. Provide the same to meet the required conditions. Drawings and specifications, etc., prepared and issued by the consultant are the property of the consultant and must be returned at the completion of the project. These documents are not to be duplicated or copied without the consent of the Consultant.

Do not scale this drawing.

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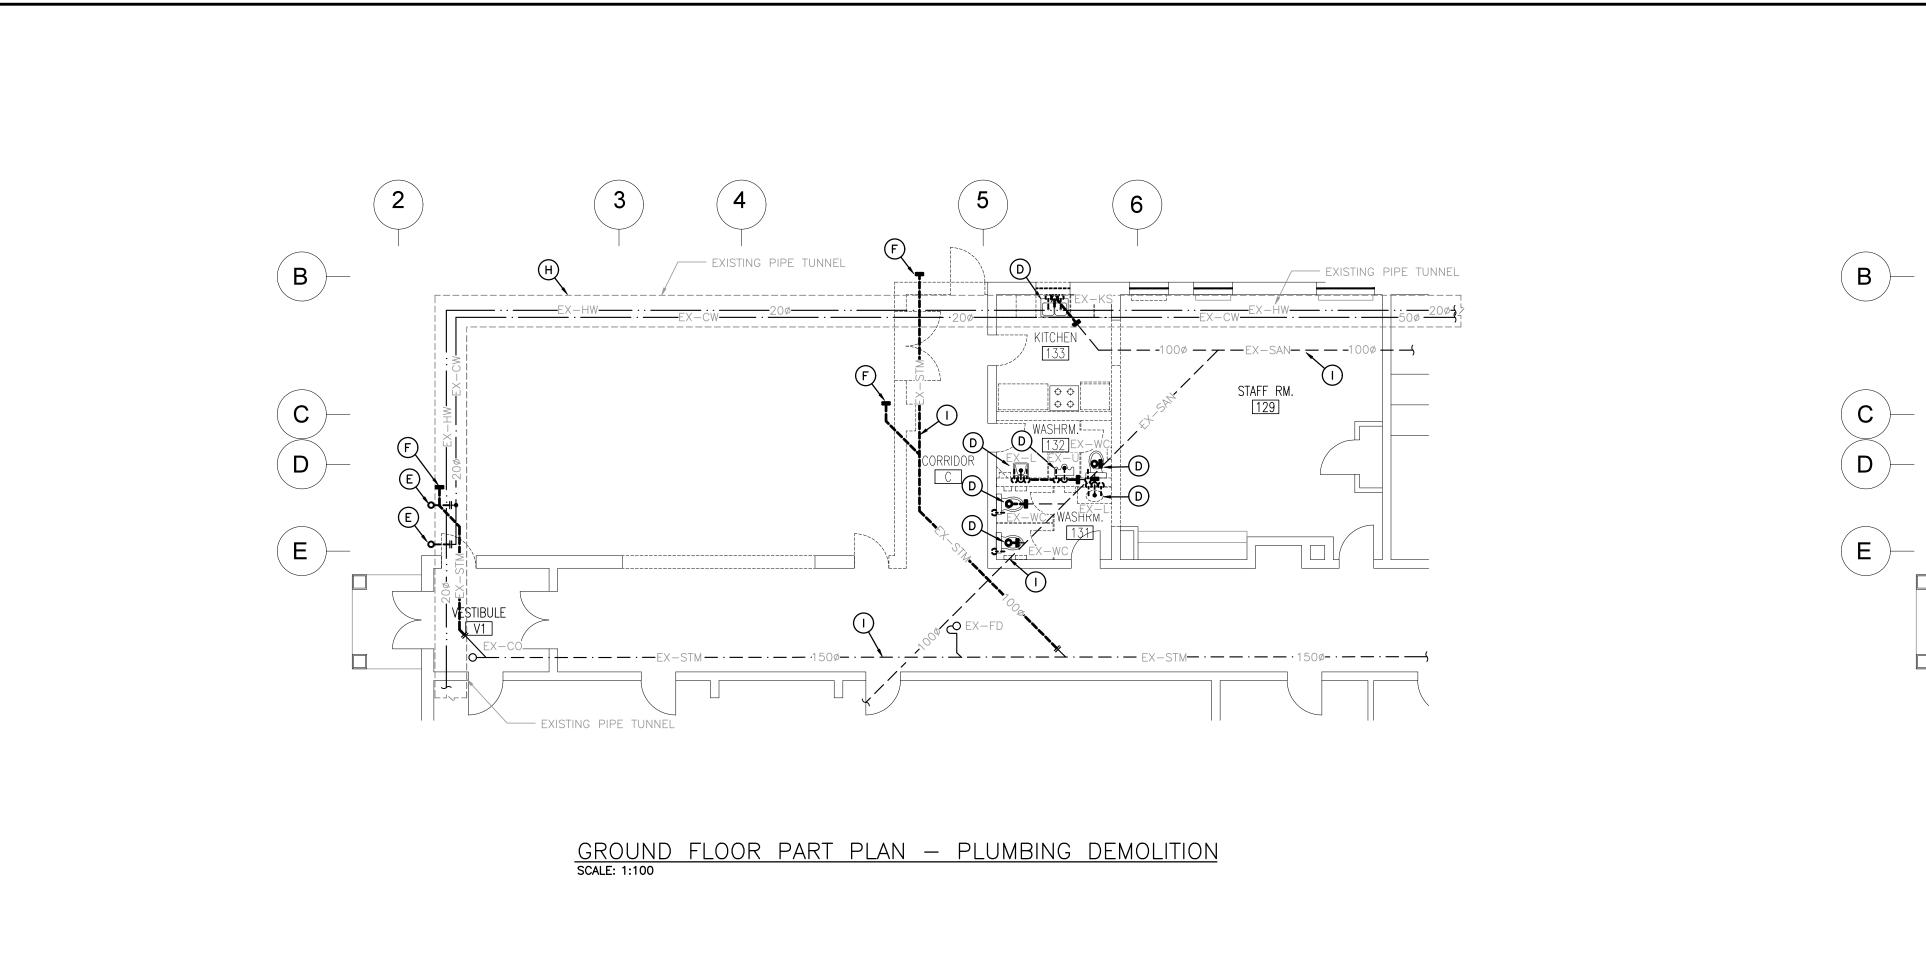
As Built Drawings


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Pr	oject North	True North
No.	Revisions	Date
5	AS-BUILT DRAWING	2025-09-29
4	ISSUED FOR TENDER	2024.04.30
3	ISSUED FOR PERMIT	2024.04.19
2	ISSUED FOR SPA SUBMISSION	2024.02.27
1	ISSUED FOR SPA REVIEW SET	2024.02.06
No	Revision	Date

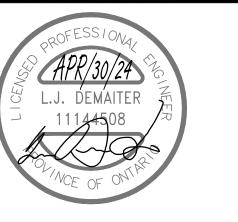

SITE PLAN, LEGEND, & SCHEDULES

2314	M101
Job No.	Drawing No.
Drawn by: IE	Checked by: MW
Scale: AS NOTED	Date: APR 2024



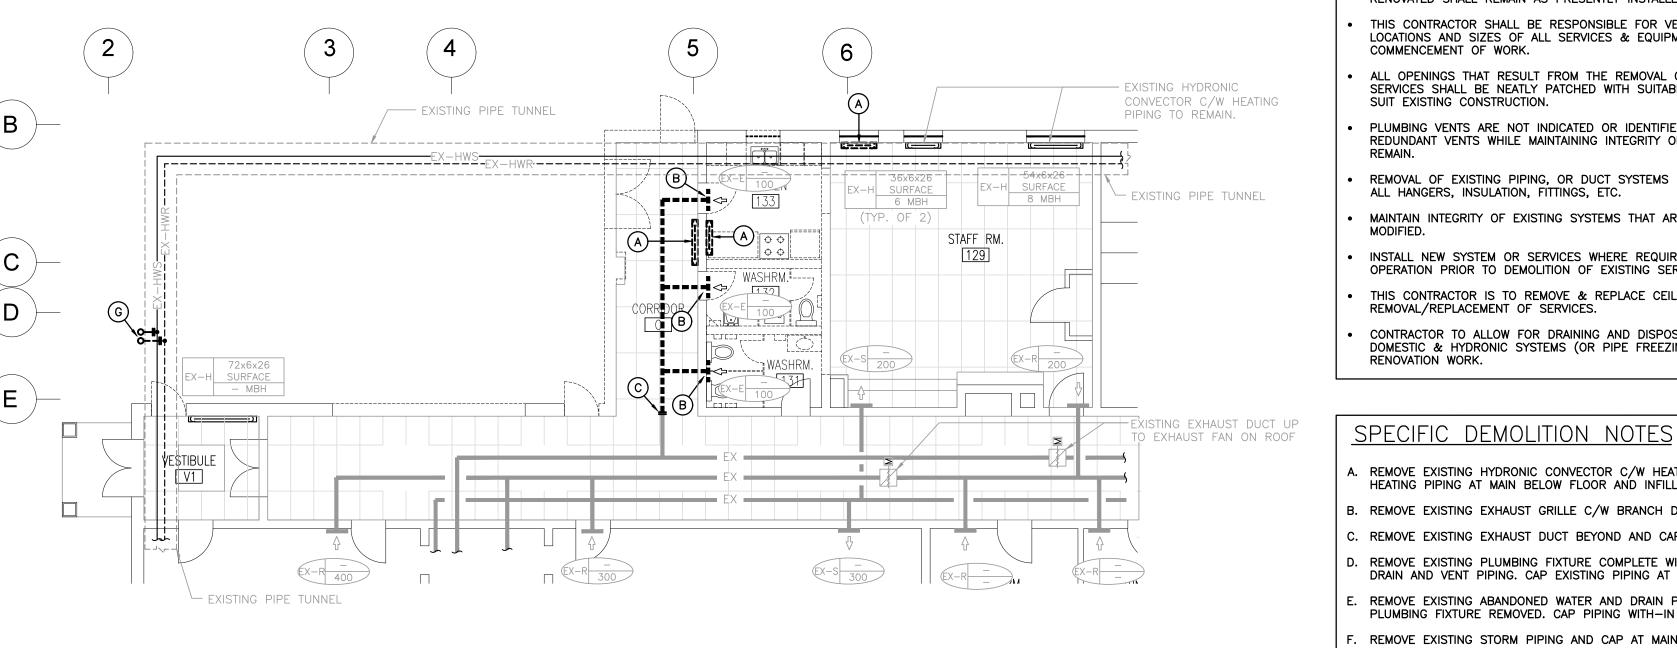

GROUND FLOOR PART PLAN — HVAC DEMOLITION SCALE: 1:100


GENERAL DEMOLITION NOTES


- EXISTING MECHANICAL ITEMS NOT SHOWN SHALL REMAIN UNLESS NOTED EXISTING MECHANICAL ITEMS SHOWN BUT NOT NOTED AS BEING REMOVED OR
- RENOVATED SHALL REMAIN AS PRESENTLY INSTALLED AND OPERATING. THIS CONTRACTOR SHALL BE RESPONSIBLE FOR VERIFYING ON SITE ALL LOCATIONS AND SIZES OF ALL SERVICES & EQUIPMENT PRIOR TO THE
- ALL OPENINGS THAT RESULT FROM THE REMOVAL OF EQUIPMENT OR SERVICES SHALL BE NEATLY PATCHED WITH SUITABLE NEW MATERIALS TO SUIT EXISTING CONSTRUCTION. PLUMBING VENTS ARE NOT INDICATED OR IDENTIFIED. REMOVE ALL REDUNDANT VENTS WHILE MAINTAINING INTEGRITY OF EXISTING SYSTEMS TO
- REMOVAL OF EXISTING PIPING, OR DUCT SYSTEMS INCLUDES REMOVAL OF ALL HANGERS, INSULATION, FITTINGS, ETC.
- MAINTAIN INTEGRITY OF EXISTING SYSTEMS THAT ARE TO REMAIN OR BE INSTALL NEW SYSTEM OR SERVICES WHERE REQUIRED TO MAINTAIN SYSTEM OPERATION PRIOR TO DEMOLITION OF EXISTING SERVICES. THIS CONTRACTOR IS TO REMOVE & REPLACE CEILINGS AS REQUIRED FOR REMOVAL/REPLACEMENT OF SERVICES.


CONTRACTOR TO ALLOW FOR DRAINING AND DISPOSING OF ENTIRE SCHOOL DOMESTIC & HYDRONIC SYSTEMS (OR PIPE FREEZING AS REQUIRED) TO SUIT

RENOVATION WORK.

- . REMOVE EXISTING HYDRONIC CONVECTOR C/W HEATING PIPING AND CAP HEATING PIPING AT MAIN BELOW FLOOR AND INFILL HOLES.
- REMOVE EXISTING EXHAUST GRILLE C/W BRANCH DUCT AND CAP AT MAIN. REMOVE EXISTING EXHAUST DUCT BEYOND AND CAP AT MAIN. REMOVE EXISTING PLUMBING FIXTURE COMPLETE WITH ASSOCIATED WATER,
- DRAIN AND VENT PIPING. CAP EXISTING PIPING AT MAIN. REMOVE EXISTING ABANDONED WATER AND DRAIN PIPING FROM PREVIOUS PLUMBING FIXTURE REMOVED. CAP PIPING WITH-IN TUNNEL.
- REMOVE EXISTING STORM PIPING AND CAP AT MAIN UNDERGROUND. REMOVE EXISTING ABANDONED HEATING PIPING FROM PREVIOUS HEATER REMOVED. CAP PIPING WITH—IN TUNNEL.
- . APPROXIMATE LOCATION OF EXISTING PIPING TUNNEL. CONTRACTOR TO CONFIRM EXACT SIZE, ROUTE, LOCATION & INVERT ON SITE. CONTRACTOR TO COORDINATE LOCATION WITH GC AND ENSURE TUNNEL IS PROTECTED DURING
- APPROXIMATE LOCATION OF EXISTING STORM & SANITARY MAINS. CONTRACTOR TO CONFIRM EXACT SIZE, ROUTE, LOCATION & INVERT ON SITE (XRAY, SCAN AND CAMERA DRAIN AS REQUIRED). TYPICAL ALL STORM AND SANITARY MAINS

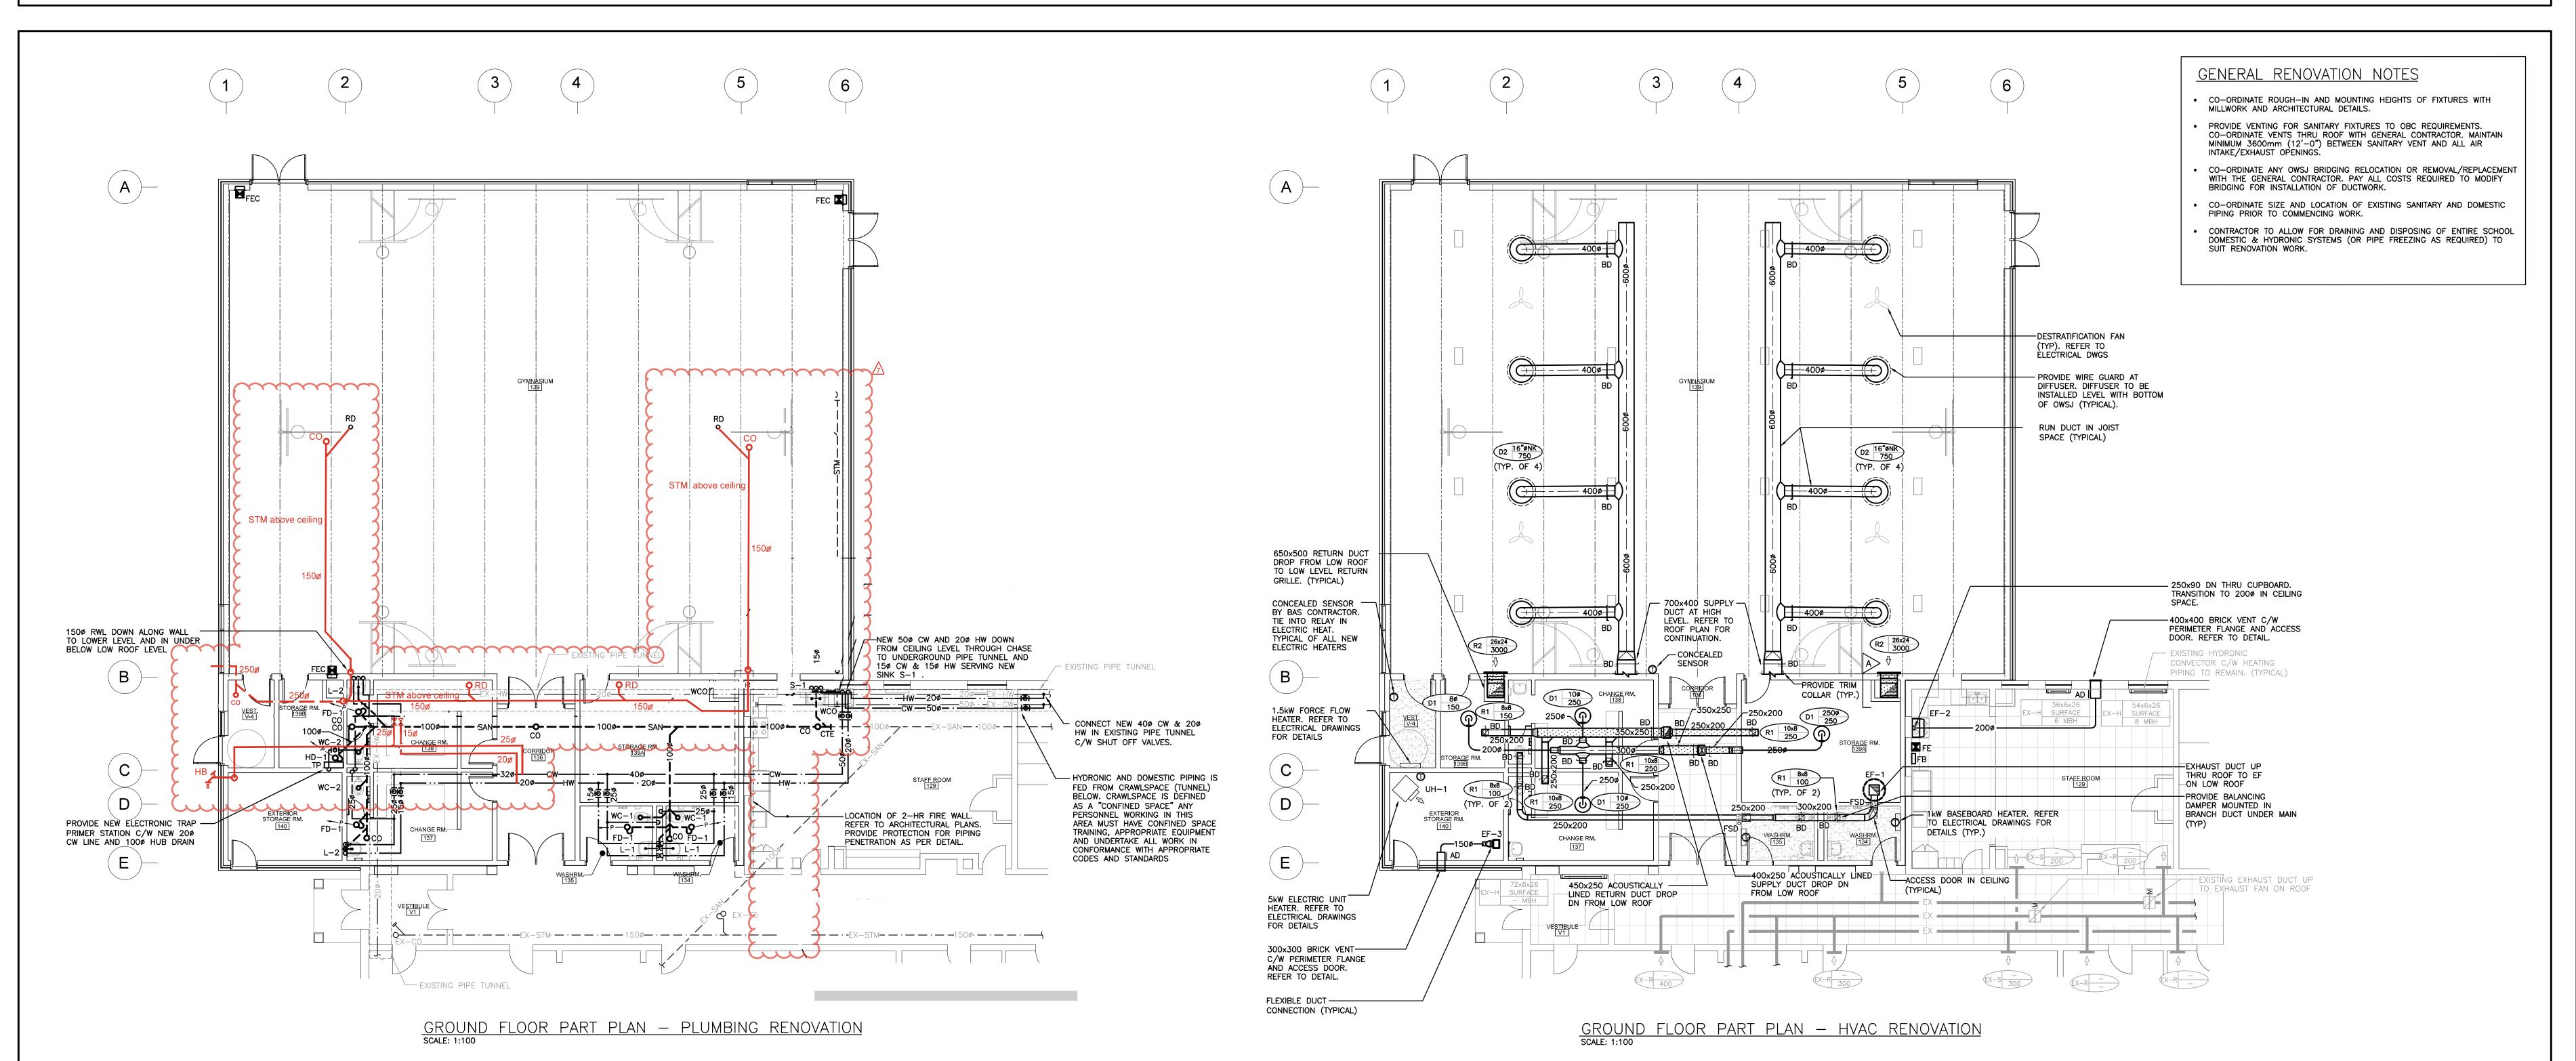

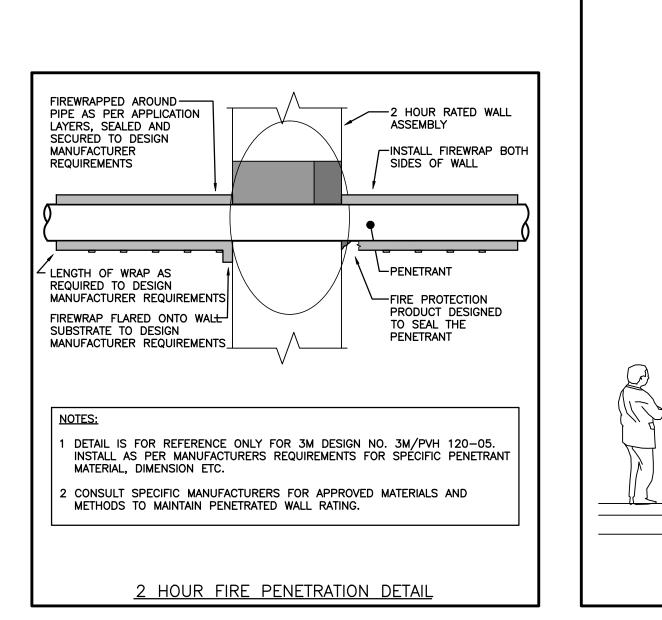

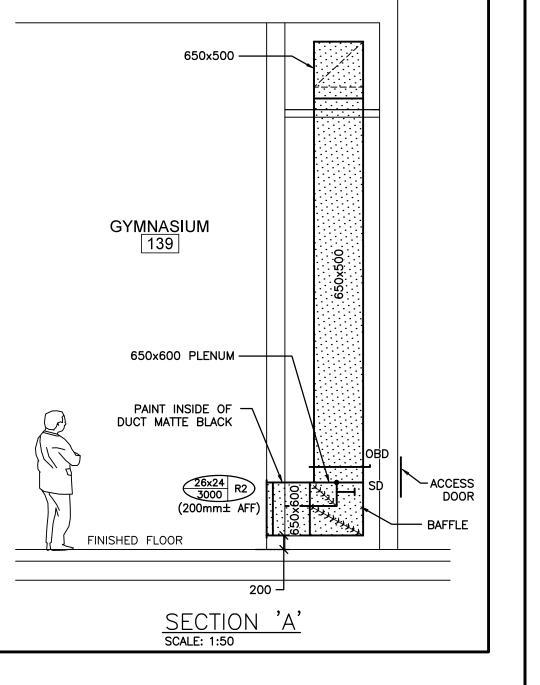



2050 Gue<mark>l</mark>ph Line, Burlington, ON. L7P 5A8

Glenview Public School Gym Addition

143 Townsend Ave.,

Burlington, ON. L7T 1Z1

Architects Snyder Architects Inc.

100 Broadview Ave, Suite 301,

Toronto, ON M4M 3H3

t. 416.966.5444, w. snyderarchitects.ca




The contractor shall verify all dimensions and report all errors and discrepancies to the Consultant before commencement of the work. The drawings show general arrangement of services. Follow as closely as actual building construction will permit. Obtain approval for relocation of service from Consultant before commencement of the work. The drawings do not indicate all offsets fitting and accessories which may be required. Provide the same to meet the required conditions. Drawings and specifications, etc., prepared and issued by the consultant are the property of the consultant and must be returned at the completion of the project. These documents are not to be duplicated or copied without the consent of the Consultant.

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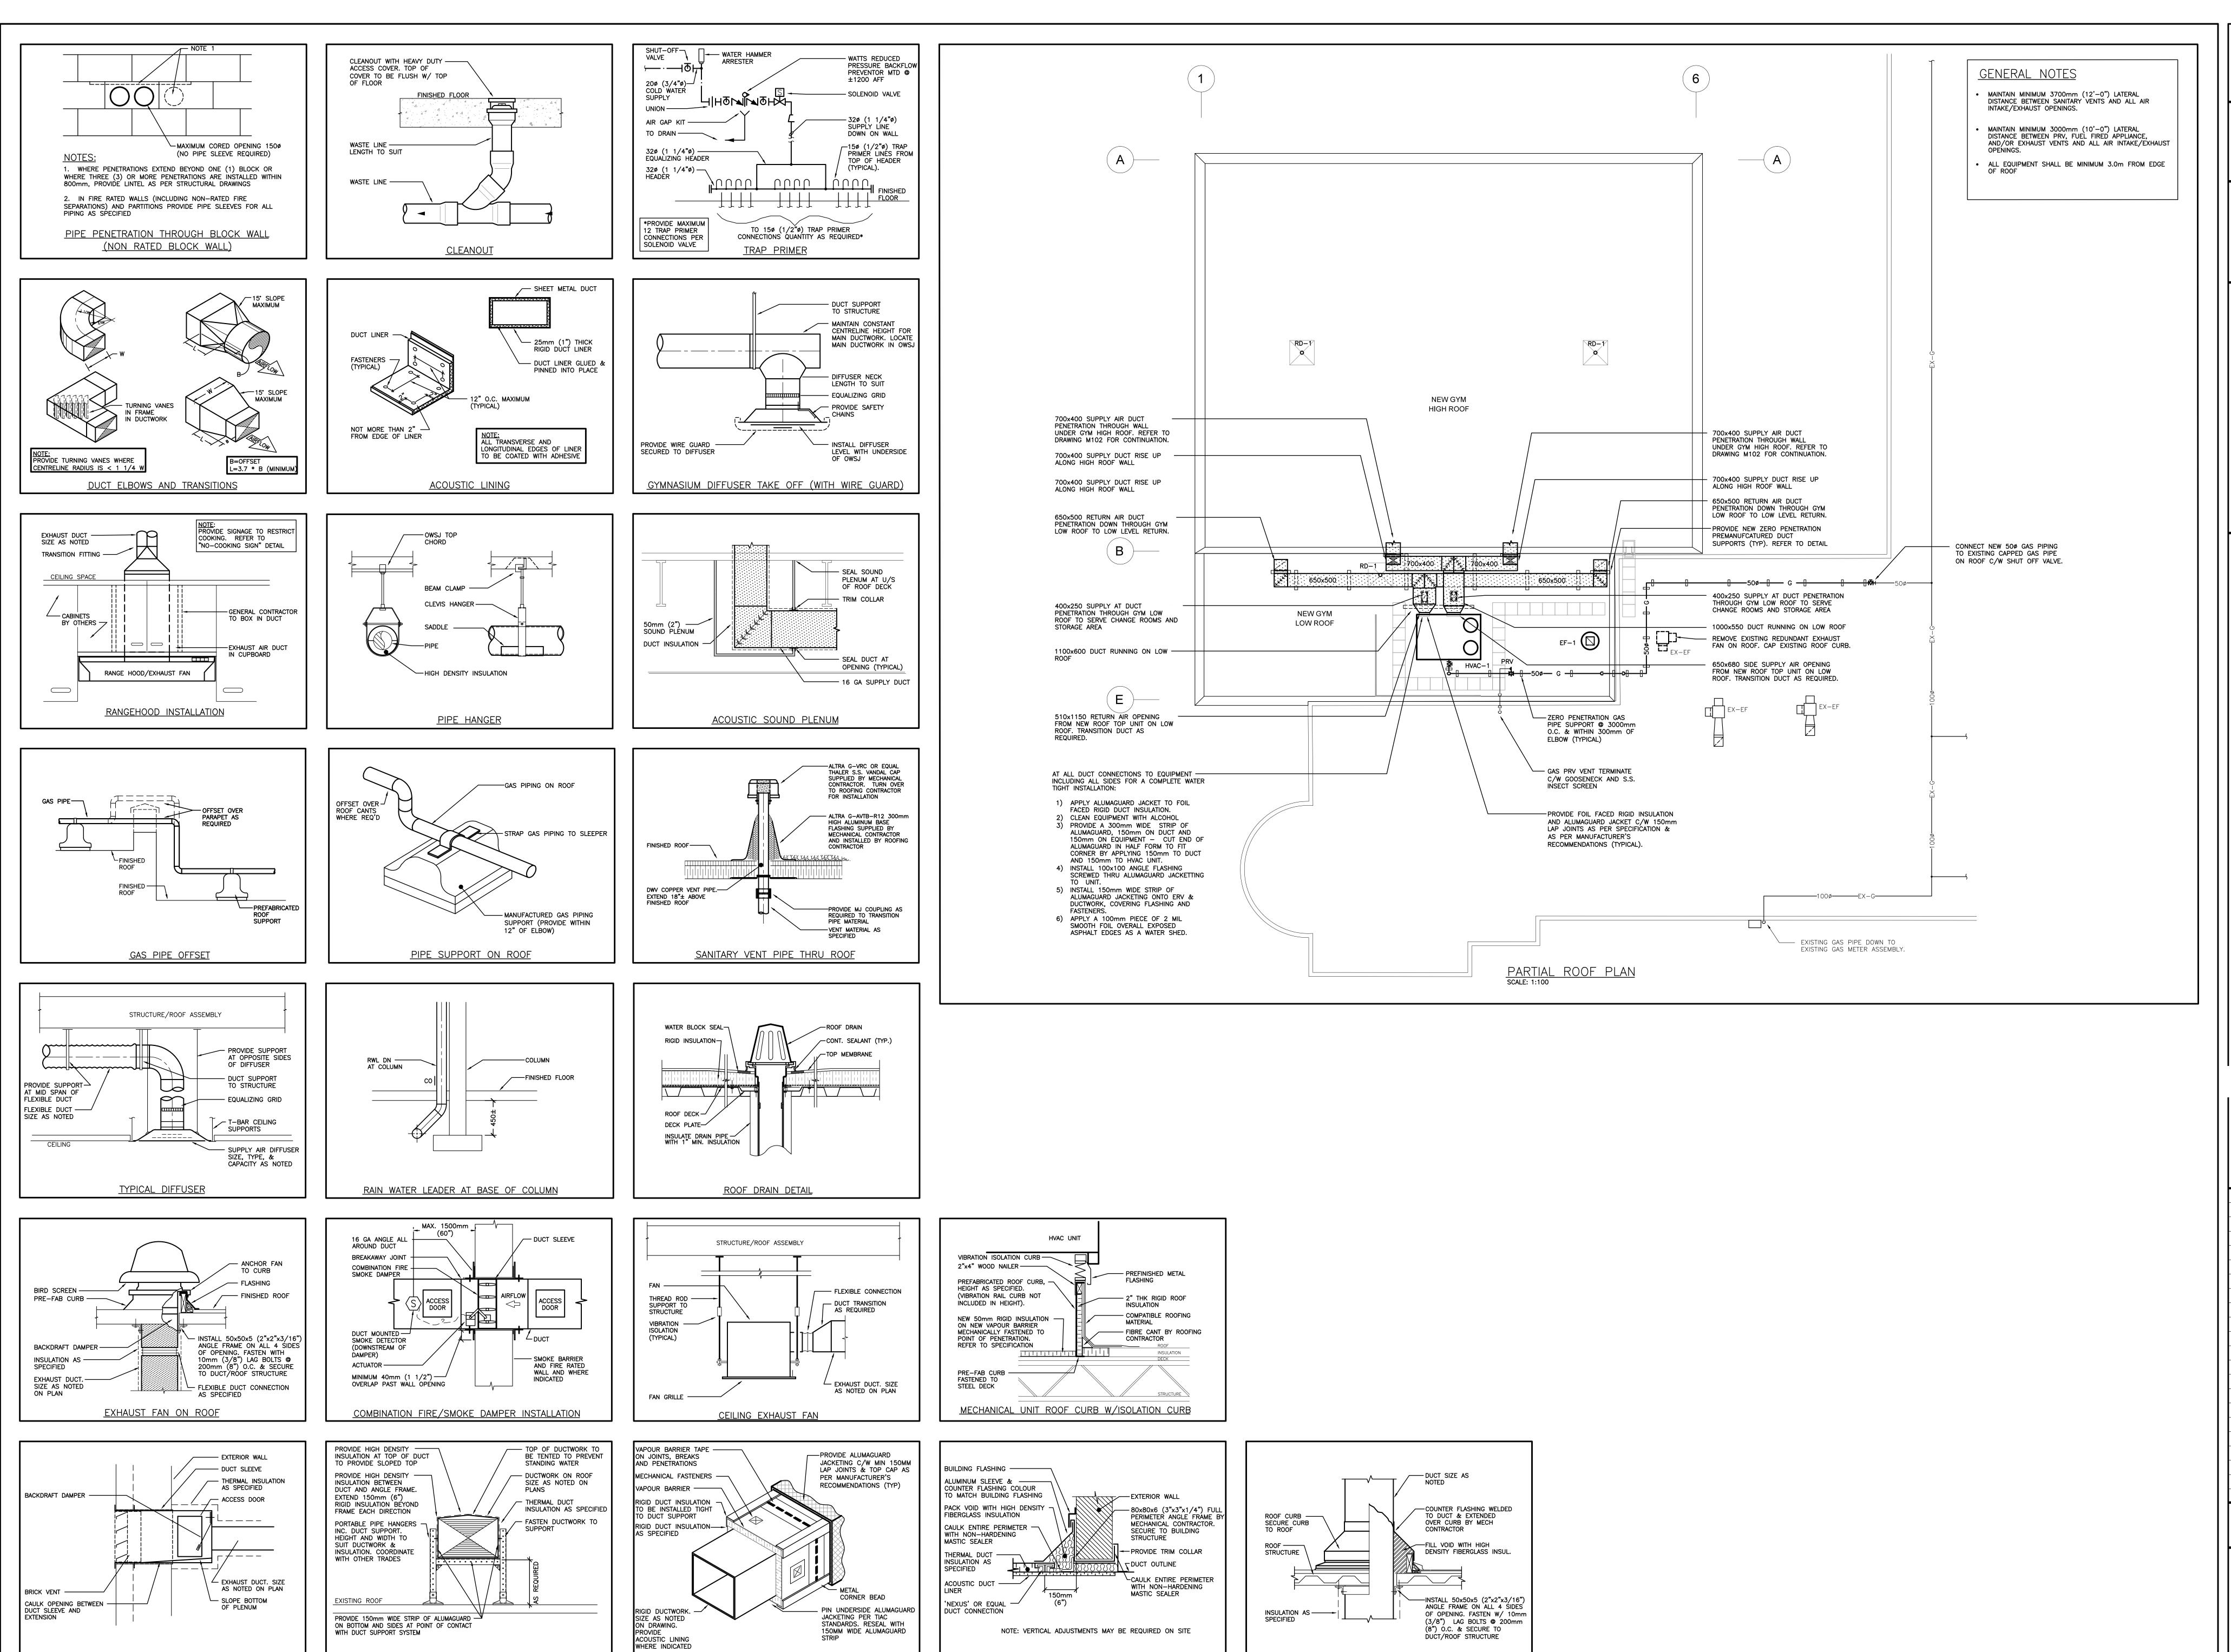
As Built Drawings

(
Pro	oject North	True North
No.	Revisions	Date
^		
⅓	AS-BUILT DRAWING	2025.07.21
6	ISSUED FOR CONSTRUCTION	2024.09.17
5	ISSUED FOR PERMIT RESPONSES	2024.06.24
4	ISSUED FOR TENDER	2024.05.01
3	ISSUED FOR PERMIT	2024.04.19
2	ISSUED FOR SPA SUBMISSION	2024.02.27
1	ISSUED FOR SPA REVIEW SET	2024.02.06
No	Revision	Date

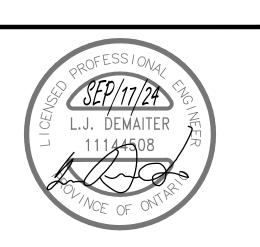

Drawing Title: GROUND FLOOR DEMOLITION & RENOVATION DRAWINGS

2314	M102
Job No.	Drawing No.
Drawn by: XX	Checked by: XX
Scale: AS NOTED	Date: MAY 2024



DUCT THRU EXTERIOR WALL

BRICK VENT

DUCT SUPPORT ON ROOF

EXTERIOR DUCT INSTALLATION

SQUARE DUCT THRU ROOF

2050 Guelph Line, Burlington, ON. L7P 5A8

Glenview Public School Gym Addition

> 143 Townsend Ave., Burlington, ON. L7T 1Z1

> > Architects

Snyder Architects Inc 100 Broadview Ave, Suite 301, Toronto, ON M4M 3H3 t. 416.966.5444, w. snyderarchitects.ca




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As Built Drawings

(N	
Pr	oject North	True North
No.	Revisions	Date
5	AS-BUILT DRAWING	2025-09-29
4	ISSUED FOR TENDER	2024.04.30
3	ISSUED FOR PERMIT	2024.04.19
2	ISSUED FOR SPA SUBMISSION	2024.02.27
1	ISSUED FOR SPA REVIEW SET	2024.02.06



Revision

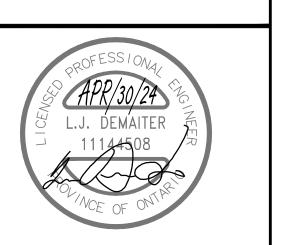Drawing Title: PARTIAL ROOF PLAN & DETAILS MECHANICAL

2314	M103		
Job No.	Drawing No.		
Drawn by: DF	Checked by: MW		
Scale: AS NOTED	Date: APR 2024		