

PROPOSED CHANGE NO. SC-03-001

To: Golden Gate Contracting Date: June 12, 2025
1038 Cooke Blvd., Unit #1 File: 9.1.7.4.2_SC-03_PC

Burlington, ON Project No.: 2215C

L7T 4A8 **Project:** TA Blakelock HS Reno - Phase 3

Copy: Star Electrical Services Inc

P: (905) 799-3883 F: (905) 799-8334

Pursuant to paragraph 6.2.1 of GC 6.2 - CHANGE ORDER in CCDC 3 - 2016, indicate within 7 days of the above date the changes to the *Contract Price, Contractor's Fee* and *Contract Time* for the following proposed change in the *Work*. Do **not** proceed with the change without a *Change Order* or *Change Directive* authorizing a change in the *Work*.

Description: Additional receptacle & breaker in Washrooms (ECN No. 01)

Refer to Electrical Change Notice 'ECN No. 01' as prepared by EXP dated June 10, 2025 regarding adding two duplex receptacle and 1 breaker in Washrooms. This also includes clarification regarding revised existing panel location for Elevators.

Prepared by the Consultant

Manasee Shinde January June 12, 2025

Distributed to:

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Alex Jacobi Snyder Architects Inc. ajacobi@snyderarchitects.ca



Change Notice

Date: June 10, 2025

EXP Project No.: ALL-22020201-A0 **Project:** T. A. Blakelock H.S. Renovations – Phase 3


From: Felix Martich ECN No. 01

You are hereby instructed, subject to the provisions of the Contract, to submit a quotation for the following Changes:

ELECTRICAL

- 1. <u>Drawing E100 Electrical & Lighting Legends and Drawing List</u> (Drawing Issued with this change notice)
 - 1. **Clarification:** Existing panel 'LP-Y' shown on Level 0 key plan.
- 2. <u>Drawing E300 Level 0 Washroom Lighting & Power Proposed Plan (Drawing Issued with this change notice)</u>
 - 1. **ADD** two (2) duplex receptacle for plumbing fixtures as shown.
 - 2. **ADD** one (1) 15A.1P breaker to feed all plumbing circuits in Male & Female washroom as shown. Revise drawing note #4, drawing note #6 & drawing note #9 as shown.
 - 3. Panel 'LP-Y' schedule added to the drawing.
- 3. <u>Drawing E301 Partial Level 0, 1 & 2 Elevator Proposed Plan</u> (Drawing Issued with this change notice)
 - 1. **Clarification:** Revised existing panel 'MU-PP-B' location as shown.

Reason: School Board's Request

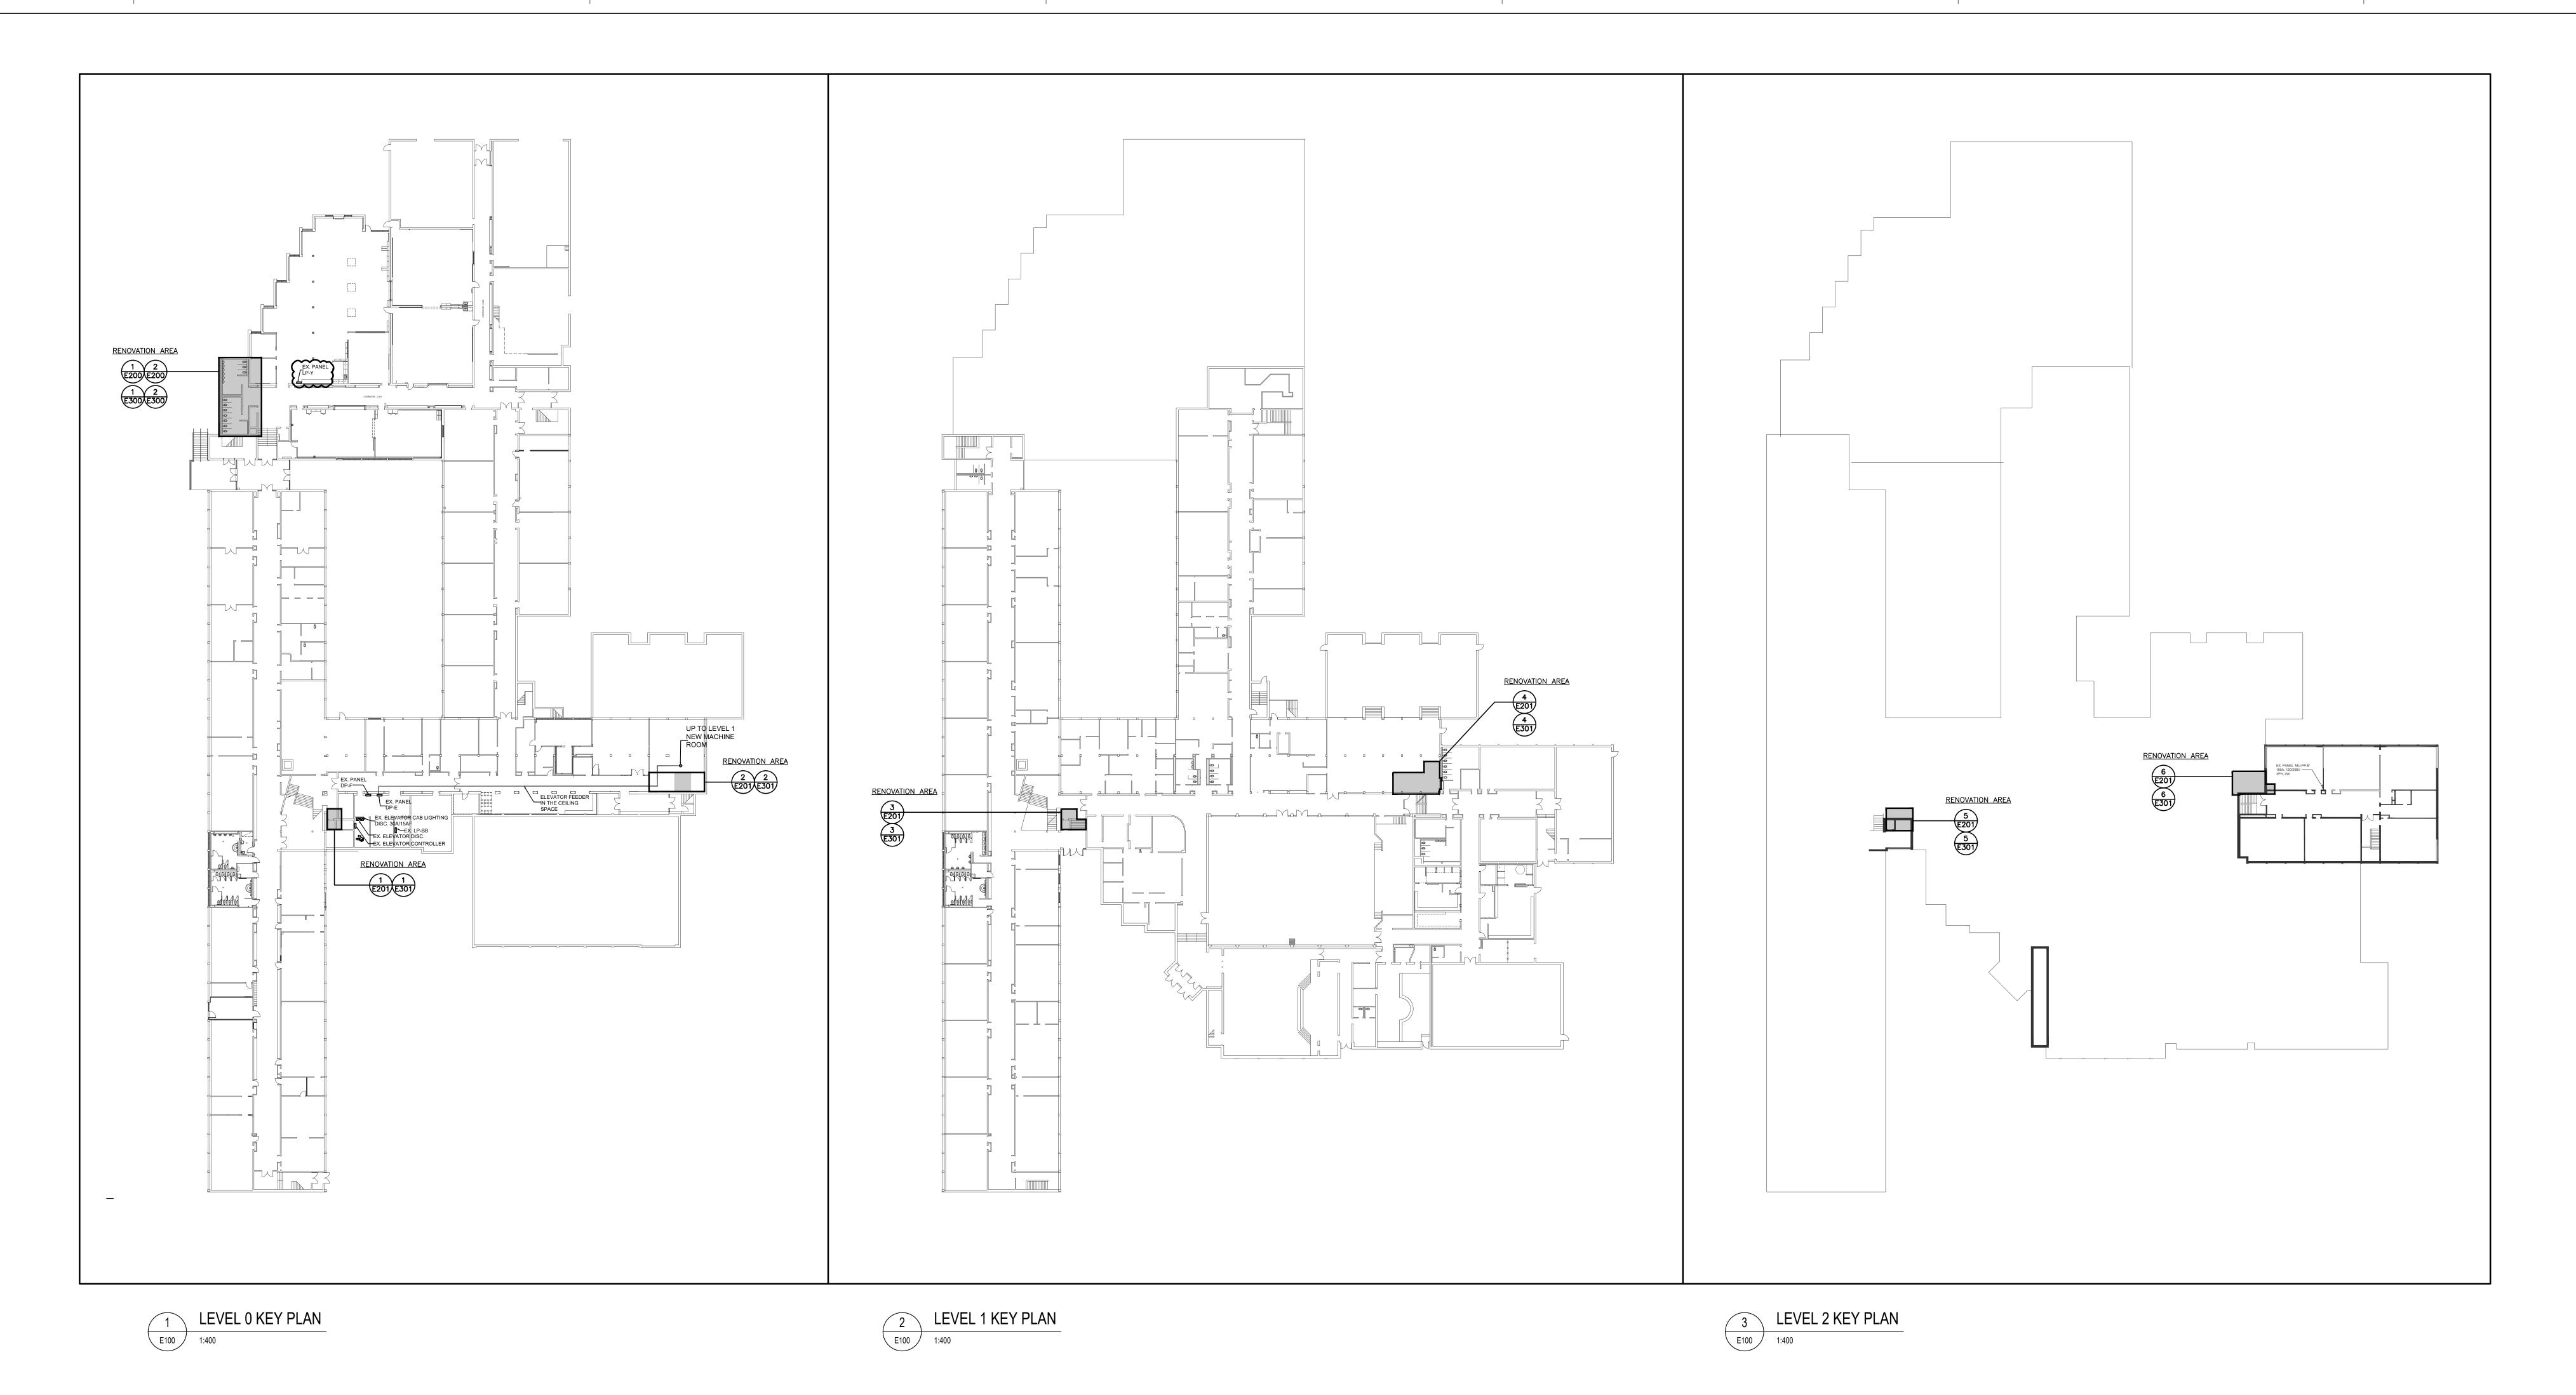

Client **Halton District School Board**2050 Guelph Line

Burlington, Ontario

T. A. BLAKELOCK H.S. RENOVATIONS

1160 Rebecca Street Oakville, ON

Architect

Sn/der

Snyder Architects Inc.

Snyder Architects Inc.

100 Broadview Ave, Suite 301, Toronto, ON, M4M 3H3
tel. 416.966.5444 fax. 416.966.4443
w w w . s n y d e r a r c h i t e c t s . c a

Consultants

Structural Consultants **Kalos Engineering Inc.**300 York Boulevard
Hamilton, Ontario, L8R 3K6
Tel: 905-333-9119

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Mechanical and Electrical Consultants **EXP**1266 S. Service Rd,

Stoney Creek, Ontario, L8E 5R9

Tel: 905-525-6069

Drawing Title:
ELECTRICAL & LIGHTING


Scale: N.T.S. Date: 2025-03-03

Drawn by: ABS Checked by: FMV

LEGENDS AND DRAWING LIST


ALL-22020201

Job No.

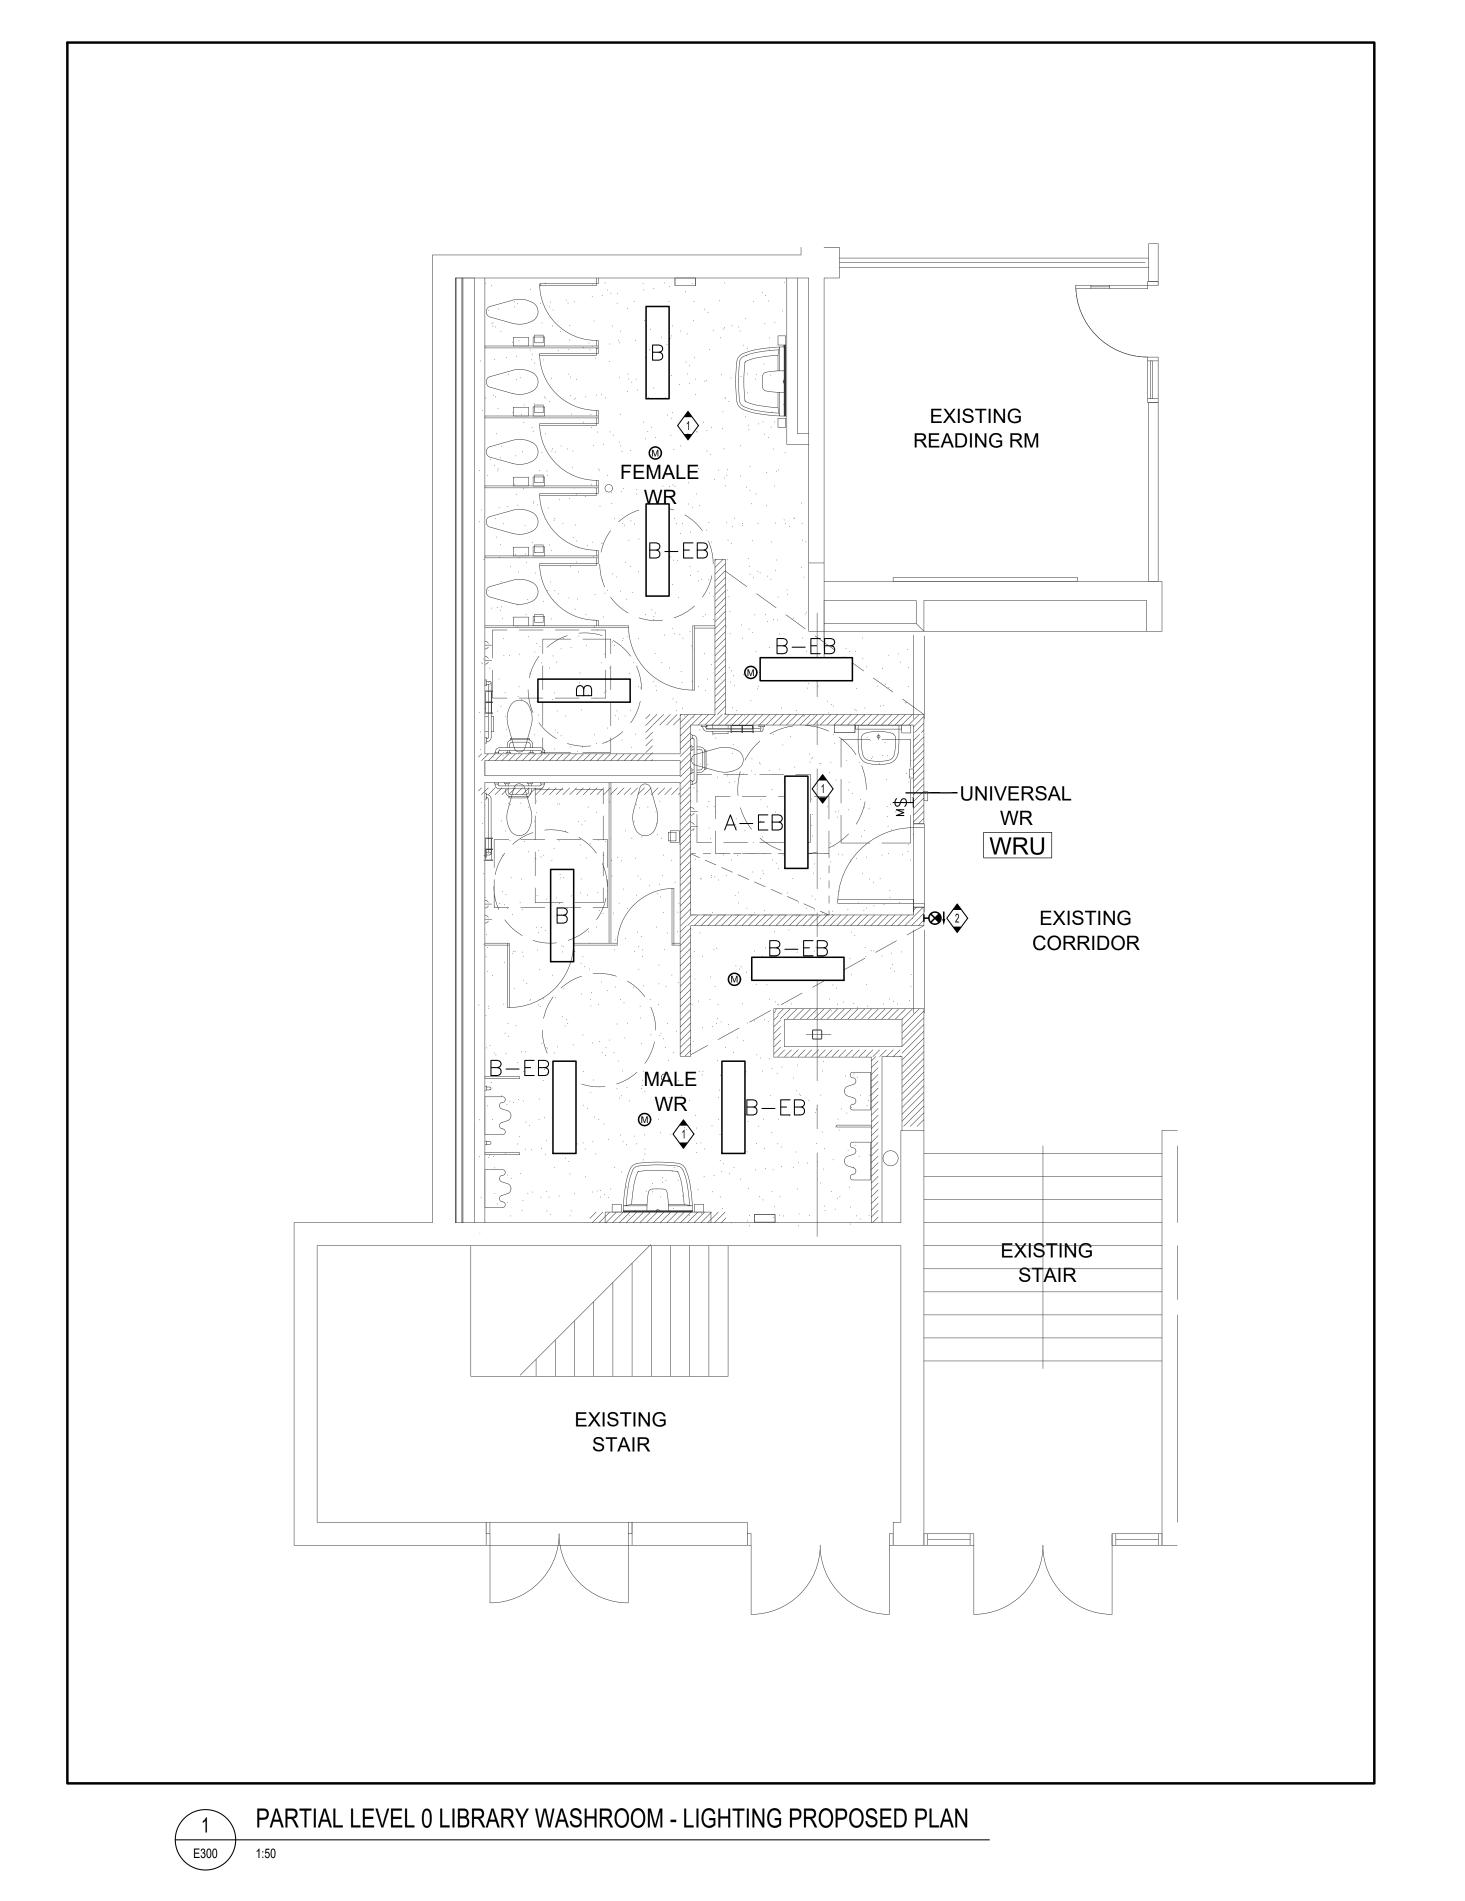

UNLESS INDICATED OTHERWISE, WIRE ALL NEW LIGHTING FIXTURE IN THIS ROOM TO EXISTING ROOM LIGHTING BRANCH CIRCUIT WIRING MADE AVAILABLE/SPARE BY THE DEMOLITION AND THROUGH NEW LIGHTING CONTROL DEVICES AND CONTROL ZONES AS INDICATED ON PLANS. MODIFY AND EXTEND EXISTING BRANCH CIRCUIT WIRING AS REQUIRED.

2 USE EXISTING CIRCUIT TO FEED THE NEW RUNNING MAN EXIT SIGN. PROVIDE ADDITIONAL CONDUIT/WIRING AS REQUIRED.

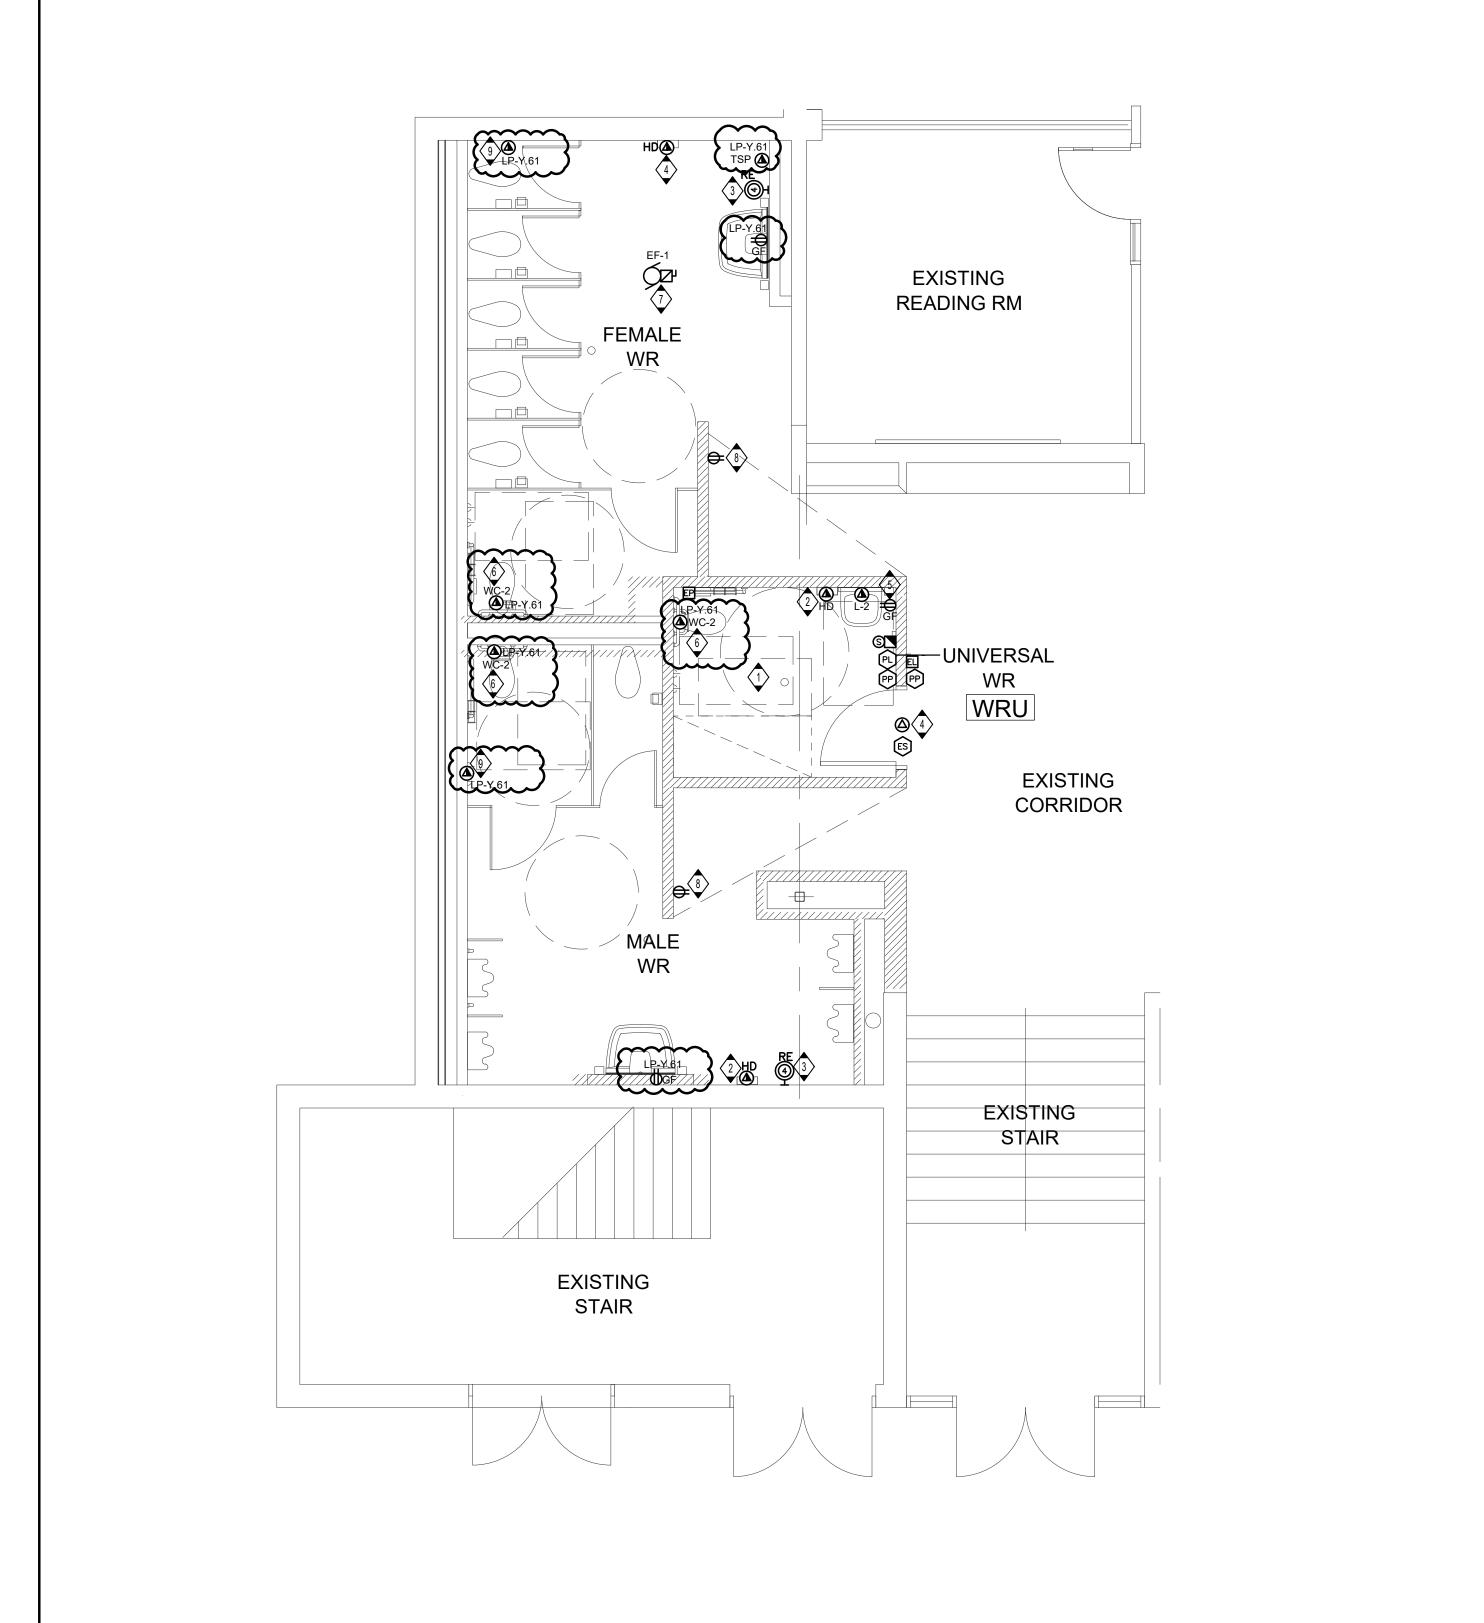

DRAWING NOTES

PROVIDE ALL POWER AND CONTROL WIRING AND CONDUIT TO DOOR OPERATOR, DOOR PUSHBUTTONS, ELECTRICAL DOOR LOCK, IN-USE LIGHT AND PUSHBUTTON. COORDINATE DEVICE LOCATIONS WITH DOOR HARDWARE INSTALLER.

REPLACE EXISTING BREAKER IN PANEL LP-Y LOCATED IN THE LIBRARY FEEDING THE EXISTING HAND DRYER CIRCUITS. PROVIDE 20AMP TANDEM BREAKER TO FEED THE NEW HAND DRYER LOCATED IN UNIVERSAL WASHROOM & MALE WASHROOM. CONNECT THE NEW HAND DRYERS TO THE EXISTING CIRCUIT. PROVIDE ADDITIONAL CONDUIT/WIRING AS REQUIRED.

HAND DRYER LOCATED IN UNIVERSAL WASHROOM & MALE WASHROOM. CONNECT THE NEW HAND DRYERS TO THE EXISTING CIRCUIT. PROVIDE ADDITIONAL CONDUIT/WIRING AS REQUIRED.

3 INSTALL THE EXISTING PA SPEAKER TO THE NEW LOCATION AS SHOWN. PROVIDE ADDITIONAL WIRING AS REQUIRED.

4 REPLACE EXISTING BREAKER IN PANEL LP-Y LOCATED IN THE LIBRARY FEEDING THE EXISTING HAND DRYER CIRCUITS. PROVIDE 20MP TANDEM BREAKER TO FEED THE NEW HAND DRYER & LOCATED IN FEMALE WASHROOM & AUTOMATIC DOOR OPERATOR IN UNIVERSAL WASHROOM. PROVIDE ADDITIONAL CONDUIT/WIRING AS REQUIRED.

5 CONNECT THE GFCI RECEPTACLE LOCATED IN UNIVERSAL WASHROOM TO THE EXISTING CORRIDOR RECEPTACLE CIRCUIT. PROVIDE ADDITIONAL CONDUIT/WIRING AS REQUIRED.

6 WIRE THE NEW PLUMBING FIXTURES CIRCUITS TO THE PANEL 'LP-Y'. REFER TO MECHANICAL DRAWINGS FOR EXACT LOCATION.

DRAWINGS FOR EXACT LOCATION.

WIRE THE NEW PLUMBING VALVE CIRCUITS TO THE PANEL "LP-Y". REFER TO MECHANICAL

CORRIDOR RECEPTACLE CIRCUIT. PROVIDE ADDITIONAL CONDUIT/WIRING AS REQUIRED.

WIRE THE NEW PLUMBING FIXTURES CIRCUITS TO THE PANEL 'LP-Y') REFER TO MECHANICAL DRAWINGS FOR EXACT LOCATION.

CONNECT THE NEW EXHAUST FAN EF-1 TO THE EXISTING EXHAUST FAN CIRCUIT LOCATED IN THE MALE & FEMALE WASHROOM. PROVIDE ADDITIONAL CONDUIT/WIRING AS REQUIRED.

CONNECT THE NEW DUPLEX RECEPTACLES TO THE EXISTING CORRIDOR RECEPTACLE CIRCUIT. PROVIDE ADDITIONAL CONDUIT/WIRING AS REQUIRED.

CONSULTATION OF THE NEW DUPLEX RECEPTACLES TO THE EXISTING CORRIDOR RECEPTACLE CIRCUIT. PROVIDE ADDITIONAL CONDUIT/WIRING AS REQUIRED.

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PARTIAL LEVEL 0 LIBRARY WASHROOM - POWER & SYSTEMS PROPOSED PLAN

GENERAL NOTES

DRAWINGS ILLUSTRATE INTENT AND DO NOT NECESSARILY REPRESENT ALL REQUIRED CONTROL COMPONENTS, FINAL WIRING METHODS OR FIXTURE MOUNTING LOCATIONS. DETERMINE THE FINAL SYSTEM INSTALLATION BASED ON THE PRODUCT MANUFACTURER'S SHOP DRAWINGS. REFER TO THE ARCHITECTURAL DRAWINGS FOR PRECISE MOUNTING LOCATION OF LUMINAIRES.

- B. EXIT SIGNS ARE TO BE MOUNTED SO THEY ARE VISIBLE UPON APPROACH NO HIGHER THAN 3000 AFF AND NO LOWER THAN 2100 AFF.
- C. CEILING MOUNTED DUAL TECHNOLOGY (DT) SENSORS ARE TO BE MOUNTED NO HIGHER THAN 3600 AFF.
- D. CONTROL DEVICES SHALL BE MOUNTED IN ACCESSIBLE LOCATIONS ABOVE THE CEILING WHERE FIXTURES ARE INSTALLED IN HARD CEILINGS, CONTROL DEVICES SHALL BE MOUNTED WITHIN THE FIXTURE DRIVER CHAMBER OR REMOTE MOUNTED IN THE NEAREST ACCESSIBLE CEILING. CONTROL DEVICES SHALL BE LABELED WITH THE CORRESPONDING CONTROL ZONE AND POWER CIRCUIT.

CONTROL DEVICES SHALL BE MOUNTED IN ACCORDANCE WITH THE MANUFACTURER'S


- RECOMMENDATIONS AND SO THEY ARE CAPABLE OF OPERATING PROPERLY WITHOUT FALSE 'ON' OR PREMATURE 'OFF' OPERATIONS. DUAL TECHNOLOGY OCCUPANCY SENSORS SHALL NOT BE MOUNTED WITHIN 610 mm OF ANY HVAC DIFFUSER.
- F. CIRCUITS USED ARE FOR CIRCUITING PURPOSE ONLY. CONNECT NEW FIXTURES AND EXIT SIGNS TO EXISTING LOCAL NORMAL AND EMERGENCY POWER LIGHTING CIRCUITS AS INDICATED. LIGHTING IN SPACES IDENTIFIED AS NOT IN CONTRACT (IE. SHADED GREY SHALL BE RE-CONNECTED TO THE SAME POWER PANEL(S) AS THEY WERE PRIOR TO START OF DEMOLITION WORK.
- G. ALLOW IN PRICE FOR TEMPORARILY REMOVING CEILING TILES, LIGHT FIXTURES OR ANY OTHER IMPEDIMENTS TO INSTALL THE FEEDER CONDUIT IN CEILING SPACE. AFTER INSTALLATION, RE-INSTATE ALL LIGHT FIXTURES AND CEILING MOUNTED DEVICES.

ELECTRICAL GENERAL NOTES

- A. PRIOR TO BIDDING, ELECTRICAL CONTRACTOR SHALL VISIT SITE AND BE FAMILIAR WITH ALL EXISTING CONDITIONS INCLUDING BUT NOT LIMITED TO EQUIPMENT LOCATIONS AND OTHER POSSIBLE INSTALLATION DIFFICULTIES. PAY AND OBTAIN ANY PERMITS REQUIRED INCLUDING ESA.
- B. ALL CONDUIT ROUTES SHOWN ON DRAWINGS ARE APPROXIMATE AND NOT FINAL. CONTRACTOR SHALL VERIFY ROUTES AND DO A WALKTHROUGH BEFORE BID. CONTRACTOR SHALL ACCOUNT FOR POSSIBLE DAMAGE AND REPAIR TO EXISTING CEILING AND LIGHT FIXTURES. ALL MAIN CONDUIT RUNS SHALL BE IN CORRIDOR CEILING SPACE.
- C. EXTEND/PROVIDE NEW WIRING/CONDUIT FOR ALL DEVICES THAT ARE RELOCATED.
- D. ALL NEW RECEPTACLES IN THE SCHOOL SHALL BE TAMPER RESISTANT TYPE.

 E. REMOVE AND RE-INSTATE ALL REQUIRED T-BAR OR DRY TYPE CEILINGS TO FACILITAT ELECTRICAL INSTALLATIONS. ANY DAMAGES TO T-BAR SHALL BE RE-INSTATED.

 E. LINI ESS OTHERWISE NOTED WITH A CIRCUIT NUMBER, RELISE EXISTING CIRCUIT.
- F. UNLESS OTHERWISE NOTED WITH A CIRCUIT NUMBER, RE-USE EXISTING CIRCUIT BREAKERS THAT HAD BECOME SPARE FROM THE DEMOLITION TO FEED NEW RECEPTACLES. MAXIMUM 6 DUPLEX RECEPTACLES PER CIRCUIT UNLESS OTHERWISE NOTED.
- G. ALL I.T. CABLES SHALL BE PLENUM RATED.
- CONTRACTOR SHALL ACCOUNT FOR POSSIBLE DAMAGE AND REPAIR TO CEILING TILES FOR CONDUIT RUNS FROM PANELS TO NEW ELECTRICAL DEVICES.
- CIRCUIT NUMBERS SHOWN ON THIS PLAN ARE FOR CIRCUITING PURPOSE ONLY. REUSE EXISTING SPARE BREAKERS OR EXISTING BREAKERS MADE SPARE FROM DEMOLITION AND/OR REPLACE OBSOLETE BREAKERS WITH NEW ADD/OR ADD NEW BREAKERS IN AVAILABLE SPACES IN EXISTING ELECTRICAL PANELS AS REQUIRED OR REPLACE EXISTING PANELS WITH NEW AS INDICATED. CONFIRM EXISTING CONDITIONS ON SITE.

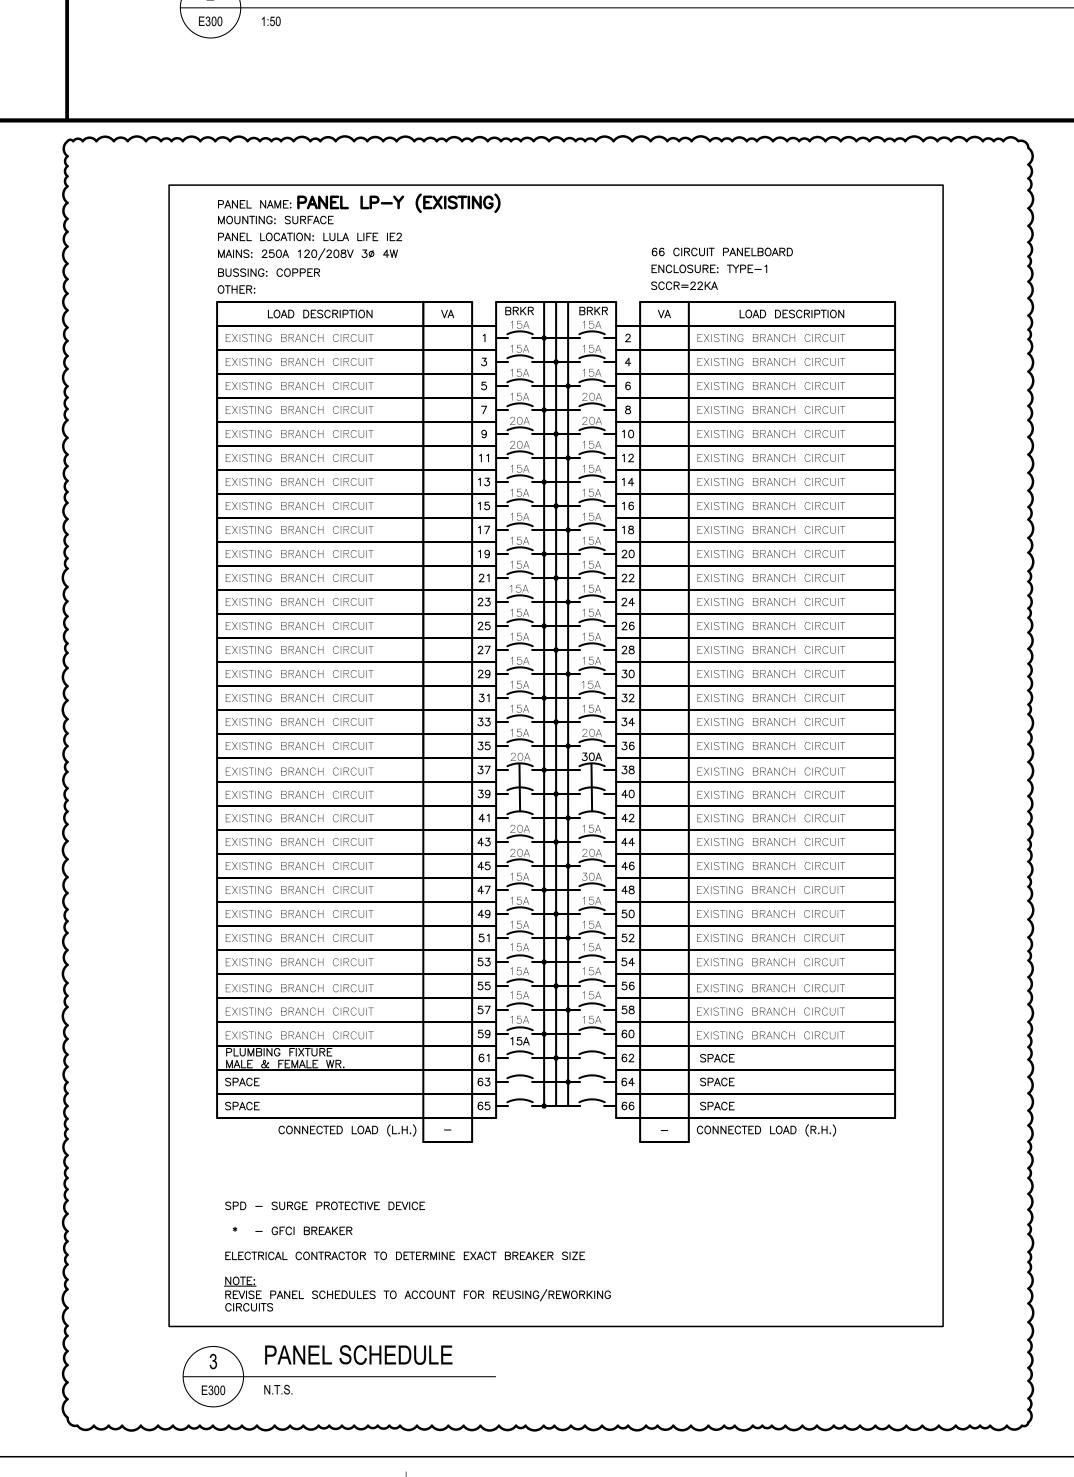


Pioje	ect North	True
No.	Revisions	Dat
5	ISSUED FOR ECN-01	2025
4	ISSUED FOR CONSTRUCTION	2025
3	ISSUED FOR TENDER	2025
2	ISSUED FOR PERMIT	2025
1	ISSUED FOR REVIEW	2025
No.	Issue	Date

LEVEL 0 - WASHROOM

Drawn by: ABS Checked by: FMV

Job No.

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Project North True North 6 ISSUED FOR ECN-01 5 | ISSUED FOR CONSTRUCTION | 2025.06.02 ISSUED FOR TENDER 2025.04.17 2025.04.07 ISSUED FOR PERMIT 2025.03.21 ISSUED FOR REVIEW errors and omissions to the Architect. Do not scale the drawings.

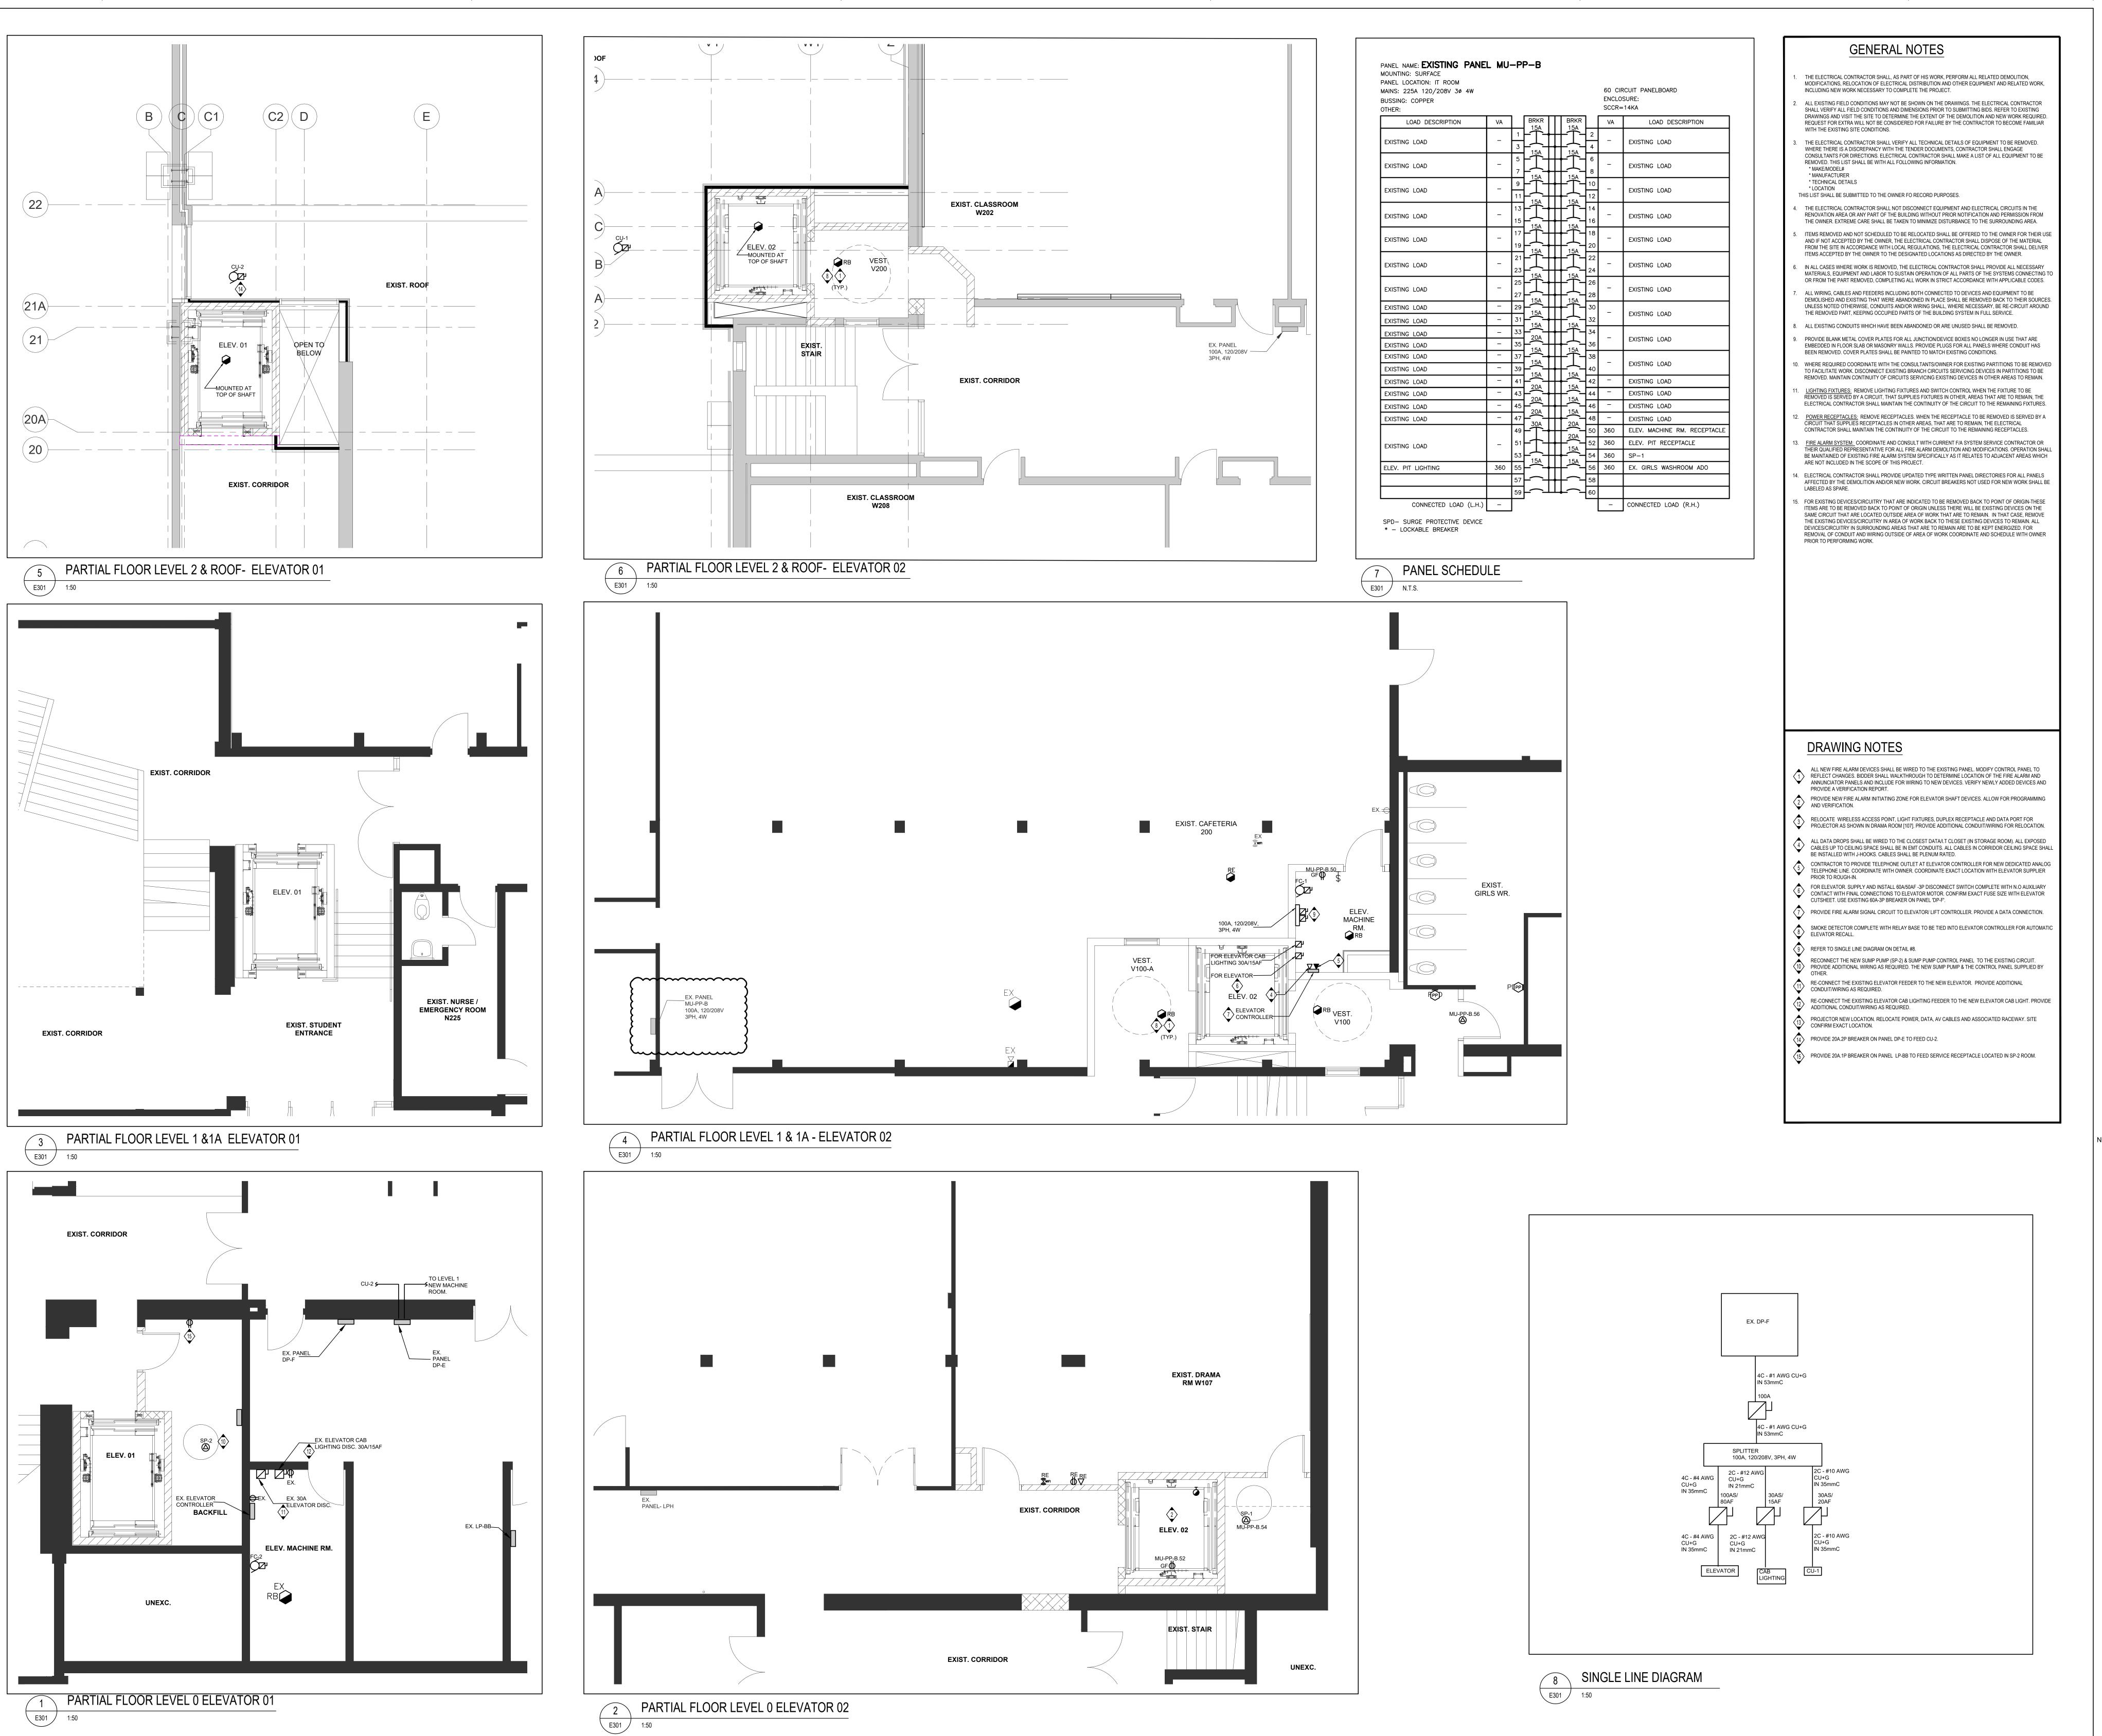Drawings shall not be used for construction purposes until issued by the

PARTIAL LEVEL 0, 1 & 2 **ELEVATOR -**PROPOSED PLAN

ABS Checked by: FMV ALL-22020201