









- ## DRAWING NOTES
- |   |   |
|---|---|
|  | UNLESS INDICATED OTHERWISE, DISCONNECT AND REMOVE ALL EXISTING LIGHTING FIXTURES IN THIS ROOM/AREA COMPLETE WITH ASSOCIATED LIGHT SWITCHES, TEMPORARY COIL EXISTING BRANCH CIRCUIT WIRING FOR RE-USE TO FEED NEW LIGHTING FIXTURES. REFER TO DRAWING E300 FOR NEW LIGHTING PLANS. |
|  | DEMOLISH EXISTING EXIT SIGN. RETAIN THE EXISTING CIRCUIT TO FEED THE NEW EXIT SIGN SHOWN IN DRAWING E300.   |



- ## DRAWING NOTES
1. UNLESS INDICATED OTHERWISE, DISCONNECT AND REMOVE HAND DRYER IN THIS ROOM AREA. TEMPORARILY COIL EXISTING BRANCH CIRCUIT WIRING FOR RE-USE TO FEED NEW HAND DRYER. REFER TO DRAWING E300 FOR NEW POWER PLANS.
  2. DISCONNECT AND REMOVE EXISTING PA SPEAKER. PROTECT EXISTING PA WIRING FOR REUSE, PA SPEAKER KEEP IN A SAFE PLACE FOR REUSE. REFER TO DRAWING E300 FOR NEW LOCATION.
  3. EXISTING PIPE FOR PLUMBING FIXTURES TO BE DISCONNECTED. PROTECT FOR REUSE. REFER TO DRAWING E300 FOR NEW LOCATION.

Architect  
**sn/der**  
**Snyder Architects Inc.**  
100 Broadview Ave., Suite 301, Toronto, ON, M4M 3H3  
tel. 416.966.5444 fax. 416.966.4443  
[www.snyderarchitects.ca](http://www.snyderarchitects.ca)

Consultants

Structural Consultants

**Kalos Engineering Inc.**  
300 York Boulevard  
Hamilton, Ontario, L8R 3K6  
Tel: 905-333-9119

Mechanical and Electrical Consultants

**EXP**  
1266 S. Service Rd.  
Stoney Creek, Ontario, L8E 5R9  
Tel: 905-525-6069

## GENERAL NOTES

- [illegible]

[illegible]


General Contractor shall check and verify all dimensions and report all errors and omissions to the Architect. Do not scale the drawings. Drawings shall not be used for construction purposes until issued by the Architect for construction.

Drawing Title:  
LEVEL 0 - WASHROOM  
LIGHTING & POWER  
DEMOLITION PLAN

Scale: 1:50	Date: 2025-03-03
Drawn by: ABS	Checked by: FMV
Job No. ALL-22020201	Drawing No. E200





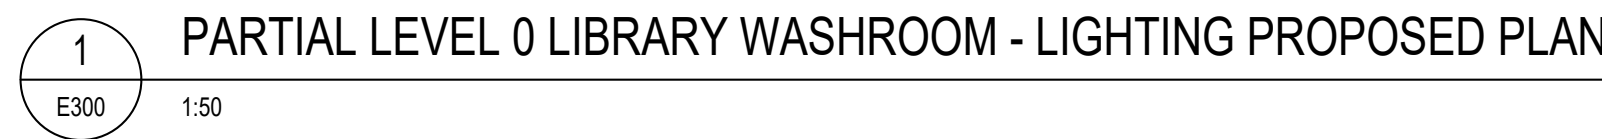

1 UNLESS INDICATED OTHERWISE, WIRE ALL NEW LIGHTING FIXTURE IN THIS ROOM TO EXISTING ROOM LIGHTING BRANCH CIRCUIT WIRING MADE AVAILABLE/SPARE BY THE DEMOLITION AND THROUGH NEW LIGHTING CONTROL DEVICES AND CONTROL ZONES AS INDICATED ON PLANS. MODIFY AND EXTEND EXISTING BRANCH CIRCUIT WIRING AS REQUIRED.

2 USE EXISTING CIRCUIT TO FEED THE NEW RUNNING MAN EXIT SIGN. PROVIDE ADDITIONAL CONTROL WIRING AS REQUIRED.

[illegible]

**EXP**  
1266 S. Service Rd,  
Stoney Creek, Ontario, L8E 5R  
Tel: 905-525-6069

- A DRAWING ILLUSTRATING LAYOUT AND NOT NECESSARILY REPRESENTING ALL REQUIRED CONTROL COMPONENTS, PLANT WIRING METHODS AND FUTURE MODIFICATION LOCATIONS. MANUFACTURERS ARE TO BE CONSULTED FOR THE APPROPRIATE ELECTRICAL DRAWINGS FOR THE SPECIFIC APPLICATIONS. REFER TO THE APPROPRIATE ELECTRICAL DRAWINGS FOR THE SPECIFIC APPLICATIONS.
- B EXIST SIGNALS ARE TO BE DOWNGRADED TO THE LOW VOLTAGE APPROACH, NOT 300V, 240V, 208V AND 120V AND NO OTHER THAN 120V.
- C CELLING MOUNTED DATA TECHNOLOGY (DT) SENSORS ARE TO BE MOUNTED NO HIGHER THAN 3000 FEET.
- D CONTROL DEVICES SHALL BE MOUNTED IN ACCESSIBLE LOCATIONS ABOVE THE CEILING. CONTROL DEVICES ARE INSTALLED IN HANDICAPPED ACCESSIBLE CONTROL DEVICES SHALL BE MOUNTED WITHIN THE FUTURE DRIVER CLOSET OR CREW MOUNTED IN THE NEAREST ACCESSIBLE LOCATION. THE CONTROL DEVICES SHALL BE LABELED WITH THE CORRESPONDING CONTROL ZONE AND POWER CIRCUIT.
- E CONTROL DEVICES SHALL BE MOUNTED IN ACCORDANCE WITH THE MANUFACTURER'S RECOMMENDATIONS AND IF THEY ARE CAPABLE OF OPERATING NORMALLY WITHOUT THE NEED FOR A BATTERY BACKUP. THE CONTROL DEVICES SHALL BE LABELED WITH THE SENSORS SHALL NOT BE MOUNTED WITHIN 60 IN OF ANY CHAFF DUCTS.
- F CIRCUITS USED ARE FOR CIRCUITING PURPOSE ONLY. ONLY KNOWN NEUTRAL FEEDERS AND CIRCUITS ARE TO BE USED. THE CIRCUITS ARE TO BE LABELED WITH THE CIRCUIT NUMBER AS INDICATED. ILLUSTRATION OF THE SPACES POWERED (NOT IN CONTRACT) IS SHARED GREEN. THE SPACES POWERED BY THE SAME POWER (WIRING) AS THEY WERE PRIOR TO START OF DEMOLITION WORK.
- G ALLOW AN PRICE FOR TEMPORARILY REMOVING CEILING LITES, LIGHT FIXTURES OR AN ALLOW PRICES TO INSTALL THE FEEDER CIRCUIT TO CEILING SPACE.

**A** PRIOR TO WORK, ELECTRICAL CONTRACTOR SHALL VISIT SITE TO BE FAMILIAR W/ ALL EXISTING CONDITIONS INCLUDING BUT NOT LIMITED TO EQUIPMENT LOCATIONS, ELECTRICAL PANELS, AND ALL EXISTING WIRING. CONTRACTOR SHALL OBTAIN ANY NECESSARY PERMITS REQUIRED INCLUDING ELEC. ETC.

**B** ALL CONDUIT ROUTES SHOWN ON DRAWINGS ARE APPROXIMATE AND NOT FINAL. CONTRACTOR SHALL VERIFY ROUTES AND DO A WALK-THROUGH BEFORE BID. CONTRACTOR SHALL VERIFY ALL EXISTING WIRING, CONDUIT, AND ALL EXISTING CEILING AND LIGHT FIXTURES. ALL WORK MUST REMAIN TO BE IN CONCORD W/ CEILING, CLING SPACE.

**C** EXTENSIVE NEW WIRING/CONDUIT FOR ALL DEVICES THAT ARE RELOCATED.

**D** ALL NEW RECEPTELES IN THE SCHOOL SHALL BE TYPIC RESISTING TYPE.

**E** REMOVE AND RE-INSTALL ALL REQUIRED TIE BAR OR DAMPER CLOSING TO FACILITATE ELECTRICAL INSTALLATIONS ANY DAMAGES TO TIE BAR SHALL BE RE-INSTATED.

**F** UNLESS OTHERWISE NOTED WITH CONTRACT, THERE ARE EXISTING CIRCUIT BREAKERS TO BE MAINTAINED. CONTRACTOR SHALL VERIFY ALL EXISTING CIRCUIT BREAKERS, MAXIMUM 40 AMP RECEPTALS PER CIRCUIT UNLESS OTHERWISE NOTED.

**G** ALL TIE CABLES SHALL BE PLUMB/RAISED.

**H** CONTRACTOR SHALL ACCOUNT FOR POSSIBLE DAMAGE AND REPAIR TO CEILING TIE FOR CONDUIT RUNS FROM PANELS TO NEW CIRCUITS.

**CRUIT NUMBERS SHOWN ON THIS PLAN ARE FOR IDENTIFICATION PURPOSE ONLY. RELY ON THE FIELD FOR THE EXISTING WIRING. CONTRACTOR SHALL VERIFY ALL EXISTING WIRING AND REPLACE OBSOLETE BREAKERS WITH NEW AND ADD NEW BREAKERS IN AVAILABLE SPACES IN IDENTIFIED ELECTRICAL PANELS AS REQUIRED. ALL REPAIRS TO EXISTING PANELS SHALL BE RELOCATED. CONTRACTOR VERIFY CONDITIONS ON FIELD.**







E302