
COB - Building Department Page 1 of 3

<u>PLU</u>	<u>JMBING FIXTURE SC</u>	HEDULE						CAPACITY INDICATED ON SCHEDULE REFER SPECIFICATION FOR CONSTRUCTION STANDA ACCESSORIES AND ADDITIONAL INFORMAT
Item	Type	ection Sizes		Fixture		Trim		Accessories
terri	HW CW	TW Drain Vent	Acceptable Manufacturer	Fixture Description	Acceptable Manufacturer	Trim Description	Acceptable Manufacturer	Accessory Description
WC-1	BARRIER-FREE FLOOR MOUNTED FLUSH VALVE WATER CLOSET	80 40	AMERICAN STANDARD MADERA KOHLER CRANE	FLOOR-MOUNTED, FLUSH VALVE, FOR BARRIER-FREE. TOP OF SEAT TO BE BETWEEN 400 MM (16") AND 450 MM (18") FROM FINISHED FLOOR. VITREOUS CHINA, FLOOR MOUNTED, SYPHON JET, ELONGATED RIM, TOP SPUD FOR FLUSH VALVE, BOLT CAPS.	ZURN Z6000AV-WS1-DF SLOAN MOAN COMMERCIAL	EXPOSED, POLISHED CHROME, EXTERNALLY ADJUSTABLE, DUAL FLUSH DIAPHRAGM TYPE WITH NPS 25 MM (1") SCREWDRIVER ANGLE STOP, OSCILLATING HANDLE, FLUSH CONNECTION AND COUPLING FOR NPS 40 MM (1 1/2") TOP SPUD, WALL AND SPUD ESCUTCHEONS, SEAT BUMPER AND VACUUM BREAKER. ULTRA LOW FLUSH CYCLE: ADJUSTABLE FROM 3.8 — 17 LITRES (1.0 — 4.5 GAL)/FLUSH, FACTORY SET TO 5.7 LITRES (1.5 GAL)/FLUSH.	SEAT: CENTOCO HL820STS BEMIS OLSONITE	SEAT: WHITE 50 MM (2") LIFT, ELONGATED, OPEN FRONT, ANTIMICROBIAL, WITH COVER, MOLDED SOLID PLASTIC, COVER, STAINLESS STEEL CHECK HINGES, STAINLESS STEEL OR SOLID BRASS INSERT POST.
VC-2	FLOOR MOUNTED FLUSH VALVE WATER CLOSET	80 40	AMERICAN STANDARD MADERA KOHLER CRANE	FLOOR-MOUNTED, TOP SPUD, ULTRA-LOW FLUSH, MAXIMUM 6 LITRES (1.6 GAL)/FLUSH. VITREOUS CHINA, SIPHON JET, ELONGATED RIM.	ZURN Z6000AV-WS1-DF SLOAN MOEN COMMERCIAL	EXPOSED, POLISHED CHROME, EXTERNALLY ADJUSTABLE, DUAL FLUSH DIAPHRAGM TYPE WITH NPS 25 MM (1") SCREWDRIVER ANGLE STOP, OSCILLATING HANDLE, FLUSH CONNECTION AND COUPLING FOR NPS 40 MM (1 1/2") TOP SPUD, WALL AND SPUD ESCUTCHEONS, SEAT BUMPER AND VACUUM BREAKER. ULTRA LOW FLUSH CYCLE: ADJUSTABLE FROM 3.8 — 17 LITRES (1.0 — 4.5 GAL)/ FLUSH, SET TO 5.7 LITRES	SEAT: CENTOCO AM500STSCC BEMIS OLSONITE	SEAT: HEAVY-DUTY, WHITE, ELONGATED, OPEN FRONT, ANTIMICROBIAL, MOULDED SOLID PLASTIC, LESS COVER, STAINLESS STEEL CHECK HINGES, STAINLESS STEEL OR SOLID BRASS INSERT POST.
L-1	BARRIER-FREE WALL MOUNTED LAVATORY (C/W FLOOR MOUNTED WALL CARRIER)	32 32	AMERICAN STANDARD MURRO KOHLER CRANE	VITREOUS CHINA, LOW SHELF, WITH INTEGRAL BACK, CONTOURED FRONT, SHALLOW FRONT BASIN, FRONT OVERFLOW, SUPPLY OPENINGS ON 100 MM (4") CENTRES, KNEE CONTACT GUARD, CONCEALED SUPPORTS. SIZES: 686 MM X 500 MM (27" X 20"), SQUARE FRONT. WASTE FITTING: NPS 32 MM (1 1/4") OFFSET WASTE WITH GRID STRAINER & CHROME PLATED CAST BRASS 2-PIECE P-TRAP.	DELTA 591T1250 ZURN MOAN COMMERCIAL	TRIM BARRIER-FREE ELECTRONIC FAUCET. ACTIVATED BY [INFRA-RED] SENSOR RESPONDING TO PRESENCE OF PERSON'S HANDS IN LAVATORY. SENSOR: WATERPROOF, [INCORPORATED IN BODY OF UNIT DECK-MOUNTED] WITH IMPACT-RESISTANT PLASTIC LENS WITH ANTI-SCRATCH COATING, SENSITIVITY ADJUSTABLE FROM 100 MM TO 450 MM (4" TO 18"). WATER CONSERVATION: 30 SECOND MAXIMUM RUN TIME. CONTROLS: VANDAL-PROOF. SPOUT: CHROME PLATED, WITH AERATOR HAVING INTEGRAL FLOW CONTROL FOR 8.35 L/MIN (2.2 GPM) AT 413 KPA (60 PSI) MAXIMUM. UNDER-COUNTER TEMPERATURE THERMOSTATIC MIXING CONTROL VALVE. (POWERS OR EQUAL). SUITABLE FOR 120/1/60.	MCGUIRE PROWRAP TRUEBRO	INSULATE WASTE AND SUPPLIES WITH UL LISTED PREFORMED INSULATION SYSTEM COMPLETE WITH SEAMLESS JACKET. PROVIDE POWERS HYDROGUARD SERIES LFLM495 OR EQUAL THERMOSTATIC MIXING VALVE TO LIMIT THE HOT WATER SUPPLY TEMPERATURE. WASTE FITTING: GRID STRAINER. PROVIDE OFFSET P/O + GUARD FOR BARRIER FREE. COMPLETE WITH PLUG—IN TRANSFORMER SUITABLE FOR 120/1/60. PROVIDE FLOOR MOUNTED WALL CARRIER
L-2	WALL MOUNTED LAVATORY (C/W FLOOR MOUNTED WALL CARRIER)	32 32	AMERICAN STANDARD LUCERNE KOHLER CRANE	WALL-HUNG, INTEGRAL BACK, VITREOUS CHINA, WITH SPLASH LIP, SOAP DEPRESSIONS, SUPPLY OPENINGS ON 100 MM (4") CENTRES, OVERFLOW. SIZE: 500 MM X 450 MM (20" X 18"). WASTE FITTING: NPS 32 MM (1 1/4") OFFSET WASTE WITH GRID STRAINER & CHROME PLATED CAST BRASS 2-PIECE P-TRAP	DELTA 591T1250 ZURN MOAN COMMERCIAL	TRIM BARRIER-FREE ELECTRONIC FAUCET. ACTIVATED BY [INFRA-RED] SENSOR RESPONDING TO PRESENCE OF PERSON'S HANDS IN LAVATORY. SENSOR: WATERPROOF, [INCORPORATED IN BODY OF UNIT DECK-MOUNTED] WITH IMPACT-RESISTANT PLASTIC LENS WITH ANTI-SCRATCH COATING, SENSITIVITY ADJUSTABLE FROM 100 MM TO 450 MM (4" TO 18"). WATER CONSERVATION: 30 SECOND MAXIMUM RUN TIME. CONTROLS: VANDAL-PROOF. SPOUT: CHROME PLATED, WITH AERATOR HAVING INTEGRAL FLOW CONTROL FOR 8.35 L/MIN (2.2 GPM) AT 413 KPA (60 PSI) MAXIMUM. UNDER-COUNTER TEMPERATURE THERMOSTATIC MIXING CONTROL VALVE. (POWERS OR EQUAL). SUITABLE FOR 120/1/60.	MCGUIRE PROWRAP TRUEBRO	INSULATE WASTE AND SUPPLIES WITH UL LISTED PREFORMED INSULATION SYSTEM COMPLETE WITH SEAMLESS JACKET. PROVIDE POWERS HYDROGUARD SERIES LFLM495 OR EQUAL THERMOSTATIC MIXING VALVE TO LIMIT THE HOT WATER SUPPLY TEMPERATURE. WASTE FITTING: NPS 32 MM (1¼") OFFSET WASTE WITH GRID STRAINER. COMPLETE WITH PLUG—IN TRANSFORMER SUITABLE FOR 120/1/60. PROVIDE FLOOR MOUNTED WALL CARRIER
FD—1	GENERAL DUTY FLOOR DRAIN	NOTED 40	ZURN ZN-415-B MIFAB F1100C WATTS DRAINAGE FD-100-C-AS-1 OR FD-100-C-LS-1 JAY R. SMITH 2005-A05NB	GENERAL DUTY CAST IRON BODY, ADJUSABLE HEAD, NICKEL BRONZE STRAINER, INTEGRAL SEEPAGE PAN, AND CLAMPING COLLAR. USE SQUARE STRAINER IN TILED AREAS AND ROUND STRAINER ELSEWHERE. C/W TRAP PRIMER				
	ROOF DRAIN	NOTED	ZURN ZA121-CR MIFAB R1200-BU CONTOUR C1000DMP WATTS RD-100-BED-K SMITH 1015-C-R-AD	STANDARD ROOF DRAIN WITH CAST IRON BODY WITH ALUMINUM DOME, UNDER-DECK CLAMP TO SUIT ROOF CONSTRUCTION, ROOF SUMP RECIEVER, FLASHING CLAMP WITH INTEGRAL GRAVEL STOP.				

Item	Туре		Nom	Nominal Capacity			Motor	Electrical Data		.a	Acceptable	Notes
ICOIII	1,750		cfm	Heat MBH	Cool MBH	in wc	hp	Voltage	MCA	MOCP	Manufacturer Manufacturer	110100
	PACKAGED ROOFTOP HVAC UNIT	20	7000	400	242	1.5	2.9	575/3/60	47	60	TRANE DHJ240AWSAH CARRIER LENNOX	HIGH HEAT, DOWN DISCHARGE & RETURN. INTEGRAL AIR/SOURCE HEAT PUMP OPERATION C/W NATURAL GAS BACKUP. 30% OUTDOOR AIR

<u>G</u> R	RILLE SCHEDULE	- -			CAPACITY INDICATED ON SCHEDULE REFER TO SPECIFICATION FOR CONSTRUCTION STANDARDS, ACCESSORIES AND ADDITIONAL INFORMATION.
Item	Туре	Manufacturer & Model	Finish	Remarks	
D1	ROUND CEILING SUPPLY	KRUEGER RA2	BAKED OFF WHITE	C/W SAFETY CHAINS. SLIDING ADJUSTMENT NOT ACCEPTABLE	
D2	ROUND SUPPLY	KRUEGER RA2	BAKED OFF WHITE	C/W SAFETY CHAINS & GUARD. SLIDING ADJUSTMENT NOT ACCEPTABLE	
D3	LINEAR SUPPLY	KRUEGER 1900		C/W 3 SLOT AND INSULATED PLENUM SUITABLE FOR DRYWALL. PROVIDE CONTINUOUS GRILLE WHERE NOTED	
R1	CEILING RETURN/EXHAUST	KRUEGER EGC5	BAKED OFF WHITE	C/W SCREWED FASTENING	
R2	GYMNASIUM RETURN	KRUEGER S480	BAKED OFF WHITE	C/W SCREWED FASTENING	

FA	N SCHEDUL	<u>E</u>							CAPACITY INDICATED ON SCHEDULE REFER T SPECIFICATION FOR CONSTRUCTION STANDARDS ACCESSORIES AND ADDITIONAL INFORMATION
ltem	Туре	Service	Exh Capacity cfm	aust Air Size hp	Data SP in. wc	Voltage	Manufacturer	Model	Remarks
EF-1	ROOF MOUNTED EXHAUST	WASHROOM EXHAUST	400	1/4	0.75	120/1/60	PENN BARRY		C/W 600mm (24") HIGH INSULATED ROOF CURB & BACKDRAFT DAMPER. DVR BY BAS CONTRACTOR
EF-2	RANGEHOOD (DUCTED)	STAFF ROOM	210	Fhp 3 SPD	0.20	120/1/60	BROAN	SAHALE BKDF1	CONTOURED STEEL HOUSING, FULLY ENCLOSED BOTTOM, TOP DISCHARGE, CENTIFUGAL BLOWER WHEELS, WASHABLE ALUMINUM FILTERS, 3 SPEED BLOWER CONTROL, PROVIDE 2 LEVEL LED LIGHTING. COLOUR SELECTED BY CONSULTANT.
EF-3	CEILING EXHAUST FAN	EXTERIOR STORAGE RM.	100	Fhp	0.20	120/1/60	BROAN	L100	ACOUSTICALLY INSULATED STEEL HOUSING, CENTIFUGAL BLOWER WHEEL, 90° DISCHARGE OUTLET W/BACKDRAFT DAMPER, C/W WHITE PAINTED ENAMEL STEEL GRILLE, VIBRATION ISOLATORS. 1.1 SONES

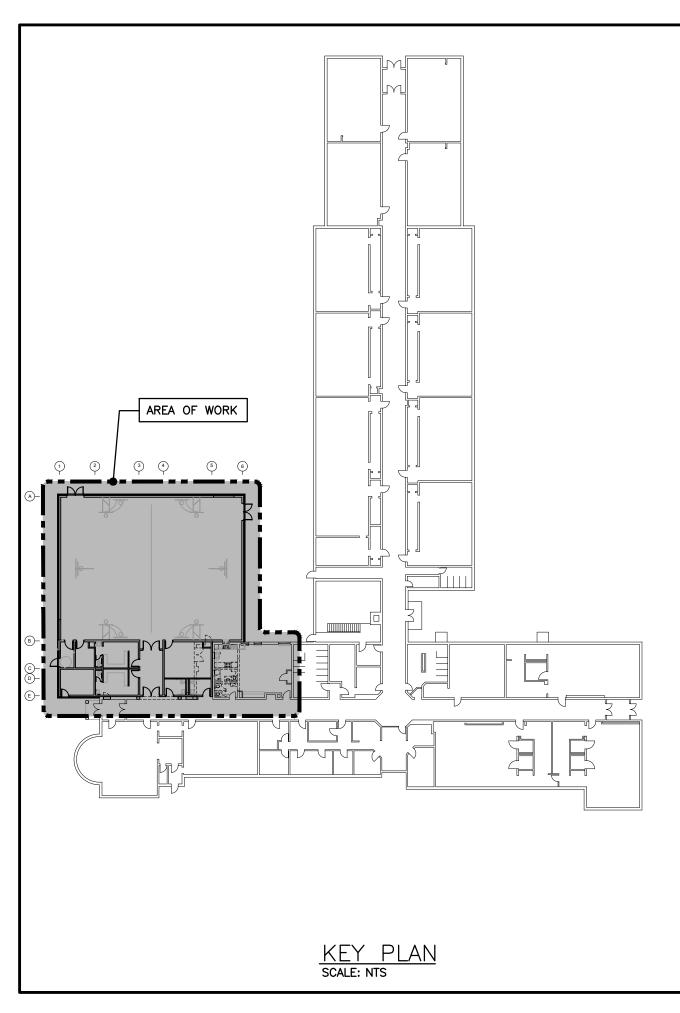

Item	Description	Item	Description
	CUT EXISTING & CONNECT NEW PIPING	o	INLINE PUMP
-	FLOW DIRECTION	TCV	TEMPERATURE CONTROL VALVE
·	DOMESTIC COLD WATER PIPING	FE FE	RECESSED CABINET MOU FIRE EXTINGUISHER
	DOMESTIC HOT WATER PIPING	▼ FE	WALL MOUNTED FIRE EXTINGUISHER
	DOMESTIC HOT WATER RECIRC. PIPING	[] FB	FIRE BLANKET IN CABINE
	EXISTING DOMESTIC COLD WATER PIPING	oco	FLOOR CLEANOUT
	EXISTING DOMESTIC HOT WATER PIPING	_C O	THERMOSTAT (WITH OR WITHOUT GUARD)
	EXISTING DOMESTIC HOT WATER RECIRC. PIPING)))))	TURNING VANES
EX-SAN-	EXISTING SANITARY PIPING ABOVE FLOOR		BETFUFFENI/ADMISST AIR D
EX-SAN-	EXISTING SANITARY PIPING BELOW FLOOR		
SAN	SANITARY PIPING ABOVE FLOOR	-	ACOUSTIC DUCT LINING
— — SAN — —	SANITARY PIPING BELOW FLOOR	<u> </u>	BRERMALLINEUSATIONN (
—ST—·—	EXISTING STORM PIPING ABOVE FLOOR		C/W BALANCING DAMPER
—ST—·—	EXISTING STORM PIPING BELOW FLOOR		TRUNK MAIN BRANCH CO
—st-·—	STORM PIPING ABOVE FLOOR		C/W BALANCING DAMPER
—st—·—	STORM PIPING BELOW FLOOR		
SP	SPRINKLER PIPING	— BD	BALANCING DAMPER
——н w s——	HEATING WATER SUPPLY PIPING	— ОВD	OPPOSED BLADE DAMPE
— —н w R— —	HEATING WATER RETURN PIPING	— FD	FIRE DAMPER
G	NATURAL GAS PIPING		FLEXIBLE ROUND DUCT
——HPG——	HIGH PRESSURE NATURAL GAS PIPING		DIFFUSER/GRILLE SIZE (TYPE & CAPACITY (cfm)
FD ℃ →	FLOOR DRAIN	Type Size Cap.	
- 79-P-	TRAP PRIMER	Size 1	HYDRONIC HEATING SIZE
	TEE CONNECTION	Capacity	TYPE & CAPACITY
c —	PIPE DOWN	AD	ACCESS DOOR
•—	PIPE UP	EXP	EXPANSION COMPENSATOR/JOINT
	SCREWED OR WELDED PIPE CAP	RIC	RETURN IN CABINET
I <u>Q</u> I	BALL VALVE	AFF	ABOVE FINISHED FLOOR
BV BV	BALANCING VALVE	— EX —	EXISTING DUCT (SIZE AS INDICATED)

GENERAL NOTES

- A. ALL DRAWINGS ARE TO BE READ IN CONJUNCTION WITH THE PREPARED SPECIFICATION.
- 3. CONTRACTOR TO INCLUDE COST FOR CONSULTANT TO COMPLETE ELECTRONIC CAD AS-BUILT DWGS (ALL PAGES). REFER TO SPEC SECTION 20 02 51 RECORD DWGS.
- C. ALL PIPING, DUCTWORK, AND EQUIPMENT IS TO BE RESTRAINED TO MEET SEISMIC CODE REQUIREMENTS. SUPPLY AND INSTALL ALL SEISMIC RESTRAINT MATERIALS TO MANUFACTURER'S WRITTEN INSTRUCTIONS. REFER TO SPECIFICATION.
- D. SANITARY VENT PIPING IS NOT SHOWN. PROVIDE ALL NECESSARY VENT PIPING FROM ALL FIXTURES FOR A COMPLETE SYSTEM TO ALL LOCAL PLUMBING CODE & LOCAL AUTHORITY REQUIREMENTS, CONNECTED TO EXISTING VENTS OR NEW VENTS AS REQUIRED. CO-ORDINATE VENT LOCATION(S) WITH GENERAL CONTRACTOR. MAINTAIN MIN 14'-0" FROM ANY AIR INLET. INSTALL VENT PIPING HIGH IN JOIST SPACE.
- E. WHERE DUCTWORK PENETRATES CORRIDOR WALL, CENTER DUCT(S) BETWEEN OWSJ.
- F. CO-ORDINATE WITH THE GENERAL CONTRACTOR ANY OWSJ BRIDGING/CROSS BRACING RELOCATION OR REMOVAL/REPLACEMENT REQUIRED FOR INSTALLATION OF DUCTWORK.
- G. CONTRACTOR TO LOCATE ISOLATION VALVES / FREEZE PIPING / OR OTHERWISE DRAIN SYSTEMS TO ALLOW PROPOSED WORK TO PROCEED. REFILL SYSTEMS AS INDICATED.

 H. UPON COMPLETION OF THE PROJECT OR UPON COMPLETION OF EACH INDIVIDUAL PHASE OF THE PROJECT THE CONTRACTORS SHALL PROVIDE THE FOLLOWING CERTIFICATES BEFORE
- CONFORMANCE LETTERS ARE ISSUED BY THE CONSULTANT:

 POTABLE WATER TEST (SEE SPEC 22 11 16 PART 3)

 COPY OF MANDATORY TSSA/CSA-B149 GAS PRESSURE TEST TAG

 MECHANICAL SEISMIC RESTRAINT ENGINEER'S INSPECTION/CONFORMANCE LETTER
- ALL CERTIFICATES ARE TO BE SUBMITTED TOGETHER IN A SINGLE PACKAGE.

IMPORTANT NOTES

A. SEISMIC RESTRAINT IS REQUIRED FOR THIS PROJECT.

- B. ALL PIPING, DUCTWORK AND EQUIPMENT IS TO BE RESTRAINED TO MEET CODE REQUIREMENTS. THE SEISMIC RESTRAINT MANUFACTURER SHALL PROVIDE DOCUMENTATION ON MAXIMUM RESTRAINT SPACING FOR VARIOUS RESTRAINT SIZES AND ANCHORS, AS WELL AS "WORST CASE" REACTION LOADS FOR EACH RESTRAINT AND/OR ANCHOR SIZE.
- C. SUBMIT SHOP DRAWING AND DESIGN CALCULATION TO CALCULATE REQUIREMENTS FOR SELECTING SEISMICALLY RATED VIBRATION ISOLATORS AND SEISMIC RESTRAINTS. CERTIFICATION DOCUMENTS TO BE SIGNED AND SEALED BY A QUALIFIED PROFESSIONAL ENGINEER WITH AT LEAST 5 YEARS OF EXPERIENCE IN THE DESIGN OF SEISMIC RESTRAINTS. PROFESSIONAL ENGINEER SHALL HAVE LOCAL JURISDICTION AND PROVIDE PERIODIC FIELD REVIEW AND FINAL CERTIFICATION UPON COMPLETION OF THE PROJECT. ALL COSTS AND FEES ASSOCIATED WITH THE ENGINEERING SHALL BE THE RESPONSIBILITY OF THIS CONTRACTOR.
- D. REFER TO SPECIFICATION FOR ADDITIONAL REQUIREMENTS.

NOTES

1. ALL CONSTRUCTION TO MEET ONTARIO BUILDING CODE REQUIREMENTS.

2. ALL CONSTRUCTION WHETHER DETAILED ON PLAN OR NOT IS SUBJECT TO FIELD APPROVAL.

3. REVIEWED PERMIT DRAWINGS MUST REMAIN AT THEJOB SITE UNTIL COMPLETION OF THE PROJECT.

4. REVIEW OF THESE PLANS DOES NOT NECESSARILY GUARANTEE THAT THEY ARE IN CONFORMANCE WITH THE ONTARIO BUILDING CODE.

5. IT IS THE OWNER/BUILDER'S RESPONSIBILITY TO CALL FOR INSPECTIONS IN ACCORDANCE WITH THE ONTARIO BUILDING CODE.

The ARCHITECT and/or PROFESSIONAL ENGINEERS shall be responsible for the field review of the building during construction to ensure conformance to the approved design. Field review reports must be submitted at least monthly to the Burlington Building Department. Prior to occupancy, the Architect and/or Professional Engineers must also submit a signed statement that, based upon their field review of the work falling within their discipline, they are of the opinion that such work has been carried out in general accordance with the approved plans.

CITY OF BURLINGTON
BUILDING SERVICES
REVIEWED
FOR PERMIT ISSUANCE
DATE JULY 31, 2024
PERMIT NUMBER 24 008616

EXAM JK



2050 Guelph Line, Burlington, ON.

Glenview Public School
Gym Addition

143 Townsend Ave.,

Burlington, ON. L7T 1Z1

Architects
SN/der



The contractor shall verify all dimensions and report all errors and discrepancies to the Consultant before commencement of the work. The drawings show general arrangement of services. Follow as closely as actual building construction will permit. Obtain approval for relocation of service from Consultant before commencement of the work.

The drawings do not indicate all offsets fitting and accessories which may be required. Provide the same to meet the required conditions. Drawings and specifications, etc., prepared and issued by the consultant are the property of the consultant and must be returned at the completion of the project. These documents are not to be duplicated or copied without the consent of the Consultant.

Do not scale this drawing.


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ALL CONSTRUCTION TO MEET ONTARIO BUILDING CODE REQUIREMENTS


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MAY 03 2024

CITY OF BURLINGTON BUILDING DEPARTMENT



Revision

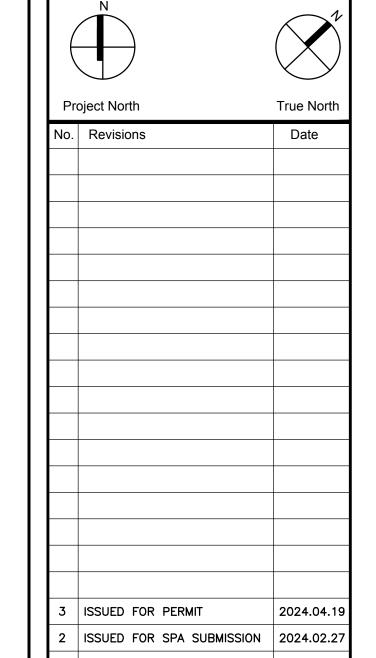

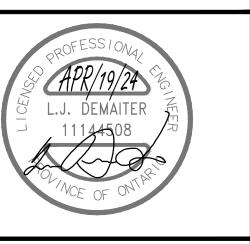SITE PLAN, LEGEND, & SCHEDULES

Scale: AS NOTED Date: JAN 2024


Drawn by: DF Checked by: MW

Job No. Drawing No.

2314

M101

Cos - Building Department

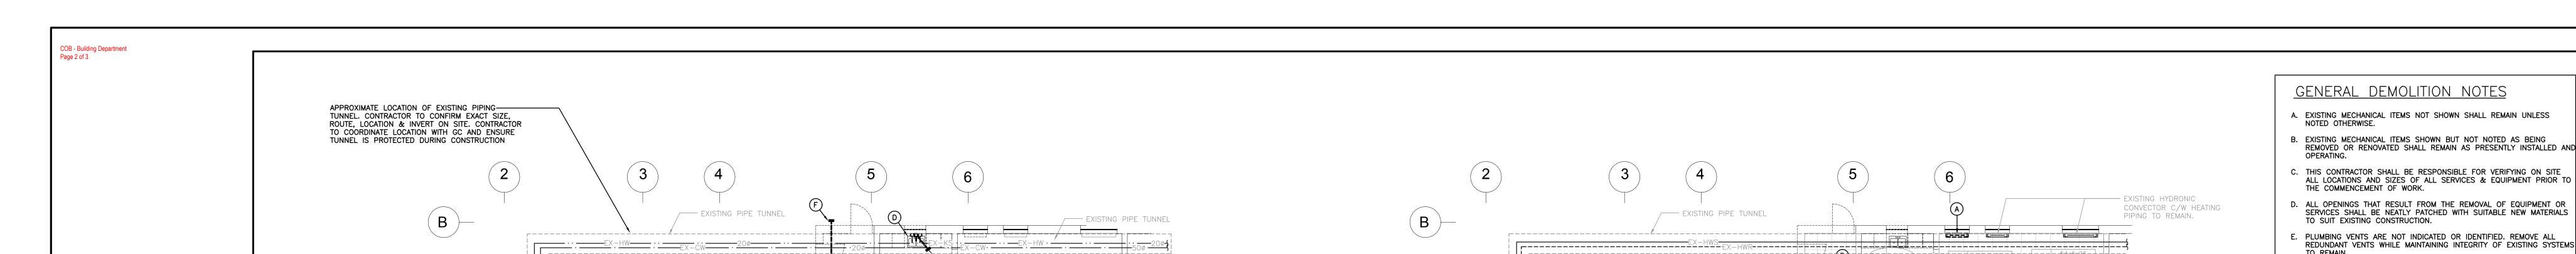

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ALL STORM AND SANITARY MAINS

-APPROXIMATE LOCATION OF EXISTING STORM &


SANITARY MAINS. CONTRACTOR TO CONFIRM EXACT

SIZE, ROUTE, LOCATION & INVERT ON SITE (XRAY,

SCAN AND CAMERA DRAIN AS REQUIRED). TYPICAL

eloped classification of not more thar 0 except as specified in Div. B, 3.6.4.3.

GROUND FLOOR PART PLAN — PLUMBING DEMOLITION SCALE: 1:100

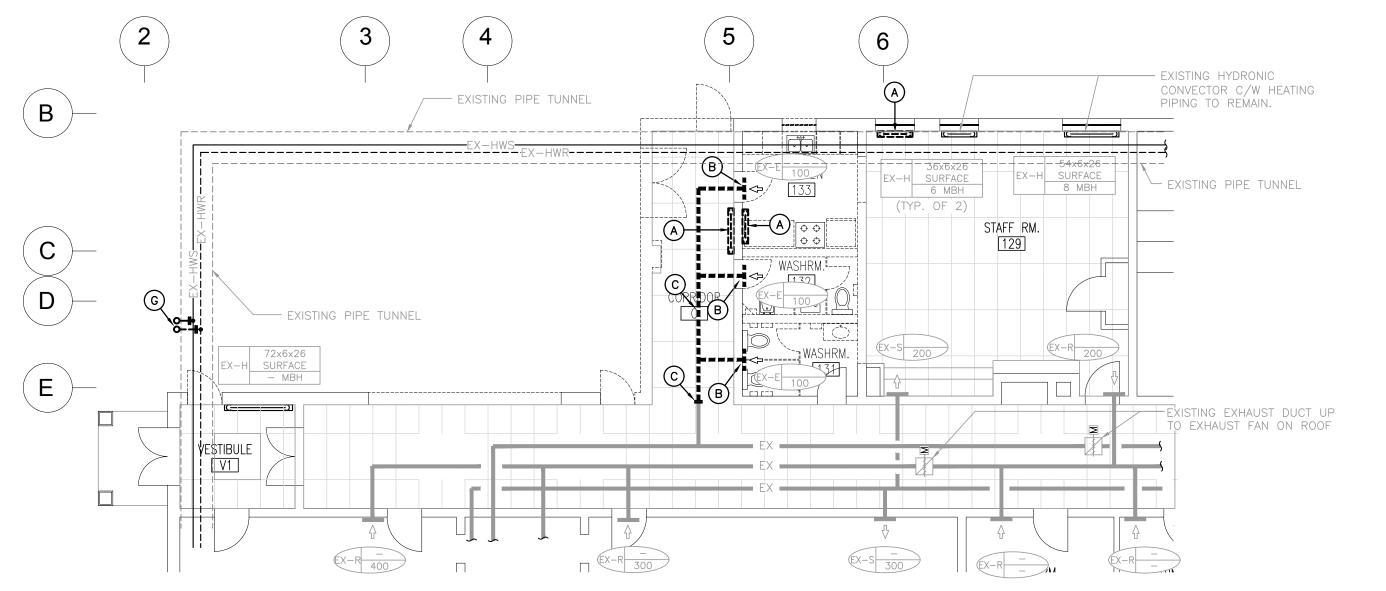

GROUND FLOOR PART PLAN — HVAC DEMOLITION SCALE: 1:100

GENERAL DEMOLITION NOTES

- B. EXISTING MECHANICAL ITEMS SHOWN BUT NOT NOTED AS BEING REMOVED OR RENOVATED SHALL REMAIN AS PRESENTLY INSTALLED AND


- O. ALL OPENINGS THAT RESULT FROM THE REMOVAL OF EQUIPMENT OR SERVICES SHALL BE NEATLY PATCHED WITH SUITABLE NEW MATERIALS TO SUIT EXISTING CONSTRUCTION.
- PLUMBING VENTS ARE NOT INDICATED OR IDENTIFIED, REMOVE ALL REDUNDANT VENTS WHILE MAINTAINING INTEGRITY OF EXISTING SYSTEMS
- REMOVAL OF EXISTING PIPING, OR DUCT SYSTEMS INCLUDES REMOVAL OF ALL HANGERS, INSULATION, FITTINGS, ETC.
- . MAINTAIN INTEGRITY OF EXISTING SYSTEMS THAT ARE TO REMAIN OR BE
- I. INSTALL NEW SYSTEM OR SERVICES WHERE REQUIRED TO MAINTAIN SYSTEM OPERATION PRIOR TO DEMOLITION OF EXISTING SERVICES.
- THIS CONTRACTOR IS TO REMOVE & REPLACE CEILINGS AS REQUIRED FOR REMOVAL/REPLACEMENT OF SERVICES. CONTRACTOR TO ALLOW FOR DRAINING AND DISPOSING OF ENTIRE SCHOOL DOMESTIC & HYDRONIC SYSTEMS (OR PIPE FREEZING AS REQUIRED) TO SUIT RENOVATION WORK.


SPECIFIC DEMOLITION NOTES

- A. REMOVE EXISTING HYDRONIC CONVECTOR C/W HEATING PIPING AND CAP HEATING PIPING AT MAIN BELOW FLOOR AND INFILL HOLES.
- B. REMOVE EXISTING EXHAUST GRILLE C/W BRANCH DUCT AND CAP AT MAIN.
- . REMOVE EXISTING EXHAUST DUCT BEYOND AND CAP AT
- O. REMOVE EXISTING PLUMBING FIXTURE COMPLETE WITH ASSOCIATED WATER, DRAIN AND VENT PIPING. CAP
- REMOVE EXISTING ABANDONED WATER AND DRAIN PIPING FROM PREVIOUS PLUMBING FIXTURE REMOVED. CAP
- PIPING WITH-IN TUNNEL. REMOVE EXISTING STORM PIPING AND CAP AT

EXISTING PIPING AT MAIN.

UNDERGROUND MAIN. . REMOVE EXISTING ABANDONED HEATING PIPING FROM PREVIOUS HEATER REMOVED. CAP PIPING WITH-IN TUNNEL.

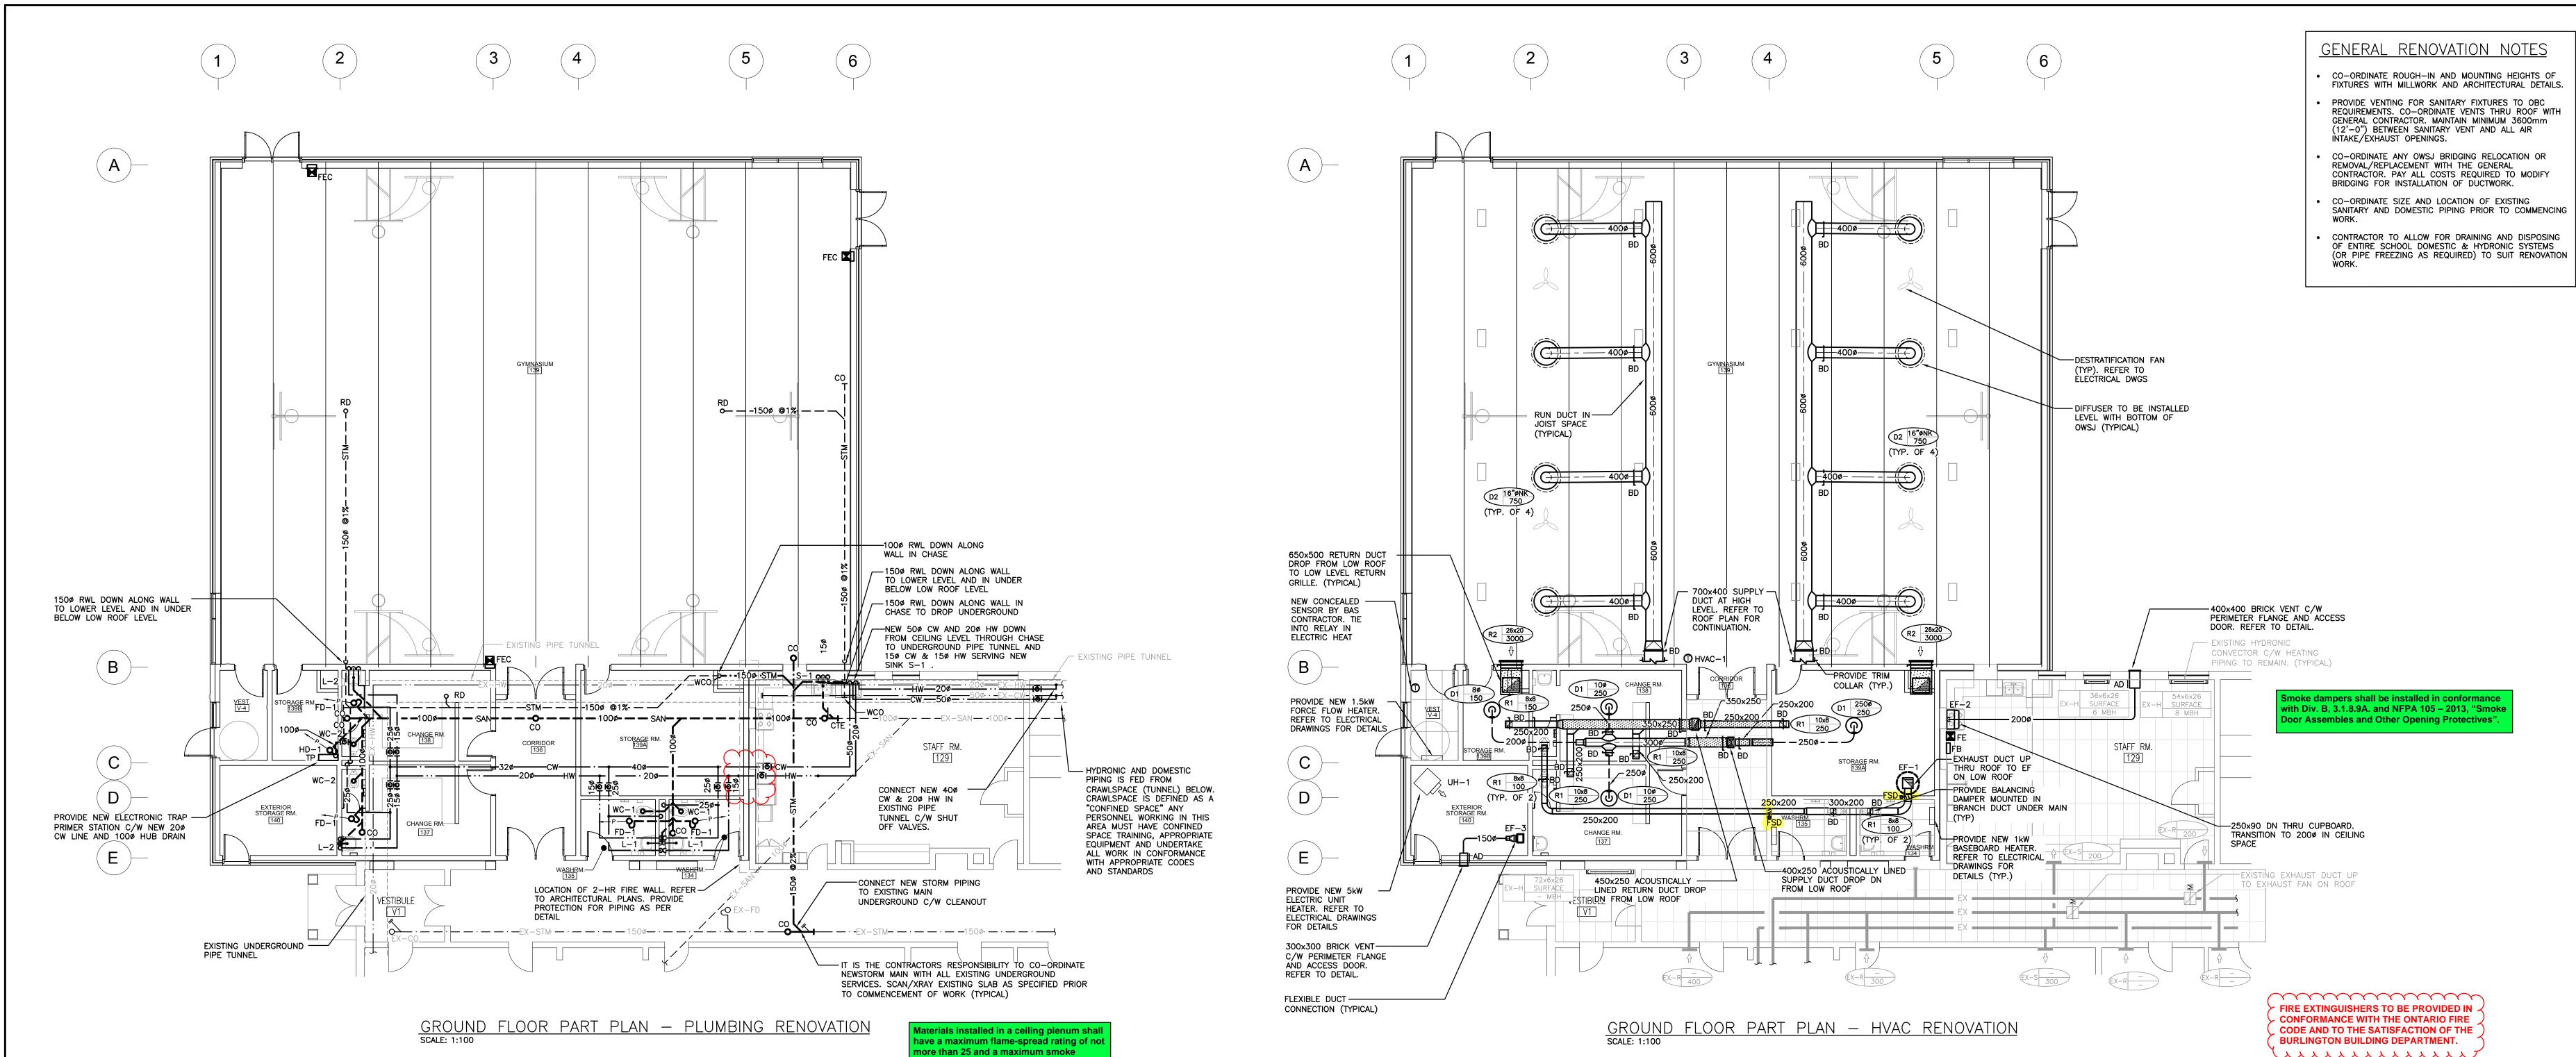

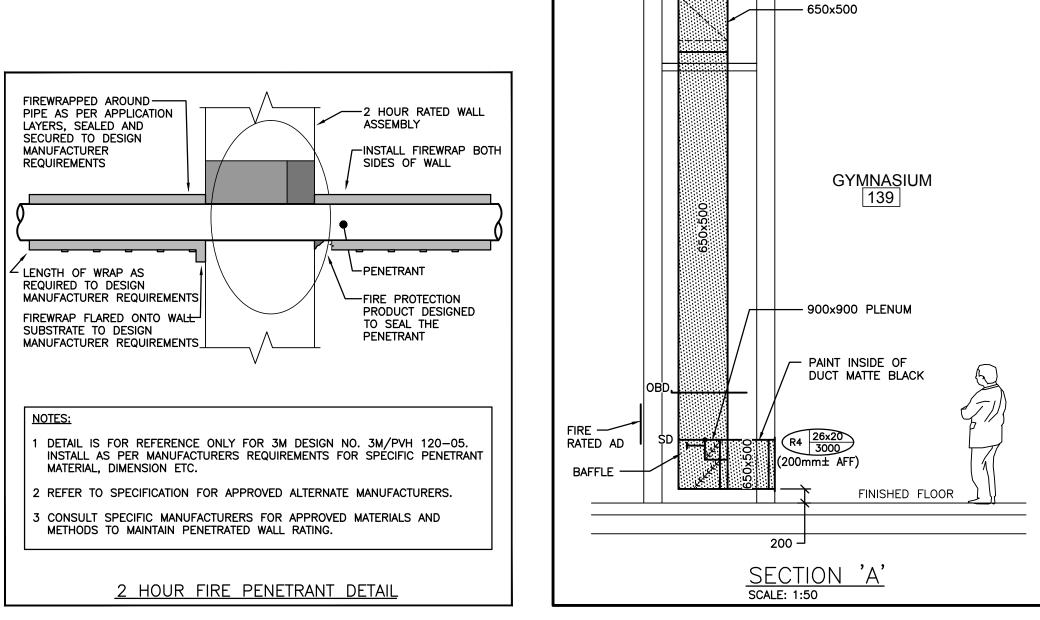



Burlington, ON. L7P 5A8

2050 Guelph Line,

Glenview Public School

Gym Addition

143 Townsend Ave.,

Burlington, ON. L7T 1Z1

Architects

Snyder Architects Inc.

100 Broadview Ave, Suite 301, Toronto, ON M4M 3H3

t. 416.966.5444, w. snyderarchitects.ca

Consulting Engineers

MECHANICAL | ELECTRICAL | AQUATIC

The contractor shall verify all dimensions and report all errors and discrepancies to the

Consultant before commencement of the work.

The drawings show general arrangement of services. Follow as closely as actual building construction will permit. Obtain approval for relocation of service from Consultant before

The drawings do not indicate all offsets fitting

the same to meet the required conditions.

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ALL CONSTRUCTION TO

CODE REQUIREMENTS

MEET ONTARIO BUILDING

MAY 03 2024

CITY OF BURLINGTON

BUILDING DEPARTMEN

ISSUED FOR PERMIT

ISSUED FOR SPA SUBMISSION | 2024.02.27 ISSUED FOR SPA REVIEW SET | 2024.02.06

Revision

L.J. DEMAITER

Drawing Title:

GROUND FLOOR

Scale: AS NOTED Date: JAN 2024

Checked by: XX

DEMOLITION &

RENOVATION

DRAWINGS

Drawn by: XX

True North

Date

2024.04.19

Project North

and accessories which may be required. Provide


Drawings and specifications, etc., prepared and


completion of the project. These documents ar not to be duplicated or copied without the

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Halton District School 205 Board

2050 Guelph Line, Burlington, ON. L7P 5A8

Glenview Public School
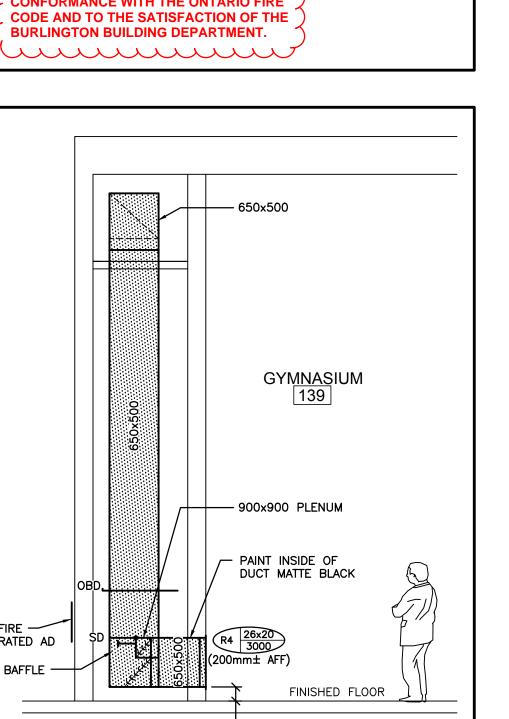
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143 Townsend Ave.,

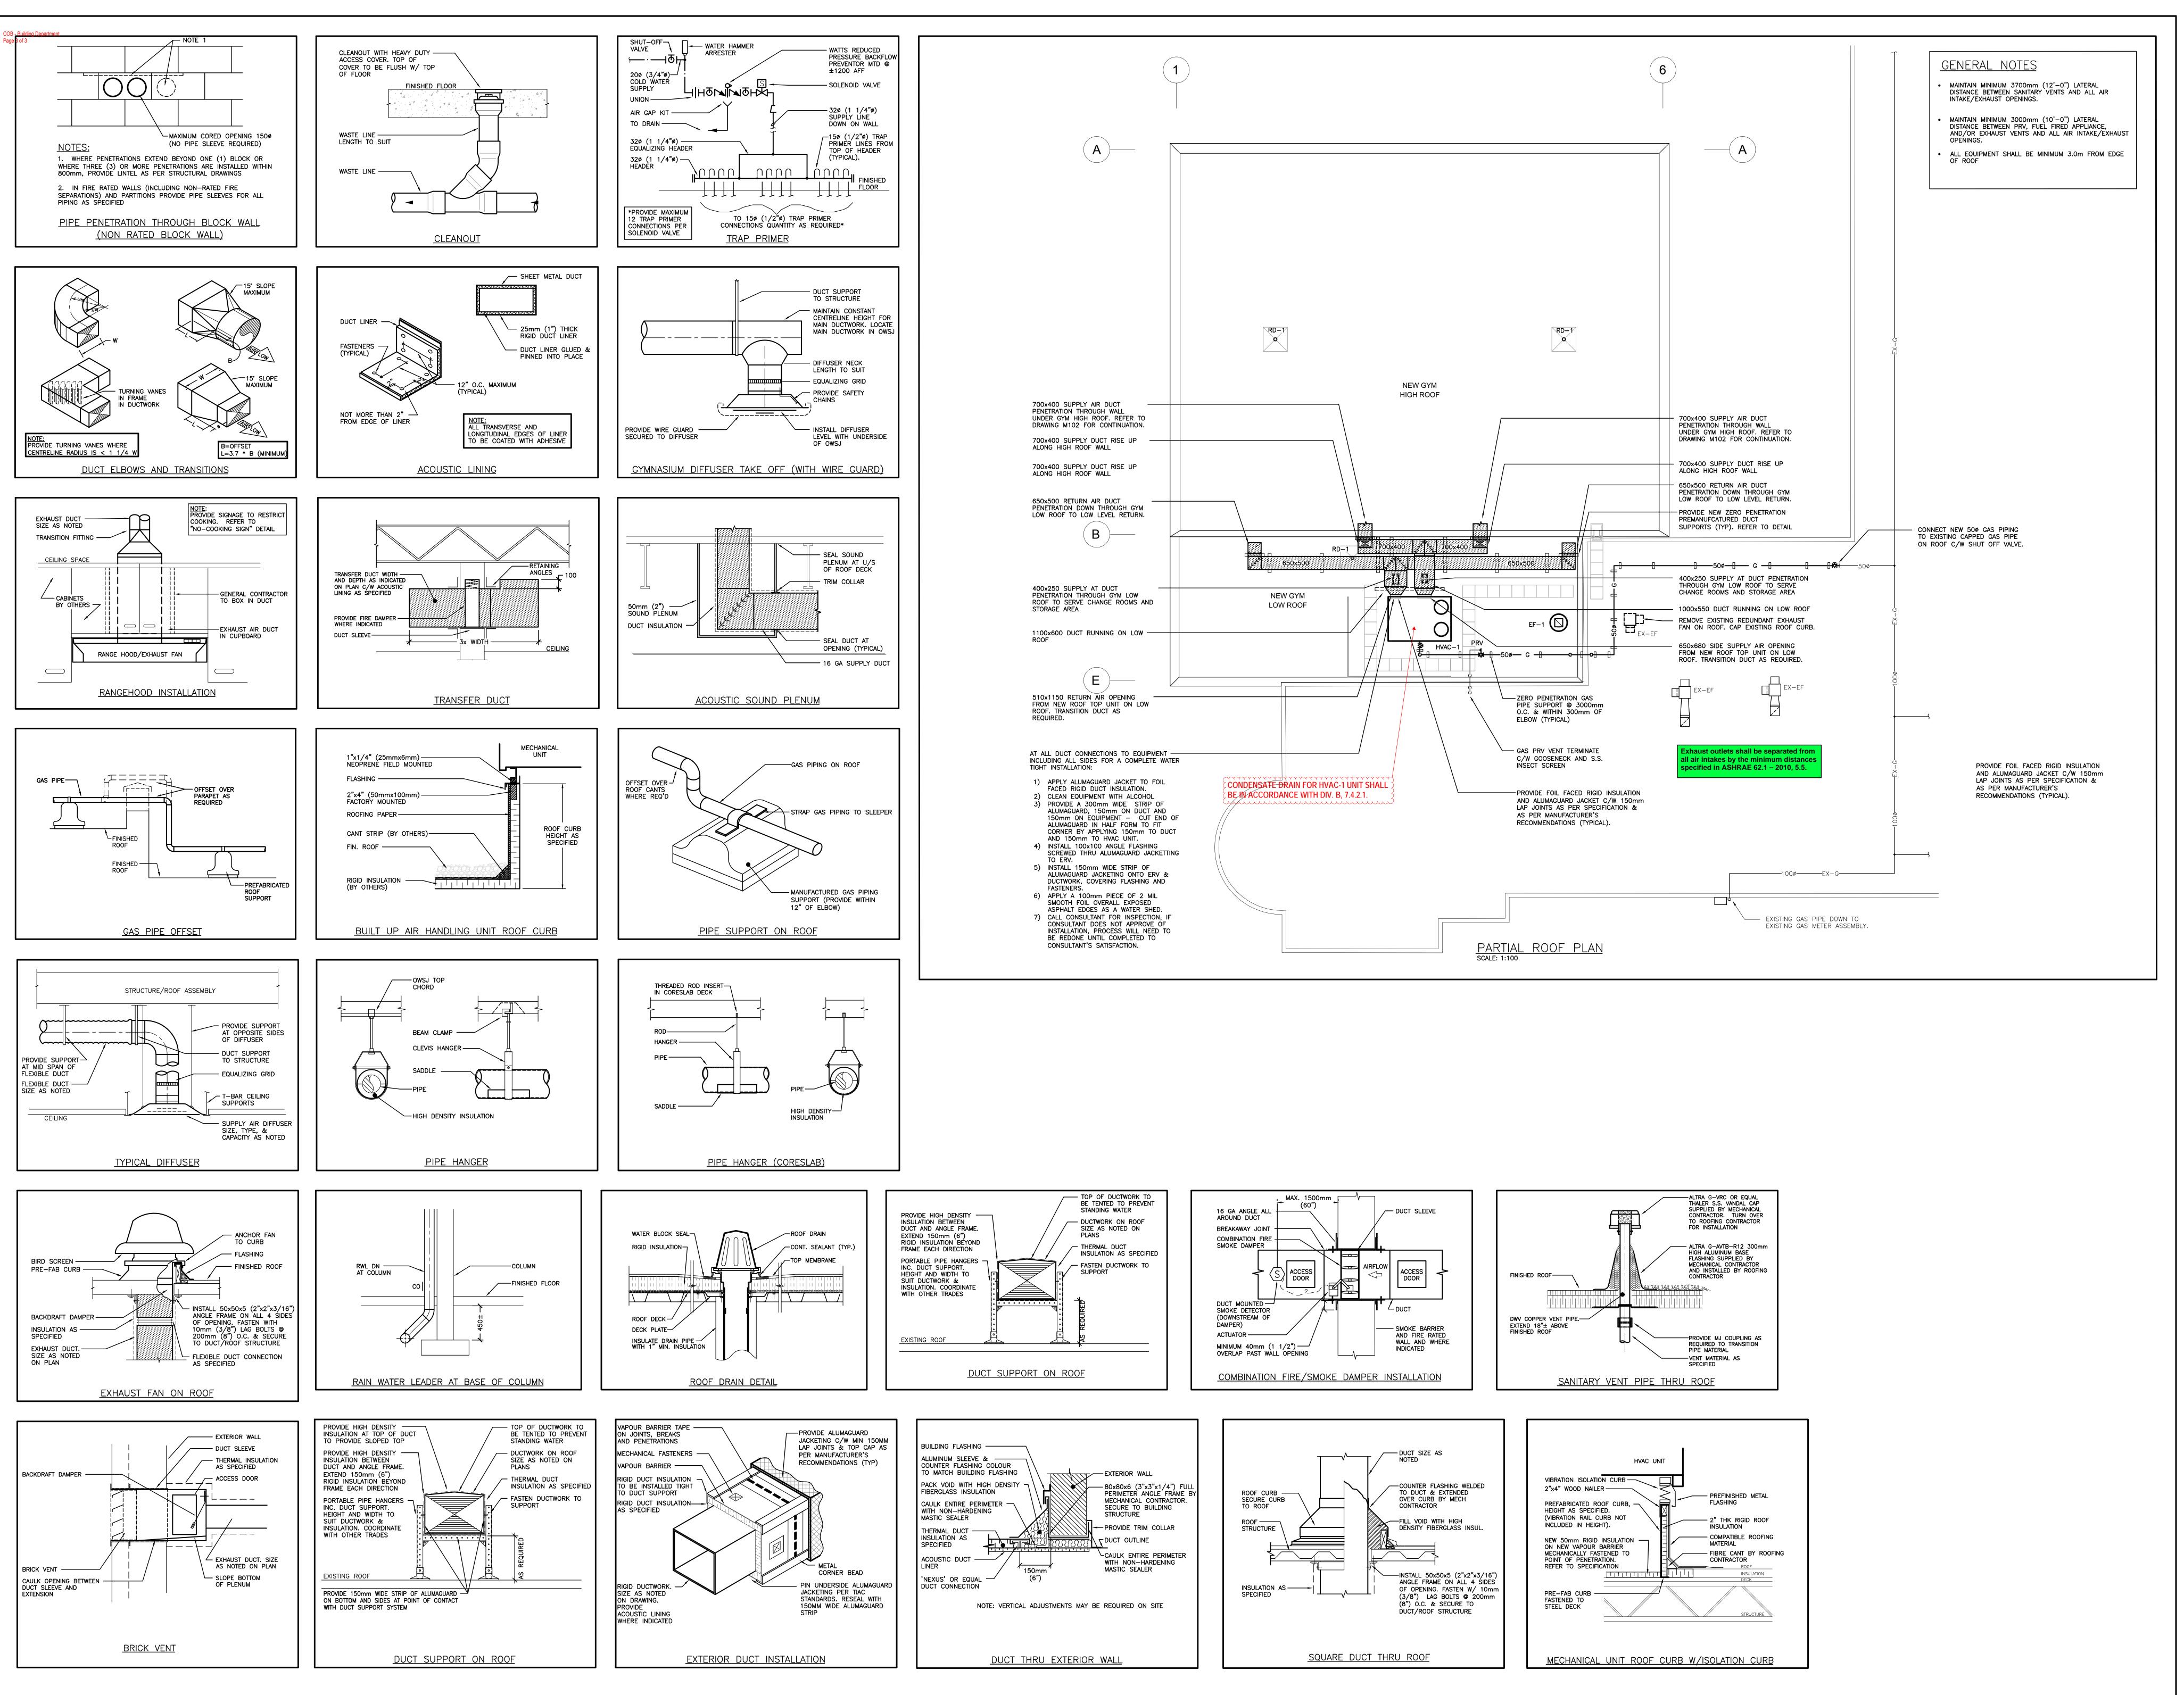Burlington, ON. L7T 1Z1

Sn/der
Snyder Architects Inc.
100 Broadview Ave, Suite 301,

Toronto, ON M4M 3H3 t. 416.966.5444, w. snyderarchitects.ca



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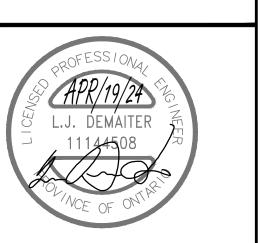
ALL CONSTRUCTION TO MEET ONTARIO BUILDING CODE REQUIREMENTS

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MAY 03 2024

CITY OF BURLINGTOI

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_	oject North	True North
No.	Revisions	Date
3	ISSUED FOR PERMIT	2024.04.19
2	ISSUED FOR SPA SUBMISSION	2024.02.27
1	ISSUED FOR SPA REVIEW SET	2024.02.06
NIO	Povision	Data



Revision Date

PARTIAL ROOF PLAN & DETAILS MECHANICAL

Scale: AS NOTED Date: JAN 2024

Drawn by: DF Checked by: MW

Job No. Drawing No.

2314

M103

Department