

INDICATES REMOVED EXISTING EXTERIOR FIXTURE. PROVIDE NEW FIXTURE AS INDICATED. WIRE TO EXISTING LIGHTING CIRCUIT. REMOVE EXISTING TIME CLOCK LOCATED IN MECHANICAL ROOM NEAR EXIT DOOR 6.

	LIGHTING		POWER		
Х	LIGHT FIXTURE TYPE AS INDICATED	Ф	WALL MOUNTED TAMPER RESISTANT RECEPTACLE (15A-120V)		
<b>75</b> EM−X	COMBINATION EMERGENCY/EXIT TYPE AS INDICATED (EM-X INDICATES BATTERY UNIT	47	TAMPER RESISTANT RECEPTACLE MTD. ABOVE COUNTER (15A-120V)		
EM-X DC-X EM-X	TYPE, DC-X INDICATES DC CIRCUIT, AND X-X INDICATES AC SOURCE CIRCUIT)	•	WALL MOUNTED T-SLOT RECEPTACLI (20A-120V)		
Ø Ø	CEILING OR WALL MOUNTED LIGHT FIXTURE TYPE AS INDICATED	#	T-SLOT RECEPTACLE MTD. ABOVE COUNTER (20A-120V)		
ğ	POLE MOUNTED LIGHT FIXTURE		DIRECT CONNECTION		
×	WALL MOUNTED EXIT LIGHT SHADING INDICATES FACE	JB	JUNCTION BOX		
1 <b>)</b>	CEILING MOUNTED EXIT LIGHT ARROWS DENOTE DIRECTION SHADING INDICATES FACE	PB	PULLBOX		
Į m m	SINGLE OR TWIN EMERGENCY LIGHTING FIXTURE	_	PANEL AS INDICATED		
BB FM-Y	BATTERY UNIT WITH INTEGRAL EMERGENCY FIXTURE (EM-X INDICATES BATTERY UNIT	짣	FUSED DISCONNECT		
EM-X DC-X X-X	TYPE, DC-X INDICATES DC CIRCUIT, AND X-X INDICATES AC SOURCE CIRCUIT)	7	DESTRATIFICATION FAN		
\$	SINGLE POLE SWITCH (3=3 WAY, 4=4 WAY, P=PILOT LIGHT, K=KEYED, DM=DIMMER, M=MOTOR RATED)	HD	HAND DRYER		
\$°S	WALL MOUNTED OCCUPANCY SENSOR DUAL—TECH. LINE VOLTAGE	<b>M</b>	TIME CLOCK		
OS	CEILING MOUNTED MOTION SENSOR	•	PUSH-BUTTON STATION (QUANTITY OF BUTTONS AS PER PLANS)		
wos	WALL MOUNTED MOTION SENSOR		COMMUNICATIONS		
PK	POWER PACK	WIRELESS ACCESS POINT. PROVIDE  34" (19mm) C TO CABLE  MANAGEMENT SYSTEM OR AS NOTE			
XB	DIGITAL WALL STATION, 'X' DENOTES NUMBER OF CONTROL BUTTONS IN SINGLE GANG	8	WALL MOUNTED SPEAKER (CS=COLU SPEAKER). PROVIDE ¾" (19mm) C CORRIDOR CEILING SPACE		
	FIRE ALARM	<b>V</b> #/#	COMBINATION SINGLE VOICE/ SINGLE COMPUTER OUTLET UNLESS OTHERWISE NOTED C/W 1" (27mm) C TO CABLE		
<b>=</b>	HEAT DETECTOR (135 DEGREE RATE OF RISE AND FIXED TEMPERATURE)	VOICE	MANAGEMENT SYSTEM. # INDICATES TH QUANTITY OF ACTIVE PARTS. LEFT VALUE ALWAYS INDICATES VOICE.		
<b>⑤</b>	SMOKE DETECTOR (RL=RELAY BASE)	2	PROGRAM BELL		
	PULLSTATION	A	AI-PHONE		
Y	COMBINATION HORN/STROBE	\$	CEILING MOUNTED SPEAKER. PROVIDE 34" (19mm) C TO CORRIDOR CEILING SPACE		
	END-OF-LINE RESISTOR	▼	HORN SPEAKER		
DH	DOOR HOLD OPEN DEVICE	₩	MICROPHONE OUTLET		
FSD	FIRE SMOKE DAMPER	<b>A</b>	AUXILIARY ROUGH-IN FOR USE AS NOTED.		
	ACCESS CONTROL		GENERAL		
ES	ELECTRIC STRIKE. CONFIRM ROUGHIN WITH DOOR HARDWARE.	ER	INDICATED EXISTING ITEM TO REMAIN		
CR	CARD/FOB READER ROUGH—IN AS A SINGLE GANG BOX AT 1100mm AFF C/W 13mmC TO ELECTRIC	D	INDICATES EXISTING ITEM TO BE DELETED		
UK)	STRIKÉ IN ADJACENT DOOR FRAME. CONFIRM ROUGH—IN WITH DOOR HARDWARE.	R	INDICATES EXISTING ITEM TO BE RELOCATED/IN RELOCATED POSITION		
STA	NDARD CIRCUIT LABELING	GF	GROUND FAULT		
POWER	PANEL LABEL — A-1-1	TR	TR TAMPER RESISTANT		
CIRCUIT	INDICATION	CLG	CEILING MOUNTED		
	ELECTRIC HEAT	WG	WIRE GUARD		
$\bigotimes$	FAN FORCED ELECTRIC HEATER (TYPE AS INDICATED)	×	NOTE INDICATOR		
1X	UNIT HEATER (TYPE AS INDICATED)	X	MECHANICAL ITEM NO.		
		GUARD	PROTECTIVE COVER		
		DW	DISHWASHER		
		MW	MILLWORK		

Glenview Public School Gym Addition 143 Townsend Ave., Burlington, ON. L7T 1Z1 Architects **Snyder Architects Inc.** 100 Broadview Ave, Suite 301, Toronto, ON M4M 3H3 t. 416.966.5444, w. snyderarchitects.ca MECHANICAL | ELECTRICAL | AQUATIC The contractor shall verify all dimensions and report all errors and discrepancies to the Consultant before commencement of the work. The drawings show general arrangement of services. Follow as closely as actual building construction will permit. Obtain approval for relocation of service from Consultant before commencement of the work.

The drawings do not indicate all offsets fitting and accessories which may be required. Provide the same to meet the required conditions. Drawings and specifications, etc., prepared and issued by the consultant are the property of the consultant and must be returned at the completion of the project. These documents are not to be duplicated or copied without the consent of the Consultant.

Do not scale this drawing.

© 2024 DEI Consulting Engineers Inc. © 2024 DEI Consulting Engineers Inc. ALL CONSTRUCTION TO MEET ONTARIO BUILDING CODE REQUIREMENTS MAY 03 2024 CITY OF BURLINGTON BUILDING DEPARTMENT ALL ELECTRICAL WIRING MUST BE INSPECTED BY THE ELECTRICAL SAFETY AUTHORITY. SEPARATE INSPECTION APPLICATIONS (PERMITS) MUST BE FILED. FOR MORE INFORMATION PLEASE CALL ELECTRICAL SAFETY AUTHORITY CUSTOMER SERVICE CENTRE PHONE FAX Safety 1-800-667-4278 all be responsible for the field review of the building ring construction to ensure conformance to the approved gn. Field review reports must be submitted at least thly to the Burlington Building Department. Prior to ield review of the work falling within their discipline, they are of the opinion that such work has been carried out in general accordance with the approved plans. CITY OF BURLINGTON BUILDING SERVICES **REVIEWED**FOR PERMIT ISSUANCE <sup>E</sup> JULY 12, 2024 RMIT NUMBER **24** 008616

Date

ISSUED FOR PERMIT


ISSUED FOR SPA SUBMISSION 2024.02.2

ISSUED FOR SPA REVIEW SET 2024.02.06


LEGEND, SITE PLAN, NOTES AND KEY PLAN

NOTE: ALL SYMBOLS MAY NOT BE USED

2050 Guelph Line, Burlington, ON.

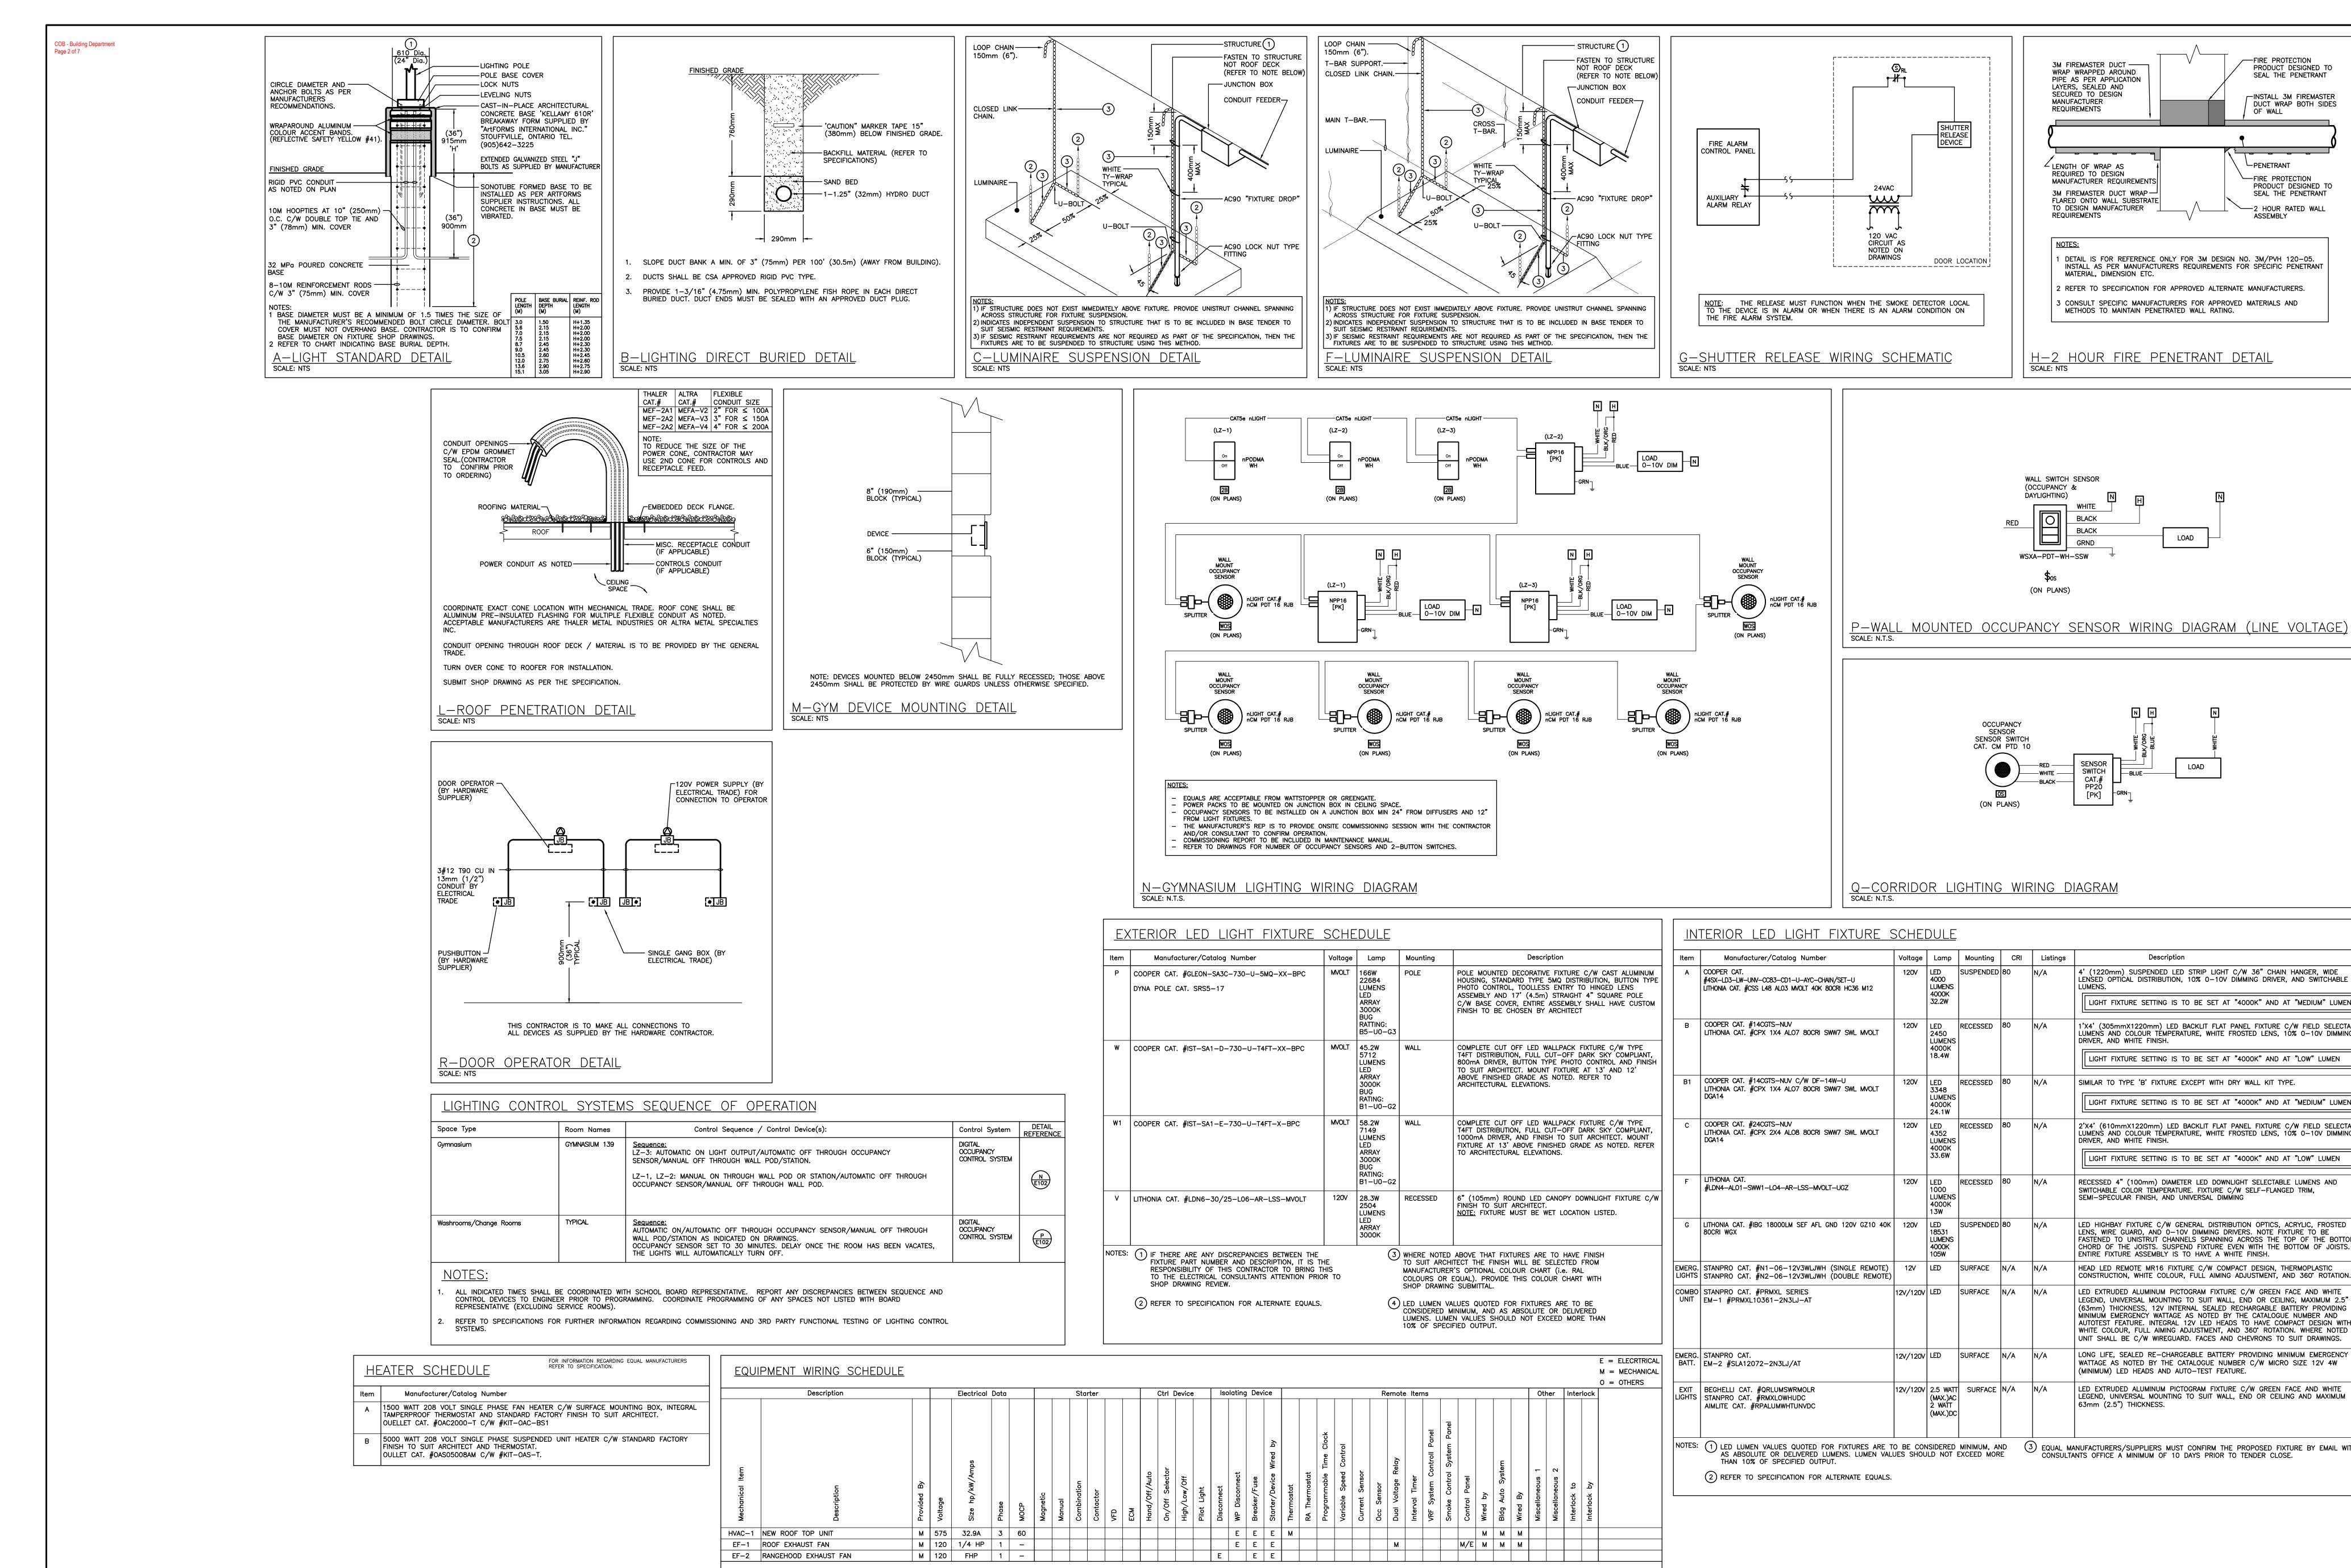

<u>Notes:</u>

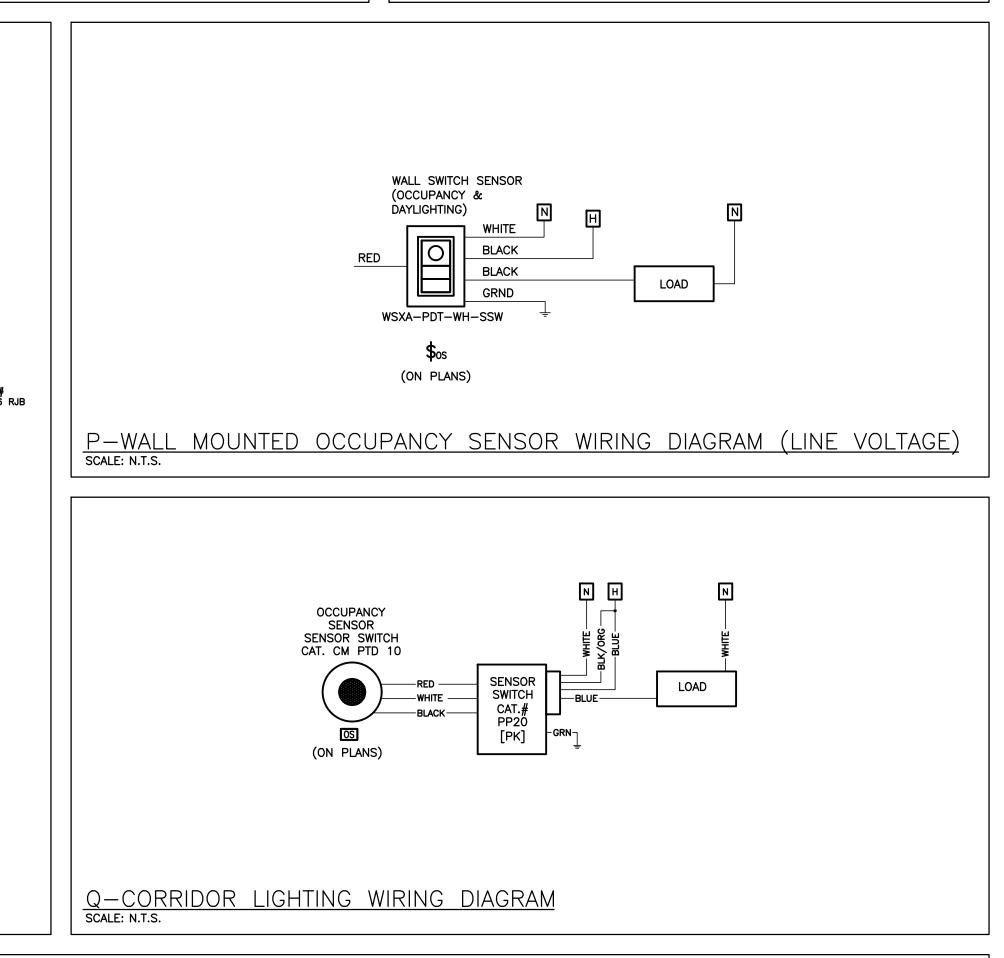

3M FIREMASTER DUCT ———

WRAP WRAPPED AROUND

PIPE AS PER APPLICATION

LAYERS, SEALED AND

SECURED TO DESIGN

LENGTH OF WRAP AS

REQUIRED TO DESIGN

REQUIREMENTS

MANUFACTURER REQUIREMENTS

3M FIREMASTER DUCT WRAP-

TO DESIGN MANUFACTURER

FLARED ONTO WALL SUBSTRATE

MATERIAL, DIMENSION ETC.

DETAIL IS FOR REFERENCE ONLY FOR 3M DESIGN NO. 3M/PVH 120-05.

REFER TO SPECIFICATION FOR APPROVED ALTERNATE MANUFACTURERS.

3 CONSULT SPECIFIC MANUFACTURERS FOR APPROVED MATERIALS AND METHODS TO MAINTAIN PENETRATED WALL RATING.

H-2 HOUR FIRE PENETRANT DETAIL

INSTALL AS PER MANUFACTURERS REQUIREMENTS FOR SPÉCIFIC PENETRANT

4' (1220mm) SUSPENDED LED STRIP LIGHT C/W 36" CHAIN HANGER, WIDE

LENSED OPTICAL DISTRIBUTION, 10% 0-10V DIMMING DRIVER, AND SWITCHABLE

LIGHT FIXTURE SETTING IS TO BE SET AT "4000K" AND AT "MEDIUM" LUMEN |

LUMENS AND COLOUR TÉMPERATURE, WHITE FROSTED LENS, 10% 0-10V DIMMING

LIGHT FIXTURE SETTING IS TO BE SET AT "4000K" AND AT "LOW" LUMEN

LIGHT FIXTURE SETTING IS TO BE SET AT "4000K" AND AT "MEDIUM" LUMEN

2'X4' (610mmX1220mm) LED BACKLIT FLAT PANEL FIXTURE C/W FIELD SELECTABLE LUMENS AND COLOUR TEMPERATURE, WHITE FROSTED LENS, 10% 0-10V DIMMING

LIGHT FIXTURE SETTING IS TO BE SET AT "4000K" AND AT "LOW" LUMEN

SIMILAR TO TYPE 'B' FIXTURE EXCEPT WITH DRY WALL KIT TYPE.

DRIVER, AND WHITE FINISH.

DRIVER, AND WHITE FINISH.

MANUFACTURER

REQUIREMENTS

DEVICE

DOOR LOCATION!

Voltage | Lamp | Mounting | CRI | Listings

SUSPENDED | 80

|RECESSED |80

|RECESSED |80

12V LED SURFACE N/A N/A

12V/120V 2.5 WATT SURFACE N/A N/A

(MAX.)DC

120V | LED | RECESSED | 80

120V LED RECESSED 80

120V LED SUSPENDED 80

120 VAC CIRCUIT AS

NOTED ON

—FIRE PROTECTION
PRODUCT DESIGNED TO

SEAL THE PENETRANT

-INSTALL 3M FIREMASTER

DUCT WRAP BOTH SIDES

PENETRANT

FIRE PROTECTION

PRODUCT DESIGNED TO

SEAL THE PENETRANT

-2 HOUR RATED WALL

2050 Guelph Line

Glenview Public School

Gym Addition

143 Townsend Ave.,

Burlington, ON. L7T 1Z1

Architects

Snyder Architects Inc

100 Broadview Ave, Suite 301,

**Consulting Engineers** MECHANICAL | ELECTRICAL | AQUATIC

The contractor shall verify all dimensions and report all errors and discrepancies to the

Consultant before commencement of the work.

The drawings show general arrangement of services. Follow as closely as actual building construction will permit. Obtain approval for relocation of service from Consultant before

The drawings do not indicate all offsets fitting

the same to meet the required conditions.

© 2024 DEI Consulting Engineers Inc.

and accessories which may be required. Provid

Drawings and specifications, etc., prepared and issued by the consultant are the property of the

consultant and must be returned at the completion of the project. These documents are not to be duplicated or copied without the consent of the Consultant.

commencement of the work.


Do not scale this drawing.

Toronto, ON M4M 3H3

t. 416.966.5444, w. snyderarchitects.ca

Burlington, ON.

L7P 5A8

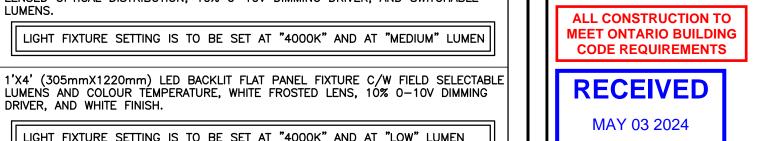

CITY OF BURLINGTON BUILDING DEPARTMEN

SWITCH	SSED 4" (100mm) DIAMETER LED DOWNLIGHT SELECTABLE LUMENS AND HABLE COLOR TEMPERATURE. FIXTURE C/W SELF—FLANGED TRIM, SPECULAR FINISH, AND UNIVERSAL DIMMING	(	N	
LENS, FASTEI CHORI	HIGHBAY FIXTURE C/W GENERAL DISTRIBUTION OPTICS, ACRYLIC, FROSTED WIRE GUARD, AND 0-10V DIMMING DRIVERS. NOTE FIXTURE TO BE NED TO UNISTRUT CHANNELS SPANNING ACROSS THE TOP OF THE BOTTOM OF THE JOISTS. SUSPEND FIXTURE EVEN WITH THE BOTTOM OF JOISTS. E FIXTURE ASSEMBLY IS TO HAVE A WHITE FINISH.	Pro No.	oject North  Revisions	True North  Date
	LED REMOTE MR16 FIXTURE C/W COMPACT DESIGN, THERMOPLASTIC FRUCTION, WHITE COLOUR, FULL AIMING ADJUSTMENT, AND 360° ROTATION.			
LEGEN (63mr MINIMU AUTOT WHITE	EXTRUDED ALUMINUM PICTOGRAM FIXTURE C/W GREEN FACE AND WHITE ID, UNIVERSAL MOUNTING TO SUIT WALL, END OR CEILING, MAXIMUM 2.5" n) THICKNESS, 12V INTERNAL SEALED RECHARGABLE BATTERY PROVIDING JM EMERGENCY WATTAGE AS NOTED BY THE CATALOGUE NUMBER AND TEST FEATURE. INTEGRAL 12V LED HEADS TO HAVE COMPACT DESIGN WITH COLOUR, FULL AIMING ADJUSTMENT, AND 360° ROTATION. WHERE NOTED SHALL BE C/W WIREGUARD. FACES AND CHEVRONS TO SUIT DRAWINGS.			
WATTA	LIFE, SEALED RE-CHARGEABLE BATTERY PROVIDING MINIMUM EMERGENCY GE AS NOTED BY THE CATALOGUE NUMBER C/W MICRO SIZE 12V 4W IUM) LED HEADS AND AUTO-TEST FEATURE.			
LEGEN	EXTRUDED ALUMINUM PICTOGRAM FIXTURE C/W GREEN FACE AND WHITE ID, UNIVERSAL MOUNTING TO SUIT WALL, END OR CEILING AND MAXIMUM (2.5") THICKNESS.			
IANUFACT	TURERS/SUPPLIERS MUST CONFIRM THE PROPOSED FIXTURE BY EMAIL WITH FFICE A MINIMUM OF 10 DAYS PRIOR TO TENDER CLOSE.			
		3	ISSUED FOR PERMIT	2024.04.16
		2	ISSUED FOR SPA SUBMISSION	2024.02.27




ISSUED FOR SPA REVIEW SET 2024.02.06

Revision

Drawing Title: DETAILS AND SCHEDULES

Scale: AS NOTED Date: JAN 2024 Checked by: RV Drawn by: SB Job No.

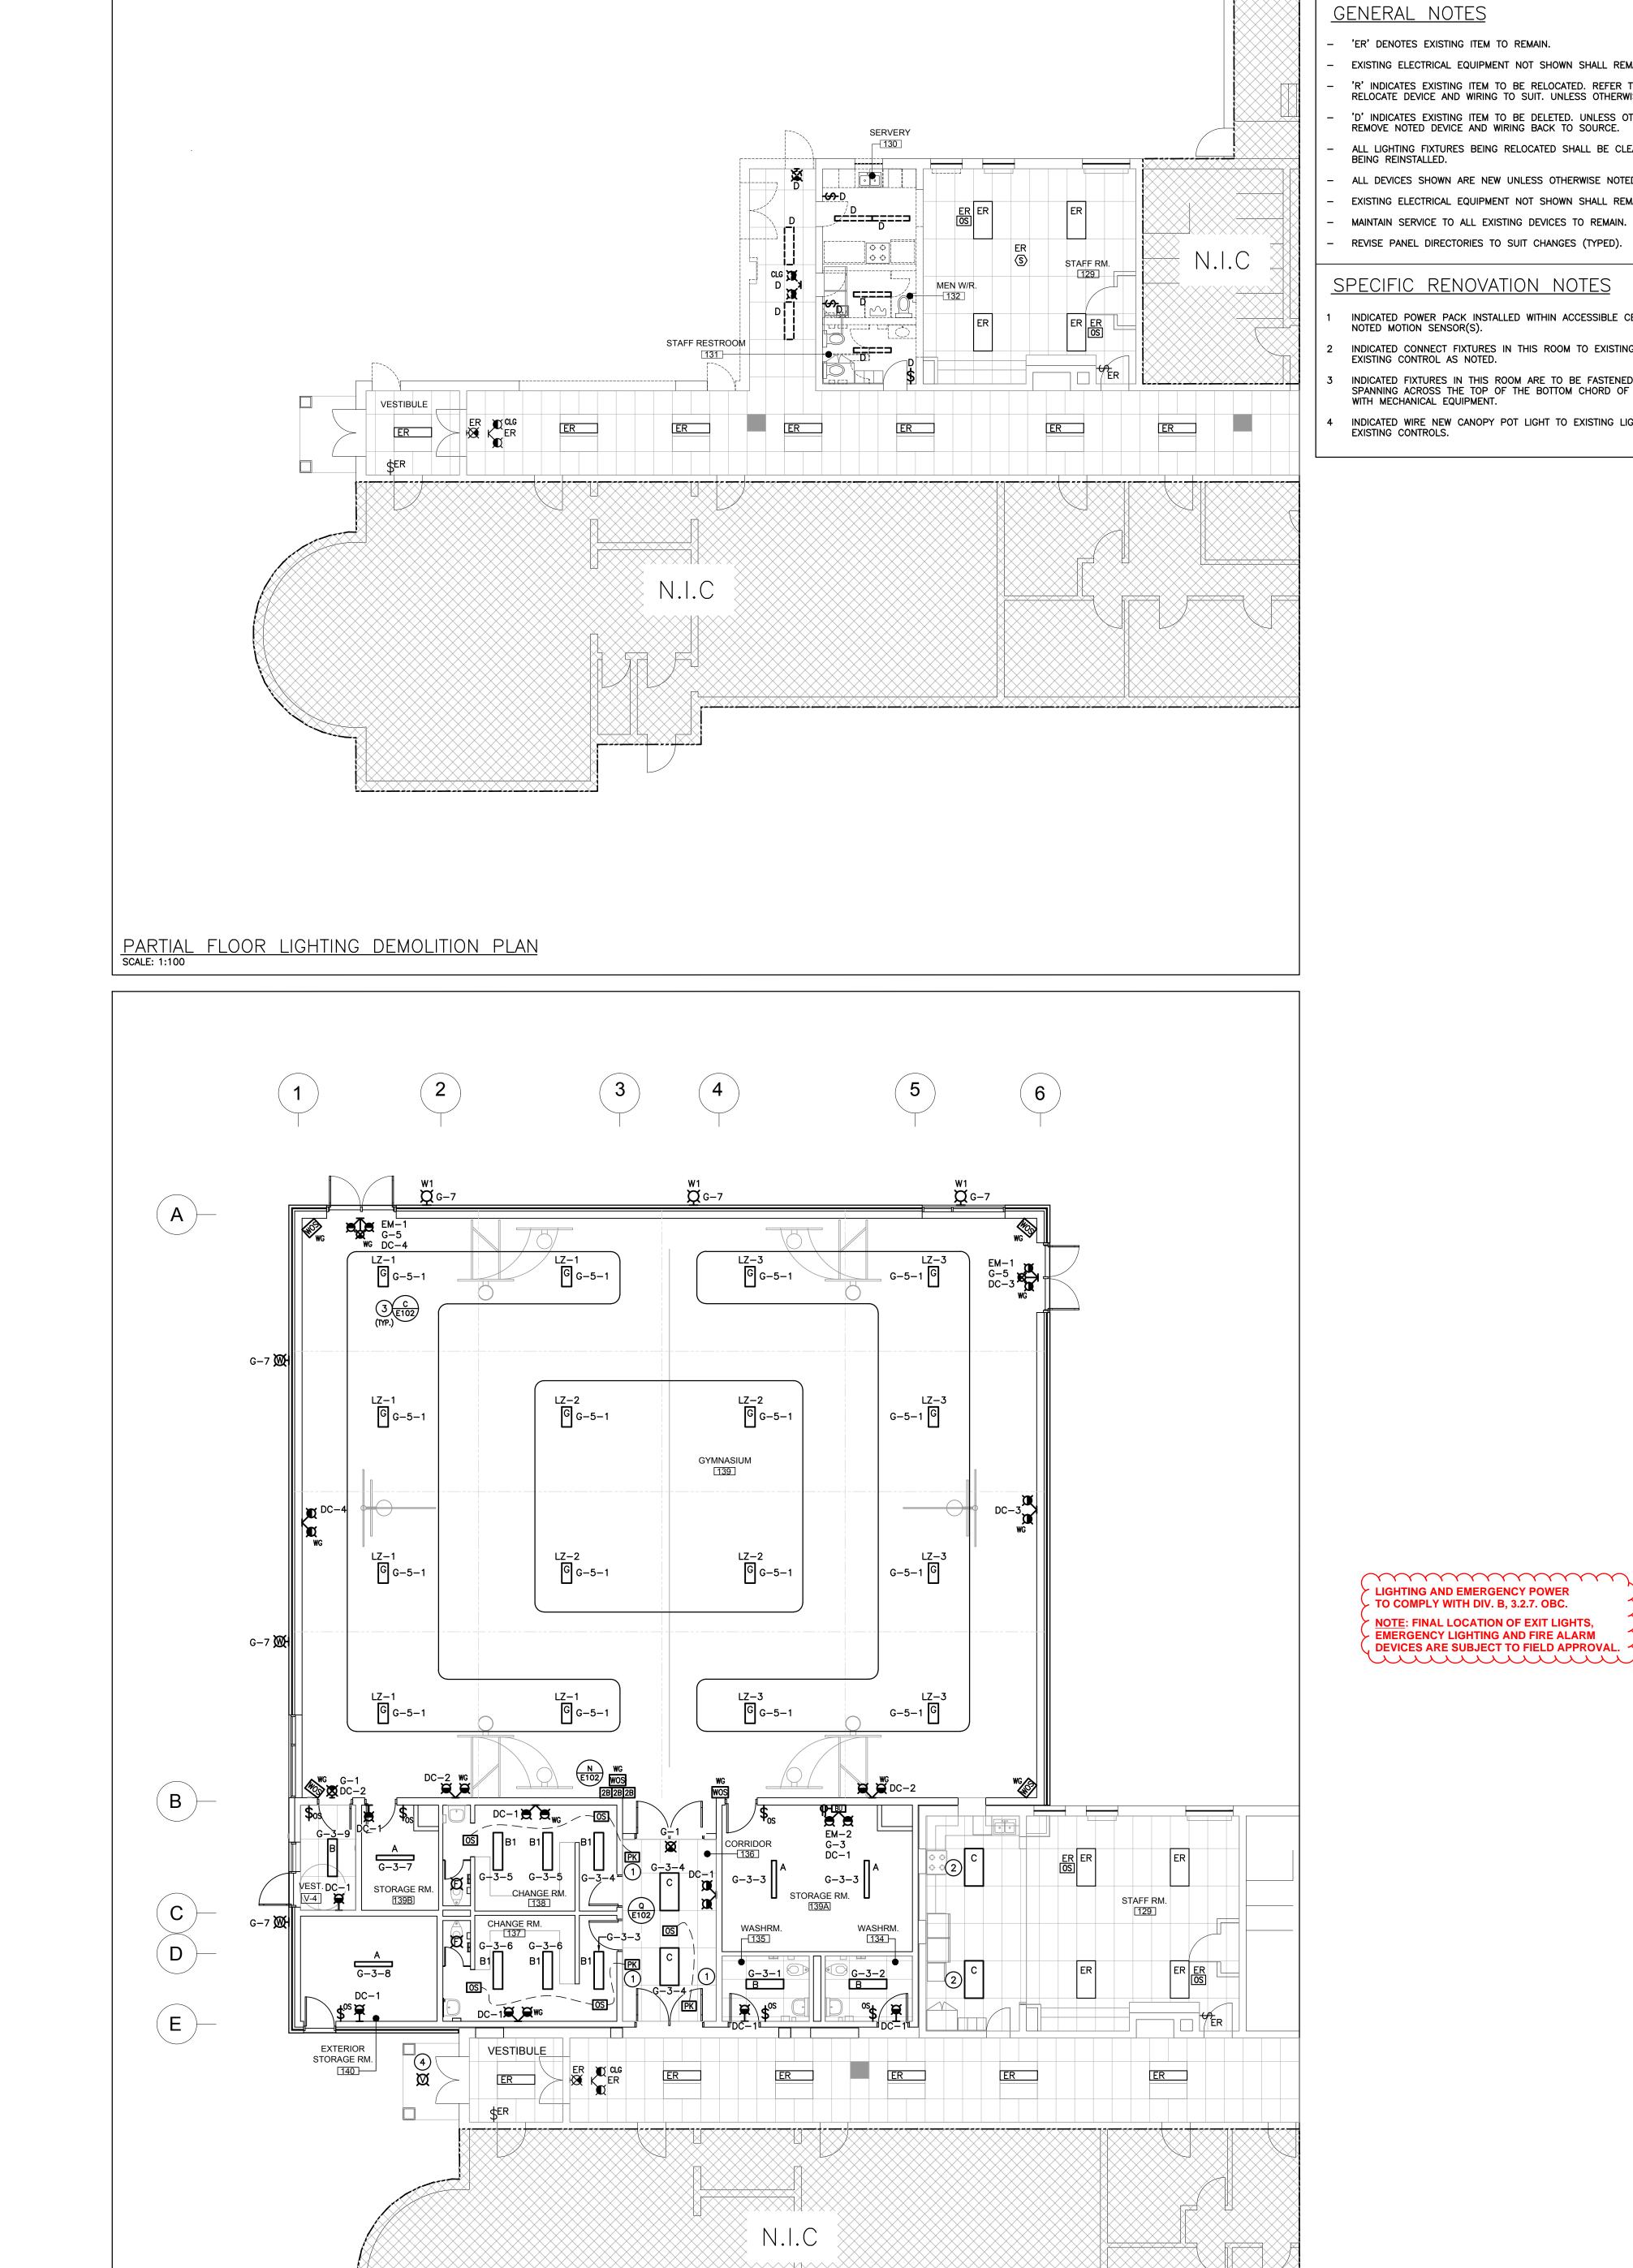

PARTIAL FLOOR RENOVATION LIGHTING PLAN SCALE: 1:100

COB - Building Department Page 3 of 7

GENERAL NOTES

'ER' DENOTES EXISTING ITEM TO REMAIN.

- EXISTING ELECTRICAL EQUIPMENT NOT SHOWN SHALL REMAIN UNLESS NOTED OTHERWISE. 'R' INDICATES EXISTING ITEM TO BE RELOCATED. REFER TO RENOVATION DRAWINGS AND RELOCATE DEVICE AND WIRING TO SUIT. UNLESS OTHERWISE NOTED.
- 'D' INDICATES EXISTING ITEM TO BE DELETED. UNLESS OTHERWISE NOTED DISCONNECT AND REMOVE NOTED DEVICE AND WIRING BACK TO SOURCE. ALL LIGHTING FIXTURES BEING RELOCATED SHALL BE CLEANED AND CHECKED PRIOR TO BEING REINSTALLED.
- ALL DEVICES SHOWN ARE NEW UNLESS OTHERWISE NOTED. EXISTING ELECTRICAL EQUIPMENT NOT SHOWN SHALL REMAIN UNLESS OTHERWISE NOTED.
- MAINTAIN SERVICE TO ALL EXISTING DEVICES TO REMAIN. REVISE PANEL DIRECTORIES TO SUIT CHANGES (TYPED).

## SPECIFIC RENOVATION NOTES

LIGHTING AND EMERGENCY POWER TO COMPLY WITH DIV. B, 3.2.7. OBC.

NOTE: FINAL LOCATION OF EXIT LIGHTS,
EMERGENCY LIGHTING AND FIRE ALARM
DEVICES ARE SUBJECT TO FIELD APPROVAL.

- INDICATED POWER PACK INSTALLED WITHIN ACCESSIBLE CEILING SPACE FOR CONTROL OF NOTED MOTION SENSOR(S).
- INDICATED CONNECT FIXTURES IN THIS ROOM TO EXISTING LOCAL LIGHTING CIRCUIT AND EXISTING CONTROL AS NOTED.
- INDICATED FIXTURES IN THIS ROOM ARE TO BE FASTENED TO UNISTRUT CHANNELS SPANNING ACROSS THE TOP OF THE BOTTOM CHORD OF JOISTS. COORDINATE LOCATION WITH MECHANICAL EQUIPMENT. INDICATED WIRE NEW CANOPY POT LIGHT TO EXISTING LIGHTING CIRCUIT. CONTROL VIA EXISTING CONTROLS.

2050 Guelph Line, Burlington, ON. L7P 5A8

Glenview Public School Gym Addition

143 Townsend Ave., Burlington, ON. L7T 1Z1

Architects



**Snyder Architects Inc.** 

100 Broadview Ave, Suite 301,

Toronto, ON M4M 3H3

t. 416.966.5444, w. snyderarchitects.ca

The contractor shall verify all dimensions and report all errors and discrepancies to the
Consultant before commencement of the work.
The drawings show general arrangement of
services. Follow as closely as actual building
construction will permit. Obtain approval for
relocation of service from Consultant before
commencement of the work.
The drawings do not indicate all offsets fitting
and accessories which may be required. Provide
the same to meet the required conditions the same to meet the required conditions. the same to meet the required conditions.

Drawings and specifications, etc., prepared and issued by the consultant are the property of the consultant and must be returned at the completion of the project. These documents are not to be duplicated or copied without the consent of the Consultant.


Do not scale this drawing.

© 2024 DEI Consulting Engineers Inc.

ALL CONSTRUCTION TO MEET ONTARIO BUILDING CODE REQUIREMENTS RECEIVED


MAY 03 2024 CITY OF BURLINGTON BUILDING DEPARTMENT

Date

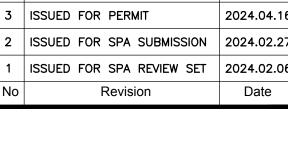



PARTIAL FLOOR PLAN LIGHTING DEMOLITION AND RENOVATION

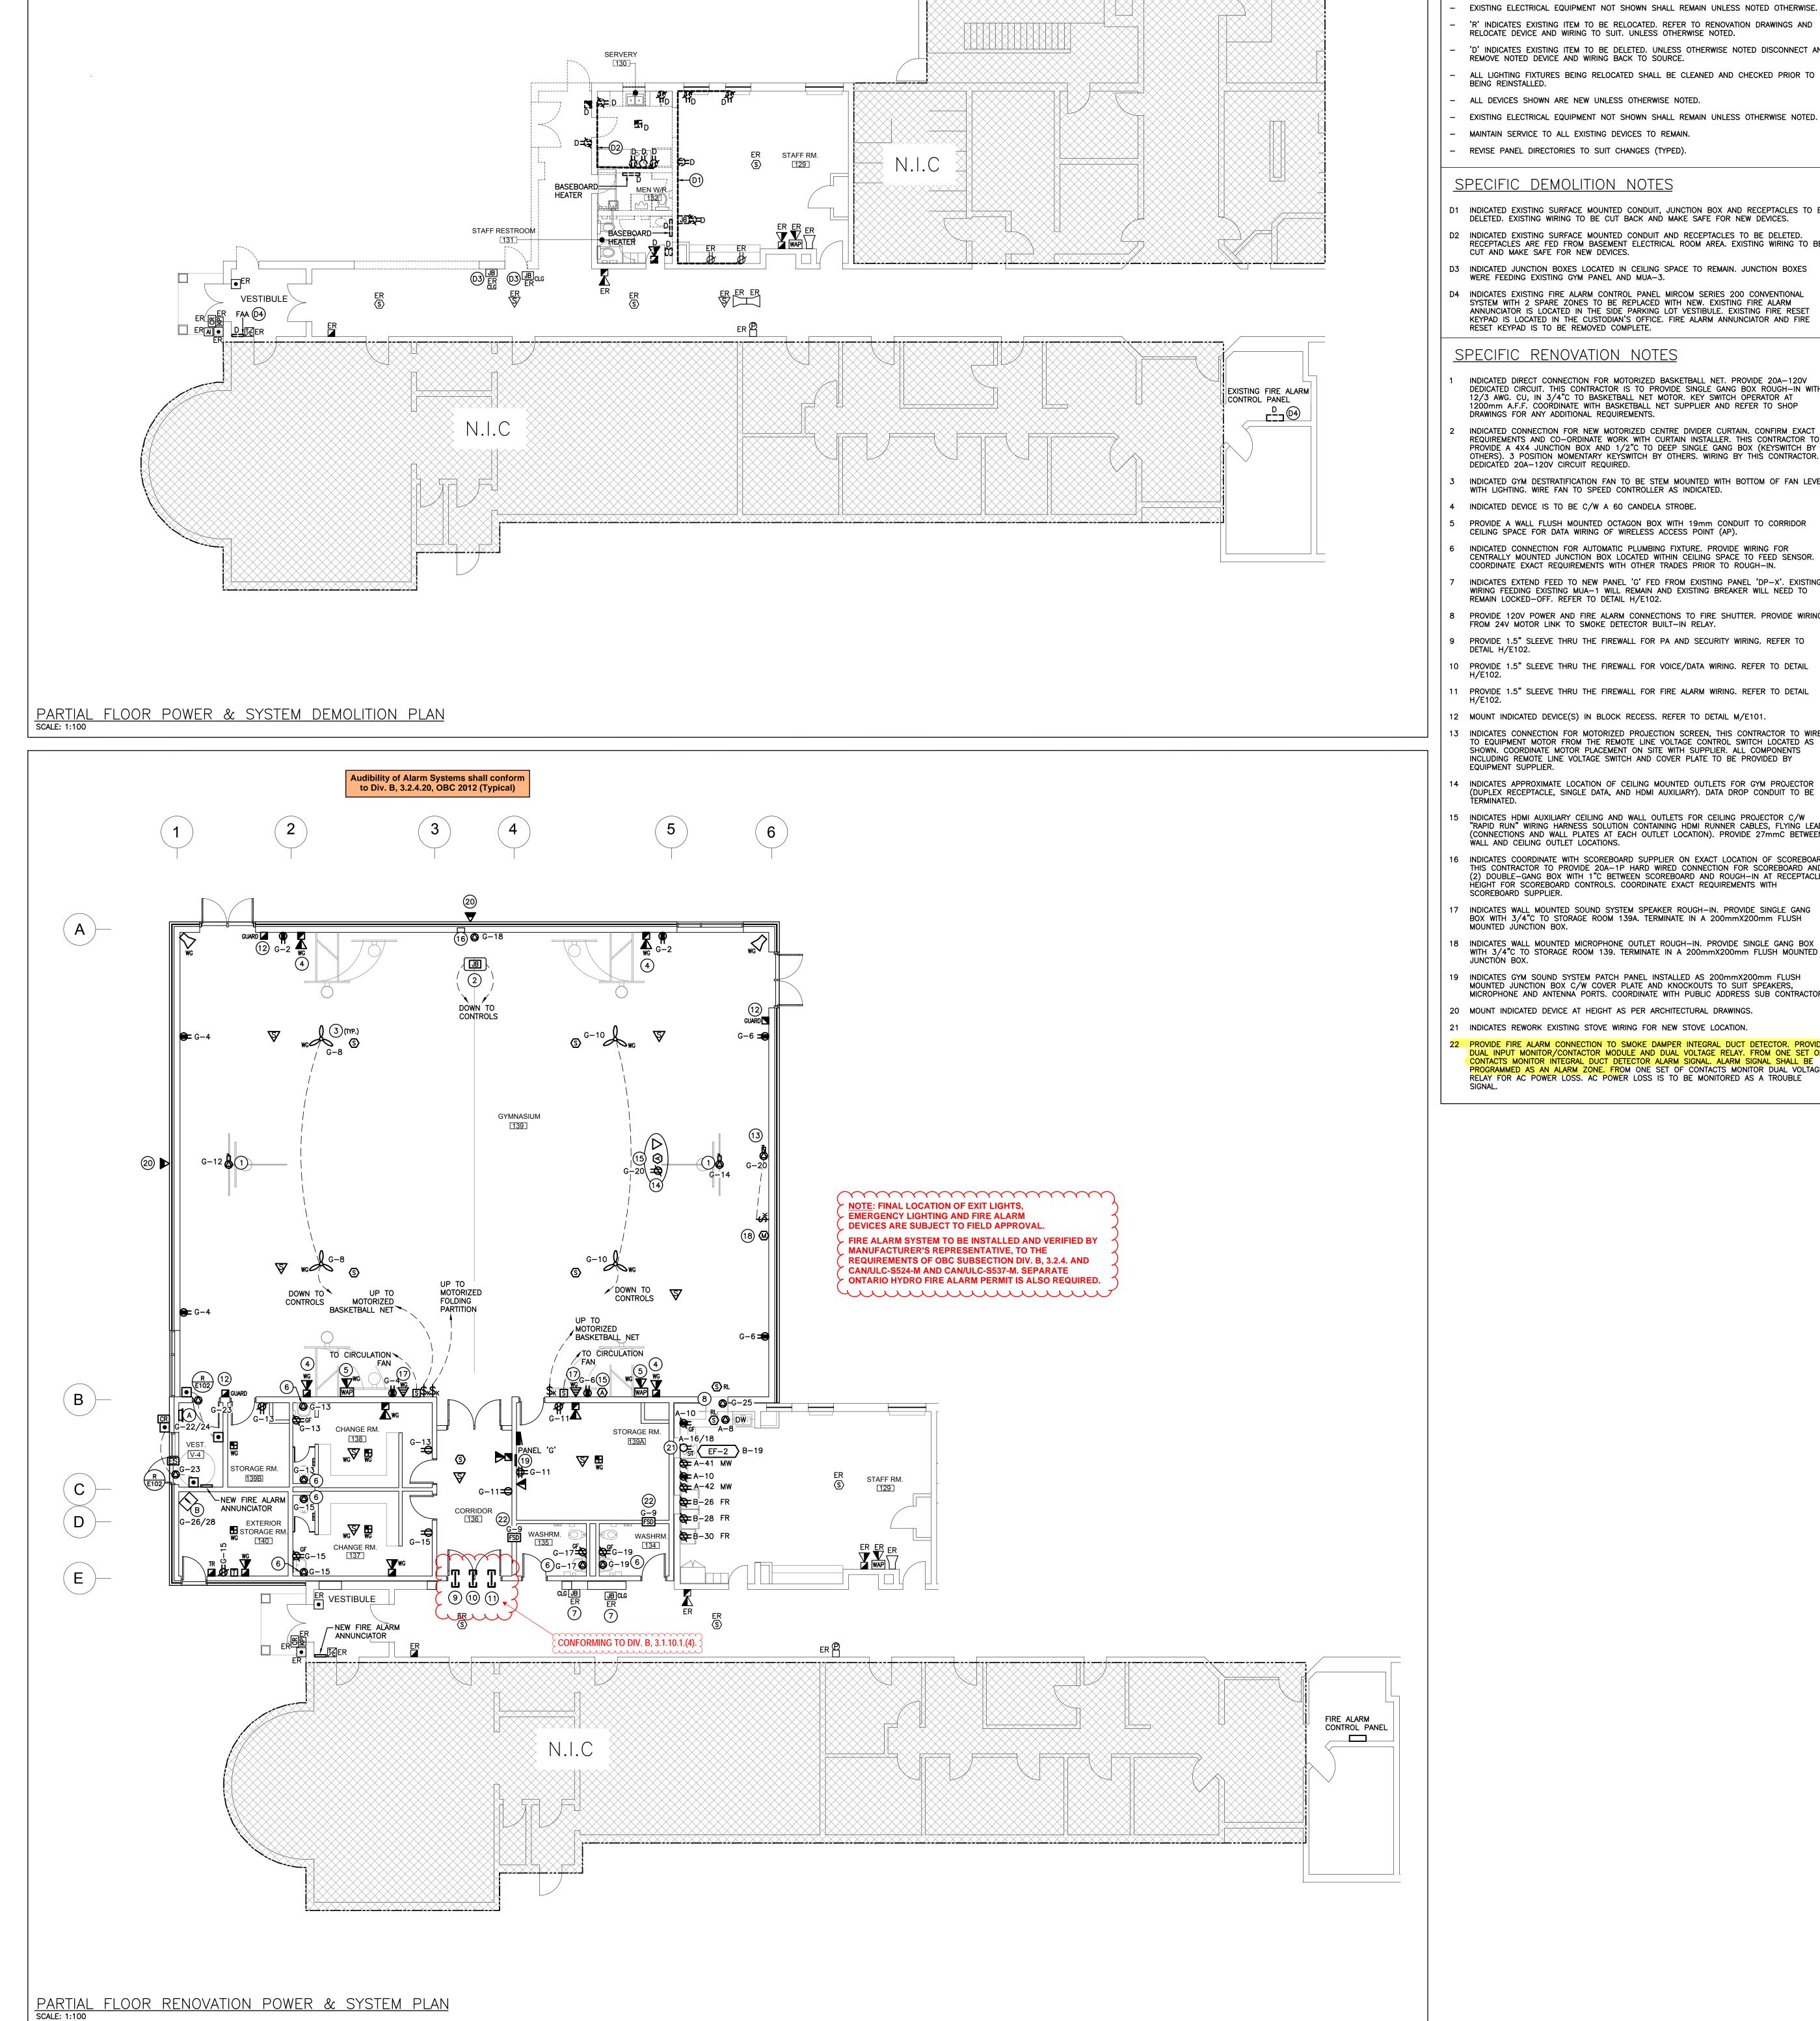

COB - Building Department

**GENERAL NOTES** 

'ER' DENOTES EXISTING ITEM TO REMAIN.

- EXISTING ELECTRICAL EQUIPMENT NOT SHOWN SHALL REMAIN UNLESS NOTED OTHERWISE. 'R' INDICATES EXISTING ITEM TO BE RELOCATED. REFER TO RENOVATION DRAWINGS AND RELOCATE DEVICE AND WIRING TO SUIT. UNLESS OTHERWISE NOTED.
- 'D' INDICATES EXISTING ITEM TO BE DELETED. UNLESS OTHERWISE NOTED DISCONNECT AND REMOVE NOTED DEVICE AND WIRING BACK TO SOURCE. ALL LIGHTING FIXTURES BEING RELOCATED SHALL BE CLEANED AND CHECKED PRIOR TO BEING REINSTALLED.
- ALL DEVICES SHOWN ARE NEW UNLESS OTHERWISE NOTED. EXISTING ELECTRICAL EQUIPMENT NOT SHOWN SHALL REMAIN UNLESS OTHERWISE NOTED.
- MAINTAIN SERVICE TO ALL EXISTING DEVICES TO REMAIN. REVISE PANEL DIRECTORIES TO SUIT CHANGES (TYPED).

## SPECIFIC DEMOLITION NOTES

- D1 INDICATED EXISTING SURFACE MOUNTED CONDUIT, JUNCTION BOX AND RECEPTACLES TO BE DELETED. EXISTING WIRING TO BE CUT BACK AND MAKE SAFE FOR NEW DEVICES.
- D2 INDICATED EXISTING SURFACE MOUNTED CONDUIT AND RECEPTACLES TO BE DELETED. RECEPTACLES ARE FED FROM BASEMENT ELECTRICAL ROOM AREA. EXISTING WIRING TO BE CUT AND MAKE SAFE FOR NEW DEVICES.
- D3 INDICATED JUNCTION BOXES LOCATED IN CEILING SPACE TO REMAIN. JUNCTION BOXES WERE FEEDING EXISTING GYM PANEL AND MUA-3.
- D4 INDICATES EXISTING FIRE ALARM CONTROL PANEL MIRCOM SERIES 200 CONVENTIONAL SYSTEM WITH 2 SPARE ZONES TO BE REPLACED WITH NEW. EXISTING FIRE ALARM ANNUNCIATOR IS LOCATED IN THE SIDE PARKING LOT VESTIBULE. EXISTING FIRE RESET KEYPAD IS LOCATED IN THE CUSTODIAN'S OFFICE. FIRE ALARM ANNUNCIATOR AND FIRE

## SPECIFIC RENOVATION NOTES

- INDICATED DIRECT CONNECTION FOR MOTORIZED BASKETBALL NET. PROVIDE 20A-120V DEDICATED CIRCUIT. THIS CONTRACTOR IS TO PROVIDE SINGLE GANG BOX ROUGH-IN WITH 12/3 AWG. CU, IN 3/4"C TO BASKETBALL NET MOTOR. KEY SWITCH OPERATOR AT 1200mm A.F.F. COORDINATE WITH BASKETBALL NET SUPPLIER AND REFER TO SHOP DRAWINGS FOR ANY ADDITIONAL REQUIREMENTS.
- INDICATED CONNECTION FOR NEW MOTORIZED CENTRE DIVIDER CURTAIN. CONFIRM EXACT REQUIREMENTS AND CO-ORDINATE WORK WITH CURTAIN INSTALLER. THIS CONTRACTOR TO PROVIDE A 4X4 JUNCTION BOX AND 1/2"C TO DEEP SINGLE GANG BOX (KEYSWITCH BY OTHERS). 3 POSITION MOMENTARY KEYSWITCH BY OTHERS. WIRING BY THIS CONTRACTOR.
- DEDICATED 20A-120V CIRCUIT REQUIRED. INDICATED GYM DESTRATIFICATION FAN TO BE STEM MOUNTED WITH BOTTOM OF FAN LEVEL WITH LIGHTING. WIRE FAN TO SPEED CONTROLLER AS INDICATED.
- INDICATED DEVICE IS TO BE C/W A 60 CANDELA STROBE.
- PROVIDE A WALL FLUSH MOUNTED OCTAGON BOX WITH 19mm CONDUIT TO CORRIDOR CEILING SPACE FOR DATA WIRING OF WIRELESS ACCESS POINT (AP).
- INDICATED CONNECTION FOR AUTOMATIC PLUMBING FIXTURE. PROVIDE WIRING FOR CENTRALLY MOUNTED JUNCTION BOX LOCATED WITHIN CEILING SPACE TO FEED SENSOR. COORDINATE EXACT REQUIREMENTS WITH OTHER TRADES PRIOR TO ROUGH—IN.
- INDICATES EXTEND FEED TO NEW PANEL 'G' FED FROM EXISTING PANEL 'DP-X'. EXISTING WIRING FEEDING EXISTING MUA-1 WILL REMAIN AND EXISTING BREAKER WILL NEED TO REMAIN LOCKED-OFF. REFER TO DETAIL H/E102. PROVIDE 120V POWER AND FIRE ALARM CONNECTIONS TO FIRE SHUTTER. PROVIDE WIRING FROM 24V MOTOR LINK TO SMOKE DETECTOR BUILT-IN RELAY.
- PROVIDE 1.5" SLEEVE THRU THE FIREWALL FOR PA AND SECURITY WIRING. REFER TO
- 10 PROVIDE 1.5" SLEEVE THRU THE FIREWALL FOR VOICE/DATA WIRING. REFER TO DETAIL H/E102.
- 11 PROVIDE 1.5" SLEEVE THRU THE FIREWALL FOR FIRE ALARM WIRING. REFER TO DETAIL H/E102. 12 MOUNT INDICATED DEVICE(S) IN BLOCK RECESS. REFER TO DETAIL M/E101. INDICATES CONNECTION FOR MOTORIZED PROJECTION SCREEN, THIS CONTRACTOR TO WIRE
- 14 INDICATES APPROXIMATE LOCATION OF CEILING MOUNTED OUTLETS FOR GYM PROJECTOR (DUPLEX RECEPTACLE, SINGLE DATA, AND HDMI AUXILIARY). DATA DROP CONDUIT TO BE
- 15 INDICATES HDMI AUXILIARY CEILING AND WALL OUTLETS FOR CEILING PROJECTOR C/W "RAPID RUN" WIRING HARNESS SOLUTION CONTAINING HDMI RUNNER CABLES, FLYING LEADS (CONNECTIONS AND WALL PLATES AT EACH OUTLET LOCATION). PROVIDE 27mmC BETWEEN WALL AND CEILING OUTLET LOCATIONS.
- 16 INDICATES COORDINATE WITH SCOREBOARD SUPPLIER ON EXACT LOCATION OF SCOREBOARD. THIS CONTRACTOR TO PROVIDE 20A-1P HARD WIRED CONNECTION FOR SCOREBOARD AND (2) DOUBLE-GANG BOX WITH 1"C BETWEEN SCOREBOARD AND ROUGH-IN AT RECEPTACLE HEIGHT FOR SCOREBOARD CONTROLS. COORDINATE EXACT REQUIREMENTS WITH
- 7 INDICATES WALL MOUNTED SOUND SYSTEM SPEAKER ROUGH—IN. PROVIDE SINGLE GANG BOX WITH 3/4"C TO STORAGE ROOM 139A. TERMINATE IN A 200mmX200mm FLUSH MOUNTED JUNCTION BOX.
- 18 INDICATES WALL MOUNTED MICROPHONE OUTLET ROUGH-IN. PROVIDE SINGLE GANG BOX WITH 3/4"C TO STORAGE ROOM 139. TERMINATE IN A 200mmX200mm FLUSH MOUNTED
- 19 INDICATES GYM SOUND SYSTEM PATCH PANEL INSTALLED AS 200mmX200mm FLUSH MOUNTED JUNCTION BOX C/W COVER PLATE AND KNOCKOUTS TO SUIT SPEAKERS, MICROPHONE AND ANTENNA PORTS. COORDINATE WITH PUBLIC ADDRESS SUB CONTRACTOR.
- 20 MOUNT INDICATED DEVICE AT HEIGHT AS PER ARCHITECTURAL DRAWINGS. 21 INDICATES REWORK EXISTING STOVE WIRING FOR NEW STOVE LOCATION.
- 22 PROVIDE FIRE ALARM CONNECTION TO SMOKE DAMPER INTEGRAL DUCT DETECTOR. PROVIDE DUAL INPUT MONITOR/CONTACTOR MODULE AND DUAL VOLTAGE RELAY. FROM ONE SET OF CONTACTS MONITOR INTEGRAL DUCT DETECTOR ALARM SIGNAL. ALARM SIGNAL SHALL BE PROGRAMMED AS AN ALARM ZONE. FROM ONE SET OF CONTACTS MONITOR DUAL VOLTAGE RELAY FOR AC POWER LOSS. AC POWER LOSS IS TO BE MONITORED AS A TROUBLE



2050 Guelph Line, Burlington, ON.

Glenview Public School

Gym Addition

Burlington, ON. L7T 1Z1 Architects

143 Townsend Ave.,

**Snyder Architects Inc.** 100 Broadview Ave, Suite 301, Toronto, ON M4M 3H3 t. 416.966.5444, w. snyderarchitects.ca




The contractor shall verify all dimensions and report all errors and discrepancies to the Consultant before commencement of the work. The drawings show general arrangement of services. Follow as closely as actual building construction will permit. Obtain approval for relocation of service from Consultant before commencement of the work. The drawings do not indicate all offsets fitting and accessories which may be required. Provide the same to meet the required conditions. Drawings and specifications, etc., prepared and issued by the consultant are the property of the consultant and must be returned at the completion of the project. These documents are not to be duplicated or copied without the consent of the Consultant.

Do not scale this drawing. © 2024 DEI Consulting Engineers Inc.


**ALL CONSTRUCTION TO** CODE REQUIREMENTS

RECEIVED MAY 03 2024 CITY OF BURLINGTON BUILDING DEPARTMENT

(			
Pro	oject North	True North	
No.	Revisions	Date	
7	ISSUED FOR DEPART	2024.04.16	
2	ISSUED FOR PERMIT ISSUED FOR SPA SUBMISSION	2024.04.16	
1	ISSUED FOR SPA REVIEW SET	2024.02.27	
No	Revision	Date	

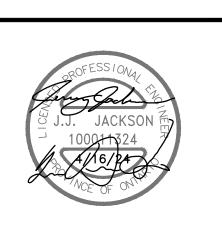

PARTIAL FLOOR PLAN POWER DEMOLITION AND RENOVATION

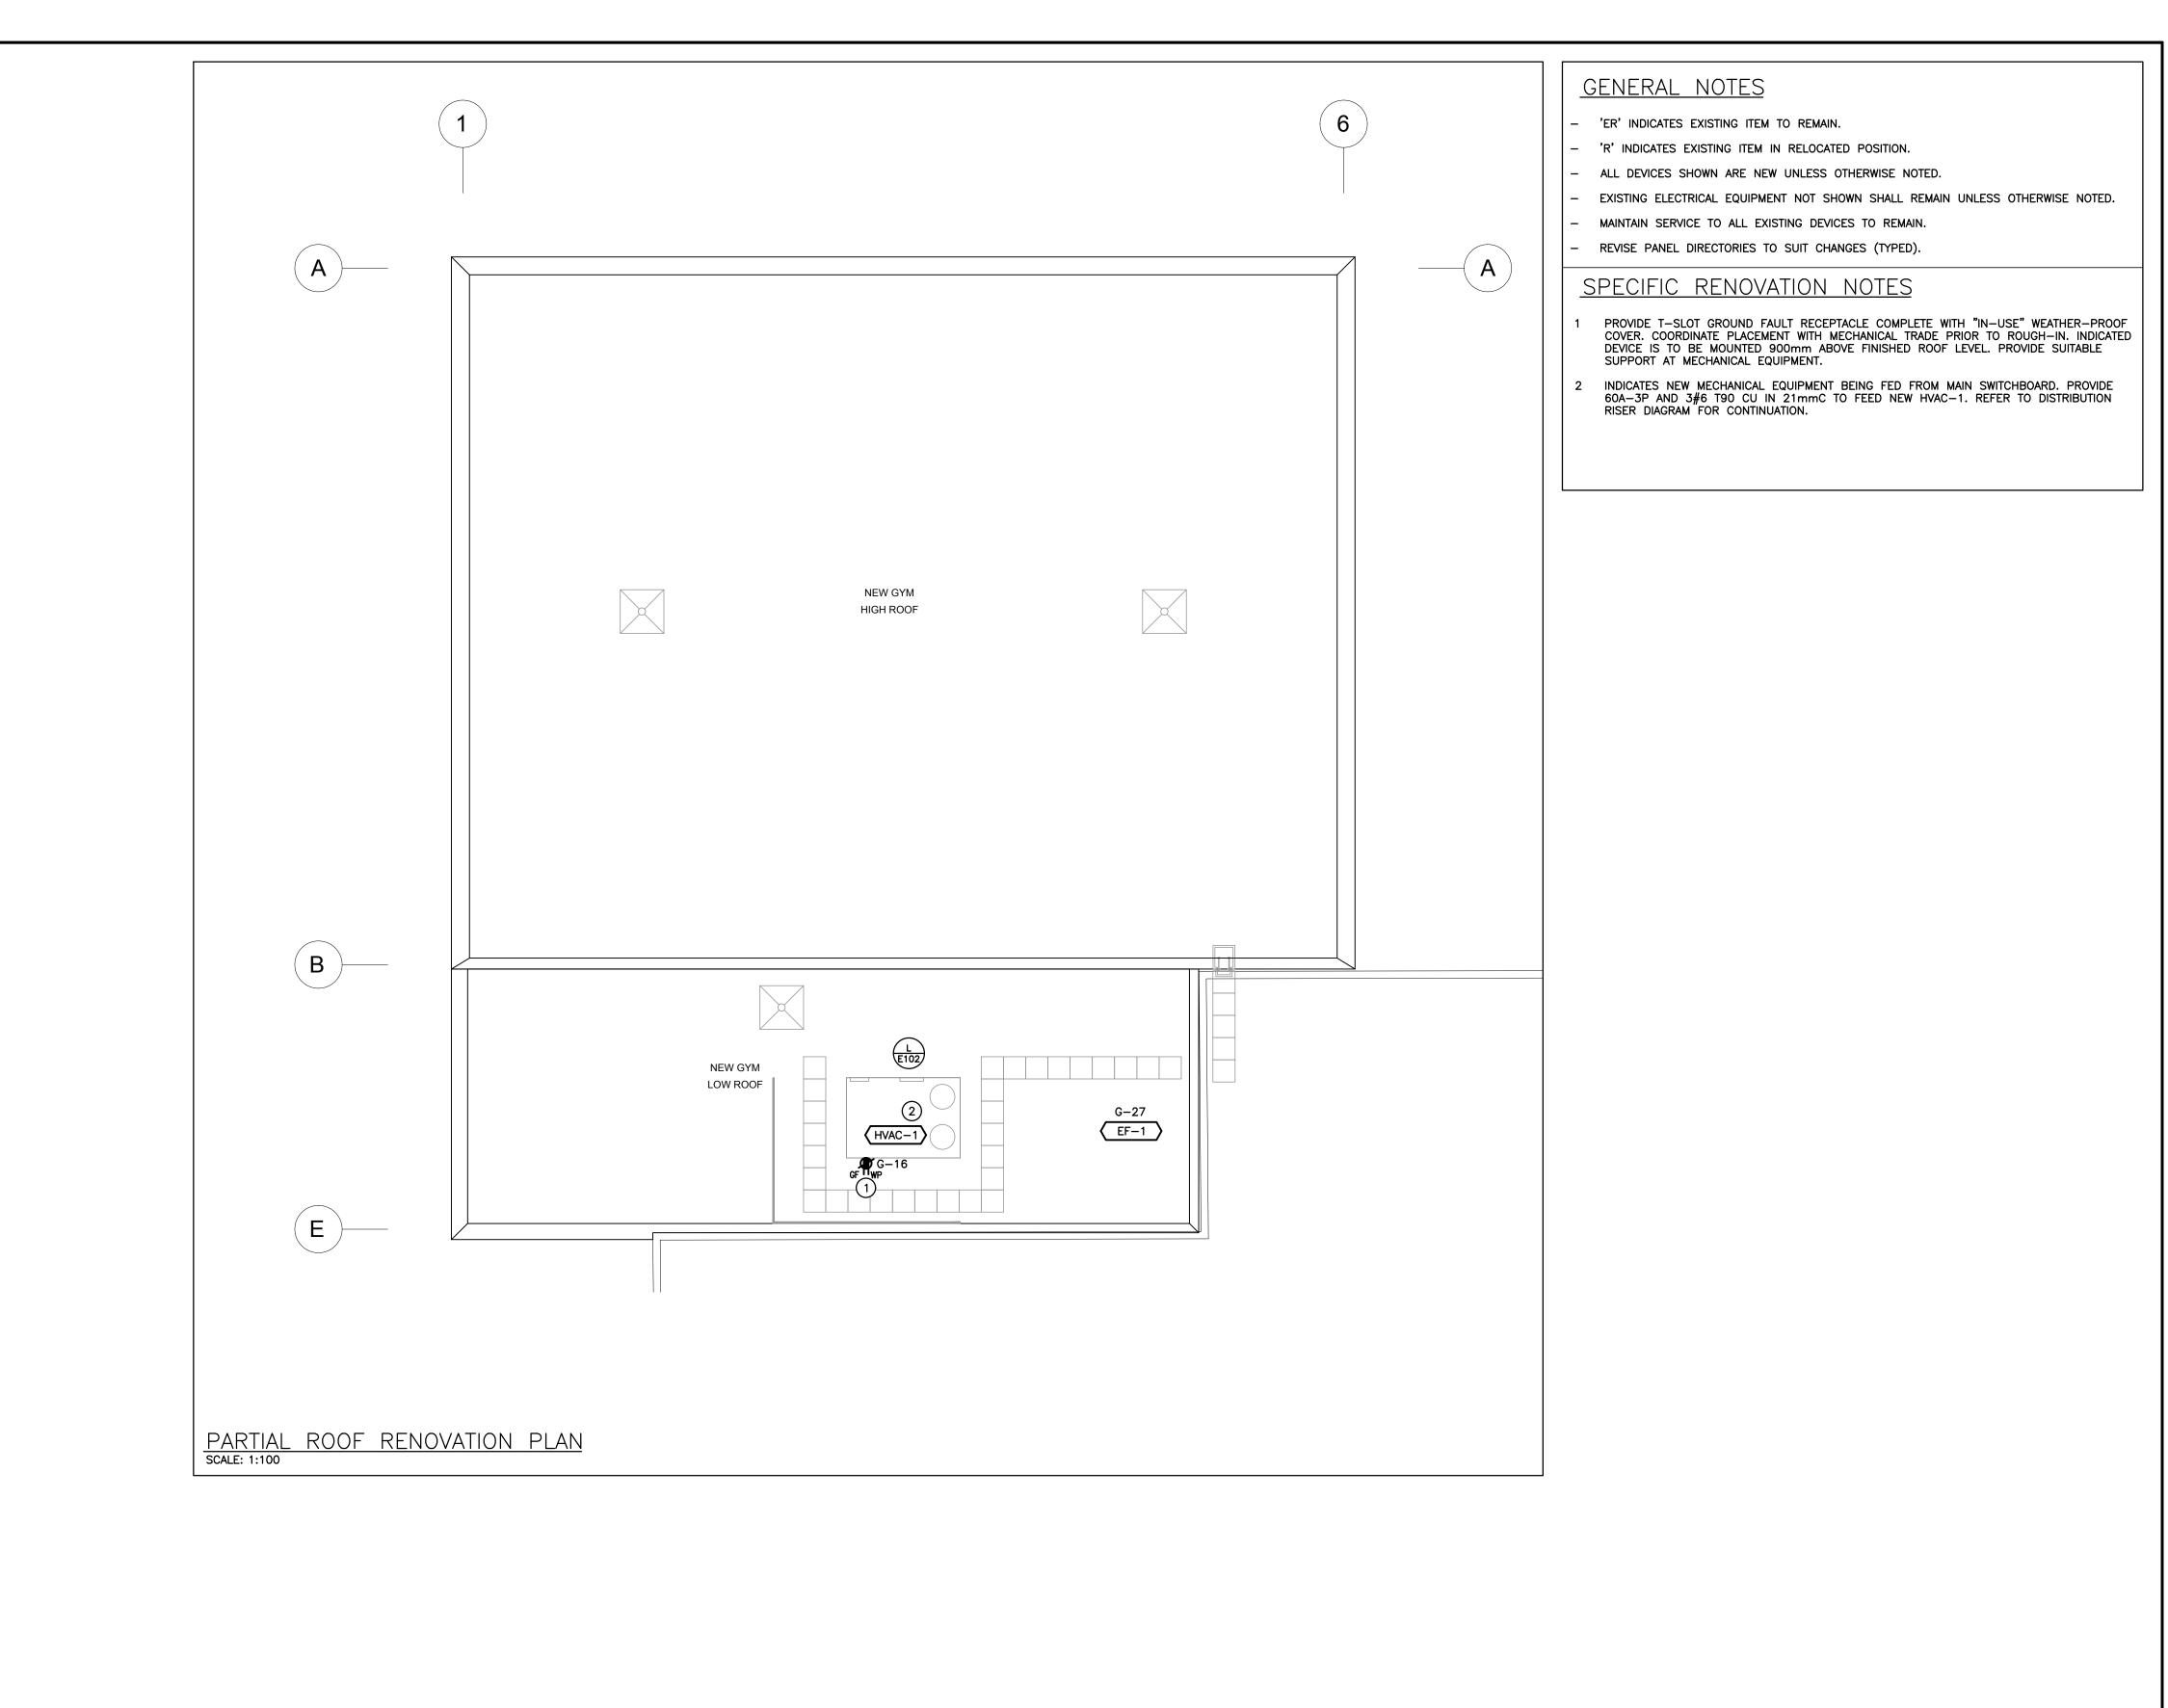

COB - Building Department Page 5 of 7



2050 Guelph Line, Burlington, ON. L7P 5A8

Glenview Public School

Gym Addition

Architects

143 Townsend Ave.,

Sn/der
Snyder Architects Inc.
100 Broadview Ave, Suite 301,
Toronto, ON M4M 3H3
t. 416.966.5444, w. snyderarchitects.ca



The contractor shall verify all dimensions and report all errors and discrepancies to the Consultant before commencement of the work. The drawings show general arrangement of services. Follow as closely as actual building construction will permit. Obtain approval for relocation of service from Consultant before commencement of the work.

The drawings do not indicate all offsets fitting and accessories which may be required. Provide the same to meet the required conditions. Drawings and specifications, etc., prepared and issued by the consultant are the property of the consultant and must be returned at the completion of the project. These documents are not to be duplicated or copied without the consent of the Consultant.

Do not scale this drawing.

© 2024 DEI Consulting Engineers Inc.

ALL CONSTRUCTION TO MEET ONTARIO BUILDING CODE REQUIREMENTS

RECEIVED

MAY 03 2024

CITY OF BURLINGTON BUILDING DEPARTMENT

Project North

True North

No. Revisions

Date

3 ISSUED FOR PERMIT
2024.04.16
2 ISSUED FOR SPA SUBMISSION
1 ISSUED FOR SPA REVIEW SET
2024.02.06
No Revision

Date




PARTIAL ROOF
RENOVATION PLAN

Scale: AS NOTED Date: JAN 2024


Drawn by: SB Checked by: RV

Job No. Drawing No.

2314 **E203** 

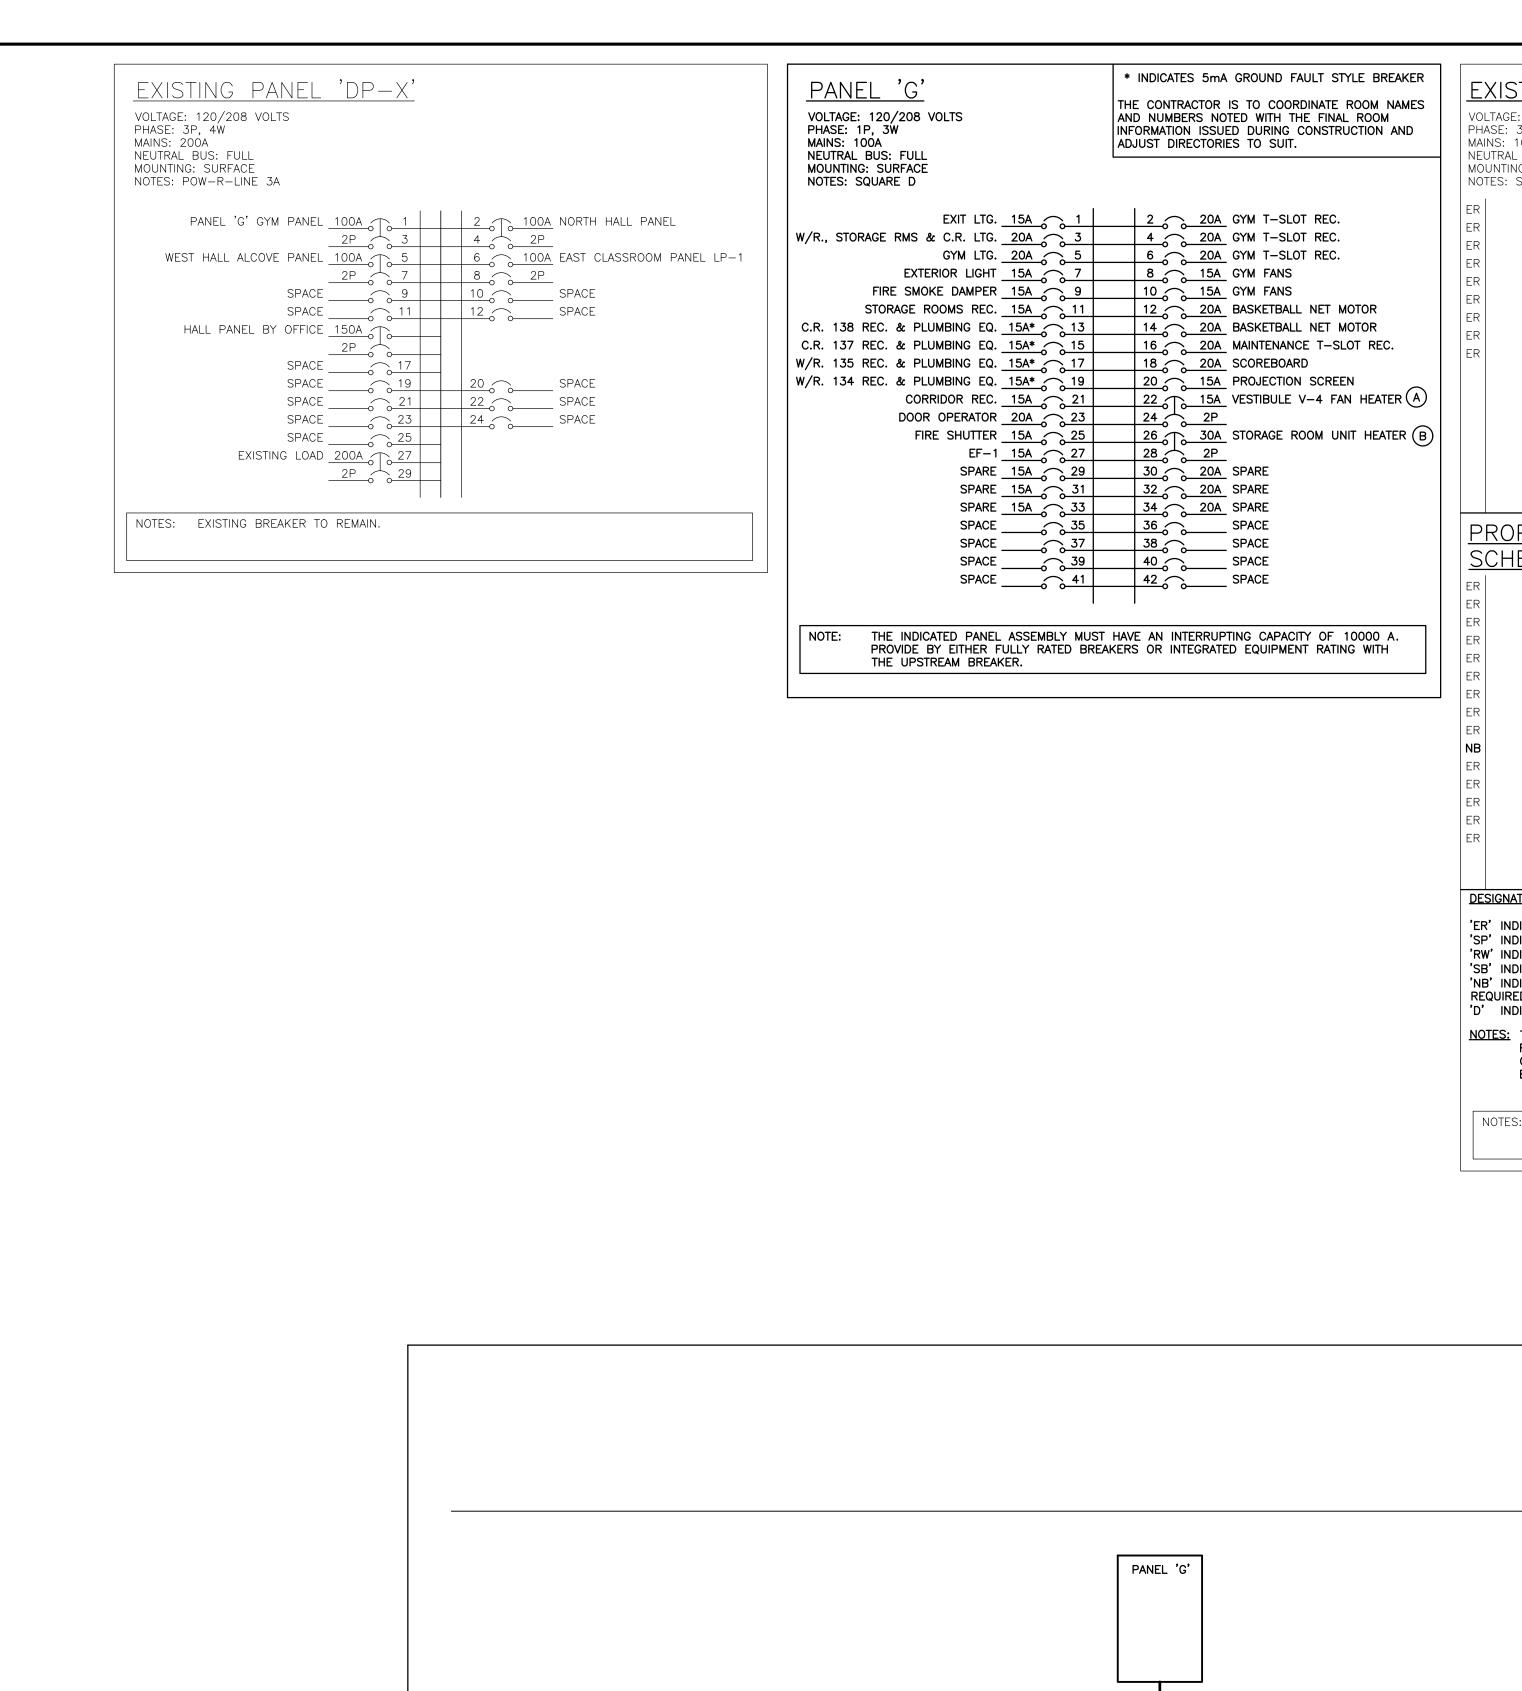


COB - Building Department

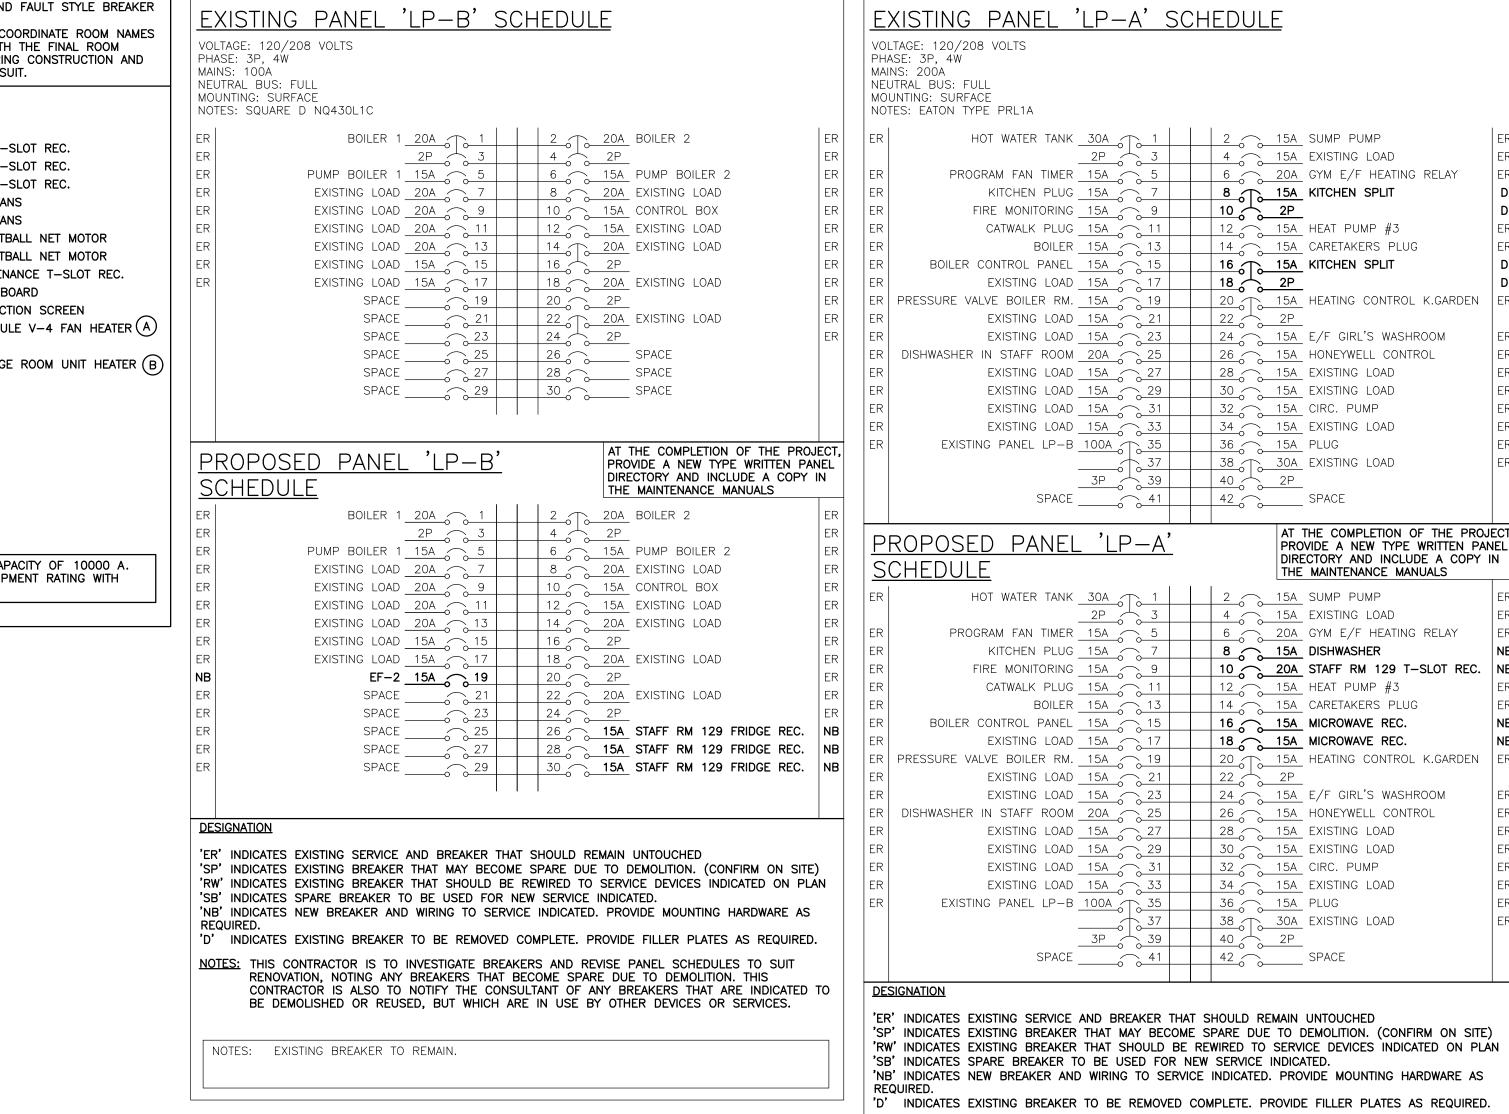

NOTES: THIS CONTRACTOR IS TO INVESTIGATE BREAKERS AND REVISE PANEL SCHEDULES TO SUIT RENOVATION, NOTING ANY BREAKERS THAT BECOME SPARE DUE TO DEMOLITION. THIS

NOTES: EXISTING BREAKER TO REMAIN.

CONTRACTOR IS ALSO TO NOTIFY THE CONSULTANT OF ANY BREAKERS THAT ARE INDICATED TO BE DEMOLISHED OR REUSED, BUT WHICH ARE IN USE BY OTHER DEVICES OR SERVICES.

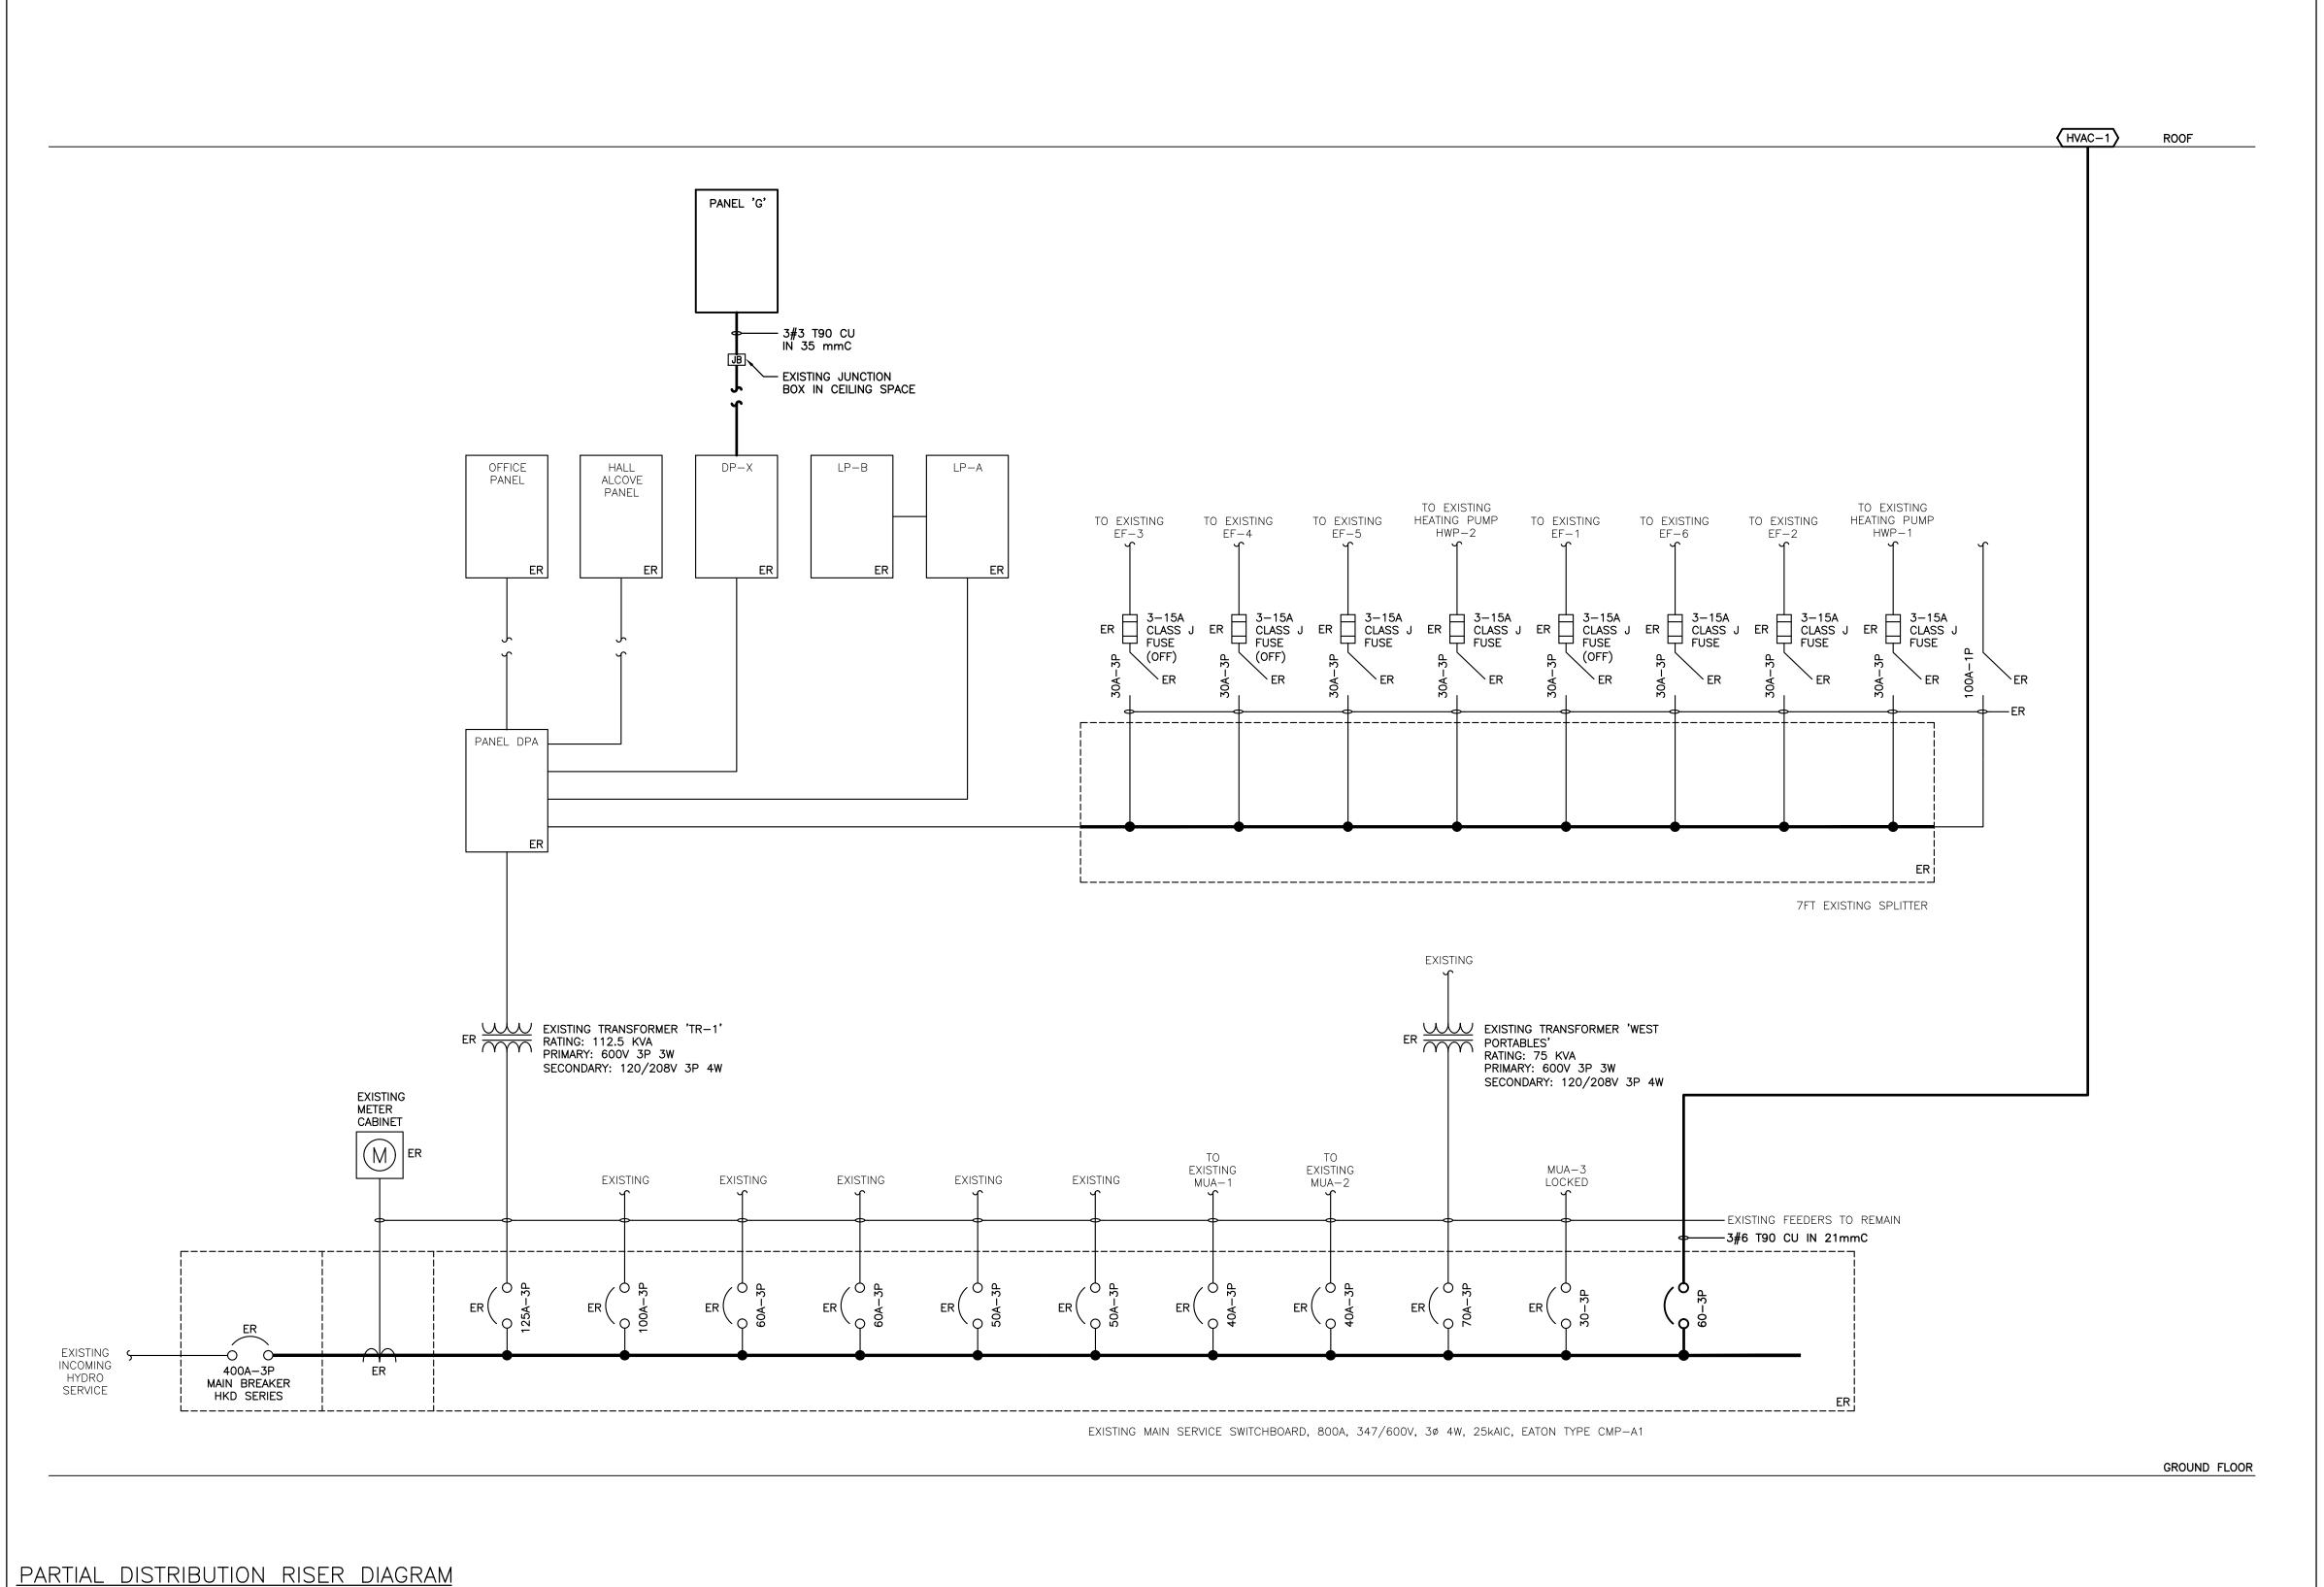



2050 Guelph Line, Burlington, ON. L7P 5A8

Glenview Public School

Gym Addition

143 Townsend Ave.,

Burlington, ON. L7T 1Z1

Architects

SN/CET

Snyder Architects Inc.
100 Broadview Ave, Suite 301,
Toronto, ON M4M 3H3

t. 416.966.5444, w. snyderarchitects.ca

55 Northland Road,
Waterloo, ON, N2V 178
Phone: 519-725-3555
Website: delassociates.ca
Project Number: 24015

Consulting Engineers
MECHANICAL | ELECTRICAL | AQUATIC

The contractor shall verify all dimensions and report all errors and discrepancies to the Consultant before commencement of the work. The drawings show general arrangement of services. Follow as closely as actual building construction will permit. Obtain approval for relocation of service from Consultant before commencement of the work.

The drawings do not indicate all offsets fitting and accessories which may be required. Provide the same to meet the required conditions. Drawings and specifications, etc., prepared and issued by the consultant are the property of the consultant and must be returned at the completion of the project. These documents are not to be duplicated or copied without the consent of the Consultant.

Do not scale this drawing.

© 2024 DEI Consulting Engineers Inc.

ALL CONSTRUCTION TO MEET ONTARIO BUILDING CODE REQUIREMENTS

RECEIVED

MAY 03 2024

CITY OF BURLINGTON BUILDING DEPARTMENT

 $\bigcap^{N}$ 

Project North

No. Revisions


Date

3 ISSUED FOR PERMIT

2 ISSUED FOR SPA SUBMISSION

1 ISSUED FOR SPA REVIEW SET

2024.02.06

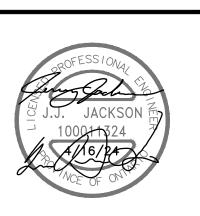

Revision

Drawing Title:

DISTRIBUTION RISER
DIAGRAM AND PANEL
SCHEDULE

Scale: AS NOTED Date: JAN 2024


Drawn by: SB Checked by: RV

Job No. Drawing No.


2314

E301

COB-Building Department

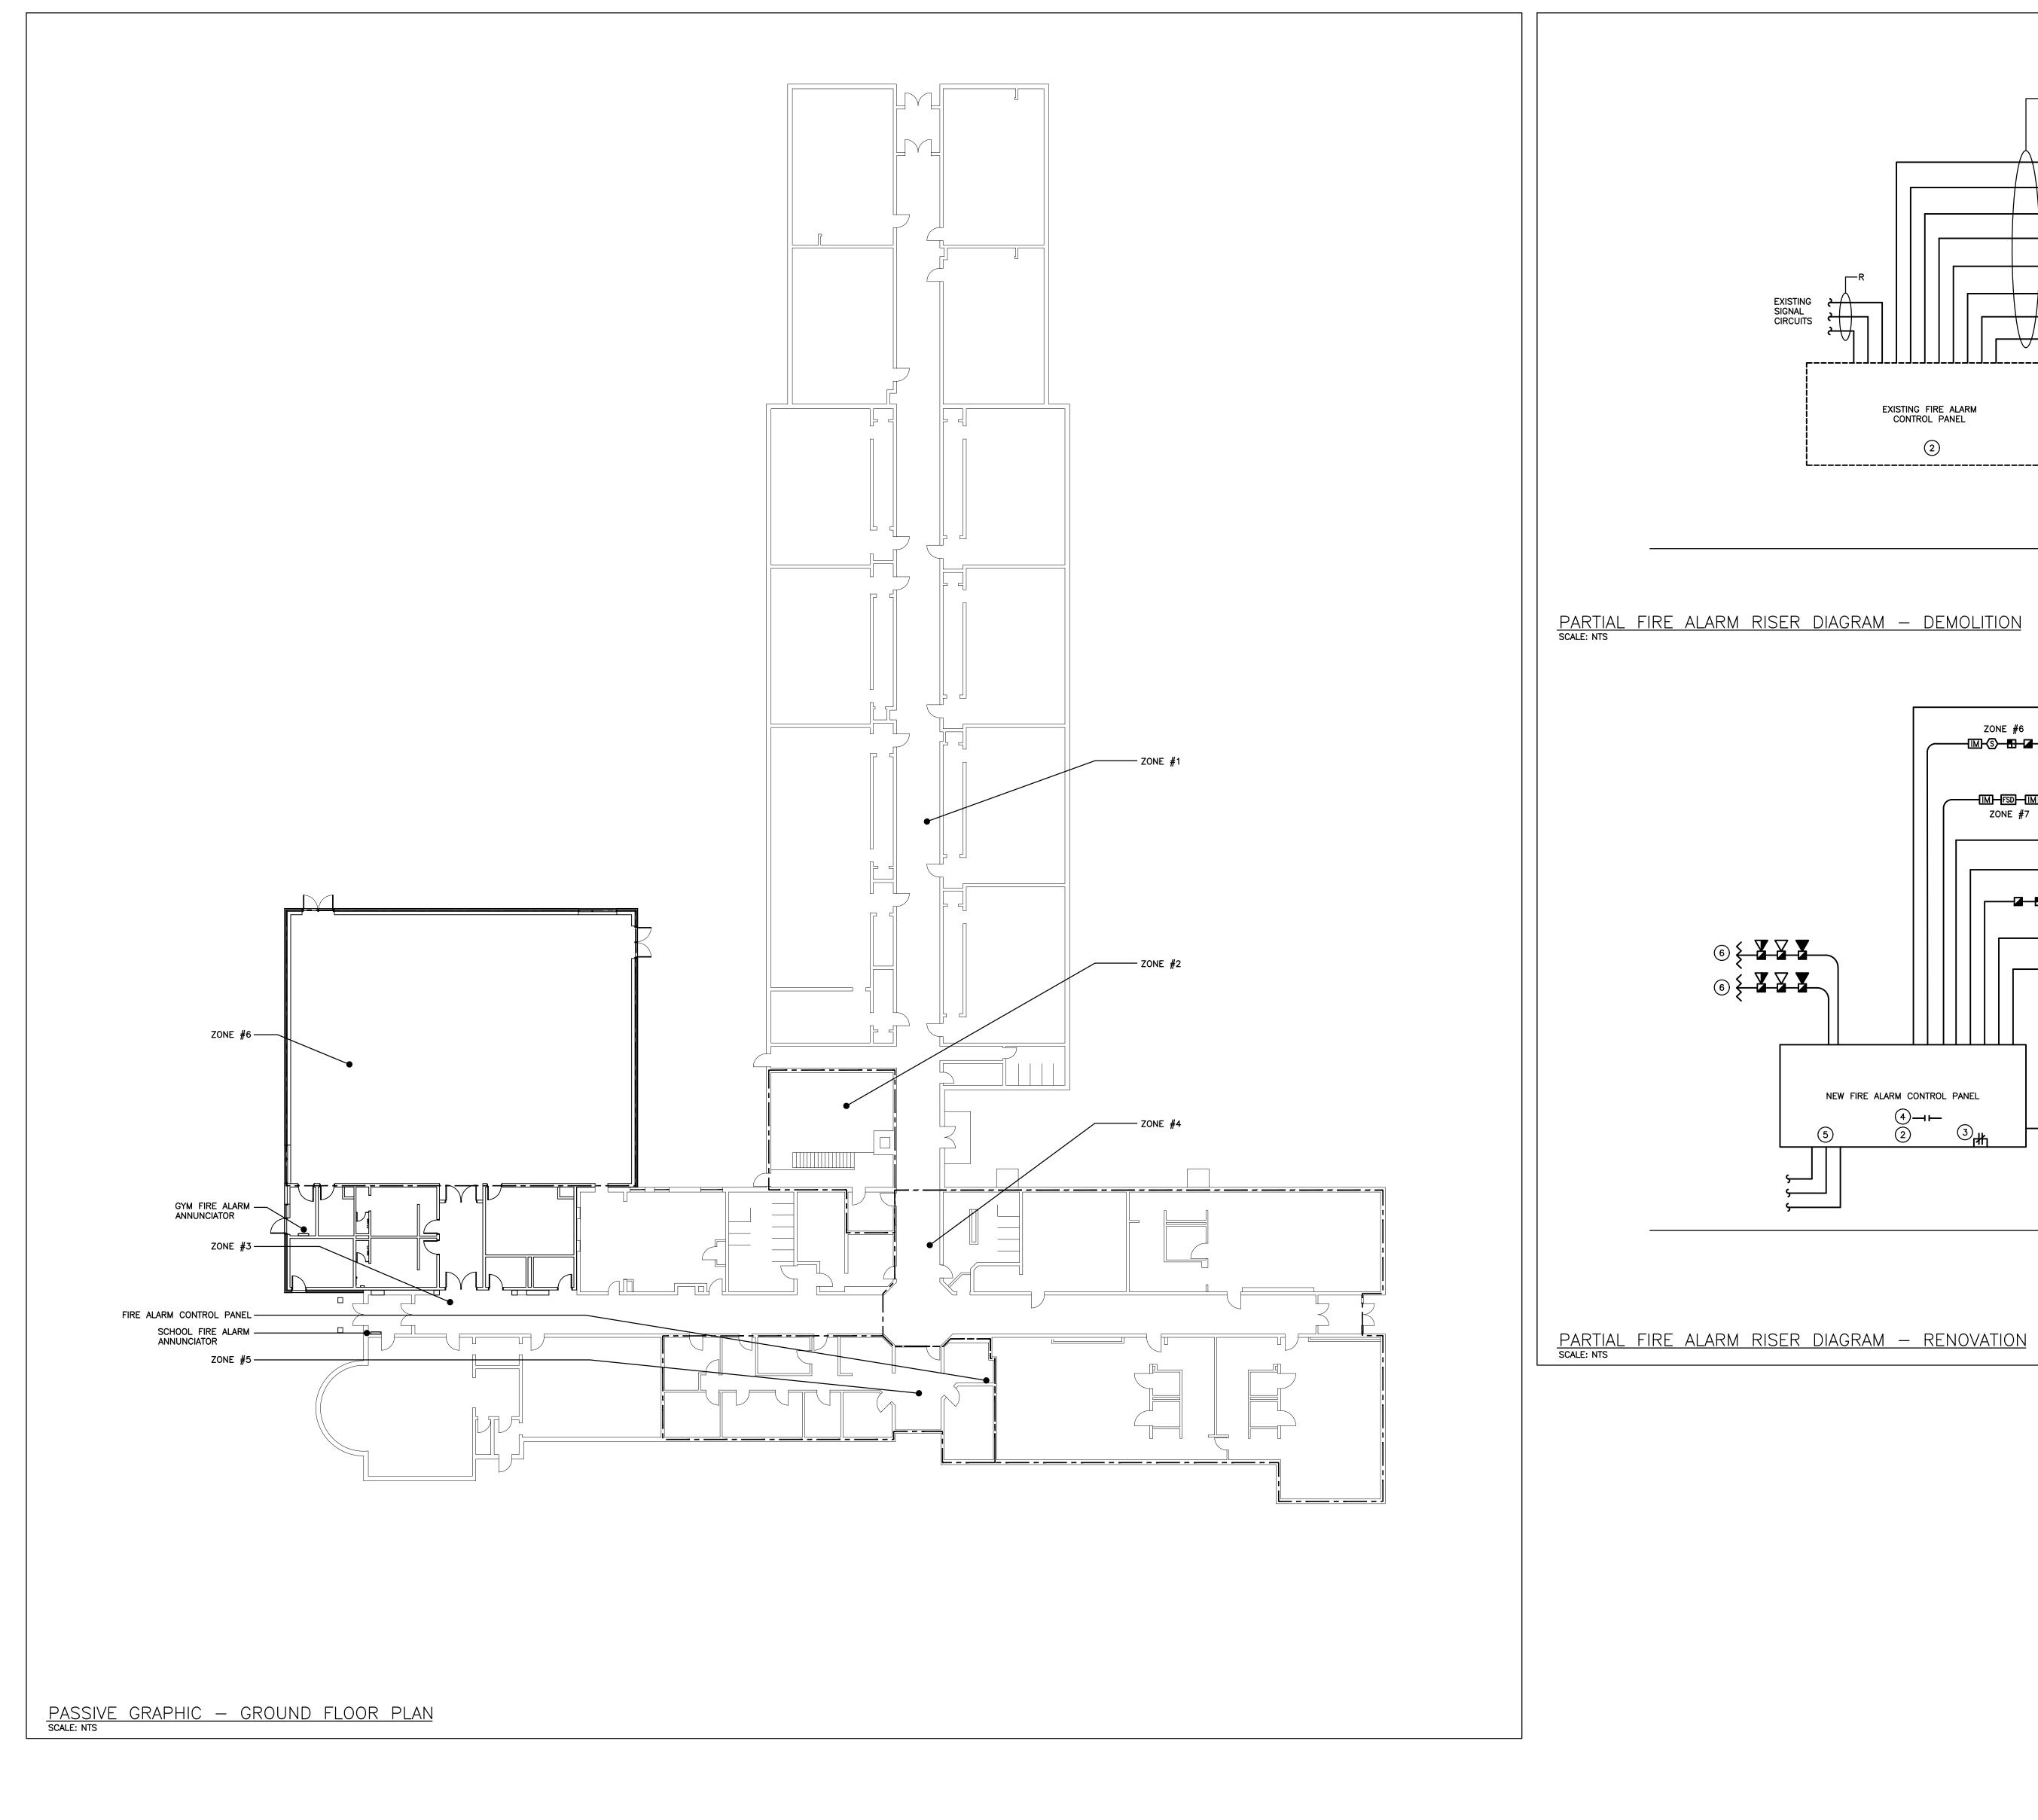

COB - Building Department Page 7 of 7

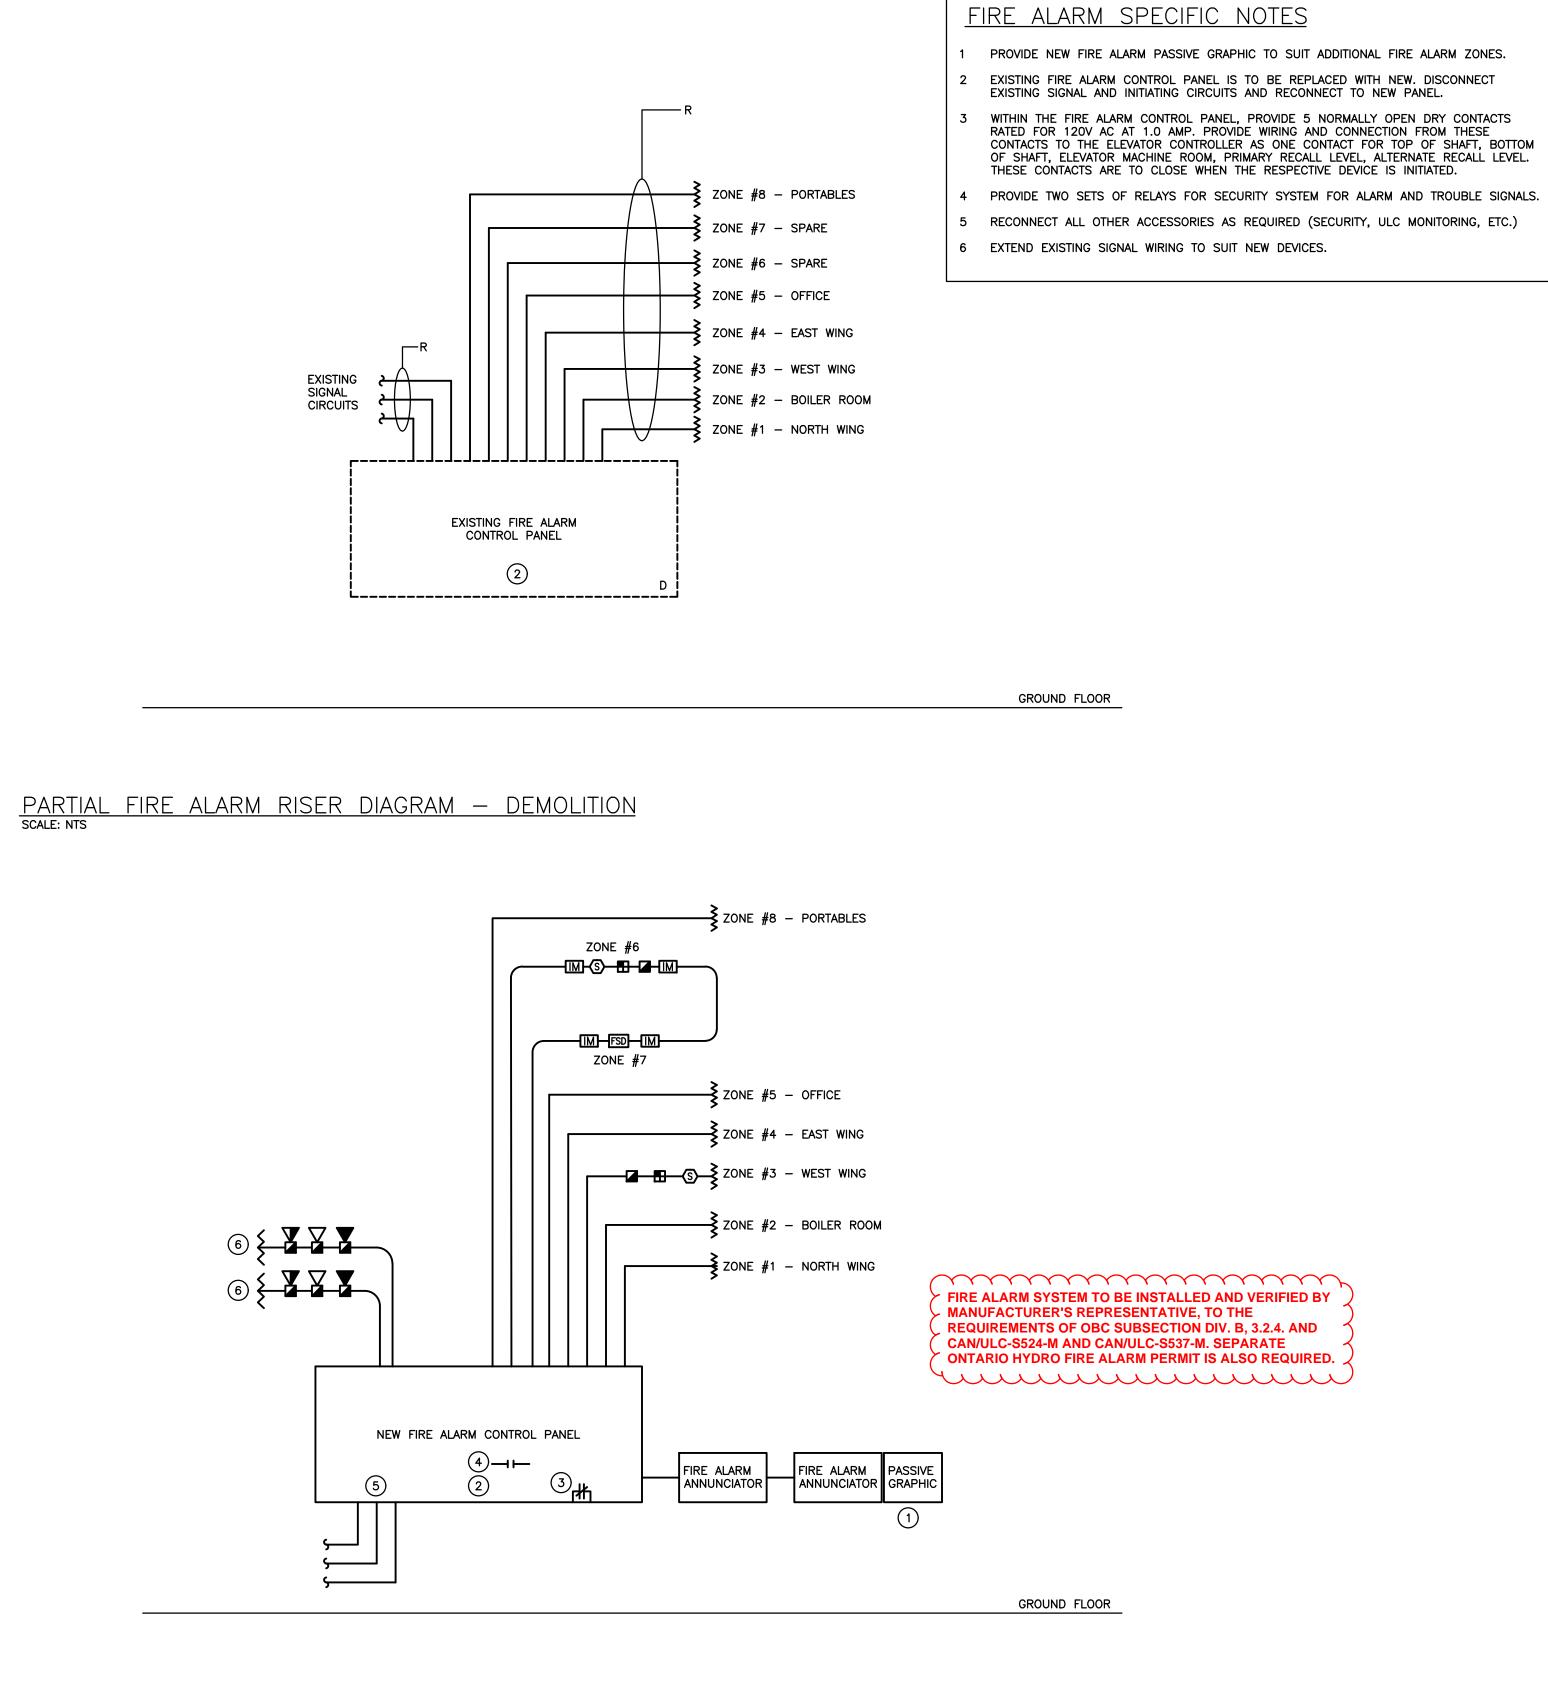

Zone	Description	Alarm	Supervisory
1	NORTH WING	•	
2	BOILER ROOM	•	
3	WEST WING	•	
4	EAST WING	•	
5	OFFICE	•	
6	GYMNASIUM	•	
7	FIRE SMOKE DAMPER	•	
8	PORTABLES	•	
9	SPARE		
10	SPARE		
11	SPARE		
12	SPARE		



2050 Guelph Line,

Glenview Public School

Burlington, ON. L7P 5A8

Gym Addition 143 Townsend Ave., Burlington, ON. L7T 1Z1

Architects Snyder Architects Inc. 100 Broadview Ave, Suite 301, Toronto, ON M4M 3H3



t. 416.966.5444, w. snyderarchitects.ca

The contractor shall verify all dimensions and report all errors and discrepancies to the Consultant before commencement of the work. The drawings show general arrangement of services. Follow as closely as actual building construction will permit. Obtain approval for relocation of service from Consultant before commencement of the work.

The drawings do not indicate all offsets fitting and accessories which may be required. Provide the same to meet the required conditions. Drawings and specifications, etc., prepared and issued by the consultant are the property of the consultant and must be returned at the completion of the project. These documents are not to be duplicated or copied without the consent of the Consultant.

Do not scale this drawing.

© 2024 DEI Consulting Engineers Inc.


ALL CONSTRUCTION TO MEET ONTARIO BUILDING CODE REQUIREMENTS RECEIVED

MAY 03 2024 CITY OF BURLINGTON BUILDING DEPARTMENT

(		(
Pr	oject North	Т
No.	Revisions	

3	ISSUED FOR PERMIT	2024.04.
2	ISSUED FOR SPA SUBMISSION	2024.02.2
1	ISSUED FOR SPA REVIEW SET	2024.02.0

Revision

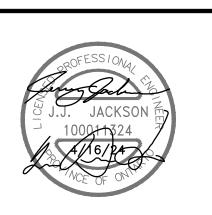

PARTIAL FIRE ALARM RISER DIAGRAM AND PASSIVE GRAPHIC