

BANBURY HEIGHTS SCHOOL CHILD CARE CENTRE ADDITION

141 BANBURY ROAD, BRANTFORD, ONTARIO N3P 1E3

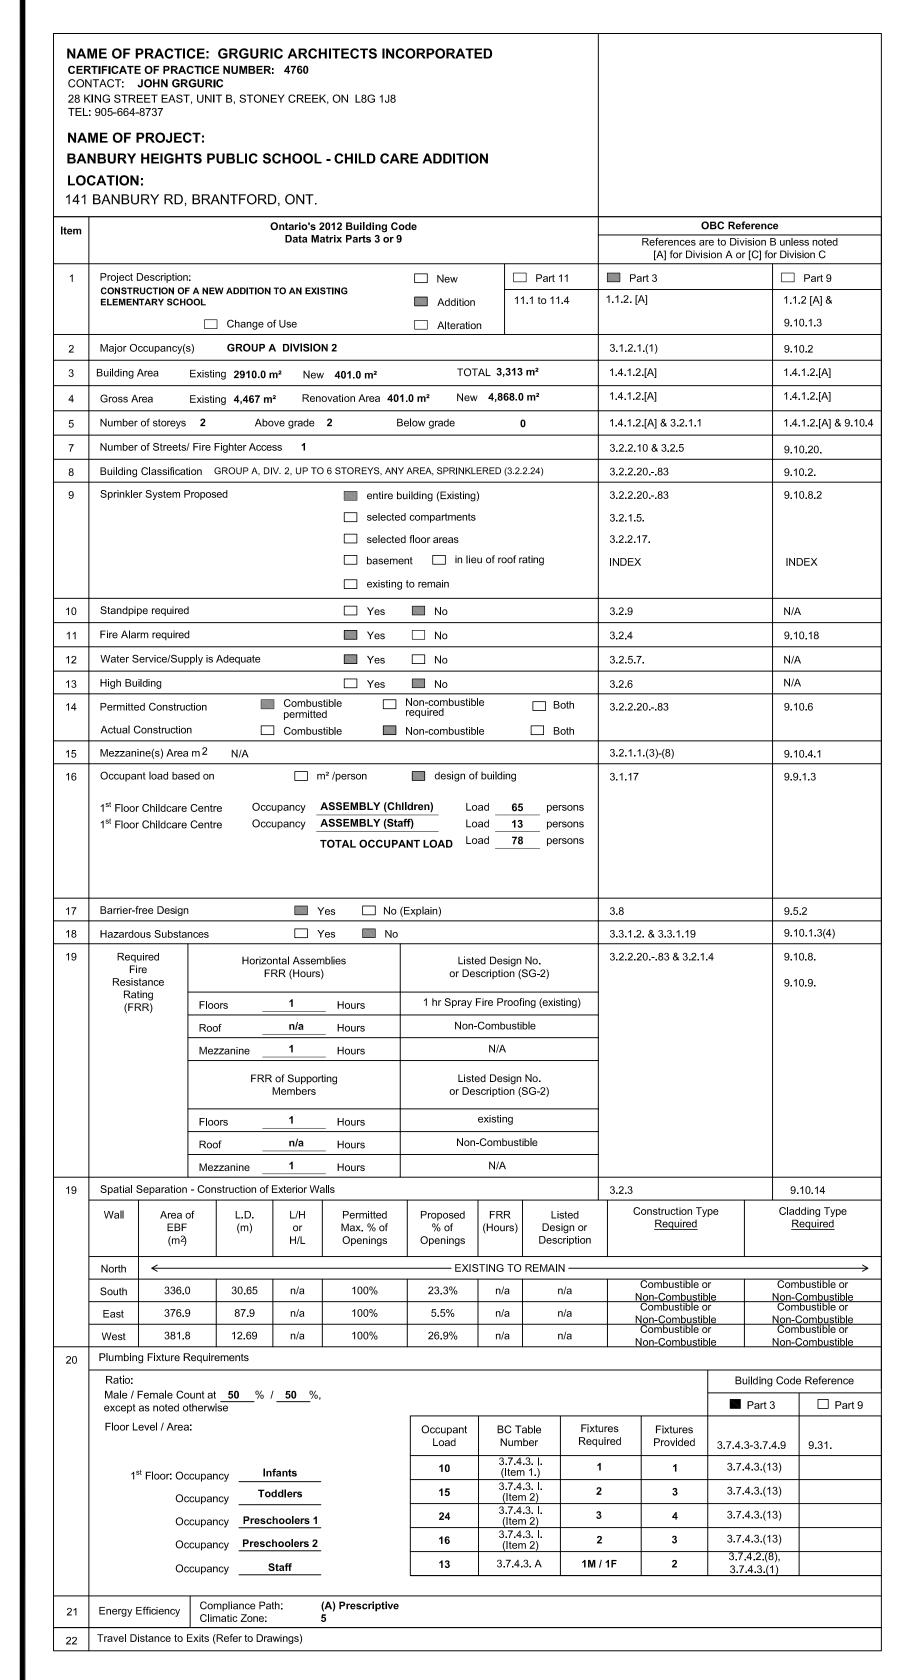

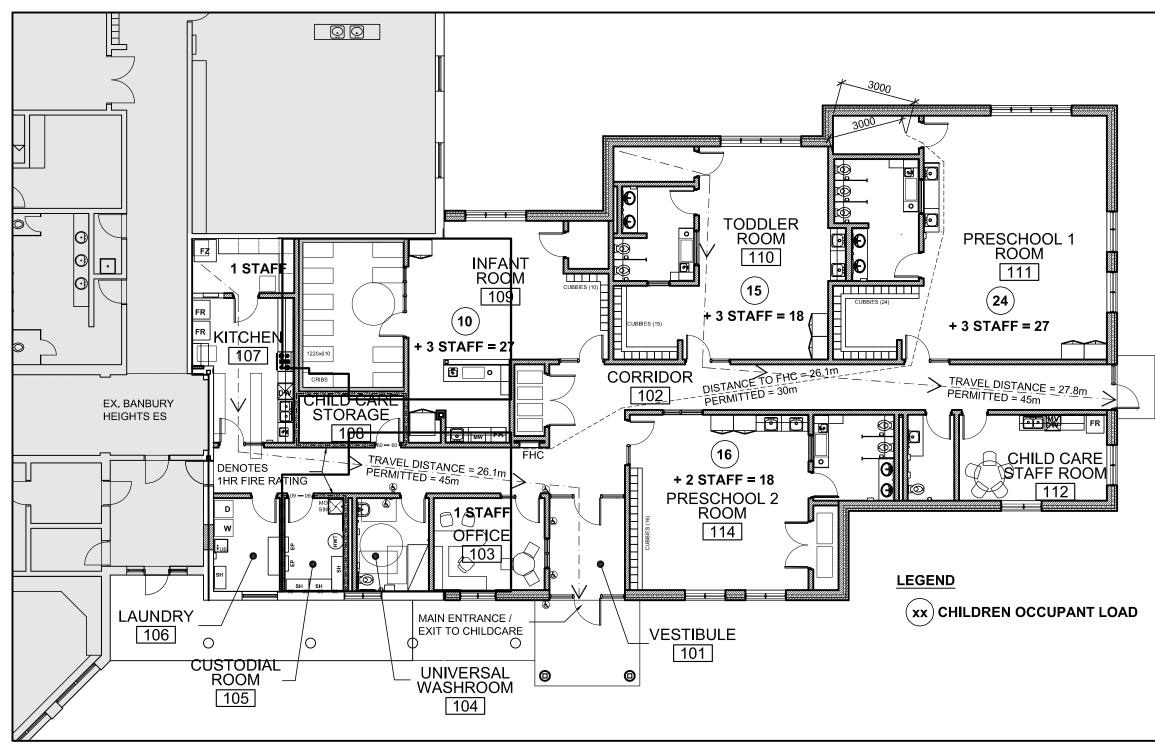

FIRE SAFETY/ TRAVEL DISTANCE PLAN SCALE: 1:150





28 KING STREET EAST, UNIT E STONEY CREEK, ONTARIO, L8G 1J8 Tel. 905-664-8735 Fax. 905-664-8737 Web: www.2gai.com



44 HARDY RD, UNIT #1 BRANTFORD, ON, N3T 5L8 TEL. 519-753-2656 FAX. 519-753-4263 EMAIL: rphillips@cohooneng.com www.cohooneng.com

CIVIL ENGINEER

DOYTCH & FILO ENGINEERING INC.




5063 NORTH SERVICE RD, SUITE 200 BURLINGTON, ON, L7L 5H6 TEL. 647-836-4805 EMAIL: todor@doytchandfilo.com www.doytchandfilo.com

STRUCTURAL ENGINEER



222 ISLINGTON AVENUE, SUITE 260 TORONTO, ON, M8V 3W7 TEL. 416-402-8112 EMAIL: dmitri@dynamiseng.com www.dynamiseng.com

MECHANICAL / ELECTRICAL ENGINEER

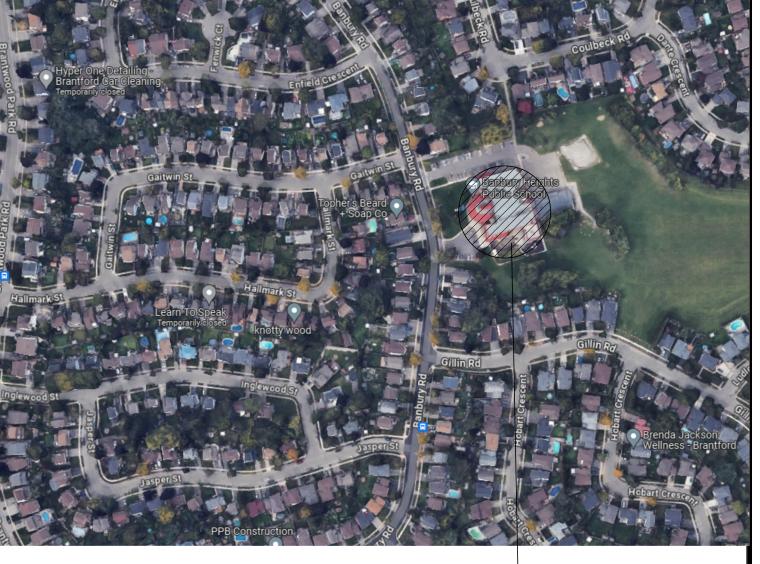

KEY PLAN - AREA OF WORK

141 BANBURY RD —

ARCHITECTURAL

COVER SHEET & OBC MATRIX A1.00 SITE PLAN

LEGAL SURVEY **EXISTING CONDITIONS AND REMOVALS PLAN**

15985-2 SITE GRADING PLAN 15985-3 SERVICING PLAN

15985-4 SEDIMENT AND EROSION CONTROL PLAN

ENLARGED SITE PLAN AND DETAILS

LANDSCAPE PLAN AND DETAILS A1.20 A1.30 SITE DETAILS

A2.10 **DEMOLITION PLANS** A2.20 FLOOR PLANS

A2.30 **ROOF PLAN**

A2.40 REFLECTED CEILING PLAN **EXTERIOR ELEVATIONS**

A3.00 BUILDING SECTIONS, WALL SECTIONS AND DETAILS

WALL SECTIONS AND DETAILS A4.10 WALL SECTIONS AND DETAILS

A4.20

A5.00 PLAN DETAILS

A7.00 **INTERIOR ELEVATIONS**

INTERIOR ELEVATIONS ROOM FINISH AND DOOR SCHEDULE

GENERAL NOTES GENERAL NOTES S0.1

S0.2 TYPICAL DETAILS

S1.0 FOUNDATION PLANS AND SECTIONS

S2.0 ROOF FRAMING PLANS, SCHEDULES AND DETAILS S3.0 DEMOLITION PLANS

MECHANICAL

DRAWINGS LIST, LEGEND AND DETAILS

DETAILS CONTINUED M1.2 **DETAILS CONTINUED**

M1.3 DETAILS CONTINUED

M1.4 SCHEDULES M1.5 SCHEDULES CONTINUED

M2.0 GROUND FLOOR PLUMBING AND DRAINAGE DEMOLITION PLAN

GROUND FLOOR PLUMBING AND DRAINAGE PROPOSED PLAN GROUND FLOOR HVAC DEMOLITION PLAN M3.0

GROUND FLOOR HVAC PROPOSED PLAN

M3.1 M3.2 ROOF PROPOSED HVAC PLAN

FIRE PROTECTION DEMOLITION PLAN FIRE PROTECTION PROPOSED PLAN

ELECTRICAL

GENERAL NOTES, SPECIFICATIONS, DRAWINGS LIST & LEGEND

E1.00 E2.00 SITE PLAN LIGHTING

E2.01 GROUND FLOOR KEY PLAN

E2.02 2ND FLOOR KEY PLAN

E2.03 LIGHTING & FIRE ALARM PLAN ELECTRICAL DEMOLITION E2.04 LIGHTING & FIRE ALARM PLAN ELECTRICAL MODIFICATION

E3.01 POWER AND SYSTEM PLAN ELECTRICAL DEMOLITION

E3.02 POWER AND SYSTEM PLAN ELECTRICAL MODIFICATIONS

E4.00 FIRE ALARM RISER DIAGRAM

E4.01 ELECTRICAL DETAILS E4.02 ELECTRICAL DETAILS & PANEL SCHEDULE

ISSUED FOR TENDER


2024-04-22

2022-08

PROJECT NUMBER

SHEET NUMBER

A 0.00

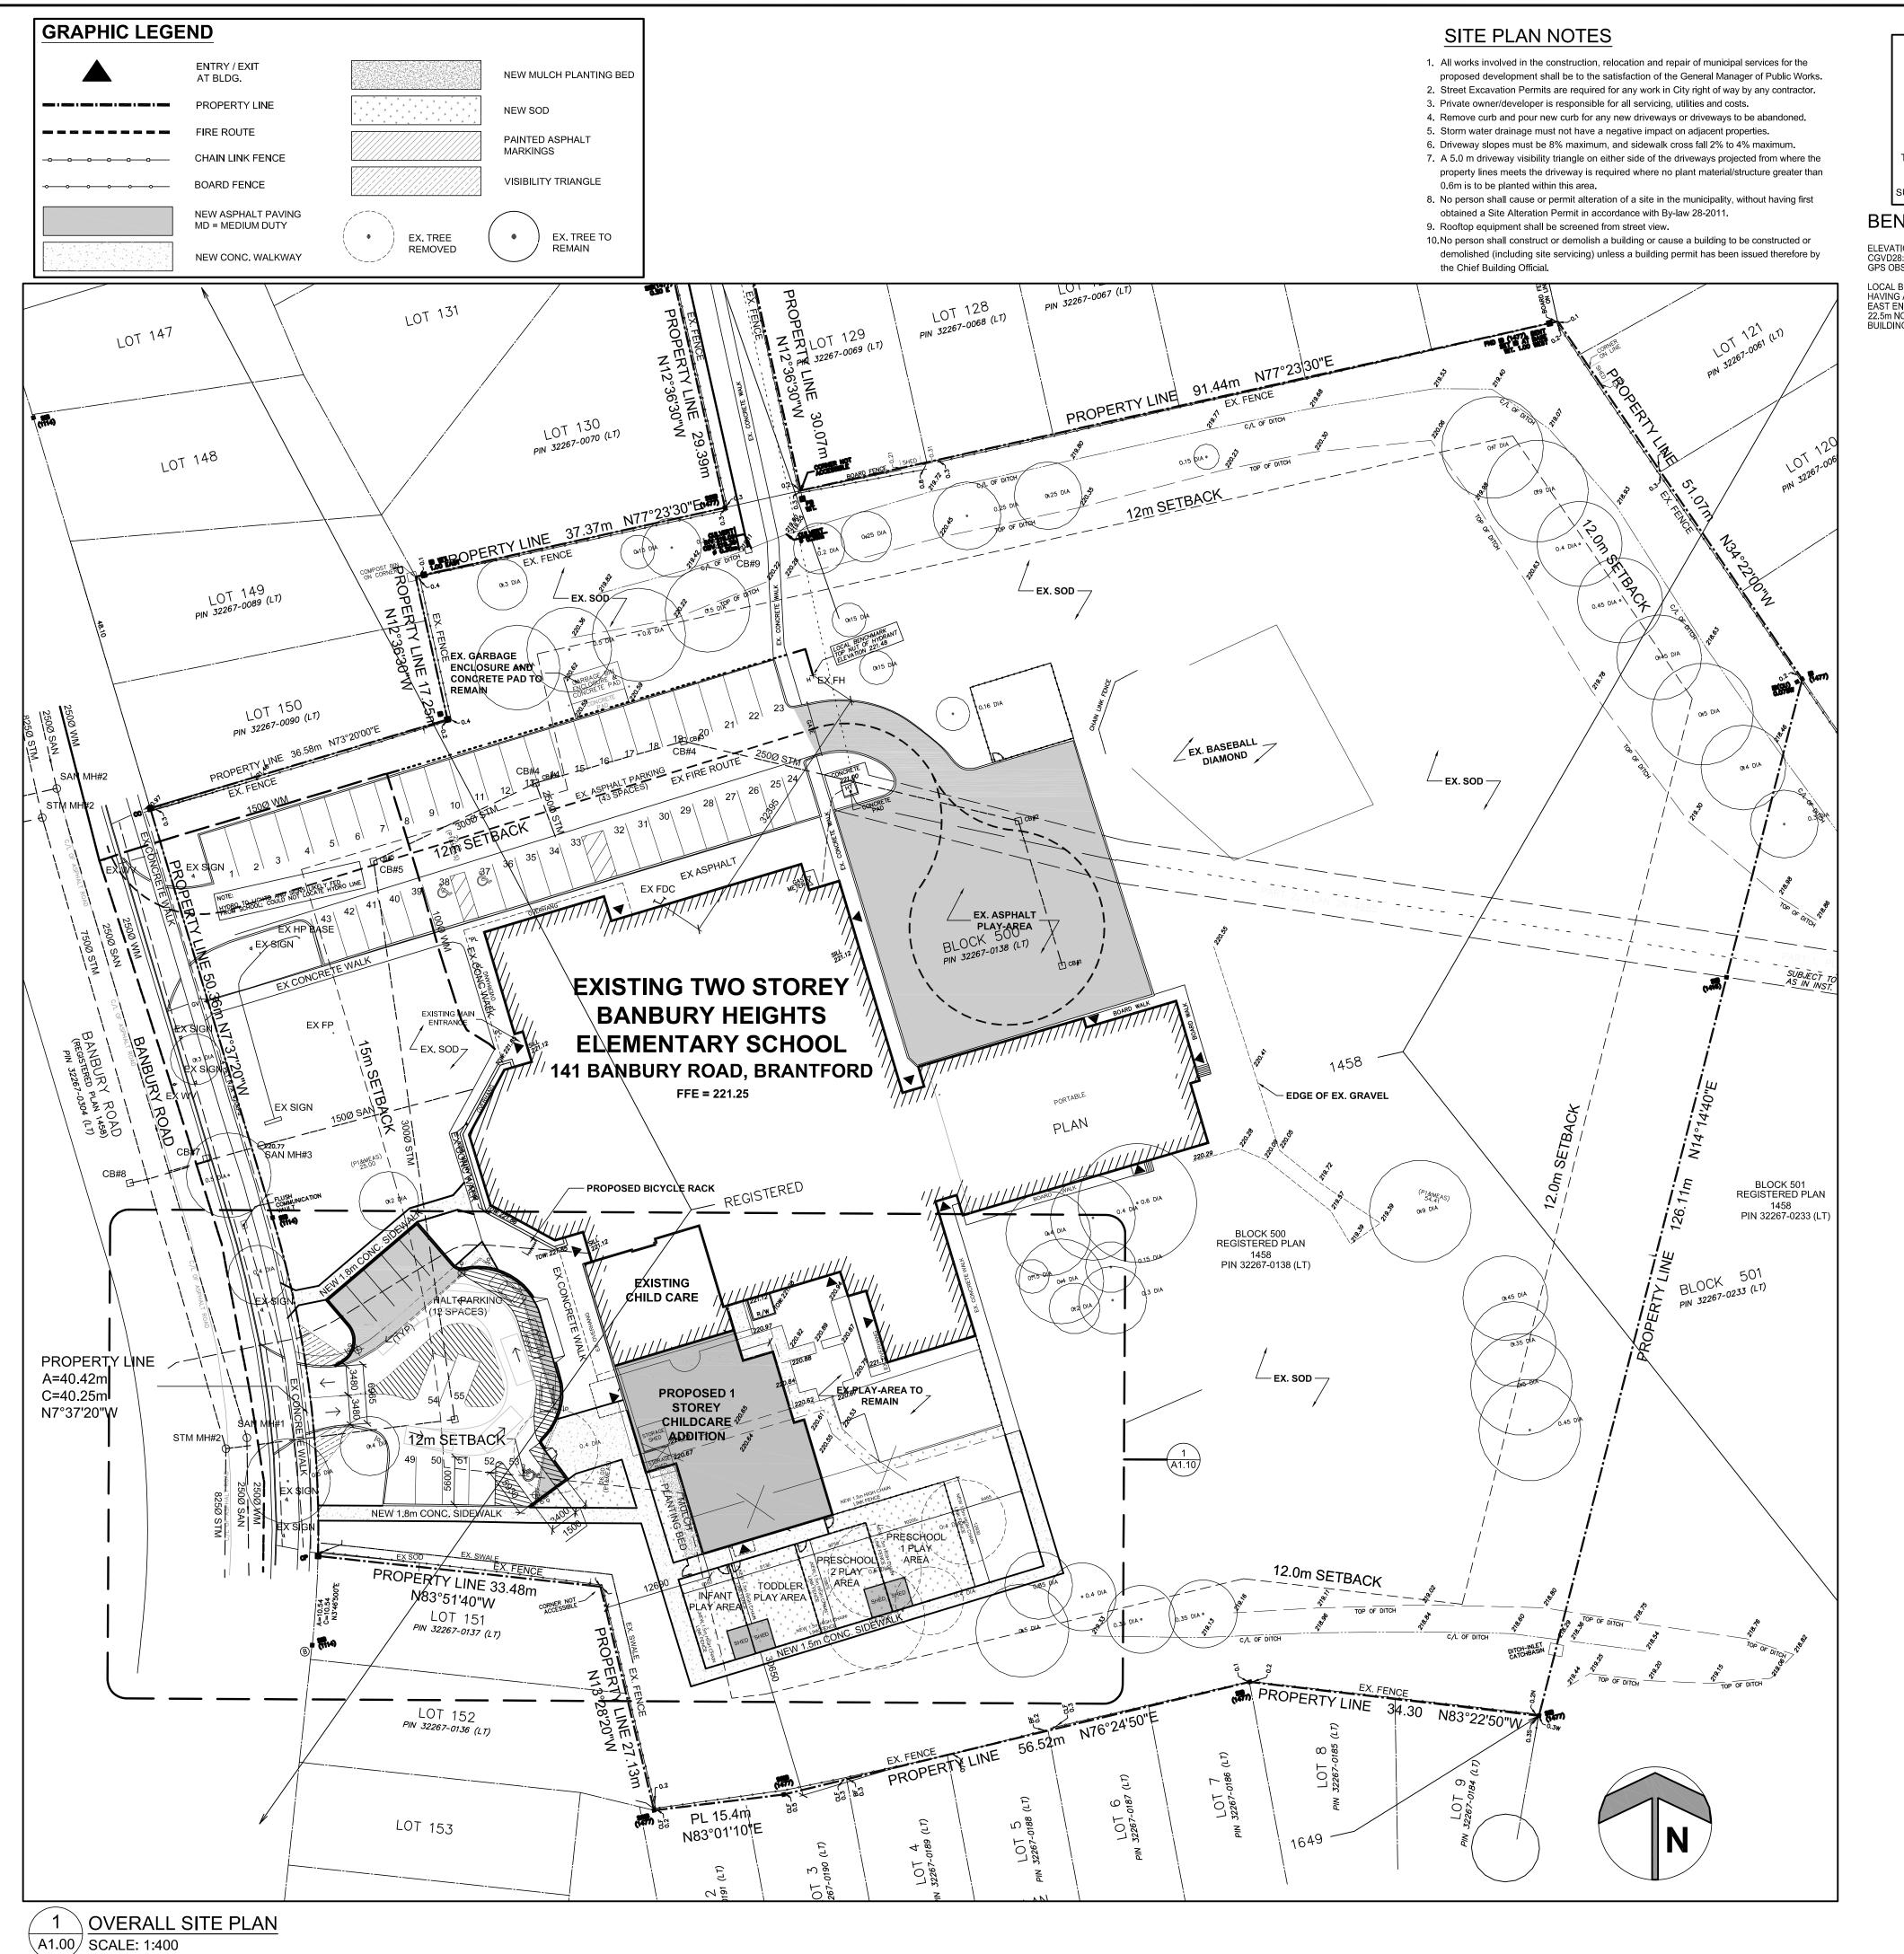

SITE PLAN

PLAN OF SURVEY OF

BLOCK 500

REGISTERED PLAN 1458

CITY OF BRANTFORD

COUNTY OF BRANT

INFORMATION ON THIS SITE PLAN

TAKEN FROM SURVEY / TOPOGRAPHY

PREPARED BY:

J.D BARNES LIMITED

SURVEY COMPLETED ON AUGUST 11, 2022

BENCHMARK

ELEVATIONS SHOWN ARE RELATED TO GEODETIC DATUM CGVD28:78 AND WERE DERIVED FROM REAL TIME NETWORK GPS OBSERVATIONS.

LOCAL BENCHMARK IS THE TOP NUT OF A WATER HYDRANT HAVING AN ELEVATION OF 221.48 WHICH IS LOCATED AT THE EAST END OF THE SCHOOL PARKING LOT AND APPROXIMATEL' 22.5m NORTH OF THE NORTH EAST CORNER OF THE SCHOOL BUILDING AS SHOWN ON THE FACE OF THIS PLAN.

SITE STATISTICS	N	DESIGNATED RESIDENTIAL AREA MEDIUM DENSITY IN OFFICIAL PLA
ITEM DESCRIPTION	PERMITTED / REQ'D REGULATIONS	ACTUAL OR PROPOSED
ZONING DESIGNATION: 12 - INSTITUTIONAL (Zoning By-law 160-90) SCHOOL ZONE	ELEMENTARY SCHOOLS DAY NURSERIES	ELEMENTARY SCHOOL (EXISTIN DAY NURSERY (PROPOSED
LOT AREA	5,000.0m²	24,078 m² (24.08 ha)
LOT COVERAGE MAXIMUM (BUILDING COVERAGE)	40% (MAX)	2,910 m² (EXISTING SCHOOI 401 m² CHILDCARE) = 3,313 m² (13.8%)
BUILDING HEIGHT	2 STOREYS	1 STOREY 5.7m (CHILDCARE ADDITION
GROSS FLOOR AREA		CHILDCARE ADDITION = 401 r EXISTING SCHOOL = 4,467m ² TOTAL = 4,868m ²
FRONT YARD SETBACK (MINIMUM)	15.0m	25.0 m
SIDE YARD SETBACK (MINIMUM)		
1. INTERIOR	12.0 m	12.2 m
2. EXTERIOR	7.5 m	N/A
REAR YARD SETBACK (MINIMUM)	12.0 m	48.9 m (EXISTING BLDG)
LANDSCAPE AREA	15% of lot area (min)	+/- 13,912 m² = 58%
REQUIRED PARKING SPACES: SECTION 6.18 EXISTING ELEMENTARY SCHOOL: The greater of either 3.0 spaces plus 1.0	3.0 spaces plus 1.0 space for each teaching station	43 SPACES
space/teaching station or 1.0 space/4 persons of permitted capacity of the place of public assembly within the elementary school which has the greatest permitted capacity.	(classroom) 20 existing classrooms 3 + 20 = 23 spaces required	Note: Parking count requirements for existing schoot to be maintained as the existin school is not in scope of work
PROPOSED CHILDCARE (DAY NURSERY): 1.0 space per 28.0m² of gross floor playroom space	198.2m² OF FLOOR PLAY ROOM SPACE 198.2m² / 28 = 8 SPACES	13 SPACES
		

31 spaces required

2 spaces required

1 Type A space

1 Type B space

4 SPACES

2 Type A spaces

2 Type B spaces

Note: One (1) Type A space has

reconfigured Childcare (Day

been provided in the

Nursery) parking lot.

ACCESSIBLE PARKING: SECTION 6.1

4% OF THE REQUIRED SPACES SHALL BE

ACCESSIBLE PARKING SPACES IS TO BE

DIVIDED EQUALLY BETWEEN TYPE A AND


PROVIDED AS ACCESSIBLE PARKING

SPACES. THE REQUIRED NUMBER OF

TYPE B SPACES. IN CASE OF A ODD

SPACE CAN BE TYPE B.

NUMBER OF SPACES, THE ADDITIONAL

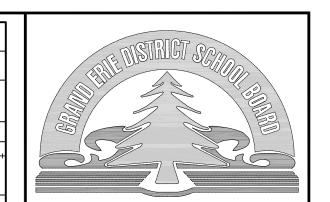

LE	EGI	ΕN	D

BARRIER FREE BOLLARD CATCH BASIN CHAIN LINK FENCE CLEAR

CONC CONCRETE
CW CONCRETE WALK
DBL DOUBLE

DC DEPRESSED CURB
DPS DESIGNATED PARKING SIGN
EX EXISTING ITEM
FP FLAG POLE

FDC FIRE DEPARTMENT CONNECTIONS
FH FIRE HYDRANT
FR DESIGNATED FIRE ROUTE SIGN
LS LIGHT STANDARD

MAX MAXIMUM
MH MAN HOLE
MIN MINIMUM
MW MONITORING WELL
O/H OVER HEAD

S STANDARD IRON BAR
D TO BE DETERMINED
TRAFFIC SIGN OR STOP SIGN
UTILITY POLE
VISIBILITY TRIANGLE

WATER VALVE

 8
 ISSUED FOR TENDER
 2024-04-22

 7
 ISSUED FOR BUILDING PERMIT
 2024-04-17

 6
 RE-ISSUED FOR SITE PLAN APPROVAL
 2024-01-08

 5
 RE-ISSUED FOR SITE PLAN APPROVAL
 2023-09-29

 4
 ISSUED FOR COST ESTIMATE
 2023-07-27

 3
 ISSUED FOR SITE PLAN APPROVAL
 2023-04-12

 2
 RE-ISSUED FOR REVISED DAYCARE PARKING LAYOUT
 2023-01-17

 1
 ISSUED FOR PRE-CONSULTATION
 2022-09-21

 NO
 REVISIONS
 DATE

DRAWINGS ARE NOT TO BE SCALED. CONTRACTOR MUST CHECK AND VERIFY ALL DIMENSIONS AND CONDITIONS ON THE PROJECT; AND MUST REPORT ANY DISCREPANCIES TO THE ARCHITECTS BEFORE PROCEEDING WITH THE WORK. THE USE OF THIS DRAWING OR PART THEREOF IS FORBIDDE WITHOUT THE WRITTEN APPROVAL OF THE ARCHITECTS.

BANBURY HEIGHTS SCHOOI CHILD CARE CENTRE ADDITION 141 BANBURY ROAD BRANTFORD, ON. N3P 1E3

SITE PLAN

GRGURIC ARCHITECTS INCORPORATED

28 KING STREET EAST, UNIT B STONEY CREEK, ONTARIO, L8G 1J8 Tel. 905-664-8735 Fax. 905-664-8737 Web: www.2gai.com

SCALE:
AS NOTED

START DATE:
AUGUST 2022

PROJECT:
2024

204

205

207

208


DRAWN DRAWING:


CHECKED A1.0

J.G

PRINT DATE 04/22/24

S:\Data\2022\2022-08-GEDSB-Banbury-New-Child-Care-Centre\65d

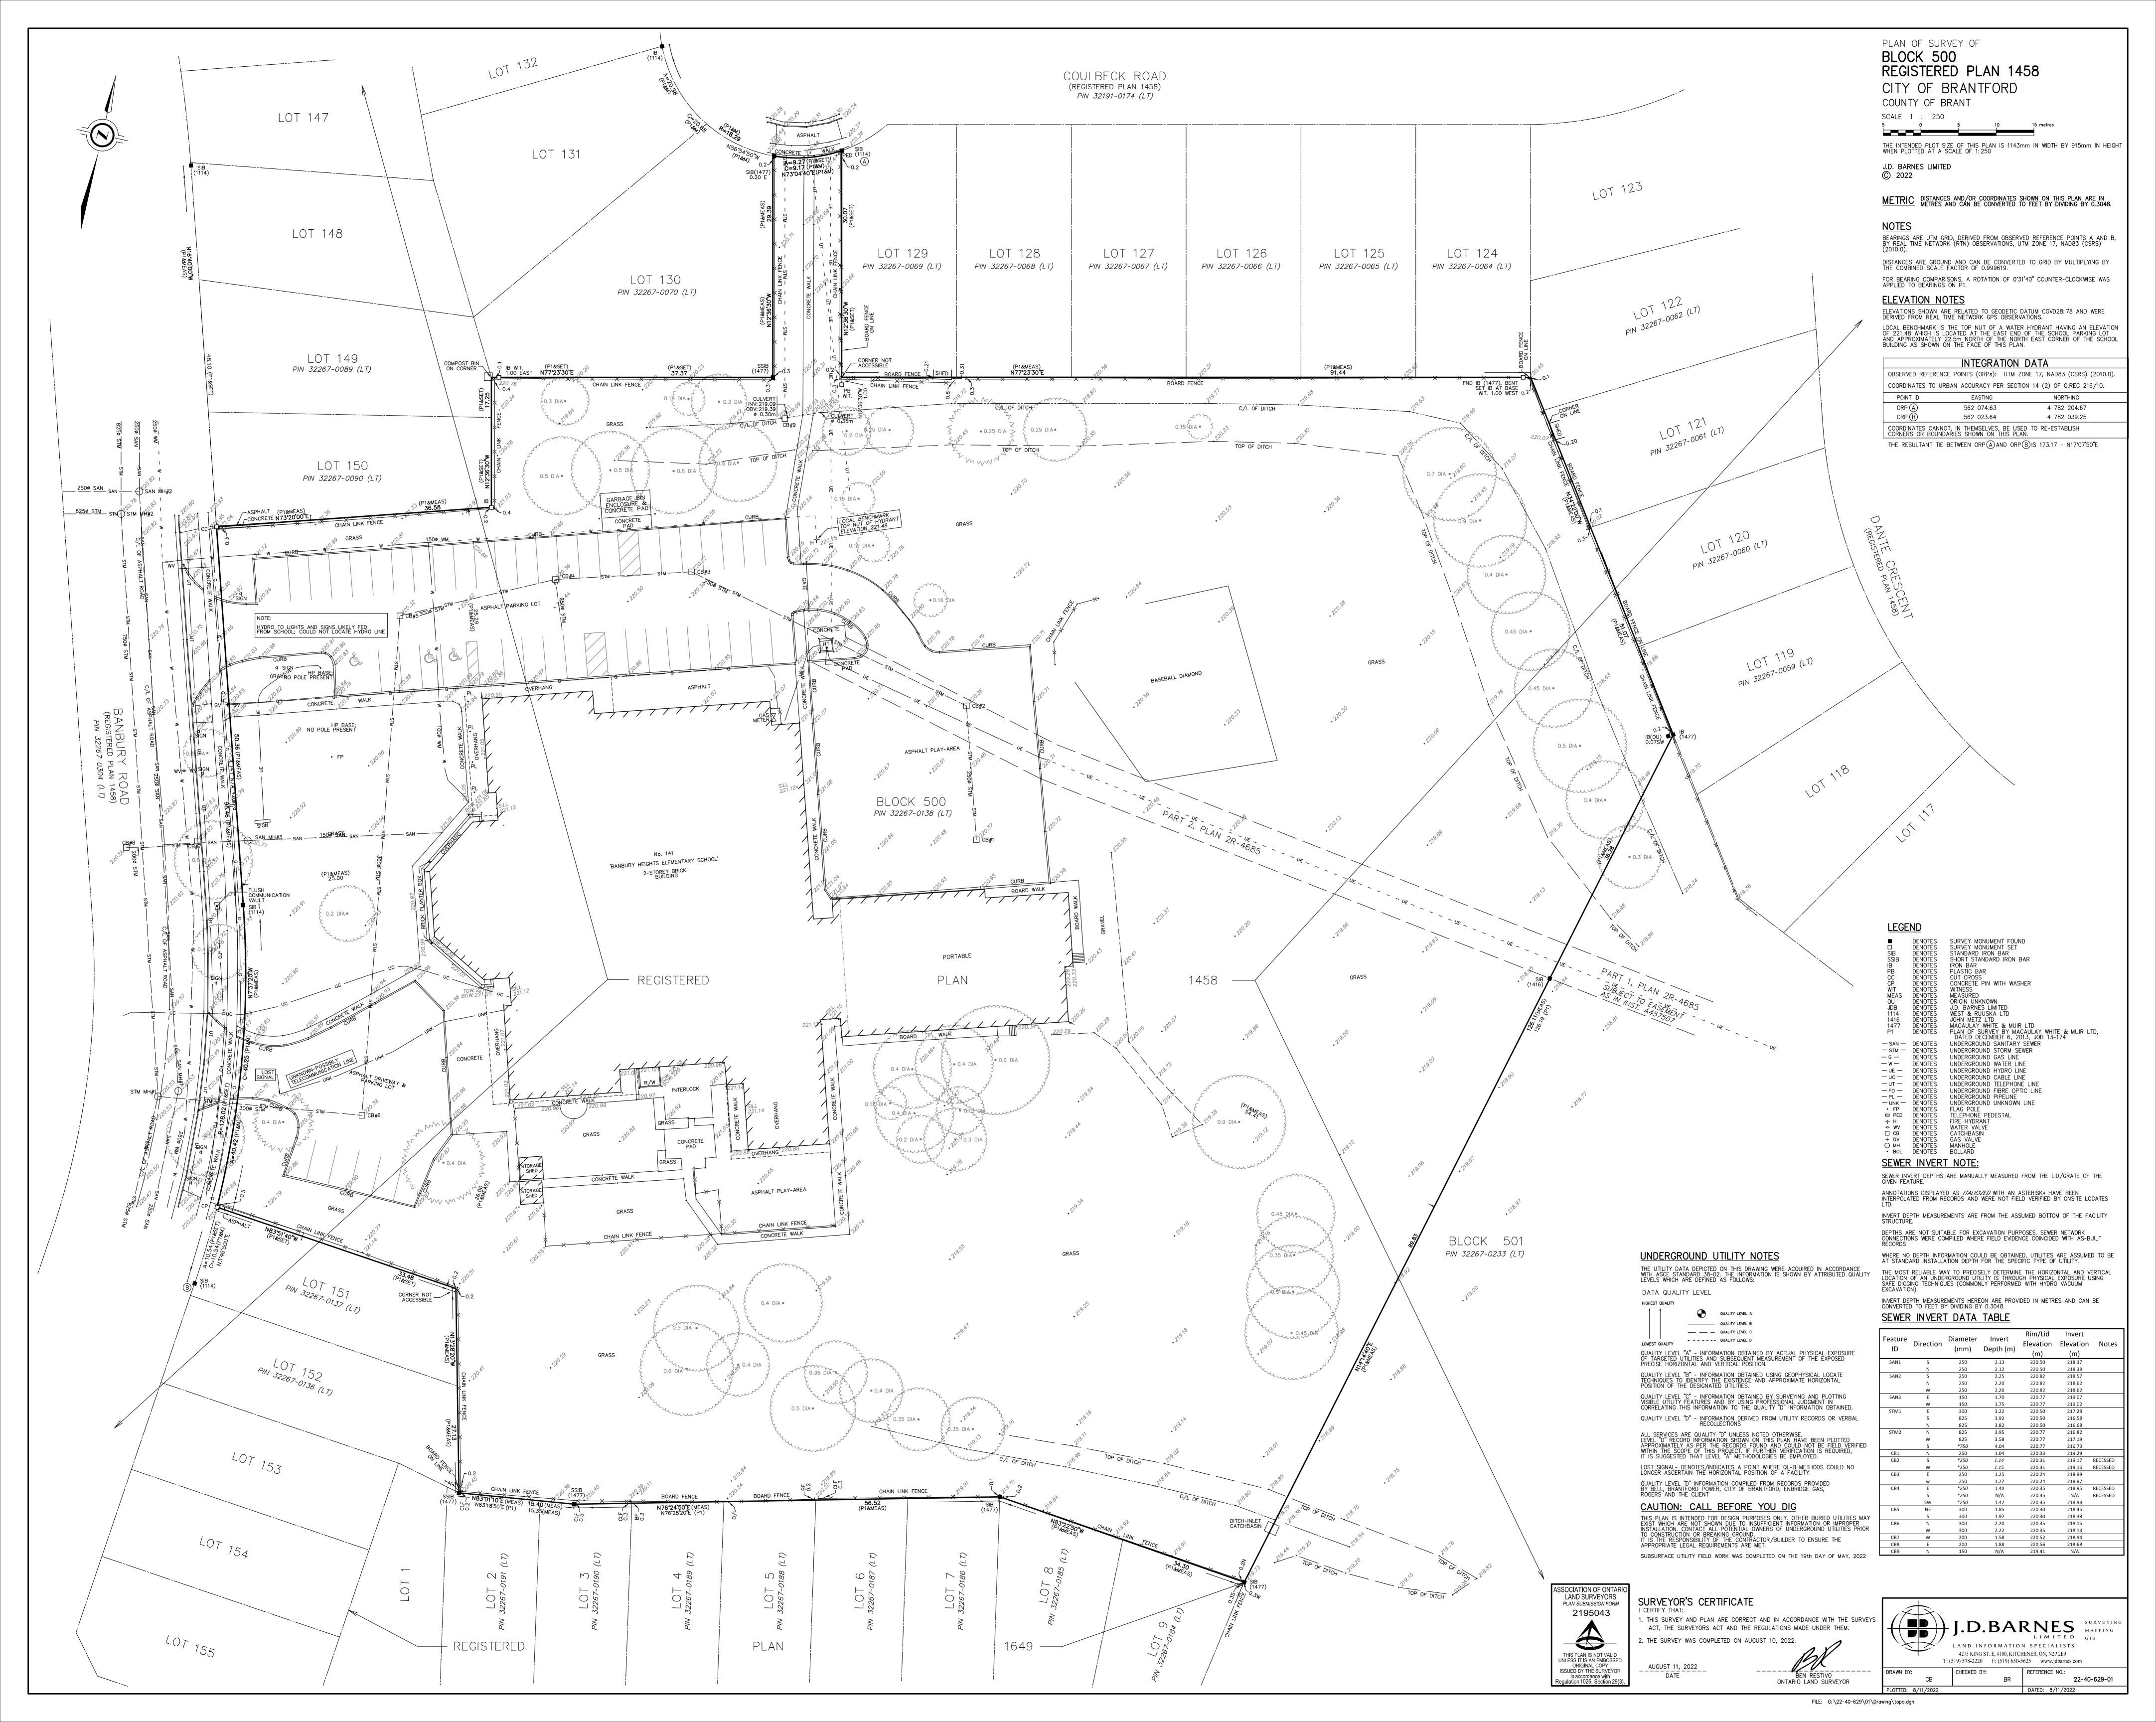

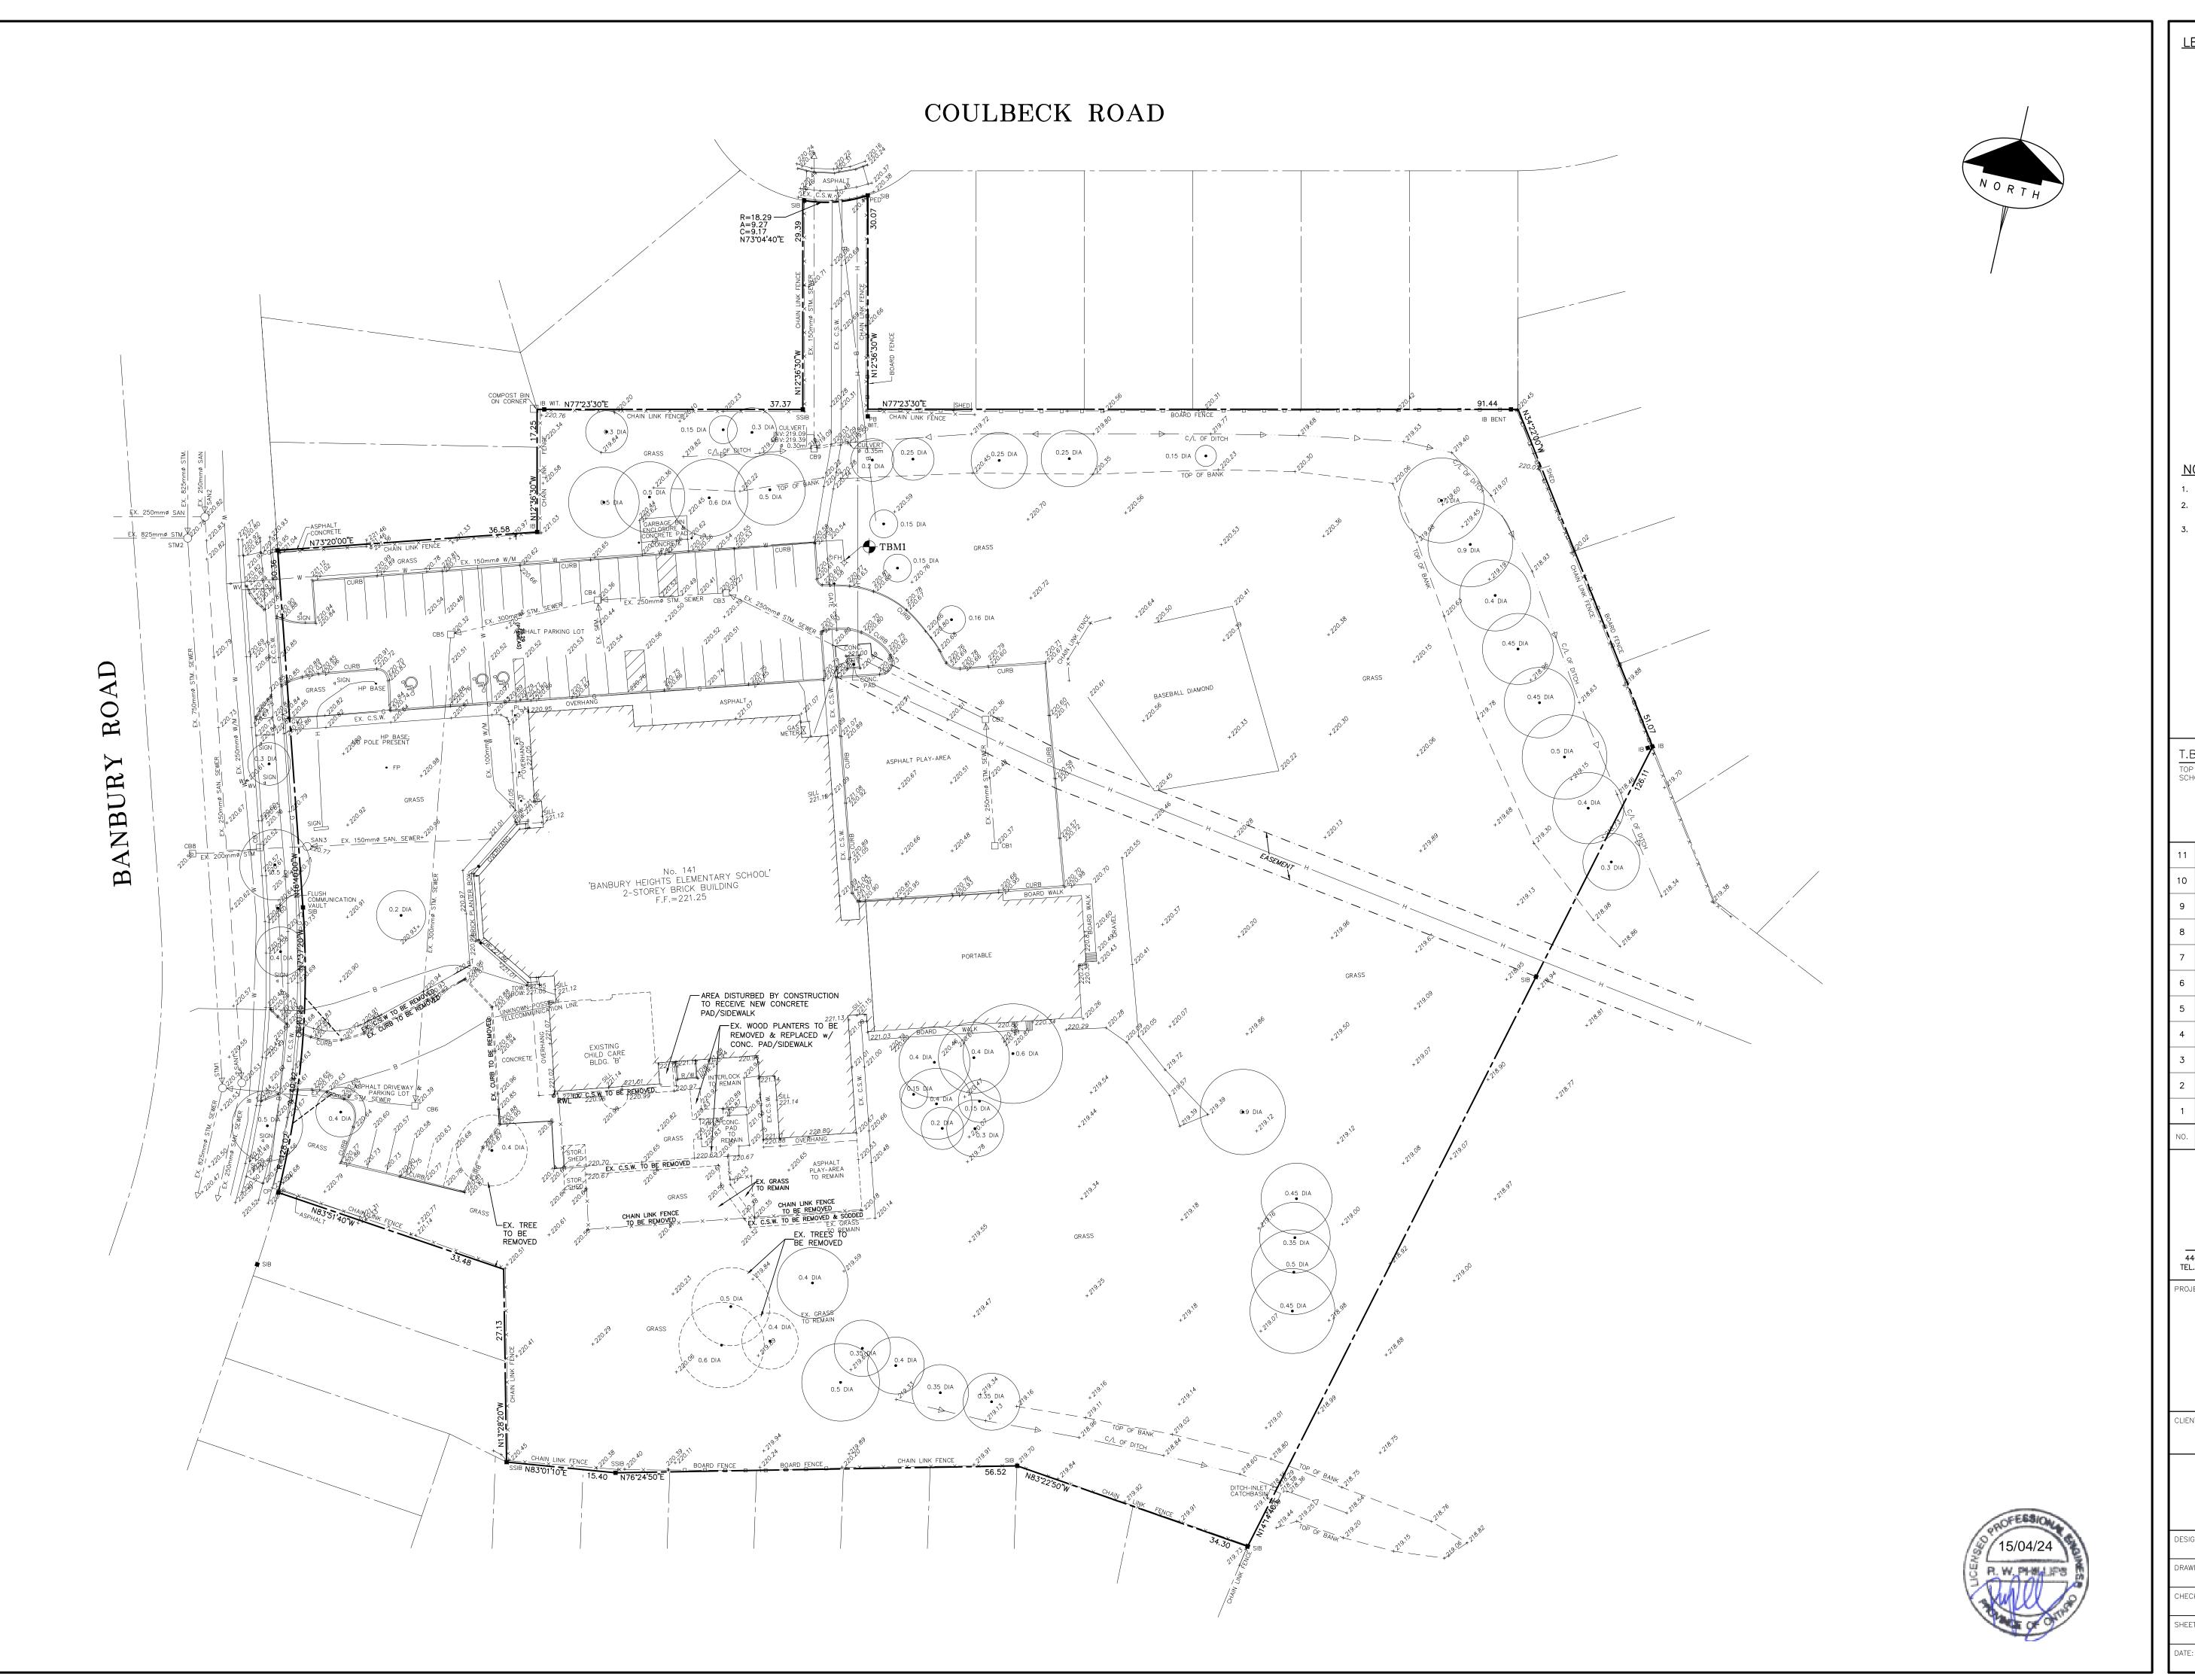

LEGEND:

EXISTING ELEVATIONS



EXISTING TREES TO REMAIN



EXISTING TREES TO BE REMOVED

- 1. ALL ELEVATIONS SHOWN ARE METRIC.
- . BUILDER/OWNER TO VERIFY COMPLIANCE WITH ZONING BYLAWS (ie. SIDEYARDS, SETBACKS, REARYARDS ETC.)
- BOUNDARY AND TOPOGRAPHIC SURVEY PROVIDED BY J.D. BARNES LIMITED. PLAN REF. NUMBER 22-40-629-01 DATED AUGUST 11, 2022.

T.B.M. No. 1 ELEV. = 221.48m TOP NUT OF FIRE HYDRANT AT THE EAST END OF THE EXISTING SCHOOL PARKING LOT AS SHOWN.

	11	ISSUED FOR PERMIT	04/15/24	S.L.M.
	10	STORM SERVICE	12/05/23	S.L.M.
	9	CO-ORDINATION	11/27/23	S.L.M.
	8	CO-ORDINATION	11/27/23	S.L.M.
	7	ISSUED FOR PERMIT / TENDER	11/17/23	K.P.B.
	6	ARCHITECTURAL COMMENTS	09/26/23	S.L.M.
	5	AS PER CITY COMMENTS	09/05/23	S.L.M.
	4	AS PER CITY COMMENTS	06/29/23	S.L.M.
	3	AS PER CITY COMMENTS	06/12/23	S.L.M.
	2	CO-ORDINATION	04/10/23	S.L.M.
	1	CO-ORDINATION	02/14/23	S.L.M.
	NO.	REVISION	DATE (MM/DD/YY)	BY



J.H. COHOON ENGINEERING CONSULTING ENGINEERS


PROPOSED CHILDCARE ADDITION BANBURY ELEMENTARY SCHOOL


141 BANBURY ROAD CITY OF BRANTFORD

GRGURIC ARCHITECTS INCORPORATED

EXISTING CONDITIONS & REMOVALS PLAN

ESIGN:	R.W.P.	SCALE: 1:400
RAWN:	K.P.B./S.L.M.	JOB No:
HECKED:	R.W.P.	15895
HEET:	1 of 4	DWG. No:
ATE:	FEB. 14. 2023	15895-1

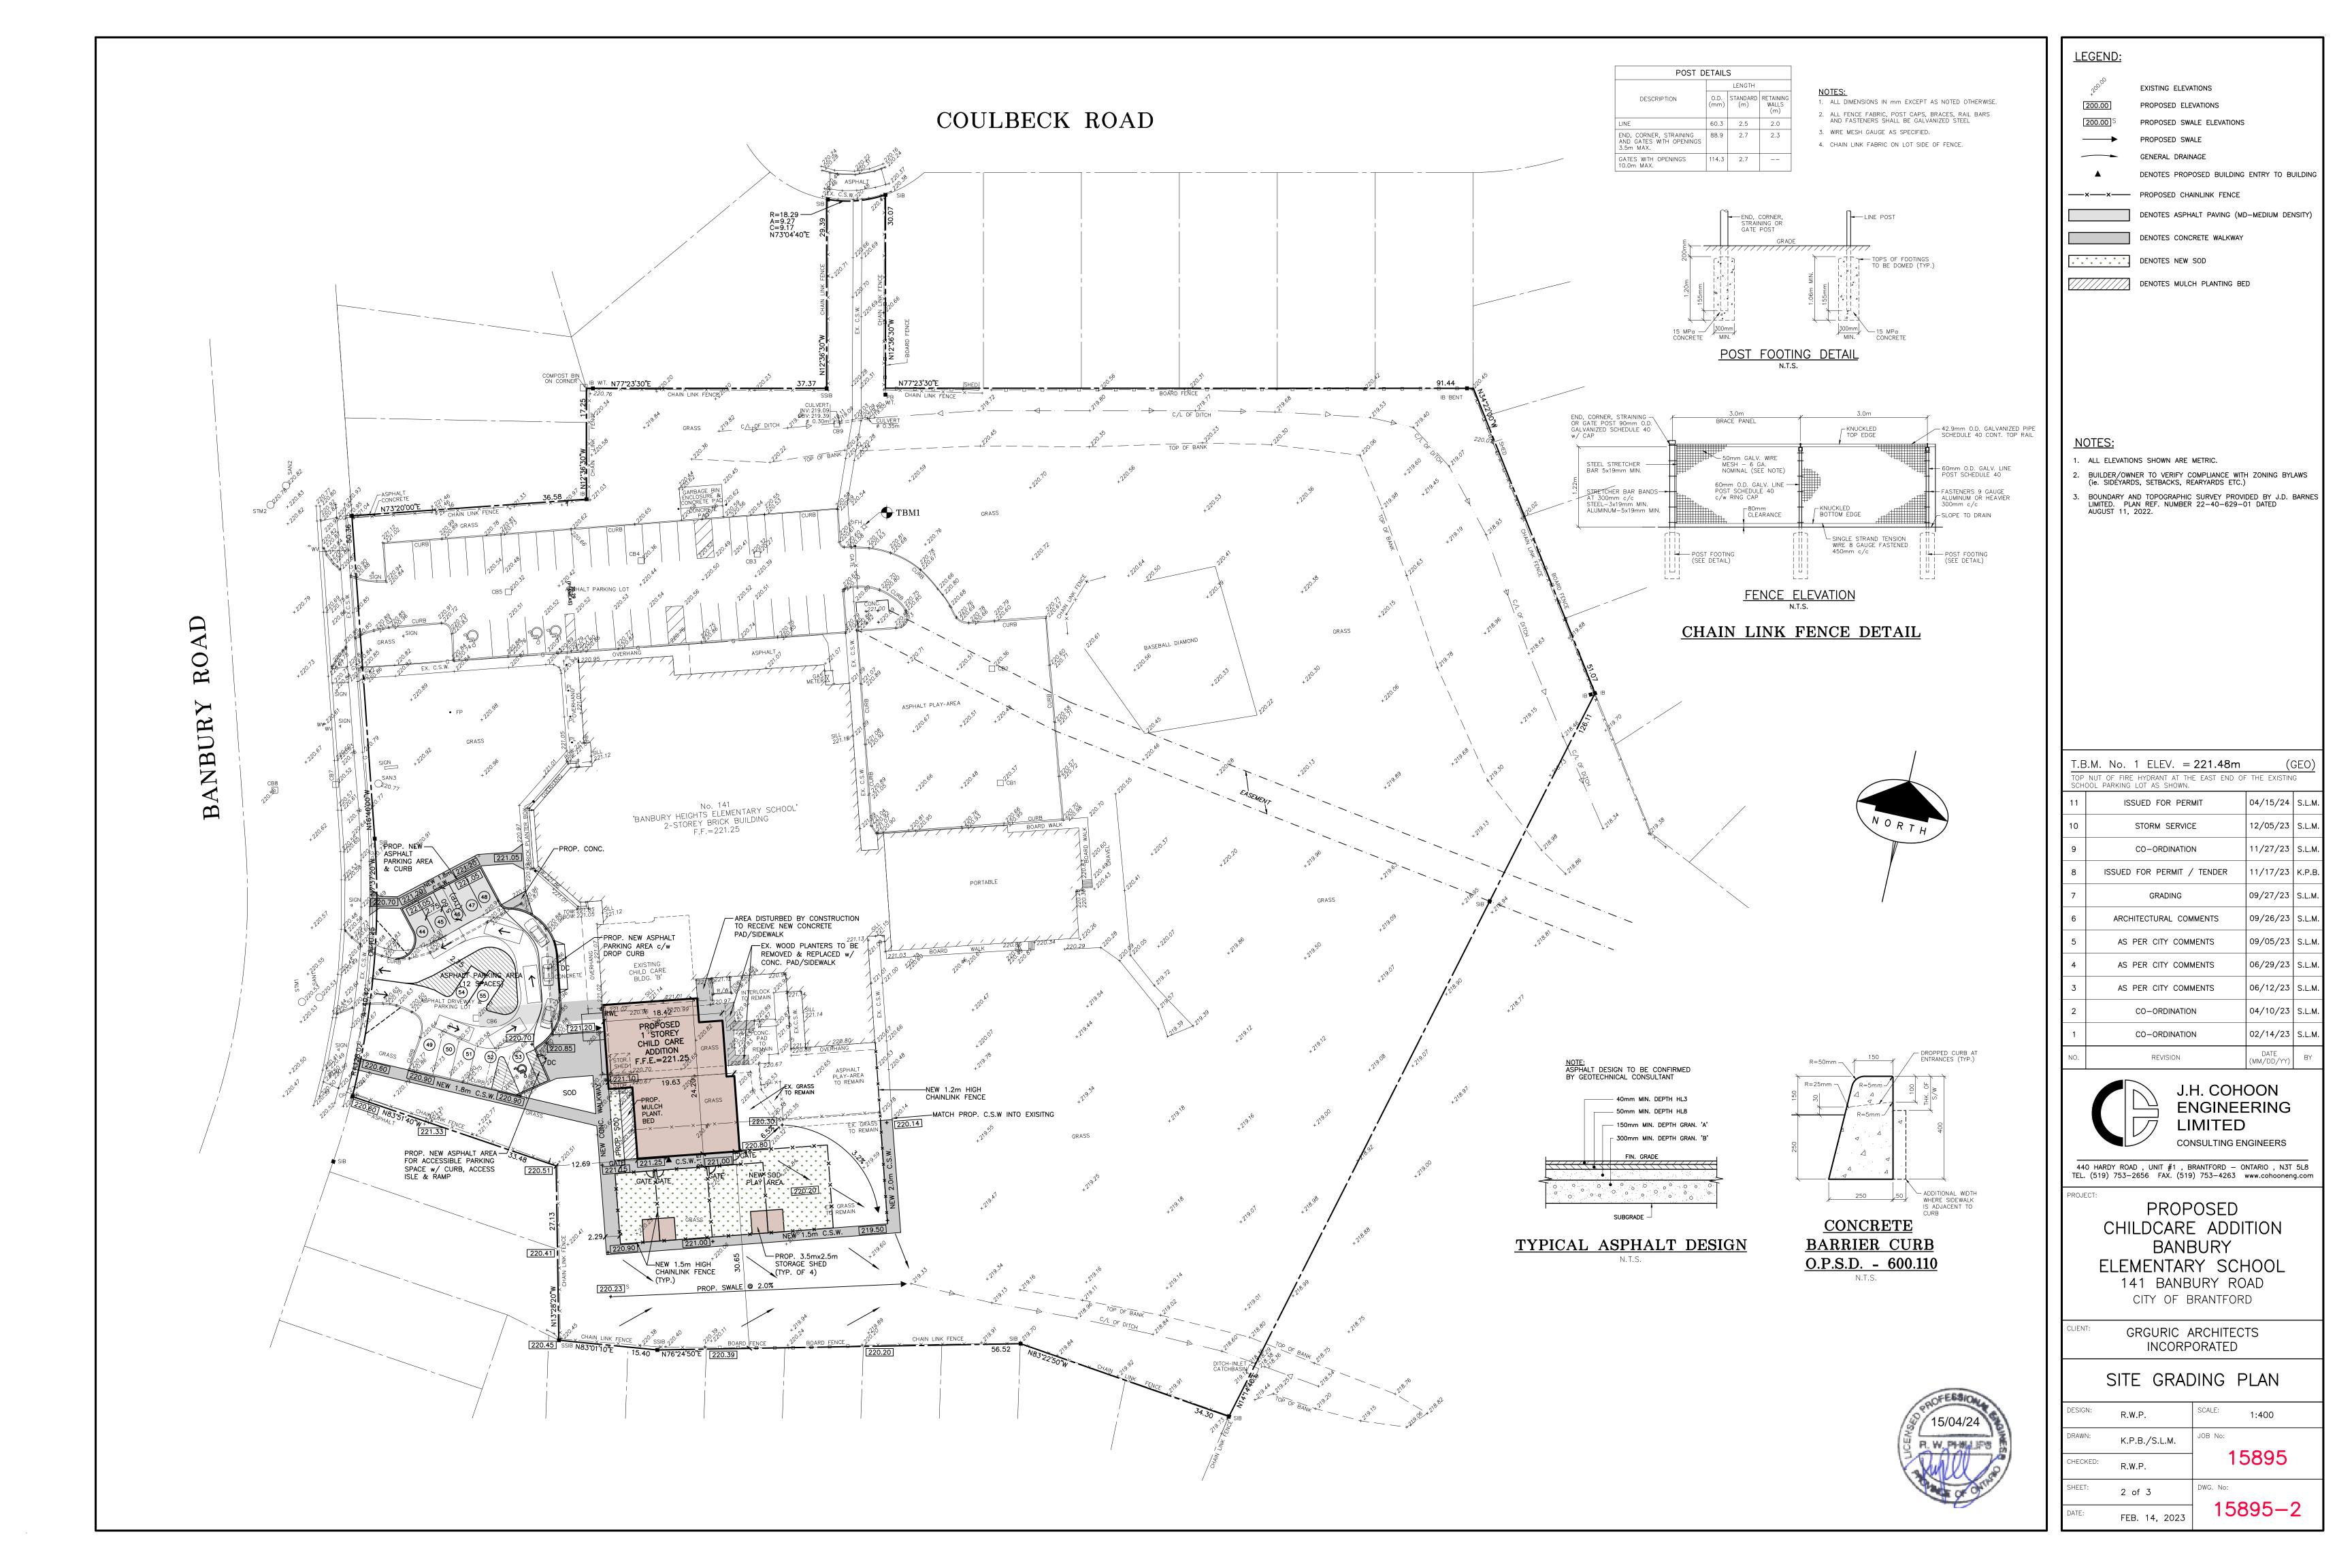


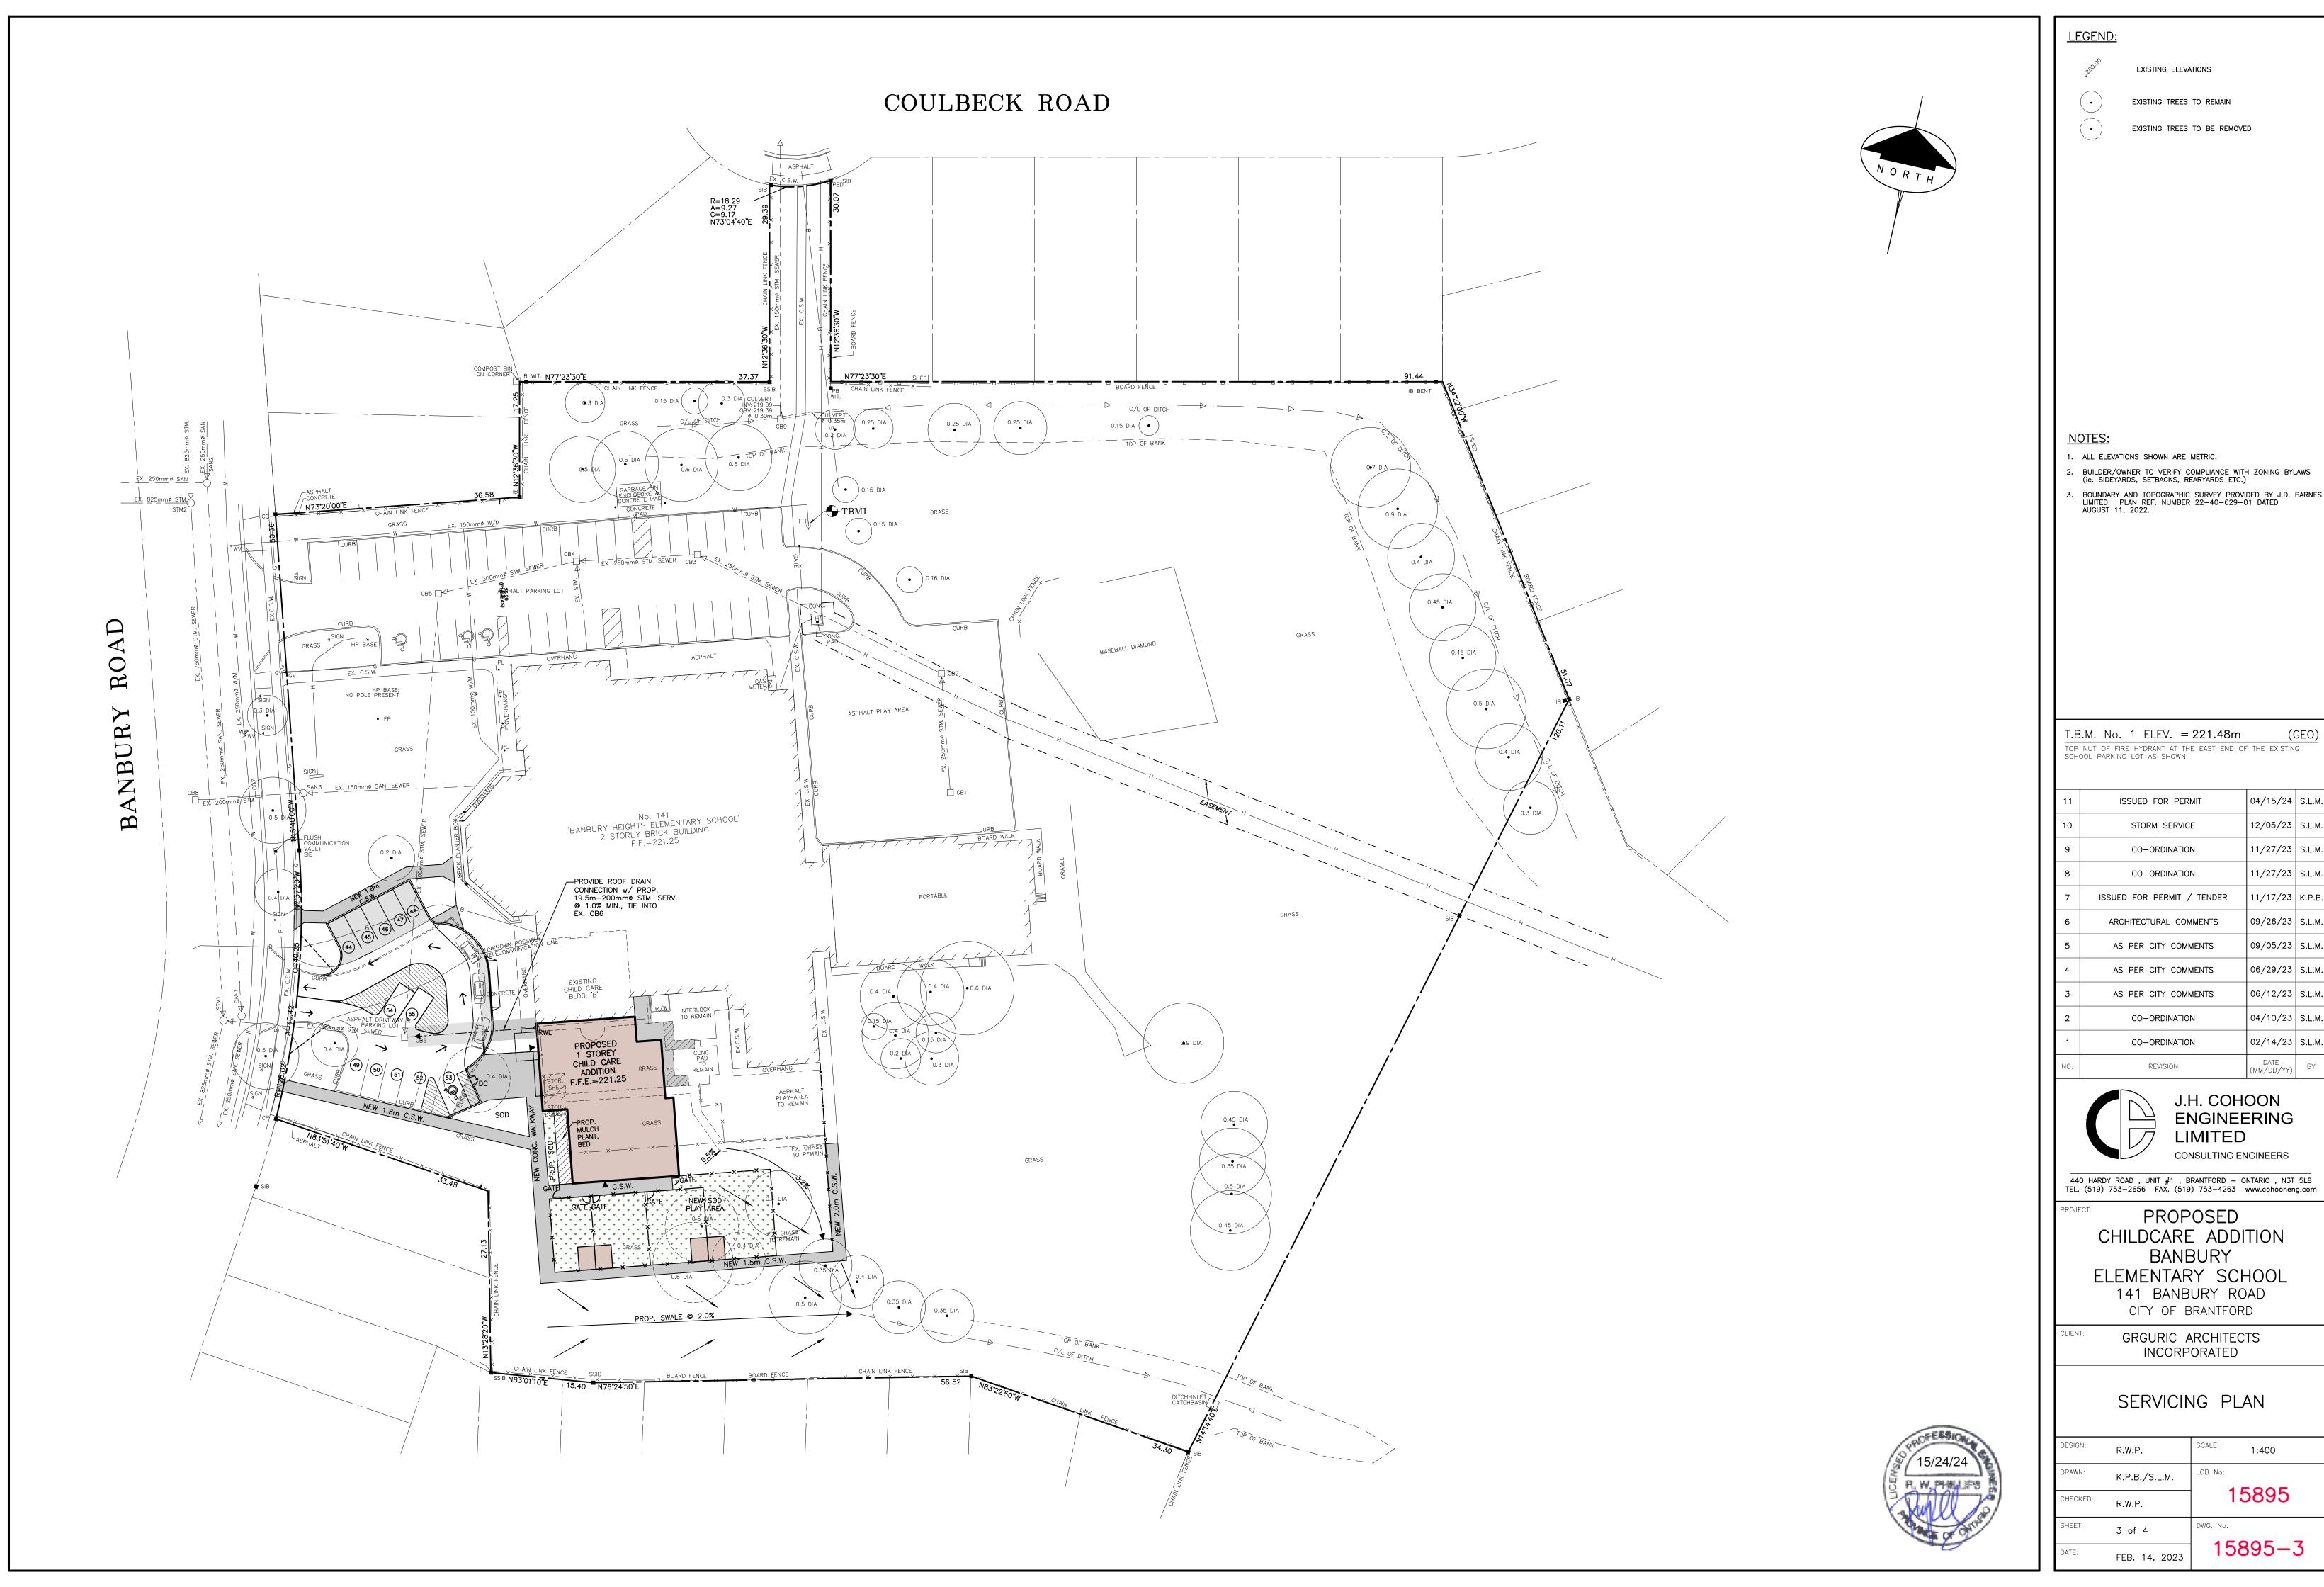

	11	ISSUED FOR PERMIT	04/15/24	S.L.M.
	10	STORM SERVICE	12/05/23	S.L.M.
	9	CO-ORDINATION	11/27/23	S.L.M.
	8	CO-ORDINATION	11/27/23	S.L.M.
	7	ISSUED FOR PERMIT / TENDER	11/17/23	K.P.B.
	6	ARCHITECTURAL COMMENTS	09/26/23	S.L.M.
	5	AS PER CITY COMMENTS	09/05/23	S.L.M.
	4	AS PER CITY COMMENTS	06/29/23	S.L.M.
	3	AS PER CITY COMMENTS	06/12/23	S.L.M.
	2	CO-ORDINATION	04/10/23	S.L.M.
	1	CO-ORDINATION	02/14/23	S.L.M.
	NO.	REVISION	DATE (MM /DD /XX)	BY

ENGINEERING


DESIGN:	R.W.P.	SCALE: 1:400
DRAWN:	K.P.B./S.L.M.	JOB No:
CHECKED:	R.W.P.	15895
SHEET:	3 of 4	DWG. No:
		15005 7

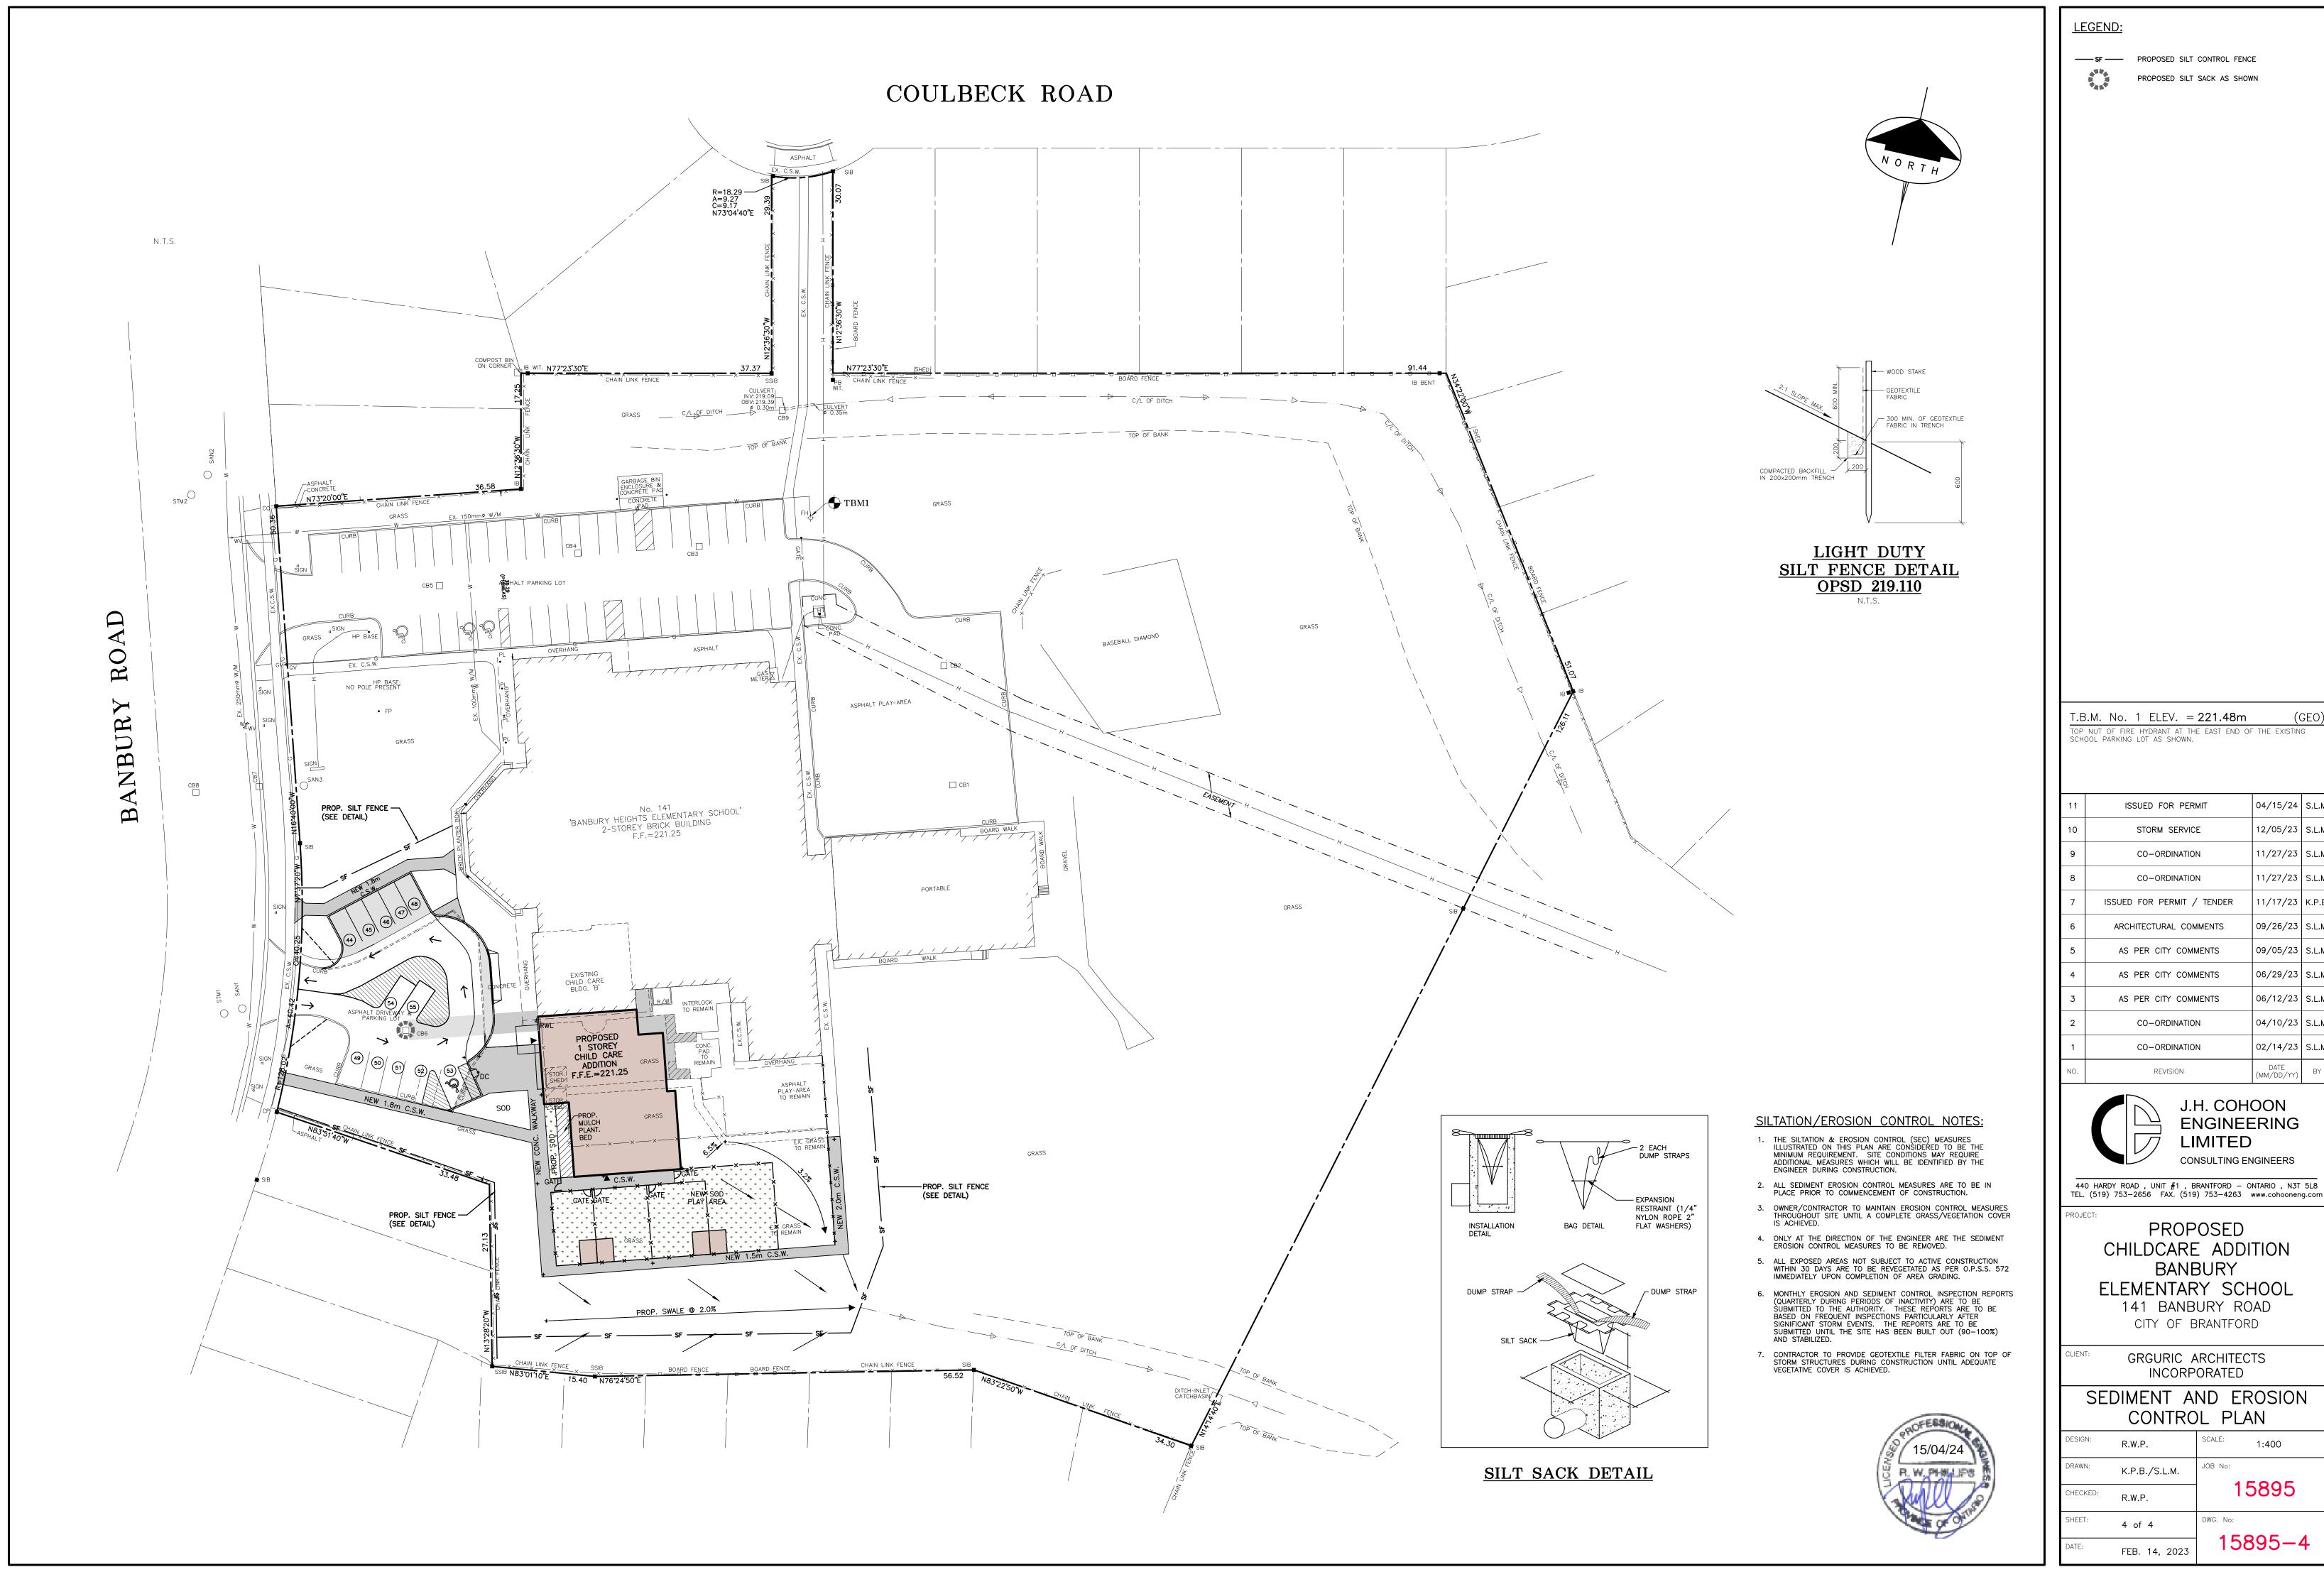


	11	ISSUED FOR PERMIT	04/15/24	S.L.M
	10	STORM SERVICE	12/05/23	S.L.M
	9	CO-ORDINATION	11/27/23	S.L.M
	8	CO-ORDINATION	11/27/23	S.L.M
	7	ISSUED FOR PERMIT / TENDER	11/17/23	K.P.E
	6	ARCHITECTURAL COMMENTS	09/26/23	S.L.M
	5	AS PER CITY COMMENTS	09/05/23	S.L.M
	4	AS PER CITY COMMENTS	06/29/23	S.L.M
	3	AS PER CITY COMMENTS	06/12/23	S.L.M
	2	CO-ORDINATION	04/10/23	S.L.M
	1	CO-ORDINATION	02/14/23	S.L.M
	NO.	REVISION	DATE (MM/DD/YY)	BY


440 HARDY ROAD , UNIT #1 , BRANTFORD - ONTARIO , N3T 5L8

CONTROL PLAN			
DESIGN:	R.W.P.	SCALE: 1:400	
DRAWN:	K.P.B./S.L.M.	JOB No:	
CHECKED:	R.W.P.	15895	
SHEET:	4 of 4	DWG. No:	
DATE:	FEB. 14, 2023	15895-4	

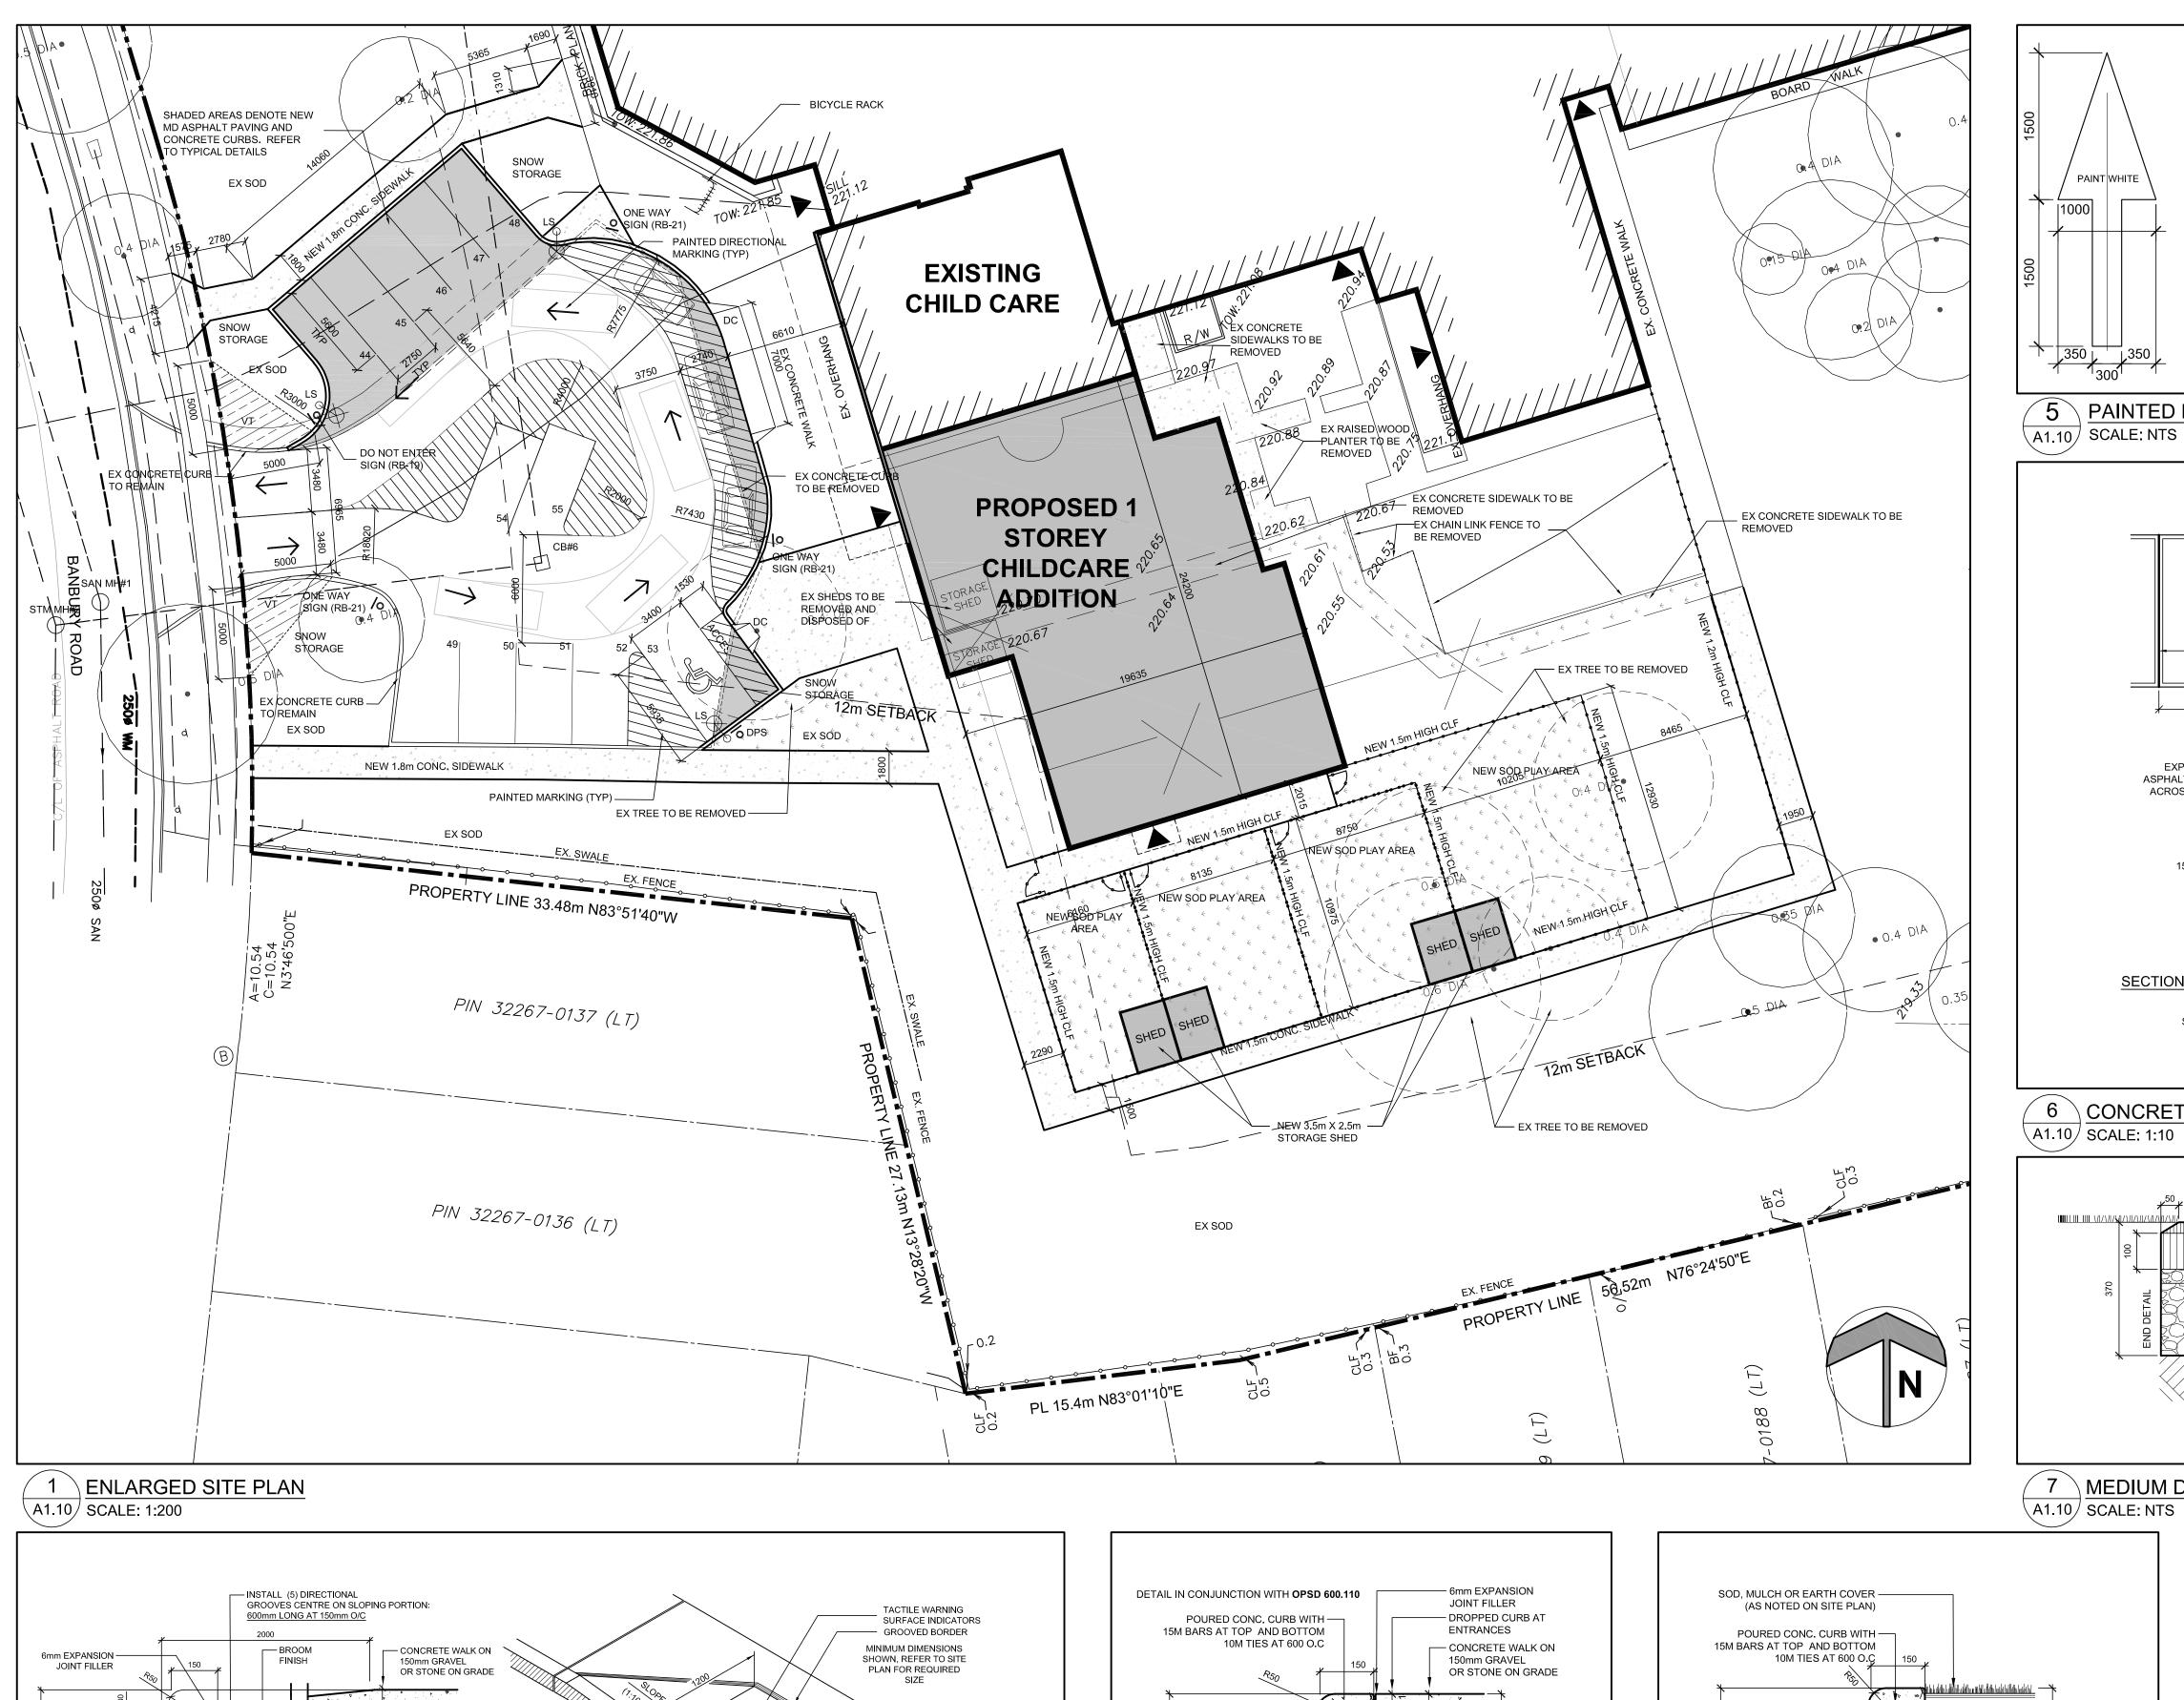


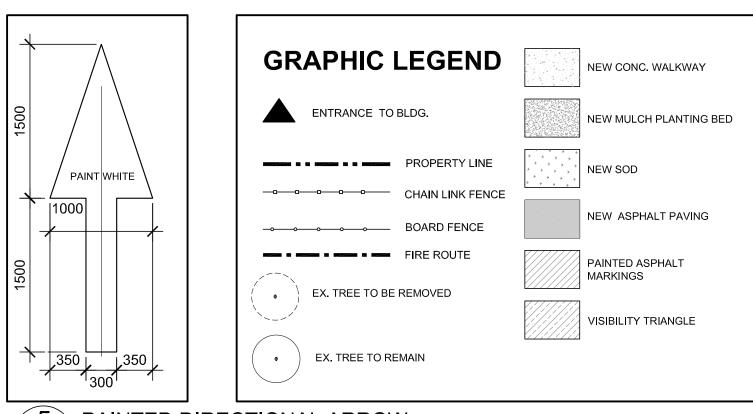


5 PAINTED DIRECTIONAL ARROW A1.10 SCALE: NTS

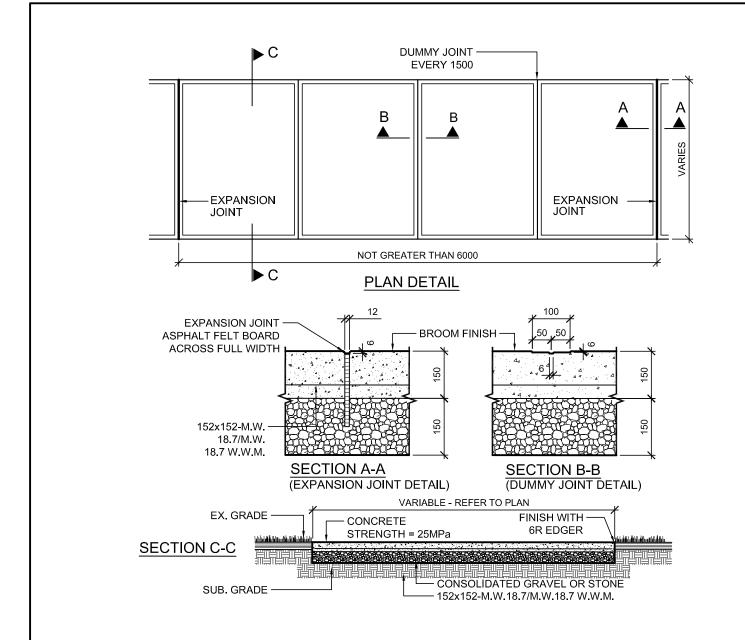

6 CONCRETE WALKWAY DETAIL (TYP.)

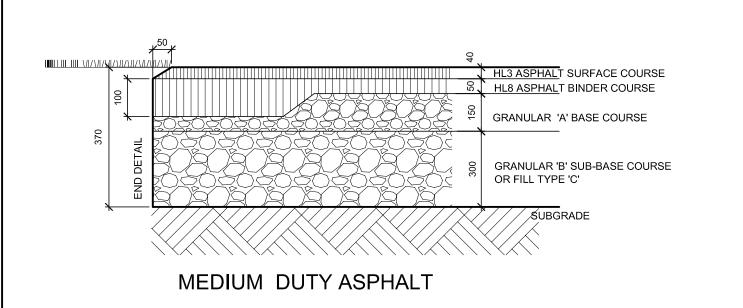

7 MEDIUM DUTY ASPHALT DETAIL A1.10 SCALE: NTS

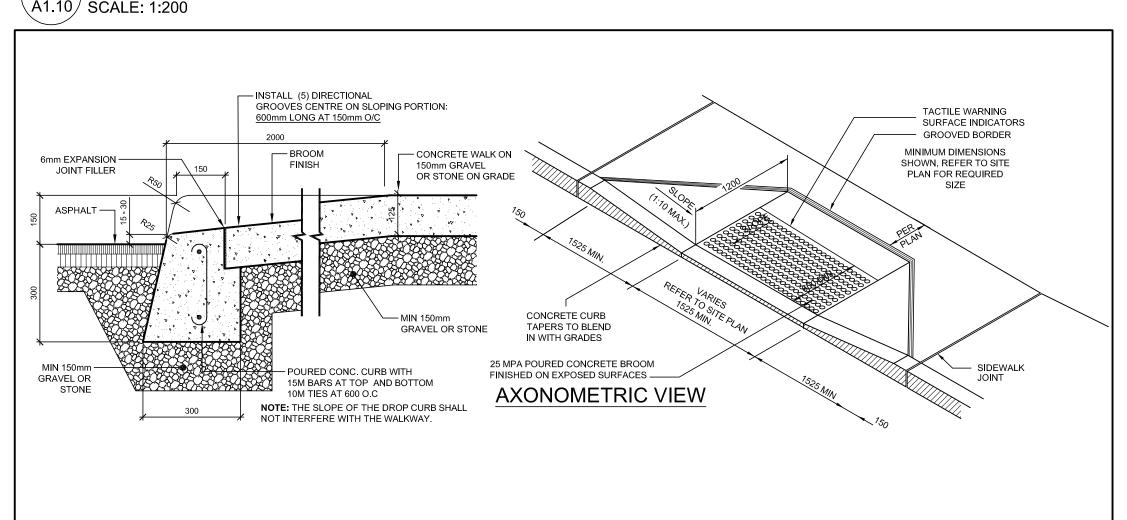


GRAVEL OR STONE NOTE 1: WHEN SIDEWALK IS CONTINUOUSLY ADJACENT, THE DROPPED CURB AT ENTRANCES CAN BE REDUCED TO 75mm 3 CONCRETE WALK AND CURB DETAIL(TYP.)

A1.10 SCALE: 1:10

MIN 150mm -GRAVEL OR STONE DETAIL IN CONJUNCTION WITH OPSD 600.110

A1.10 SCALE: 1:10

4 CONCRETE CURB AT SOD/PLANTING (TYP.)

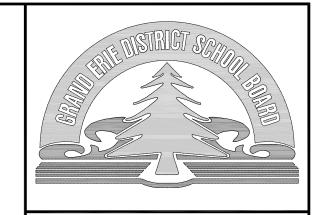

<u>LEGEND</u>

BARRIER FREE BOLLARD CB CLF CLR. CATCH BASIN CHAIN LINK FENCE CLEAR

CLR. CLEAR
CONC CONCRETE
CW CONCRETE V
DBL DOUBLE
DC DEPRESSED
DPS DESIGNATEI CONCRETE WALK DEPRESSED CURB DESIGNATED PARKING SIGN EXISTING ITEM

FLAG POLE FIRE HYDRANT DESIGNATED FIRE ROUTE SIGN LIGHT STANDARD

MAX MAXIMUM MH MIN MW O/H SIB TBD MAN HOLE MINIMUM MONITORING WELL OVER HEAD STANDARD IRON BAR TO BE DETERMINED

TRAFFIC SIGN OR STOP SIGN UTILITY POLE VISIBILITY TRIANGLE WATER VALVE

ISSUED FOR TENDER 2024-04-22 ISSUED FOR BUILDING PERMIT 2024-04-17 RE-ISSUED FOR SITE PLAN APPROVAL RE-ISSUED FOR SITE PLAN APPROVAL | 2023-09-29 ISSUED FOR COST ESTIMATE ISSUED FOR SITE PLAN APPROVAL 2023-04-12 REVISIONS

RAWINGS ARE NOT TO BE SCALED. CONTRACTOR MUST CHECK AND VERIFY ALL DIMENSIONS AND CONDITIONS ON THE PROJECT: AND MUST REPORT ANY DISCREPANCIES TO THE ARCHITECTS BEFORE PROCEEDING WITH THE WORK. ITHOUT THE WRITTEN APPROVAL OF THE ARCHITECTS.

BANBURY HEIGHTS SCHOOL CHILD CARE CENTRE **ADDITION** 141 BANBURY ROAD BRANTFORD, ON. N3P 1E3

ENLARGED SITE PLAN AND DETAILS

GRGURIC ARCHITECTS **INCORPORATED**


28 KING STREET EAST, UNIT B STONEY CREEK, ONTARIO, L8G 1J8 Tel. 905-664-8735 Fax. 905-664-8737 Web: www.2gai.com

PROJECT: SCALE: AS NOTED START DATE: AUGUST 2022

DRAWN CHECKED

A1.10 SCALE NTS

2 DEPRESSED CURB DETAIL (TYP.)

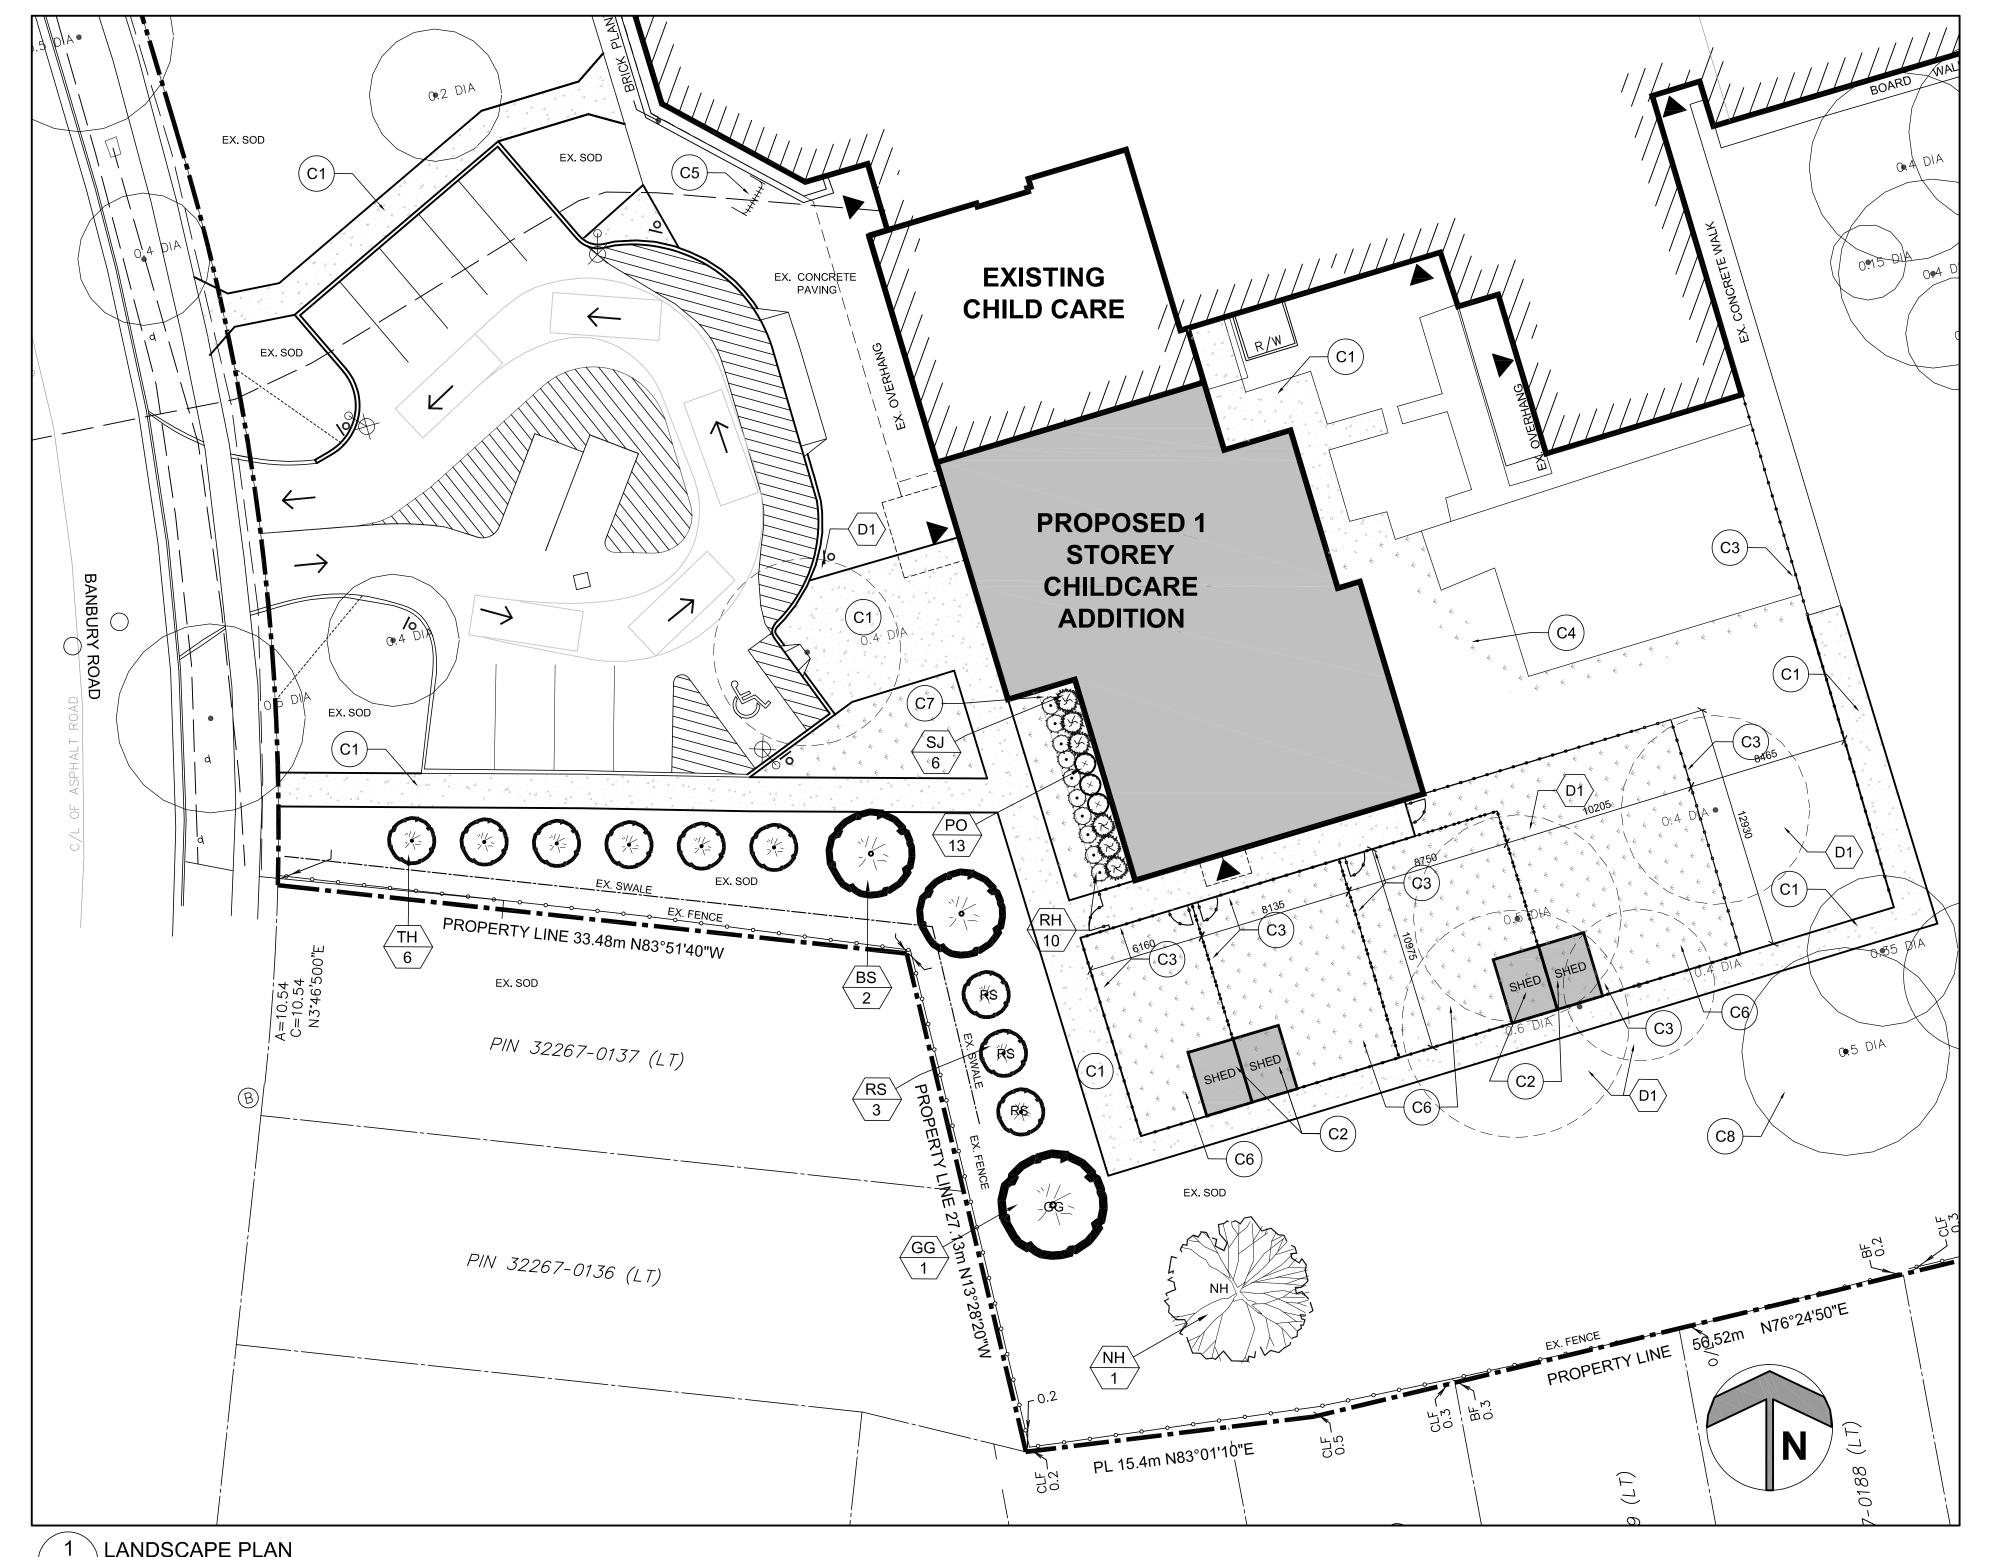

1 \LANDSCAPE PLAN \A1.20 / SCALE: 1:200

KEY	QTY.	BOTANICAL NAME	COMMON NAME	SPREAD SIZE (mm)	HEIGHT (cm)	ROOT	REMARKS
SHRU	BS						
РО	13	PHYSOCARPUS OPULIFOLIOUS 'BURGUNDY CANDY'	BURGUNDY CANDY NINEBARK		50cm	3 Gal Pot	1.0m SPACING
SJ	6	SPIRAEA JAPONICA 'ANTHONY WATERER'	ANTHONY WATERER SPIREA		50cm	3 Gal Pot	1.0m SPACING
PERE	NNIALS						
RH	10	RUDBECKIA HIRTA	BLACK-EYED SUSAN			1 Gal Pot	0.5m SPACING
CONII	FEROUS	TREES					
BS	2	PICEA PUNGENS VAR. GLAUCA	COLORADO BLUE SPRUCE			B&B	
GG	1	THUJA STANDISHII X PLICATA	THUJA GREEN GIANT		122cm	3 Gal	
RS	3	CHAMAECYPARIS THYOIDES 'RED STAR'	RED STAR CEDAR		61cm	3 Gal Pot	3.2m SPACING
TH	6	CHAMAECYPARIS THYOIDES	ATLANTIC WHITE CEDAR		61cm	3 Gal Pot	3.8m SPACING
DECIE	ouous '	TREES		•	•	•	•
NH	1	CELTIS OCCIDENTALIS	NORTHERN HACKBERRY			3 Gal	


DEMOLITION NOTES

REMOVED.

D1 REMOVE EXISTING TREE IN ITS ENTIRETY. PROVIDE NEW SOD WHERE TREES ARE

CONSTRUCTION NOTES

- (C1) INSTALL NEW CONCRETE WALK AS SHOWN. REFER TO RELATED DETAIL(S).
- (C2) FUTURE TOY SHED (NOT IN CONTRACT)
- C3 NEW 1.2m CHAIN LINK FENCE. REFER TO TYPICAL DETAIL.
- ▼ PROVIDE NEW SOD IN LOCATION OF (C4) REMOVED SIDEWALK
- (C5) NEW BIKE RACKS.
- (C6) PROVIDE NEW SOD
- (C7) NEW MULCH PLANTING BED
- REFER TO ARBORIST REPORT AND TREE PRESERVATION PLAN FOR PROTECTING EXISTING TREES TO REMAIN. TYPICAL

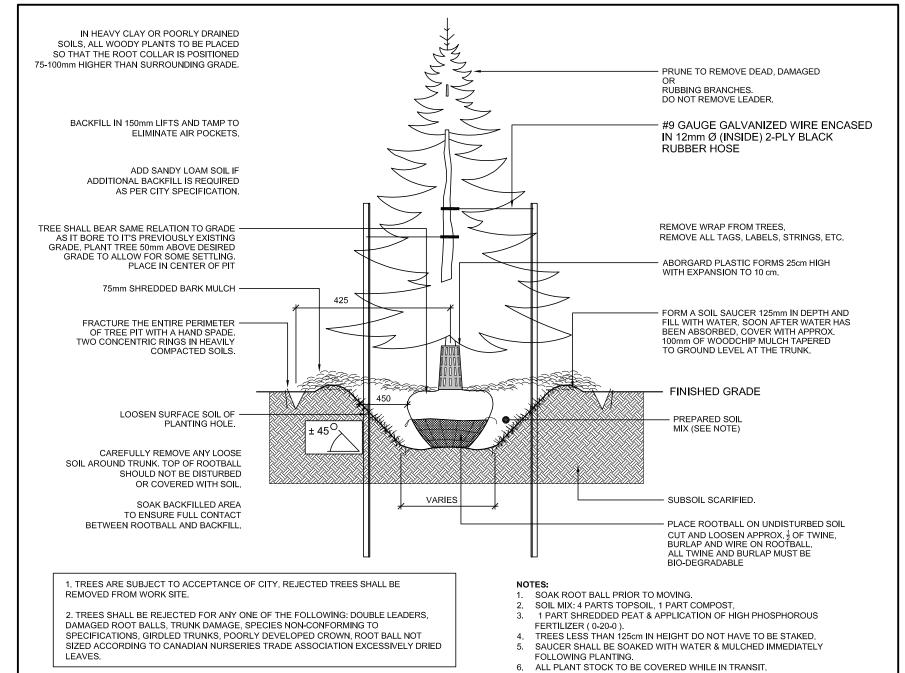

TYP. CONIFEROUS TREE PLANTING DETAIL A1.20 SCALE NTS

TREE SHALL BE STAKED USING 6'X2"X2" (1830X40X40mm) PRUNE TO REMOVE DEAD, DAMAGED OR -WOODEN STAKES (MIN 2'-0" (600mm) IN GROUND) AND ARBORITE OR VSTRAP FASTENED SECURELY TO STAKES DO NOT REMOVE LEADER. AND TIED TO TREE AS SHOWN ABOVE AND ACCORDING TO MANUFACTURER'S SPECIFICATIONS. IN HEAVY CLAY OR POORLY DRAINED

- ARBORITE KNOTTED ON BOTH SIDES OF SOILS, ALL WOODY PLANTS TO BE PLACED TREE TRUNK (MAX. 30MM FROM TRUCK) SO THAT THE ROOT COLLAR IS POSITIONED TO RESTRAIN MOVEMENT OF TREE 75-100mm HIGHER THAN SURROUNDING GRADE. ALTERNATE PRODUCT: VSTRAP BY TREESTRAP INSTALLED AS PER BACKFILL IN 150mm LIFTS AND TAMP TO MANUFACTURER'S SPECIFICATIONS PLAN OF TREE ELIMINATE AIR POCKETS. STAKES TRUNK OF TREE ADD SANDY LOAM SOIL IF ADDITIONAL BACKFILL IS REQUIRED AS PER CITY SPECIFICATION. TREE STAKES -TREE SHALL BEAR SAME RELATION TO GRADE -REMOVE WRAP FROM TREES, AS IT BORE TO IT'S PREVIOUSLY EXISTING REMOVE ALL TAGS, LABELS, STRINGS, ETC. GRADE. PLANT TREE 50mm ABOVE DESIRED GRADE TO ALLOW FOR SOME SETTLING. - ABORGARD PLASTIC FORMS 25cm HIGH PLACE IN CENTRE OF PIT 75mm SHREDDED BARK MULCH ---- FORM A SOIL SAUCER 125mm IN DEPTH, 1000-1200mm O.D. AND FILL WITH WATER. SOON AFTER WATER HAS FRACTURE THE ENTIRE PERIMETER -OF TREE PIT WITH A HAND SPADE. TWO CONCENTRIC RINGS IN HEAVILY FINISHED BEEN ABSORBED, COVER WITH APPROX 100mm OF WOODCHIP MULCH TAPERED COMPACTED SOILS. GRADE TO GROUND LEVEL AT THE TRUNK. LOOSEN SURFACE SOIL OF -PLANTING HOLE. - PREPARED SOIL MIX (SEE NOTE) CAREFULLY REMOVE ANY LOOSE SOIL AROUND TRUNK. TOP OF ROOTBALL — SUBSOIL SCARIFIED. SHOULD NOT BE DISTURBED OR COVERED WITH SOIL. SOAK BACKFILLED AREA TO ENSURE FULL CONTACT PLACE ROOTBALL ON UNDISTURBED SOIL BETWEEN ROOTBALL AND BACKFILL. CUT AND LOOSEN APPROX. $\frac{1}{2}$ OF TWINE, BURLAP AND WIRE ON ROOTBALL. . TREES ARE SUBJECT TO ACCEPTANCE OF CITY. REJECTED ALL TWINE AND BURLAP MUST BE TREES SHALL BE REMOVED FROM WORK SITE. BIO-DEGRADABLE

. SOAK ROOT BALL PRIOR TO MOVING.

HIGH PHOSPHOROUS FERTILIZER (0-20-0).

ALL PLANT STOCK TO BE COVERED WHILE IN TRANSIT.

TREES LESS THAN 125cm IN HEIGHT DO NOT HAVE TO BE STAKED.

SOIL MIX: 4 PARTS TOPSOIL, 1 PART COMPOST, 1 PART SHREDDED PEAT & APPLICATION OF

SAUCER SHALL BE SOAKED WITH WATER & MULCHED IMMEDIATELY FOLLOWING PLANTING.


3 TYP. CONIFEROUS TREE PLANTING DETAIL A1.20 SCALE NTS

2. TREES SHALL BE REJECTED FOR ANY ONE OF THE


FOLLOWING: DOUBLE LEADERS, DAMAGED ROOT BALLS, TRUNK


DAMAGE, SPECIES NON-CONFORMING TO SPECIFICATIONS. GIRDLED TRUNKS. POORLY DEVELOPED CROWN, ROOT BALL

NOT SIZED ACCORDING TO CANADIAN NURSERIES TRADE ASSOCIATION EXCESSIVELY DRIED LEAVES.

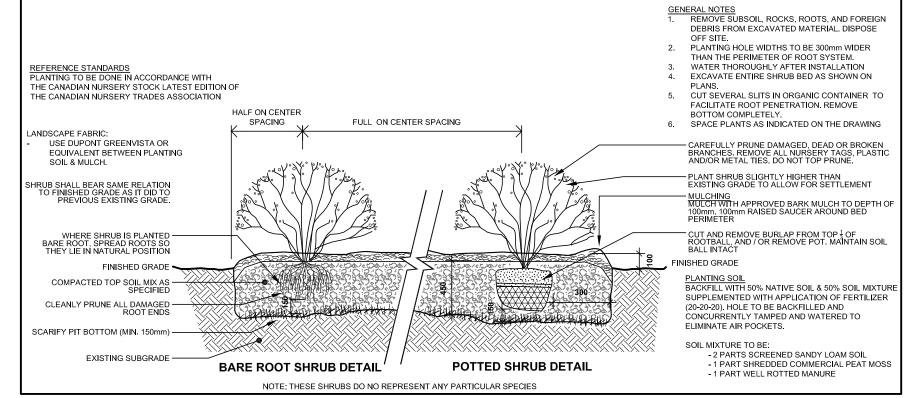

2 SHRUB BED PLANTING DETAIL (TYP.) A1.20 SCALE: NTS

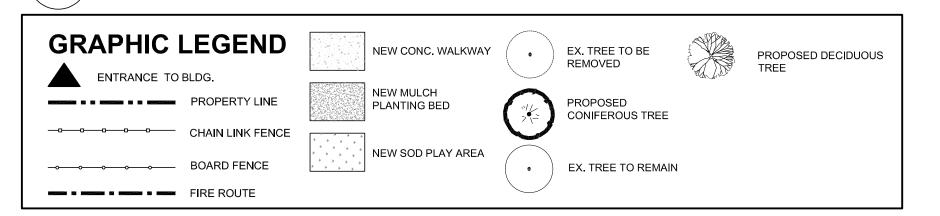

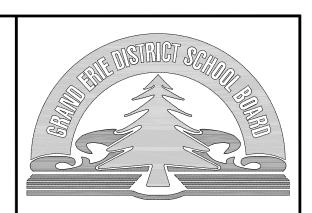

LEGEND

BARRIER FREE BOL BOLLARD CATCH BASIN CHAIN LINK FENCE CLR. CLEAR CONC CONCRETE

CONCRETE WALK DBL DOUBLE DEPRESSED CURB DPS DESIGNATED PARKING SIGN EXISTING ITEM

FLAG POLE FIRE HYDRANT DESIGNATED FIRE ROUTE SIGN LIGHT STANDARD

MAX MAXIMUM MH MAN HOLE MIN MINIMUM MW MONITORING WELL O/H OVER HEAD STANDARD IRON BAR

TO BE DETERMINED

TRAFFIC SIGN OR STOP SIGN UTILITY POLE WATER VALVE

6	ISSUED FOR TENDER	2024-04-22	
5	ISSUED FOR BUILDING PERMIT	2024-04-17	
4	RE-ISSUED FOR SITE PLAN APPROVAL	2024-01-08	
3	RE-ISSUED FOR SITE PLAN APPROVAL	2023-09-29	
2	ISSUED FOR COST ESTIMATE	2023-07-27	
1	ISSUED FOR SITE PLAN APPROVAL	2023-04-12	
NO	REVISIONS	DATE	
DRA	DRAWINGS ARE NOT TO BE SCALED. CONTRACTOR MUST		

HECK AND VERIFY ALL DIMENSIONS AND CONDITIONS ON

THE PROJECT: AND MUST REPORT ANY DISCREPANCIES TO

HE ARCHITECTS BEFORE PROCEEDING WITH THE WORK

THOUT THE WRITTEN APPROVAL OF THE ARCHITECTS.

BANBURY HEIGHTS SCHOOL CHILD CARE CENTRE **ADDITION** 141 BANBURY ROAD

BRANTFORD, ON. N3P 1E3

LANDSCAPE PLAN AND **DETAILS**


GRGURIC ARCHITECTS **INCORPORATED**




28 KING STREET EAST, UNIT B STONEY CREEK, ONTARIO, L8G 1J8 Tel. 905-664-8735 Fax. 905-664-8737 Web: www.2gai.com

SCALE:	PROJECT:
AS NOTED	0000
START DATE:	2022-0
AUGUST 2022	
DRAWN	DRAWING:


CHECKED

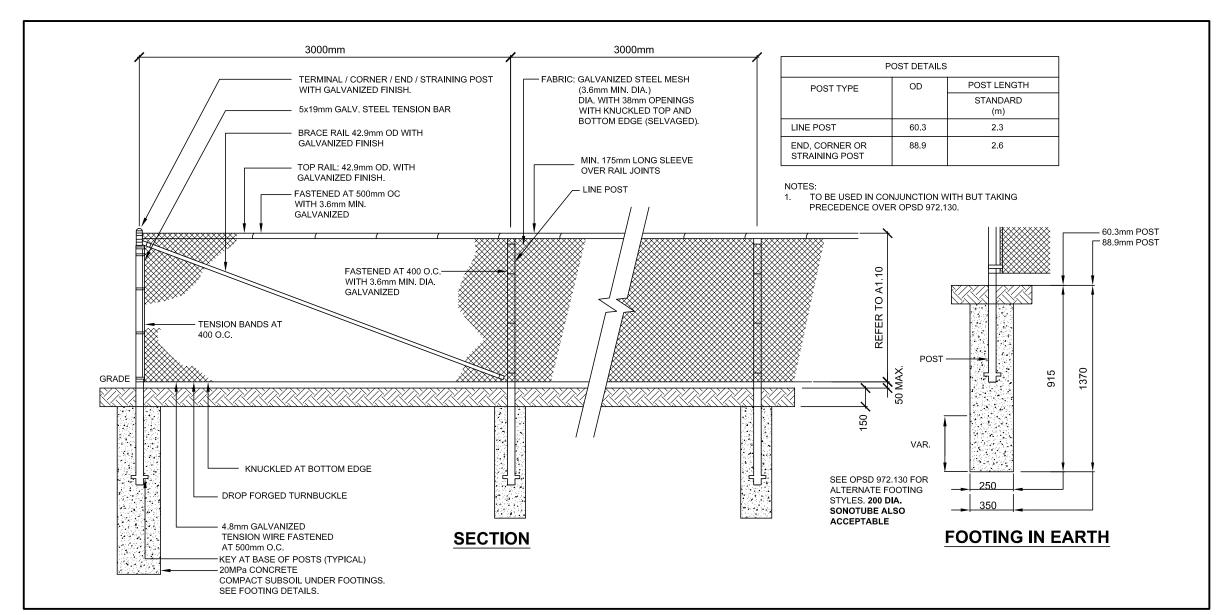

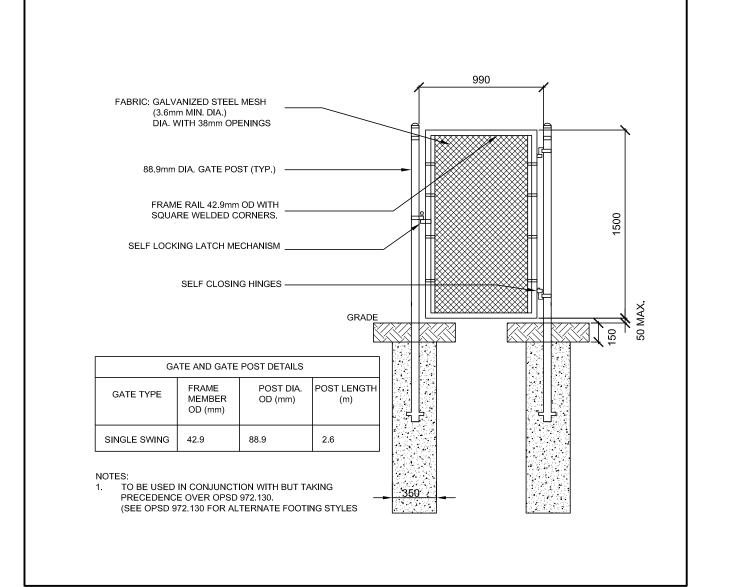

2 CHAIN LINK GATE DETAIL

A1.30 SCALE NTS

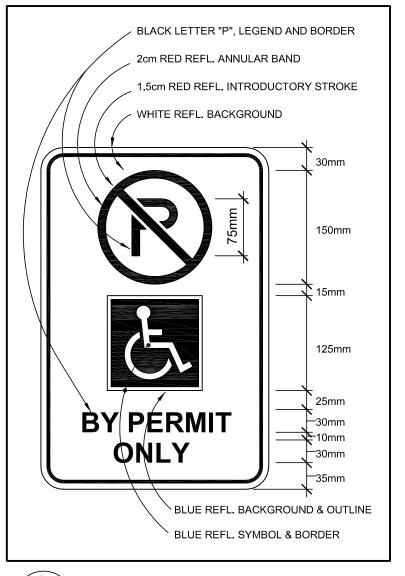


3 ACCESSIBLE PARKING SIGN A1.30 SCALE 1:5

1 CHAIN LINK FENCE, GALVANIZED - 1.2m HIGH

4 TYPICAL SIGN POST DETAIL


A1.30 SCALE 1:20

A1.30 SCALE NTS

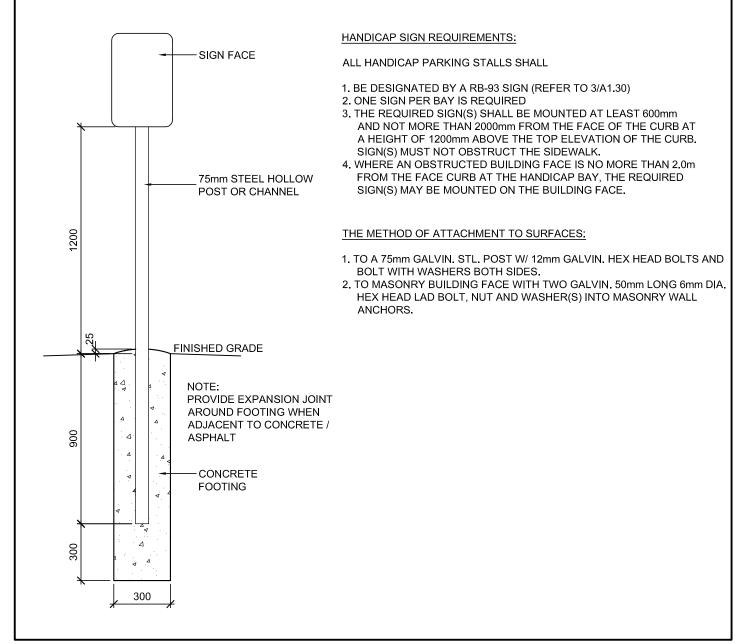

RB-21: ONE-WAY SIGN SIZE: 300mm x 900mm FONT: N/A LEGEND & BORDER: WHITE REFLECTIVE BACKGROUND: BLACK

5 ONE-WAY TRAFFIC SIGN A1.30 SCALE 1:5

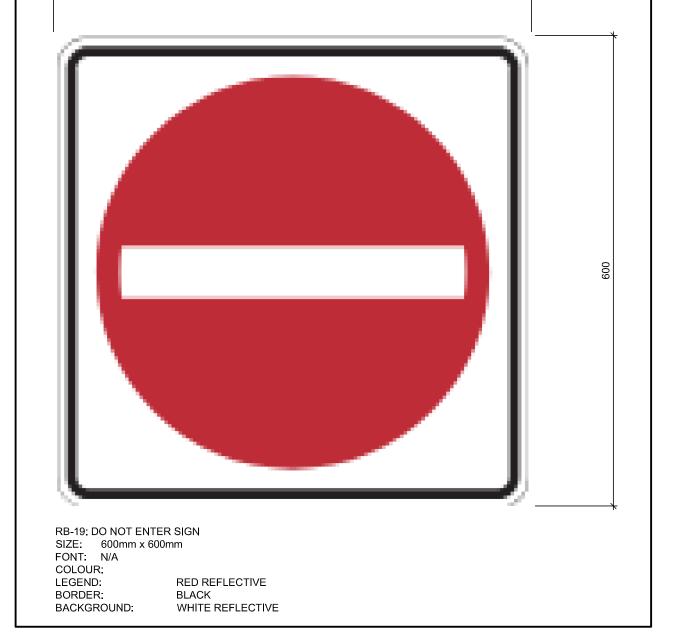

6 DO NOT ENTER SIGN A1.30 SCALE 1:5

<u>LEGEND</u>

BARRIER FREE BOL BOLLARD CB CATCH BASIN
CLF CHAIN LINK F
CLR. CLEAR
CONC CONCRETE
CW CONCRETE W
DBL DOUBLE
DC DEPRESSED
DPS DESIGNATED
EY EXISTING ITE CATCH BASIN CHAIN LINK FENCE

CONCRETE WALK DEPRESSED CURB DESIGNATED PARKING SIGN EXISTING ITEM FLAG POLE FIRE HYDRANT

DESIGNATED FIRE ROUTE SIGN LIGHT STANDARD MAX MAXIMUM MAN HOLE MINIMUM MONITORING WELL

MH MIN MW O/H SIB TBD OVER HEAD STANDARD IRON BAR TO BE DETERMINED TRAFFIC SIGN OR STOP SIGN UTILITY POLE

WV WATER VALVE

ISSUED FOR TENDER 2024-04-22 ISSUED FOR BUILDING PERMIT 2024-04-17 RE-ISSUED FOR SITE PLAN APPROVAL 2024-01-08 ISSUED FOR CLIENT REVIEW RE-ISSUED FOR SITE PLAN APPROVAL 2023-09-29 ISSUED FOR COST ESTIMATE 2023-07-2 ISSUED FOR SITE PLAN APPROVAL | 2023-04-12 REVISIONS DATE

DRAWINGS ARE NOT TO BE SCALED. CONTRACTOR MUST THE PROJECT; AND MUST REPORT ANY DISCREPANCIES TO THE ARCHITECTS BEFORE PROCEEDING WITH THE WORK. /ITHOUT THE WRITTEN APPROVAL OF THE ARCHITECTS.

BANBURY HEIGHTS SCHOOL CHILD CARE CENTRE ADDITION 141 BANBURY ROAD BRANTFORD, ON. N3P 1E3

SITE DETAILS


GRGURIC ARCHITECTS **INCORPORATED**



28 KING STREET EAST, UNIT B STONEY CREEK, ONTARIO, L8G 1J8 Tel. 905-664-8735 Fax. 905-664-8737 Web: www.2gai.com

PROJECT: SCALE AS NOTED START DATE: AUGUST 2022

DRAWN D.W. CHECKED

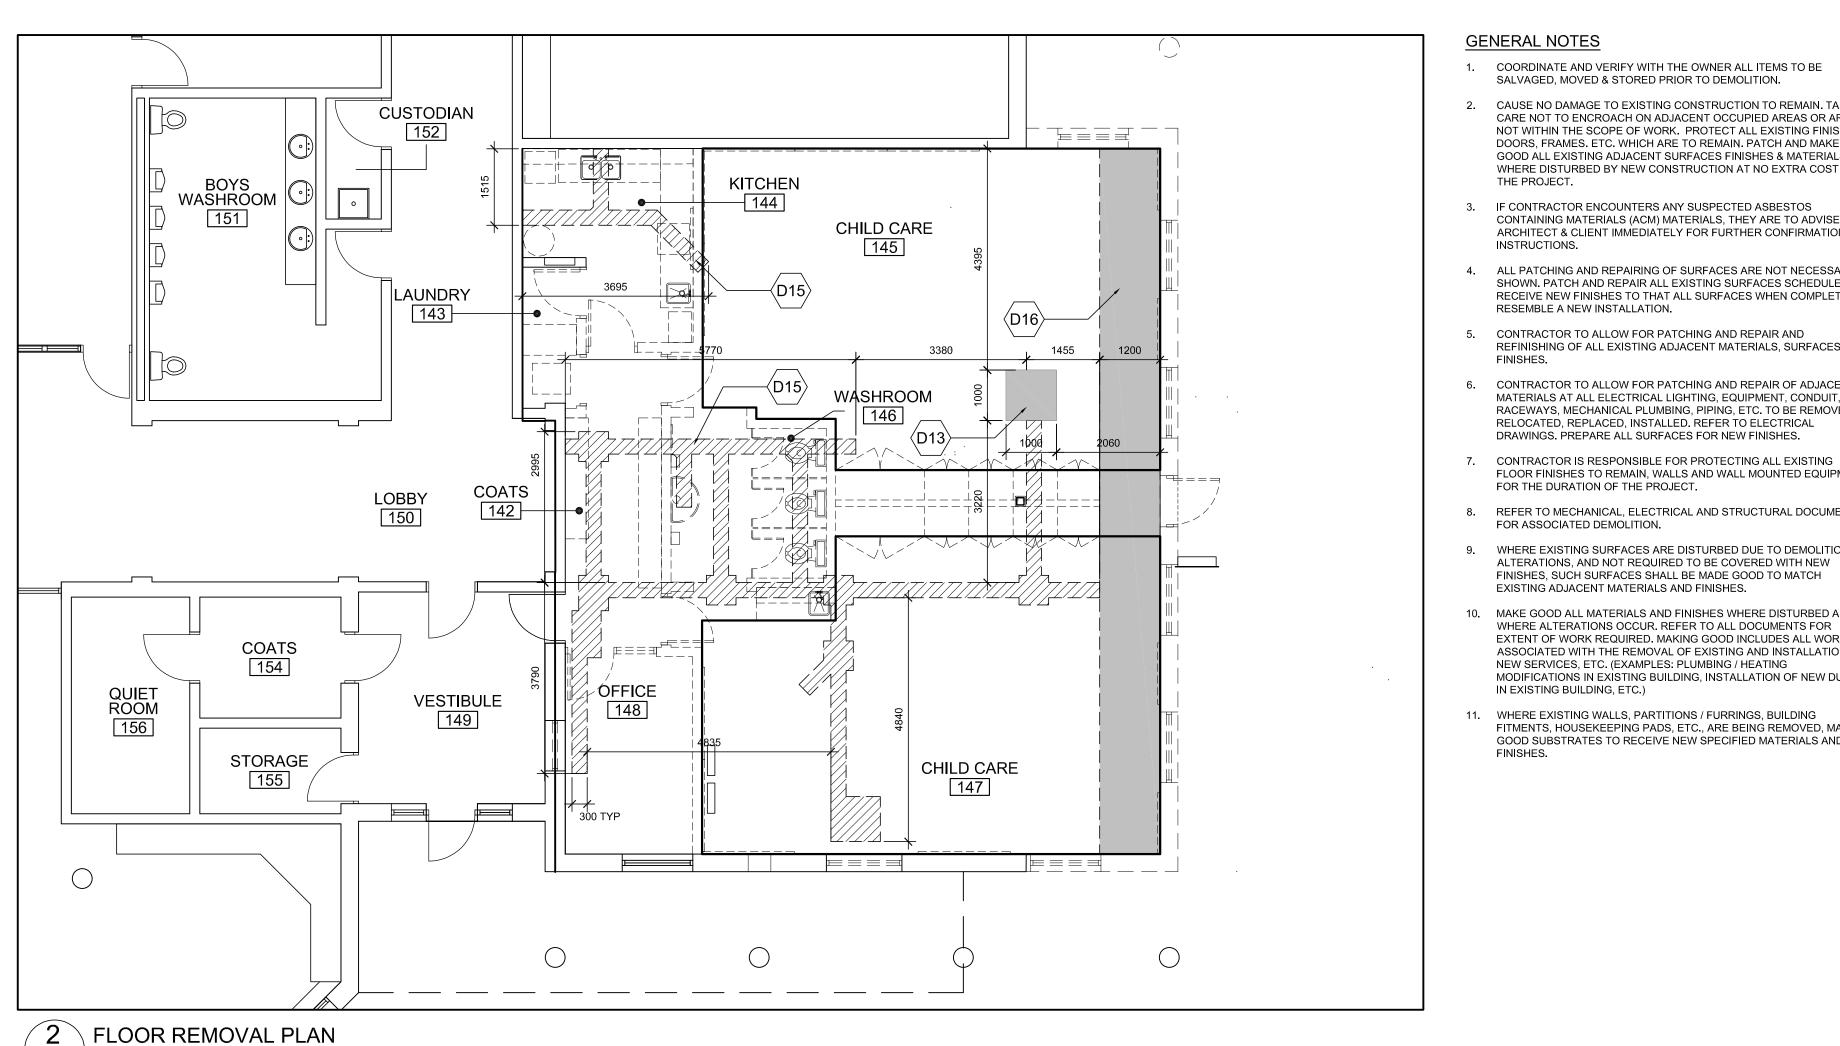

GENERAL NOTES

- 1. COORDINATE AND VERIFY WITH THE OWNER ALL ITEMS TO BE SALVAGED, MOVED & STORED PRIOR TO DEMOLITION.
- CAUSE NO DAMAGE TO EXISTING CONSTRUCTION TO REMAIN. TAKE CARE NOT TO ENCROACH ON ADJACENT OCCUPIED AREAS OR AREAS NOT WITHIN THE SCOPE OF WORK. PROTECT ALL EXISTING FINISHES, DOORS, FRAMES. ETC. WHICH ARE TO REMAIN. PATCH AND MAKE GOOD ALL EXISTING ADJACENT SURFACES FINISHES & MATERIALS WHERE DISTURBED BY NEW CONSTRUCTION AT NO EXTRA COST TO THE PROJECT.
- 3. IF CONTRACTOR ENCOUNTERS ANY SUSPECTED ASBESTOS CONTAINING MATERIALS (ACM) MATERIALS, THEY ARE TO ADVISE ARCHITECT & CLIENT IMMEDIATELY FOR FURTHER CONFIRMATION & INSTRUCTIONS.
- 4. ALL PATCHING AND REPAIRING OF SURFACES ARE NOT NECESSARILY SHOWN. PATCH AND REPAIR ALL EXISTING SURFACES SCHEDULED TO RECEIVE NEW FINISHES TO THAT ALL SURFACES WHEN COMPLETE RESEMBLE A NEW INSTALLATION.
- 5. CONTRACTOR TO ALLOW FOR PATCHING AND REPAIR AND REFINISHING OF ALL EXISTING ADJACENT MATERIALS, SURFACES &
- 6. CONTRACTOR TO ALLOW FOR PATCHING AND REPAIR OF ADJACENT MATERIALS AT ALL ELECTRICAL LIGHTING, EQUIPMENT, CONDUIT, RACEWAYS, MECHANICAL PLUMBING, PIPING, ETC. TO BE REMOVED, RELOCATED, REPLACED, INSTALLED. REFER TO ELECTRICAL DRAWINGS. PREPARE ALL SURFACES FOR NEW FINISHES.
- FLOOR FINISHES TO REMAIN, WALLS AND WALL MOUNTED EQUIPMENT FOR THE DURATION OF THE PROJECT.
- 8. REFER TO MECHANICAL, ELECTRICAL AND STRUCTURAL DOCUMENTS FOR ASSOCIATED DEMOLITION.
- 9. WHERE EXISTING SURFACES ARE DISTURBED DUE TO DEMOLITION OR ALTERATIONS, AND NOT REQUIRED TO BE COVERED WITH NEW FINISHES, SUCH SURFACES SHALL BE MADE GOOD TO MATCH EXISTING ADJACENT MATERIALS AND FINISHES.
- 10. MAKE GOOD ALL MATERIALS AND FINISHES WHERE DISTURBED AND WHERE ALTERATIONS OCCUR. REFER TO ALL DOCUMENTS FOR EXTENT OF WORK REQUIRED. MAKING GOOD INCLUDES ALL WORK ASSOCIATED WITH THE REMOVAL OF EXISTING AND INSTALLATION OF NEW SERVICES, ETC. (EXAMPLES: PLUMBING / HEATING MODIFICATIONS IN EXISTING BUILDING, INSTALLATION OF NEW DUCTS IN EXISTING BUILDING, ETC.)
- 11. WHERE EXISTING WALLS, PARTITIONS / FURRINGS, BUILDING FITMENTS, HOUSEKEEPING PADS, ETC., ARE BEING REMOVED, MAKE GOOD SUBSTRATES TO RECEIVE NEW SPECIFIED MATERIALS AND


DEMOLITION NOTES


- EXISTING CONCRETE BLOCK W/ BRICK VENEER EXTERIOR WALL TO BE REMOVED AND DISPOSED OF TO EXTENT SHOWN. EXISTING POURED CONCRETE FOUNDATION WALL AND FOOTING TO BE REMOVED AND DISPOSED OF.
- EXISTING CONCRETE BLOCK WALL TO BE REMOVED AND DISPOSED OF. PATCH AND REPAIR EXISTING WALLS AND FLOOR TO REMAIN AS REQUIRED AND MAKE READY TO RECEIVE NEW
- EXISTING HOLLOW METAL DOOR, FRAME AND GLASS TO BE REMOVED AND DISPOSED OF. PATCH AND REPAIR AS REQUIRED EXISTING WALL TO REMAIN AND MAKE READY TO RECEIVE NEW
- EXISTING ALUMINIUM WINDOW FRAMES AND GLASS TO BE REMOVED AND DISPOSED OF. EXISTING PLAM WINDOW SILL TO BE REMOVED AND DISPOSED OF.
- EXISTING HOLLOW METAL WINDOW FRAMES AND GLASS TO BE REMOVED AND DISPOSED OF. PATCH AND REPAIR EXISTING OPENING AS REQUIRED TO MAKE READY TO RECEIVE NEW WALL
- EXISTING MILLWORK TO BE REMOVED AND DISPOSED OF. PATCH AND REPAIR EXISTING SURFACES TO REMAIN AS REQUIRED TO MATCH READY TO RECEIVE NEW FINISHES.
- EXISTING PLUMBING FIXTURES TO BE REMOVED AND DISPOSED OF. COORDINATE WITH MECHANICAL DRAWINGS.
- EXISTING METAL TOILET PARTITIONS TO BE REMOVED AND DISPOSED OF. PATCH AND REPAIR SURFACES TO REMAIN AND MAKE READY TO RECEIVE NEW FINISHES.
- EXISTING HOT WATER TANK TO BE REMOVED AND DISPOSED OF.

EXISTING APPLIANCES TO BE REMOVED AND RETURNED TO

- REFER TO AND COORDINATE WITH MECHANICAL AND ELECTRICAL DRAWINGS.
- EXISTING WALL HUNG ITEMS (EG DRAPES, TACK BOARDS, CHALK BOARDS, ETC.) TO BE REMOVED AND DISPOSED OF. PATCH AND REPAIR EXISTING SURFACES TO REMAIN AND MAKE READY TO RECEIVE NEW FINISHES.
- EXISTING FLOORING TO BE REMOVED AND DISPOSED OF. GRIND EXISTING CONCRETE FLOOR SLAB TO REMOVE ANY ADHESIVES AND MAKE SURFACE READY TO RECEIVE NEW FLOOR FINISH.
- CUT, REMOVED AND DISPOSE OF EX CONCRETE FLOOR SLAB (APPROX 100mm THK). REMOVE EX FILL FROM BELOW SLAB TO ALLOW FOR THE INSTALLATION OF NEW COLUMN FOOTING AND PIER. REFER TO AND COORDINATE WITH STRUCTURAL
- EXISTING CONCRETE COLUMN AND FOOTING TO BE REMOVED
- CUT, REMOVED AND DISPOSE OF EX CONCRETE FLOOR SLAB (APPROX 100mm THK). REMOVE EX FILL FROM BELOW SLAB TO ALLOW FOR THE REMOVAL OR INSTALLATION OF NEW UNDERGROUND PLUMBING. REFER TO AND COORDINATE WITH MECHANICAL DRAWINGS.
- CUT, REMOVED AND DISPOSE OF EX CONCRETE FLOOR SLAB (APPROX 100mm THK). REMOVE EX FILL FROM BELOW SLAB TO ALLOW FOR THE REMOVAL OF THE EXISTING FOUNDATION WALL AND FOOTING. REFER TO AND COORDINATE WITH STRUCTURAL

- EX SUSPENDED CEILING, GRID, WALL ANGLES AND HANGING WIRES TO BE REMOVED AND DISPOSED OF. PATCH AND REPAIR WALLS TO REMAIN WHERE WALL ANGLE WAS REMOVED AND MAKE READY TO RECEIVE NEW WALL FINISH.
- EX LIGHTS TO BE REMOVED AND DISPOSED OF. REFER TO AND COORDINATE WITH ELECTRICAL DRAWINGS.
- EX METAL FRAMED CANOPY AND SOFFIT TO BE REMOVED AND DISPOSED OF. REFER TO AND COORDINATE WITH STRUCTURAL DRAWINGS.
- EX GYPSUM BOARD BULKHEAD AND STUD FRAMING TO BE REMOVED AND DISPOSED OF.
- REMOVE AND DISPOSE OF EXISTING CONCRETE BLOCK AND FACE BRICK FOR NEW MECHANICAL OPENING. APPROXIMATE SIZE OF OPENING IS 450mm X 300mm. TOP OF OPENING TO BE LOCATED 2745mm ABOVE EXISTING FLOOR SLAB.

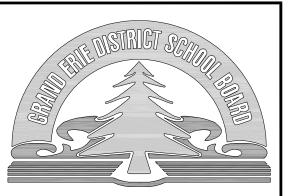

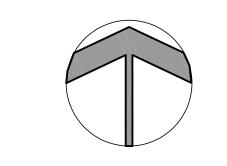

LEGEND

APPROX APPROXIMATE EX EXISTING ITEM THK THICK W/ WITH

3	ISSUED FOR TENDER	2024-04-22
2	ISSUED FOR BUILDING PERMIT	2024-04-17
1	ISSUED FOR COST ESTIMATE	2023-07-27
0	REVISIONS	DATE

RAWINGS ARE NOT TO BE SCALED. CONTRACTOR MUST HECK AND VERIFY ALL DIMENSIONS AND CONDITIONS ON THE PROJECT: AND MUST REPORT ANY DISCREPANCIES TO THE ARCHITECTS BEFORE PROCEEDING WITH THE WORK ITHOUT THE WRITTEN APPROVAL OF THE ARCHITECTS.

BANBURY HEIGHTS SCHOO CHILD CARE CENTRE **ADDITION** 141 BANBURY ROAD

BRANTFORD, ON. N3P 1E3


DEMOLITION PLANS




28 KING STREET EAST, UNIT B STONEY CREEK, ONTARIO, L8G 1J8 Tel. 905-664-8735 Fax. 905-664-8737 Web: www.2gai.com

PROJECT: AS NOTED START DATE: AUGUST 2022

DRAWN CHECKED

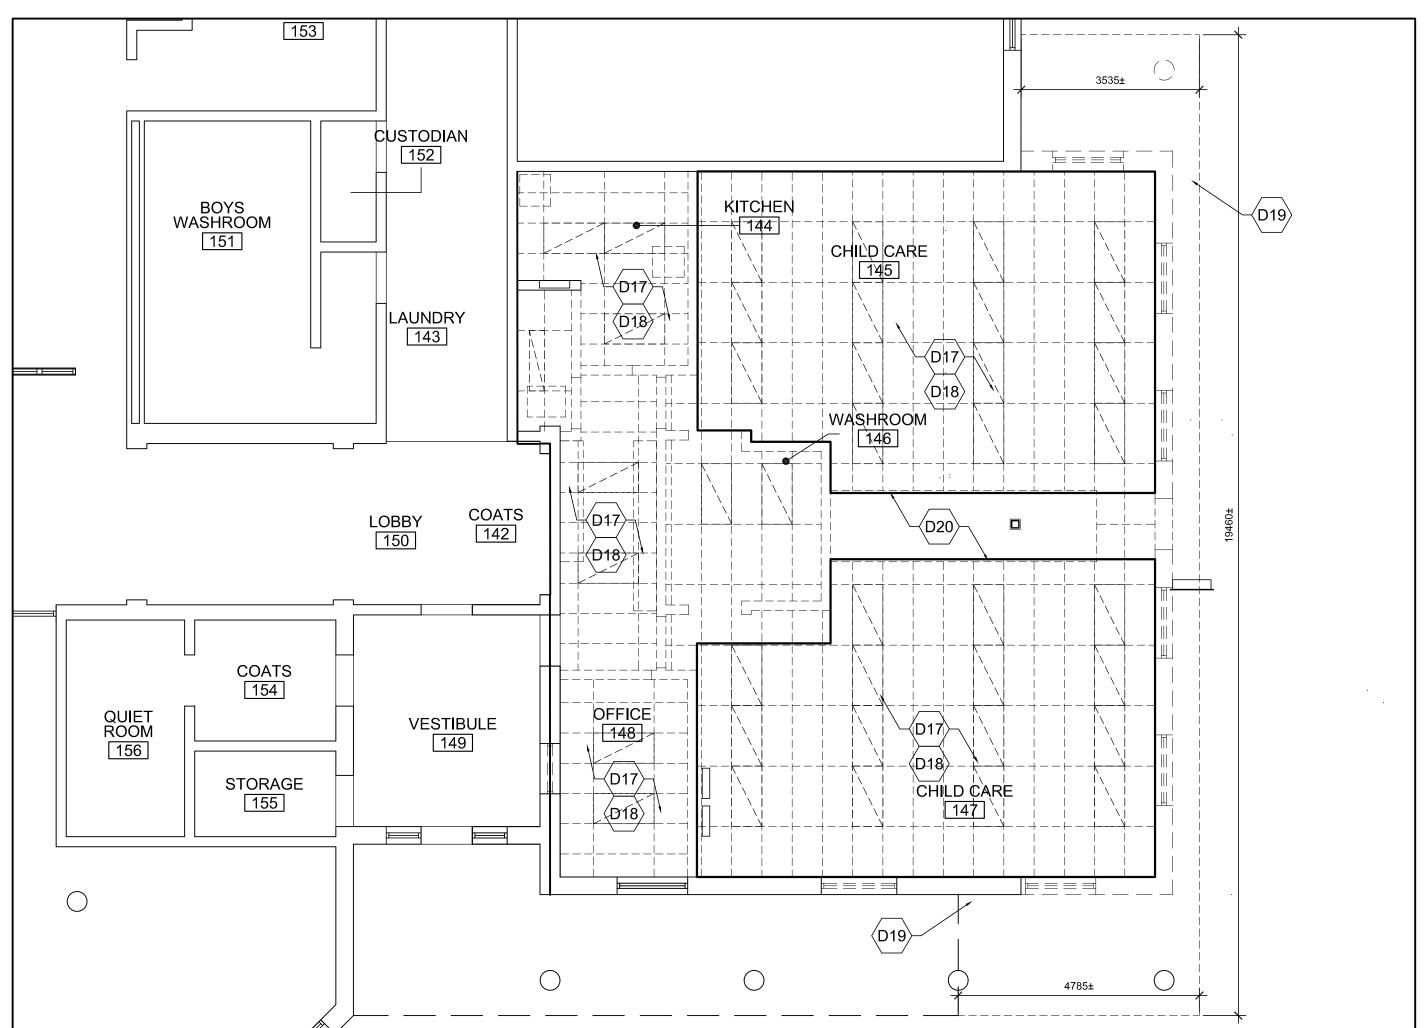

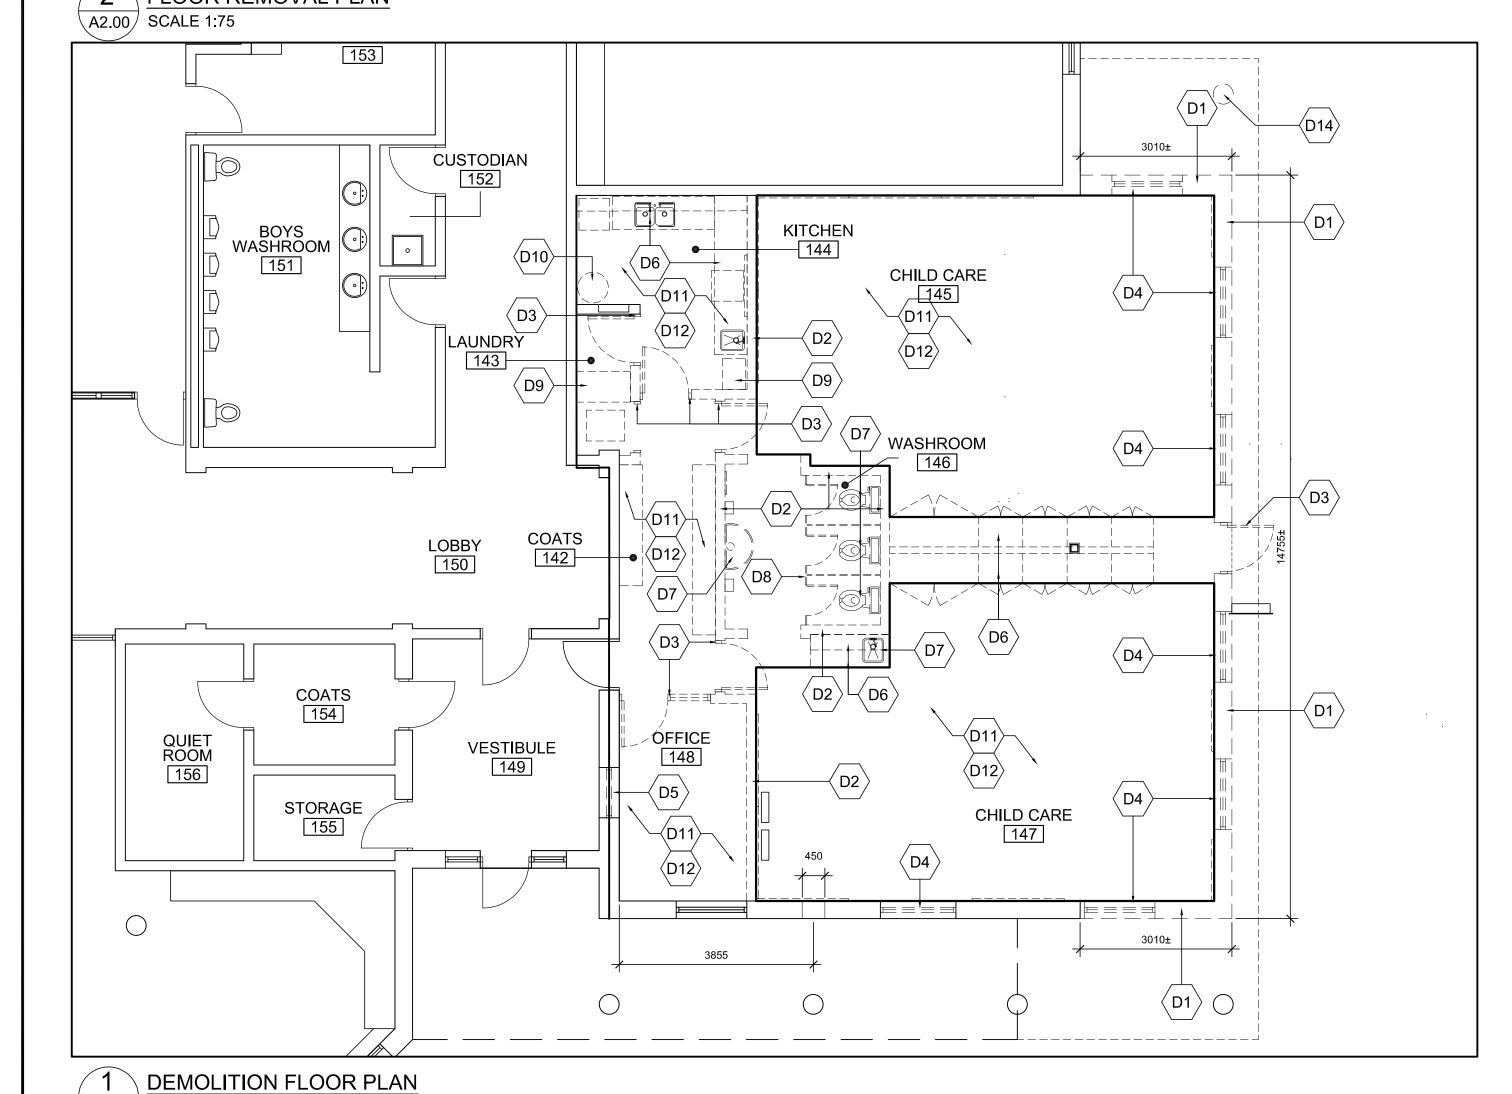

A2.00 SCALE 1.75

3 DEMOLITION REFLECTED CEILING PLAN A2.00 SCALE 1:75