




1 OVERALL EXISTING SITE PLAN
A100 1:500

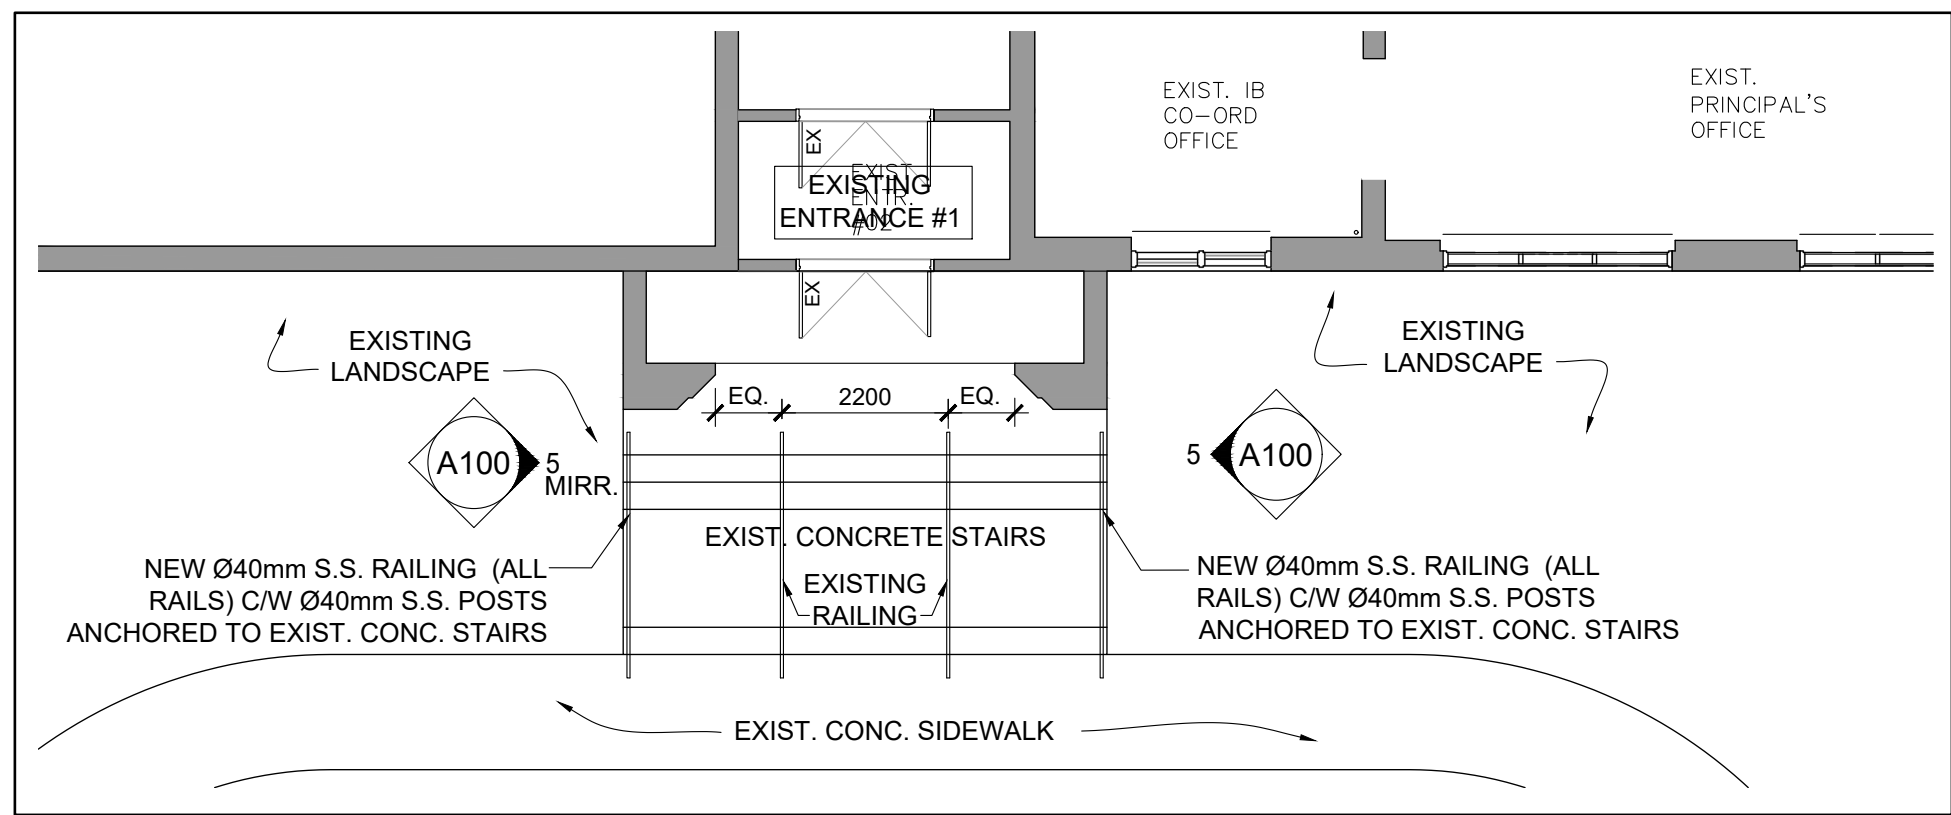


4 ADDITIONAL RAILING AT EXISTING EXTERIOR STAIRS - PLAN
A100 1:100

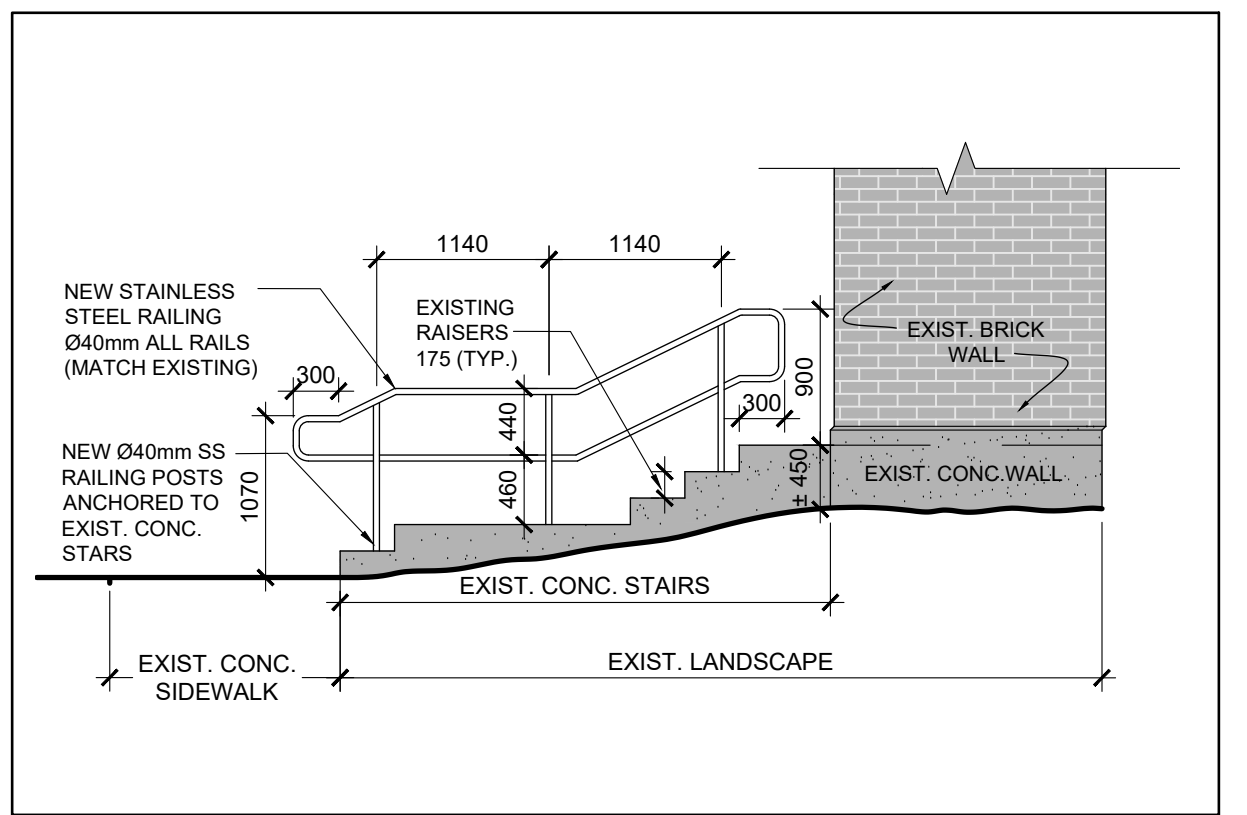

5 ENTRANCE #2 - NEW RAILING AT EXIST. EXTERIOR STAIR - ELEVATION
A100 1:50

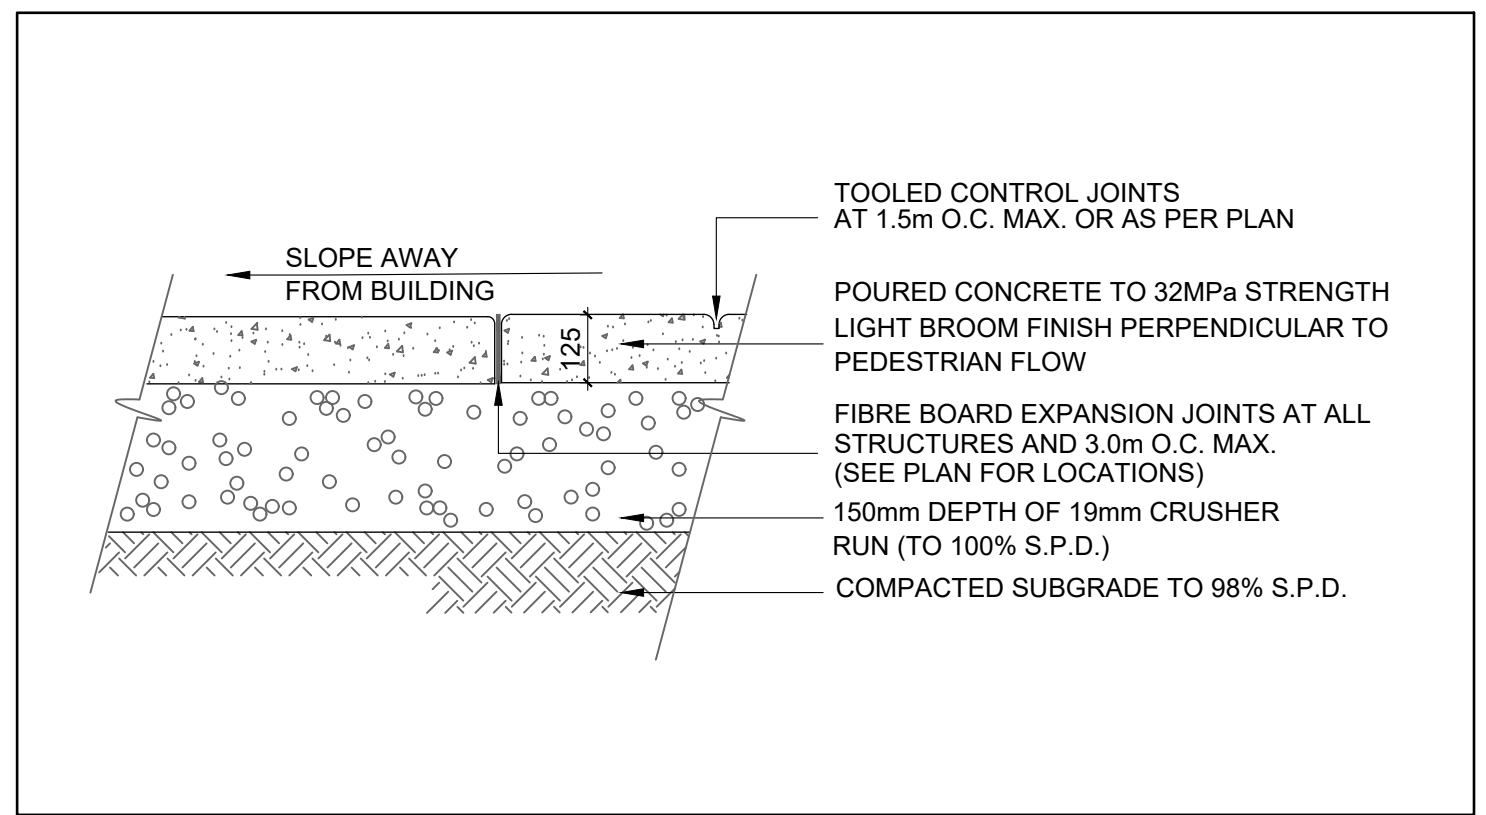

6 CONCRETE SIDEWALK DETAIL
A100 1:10

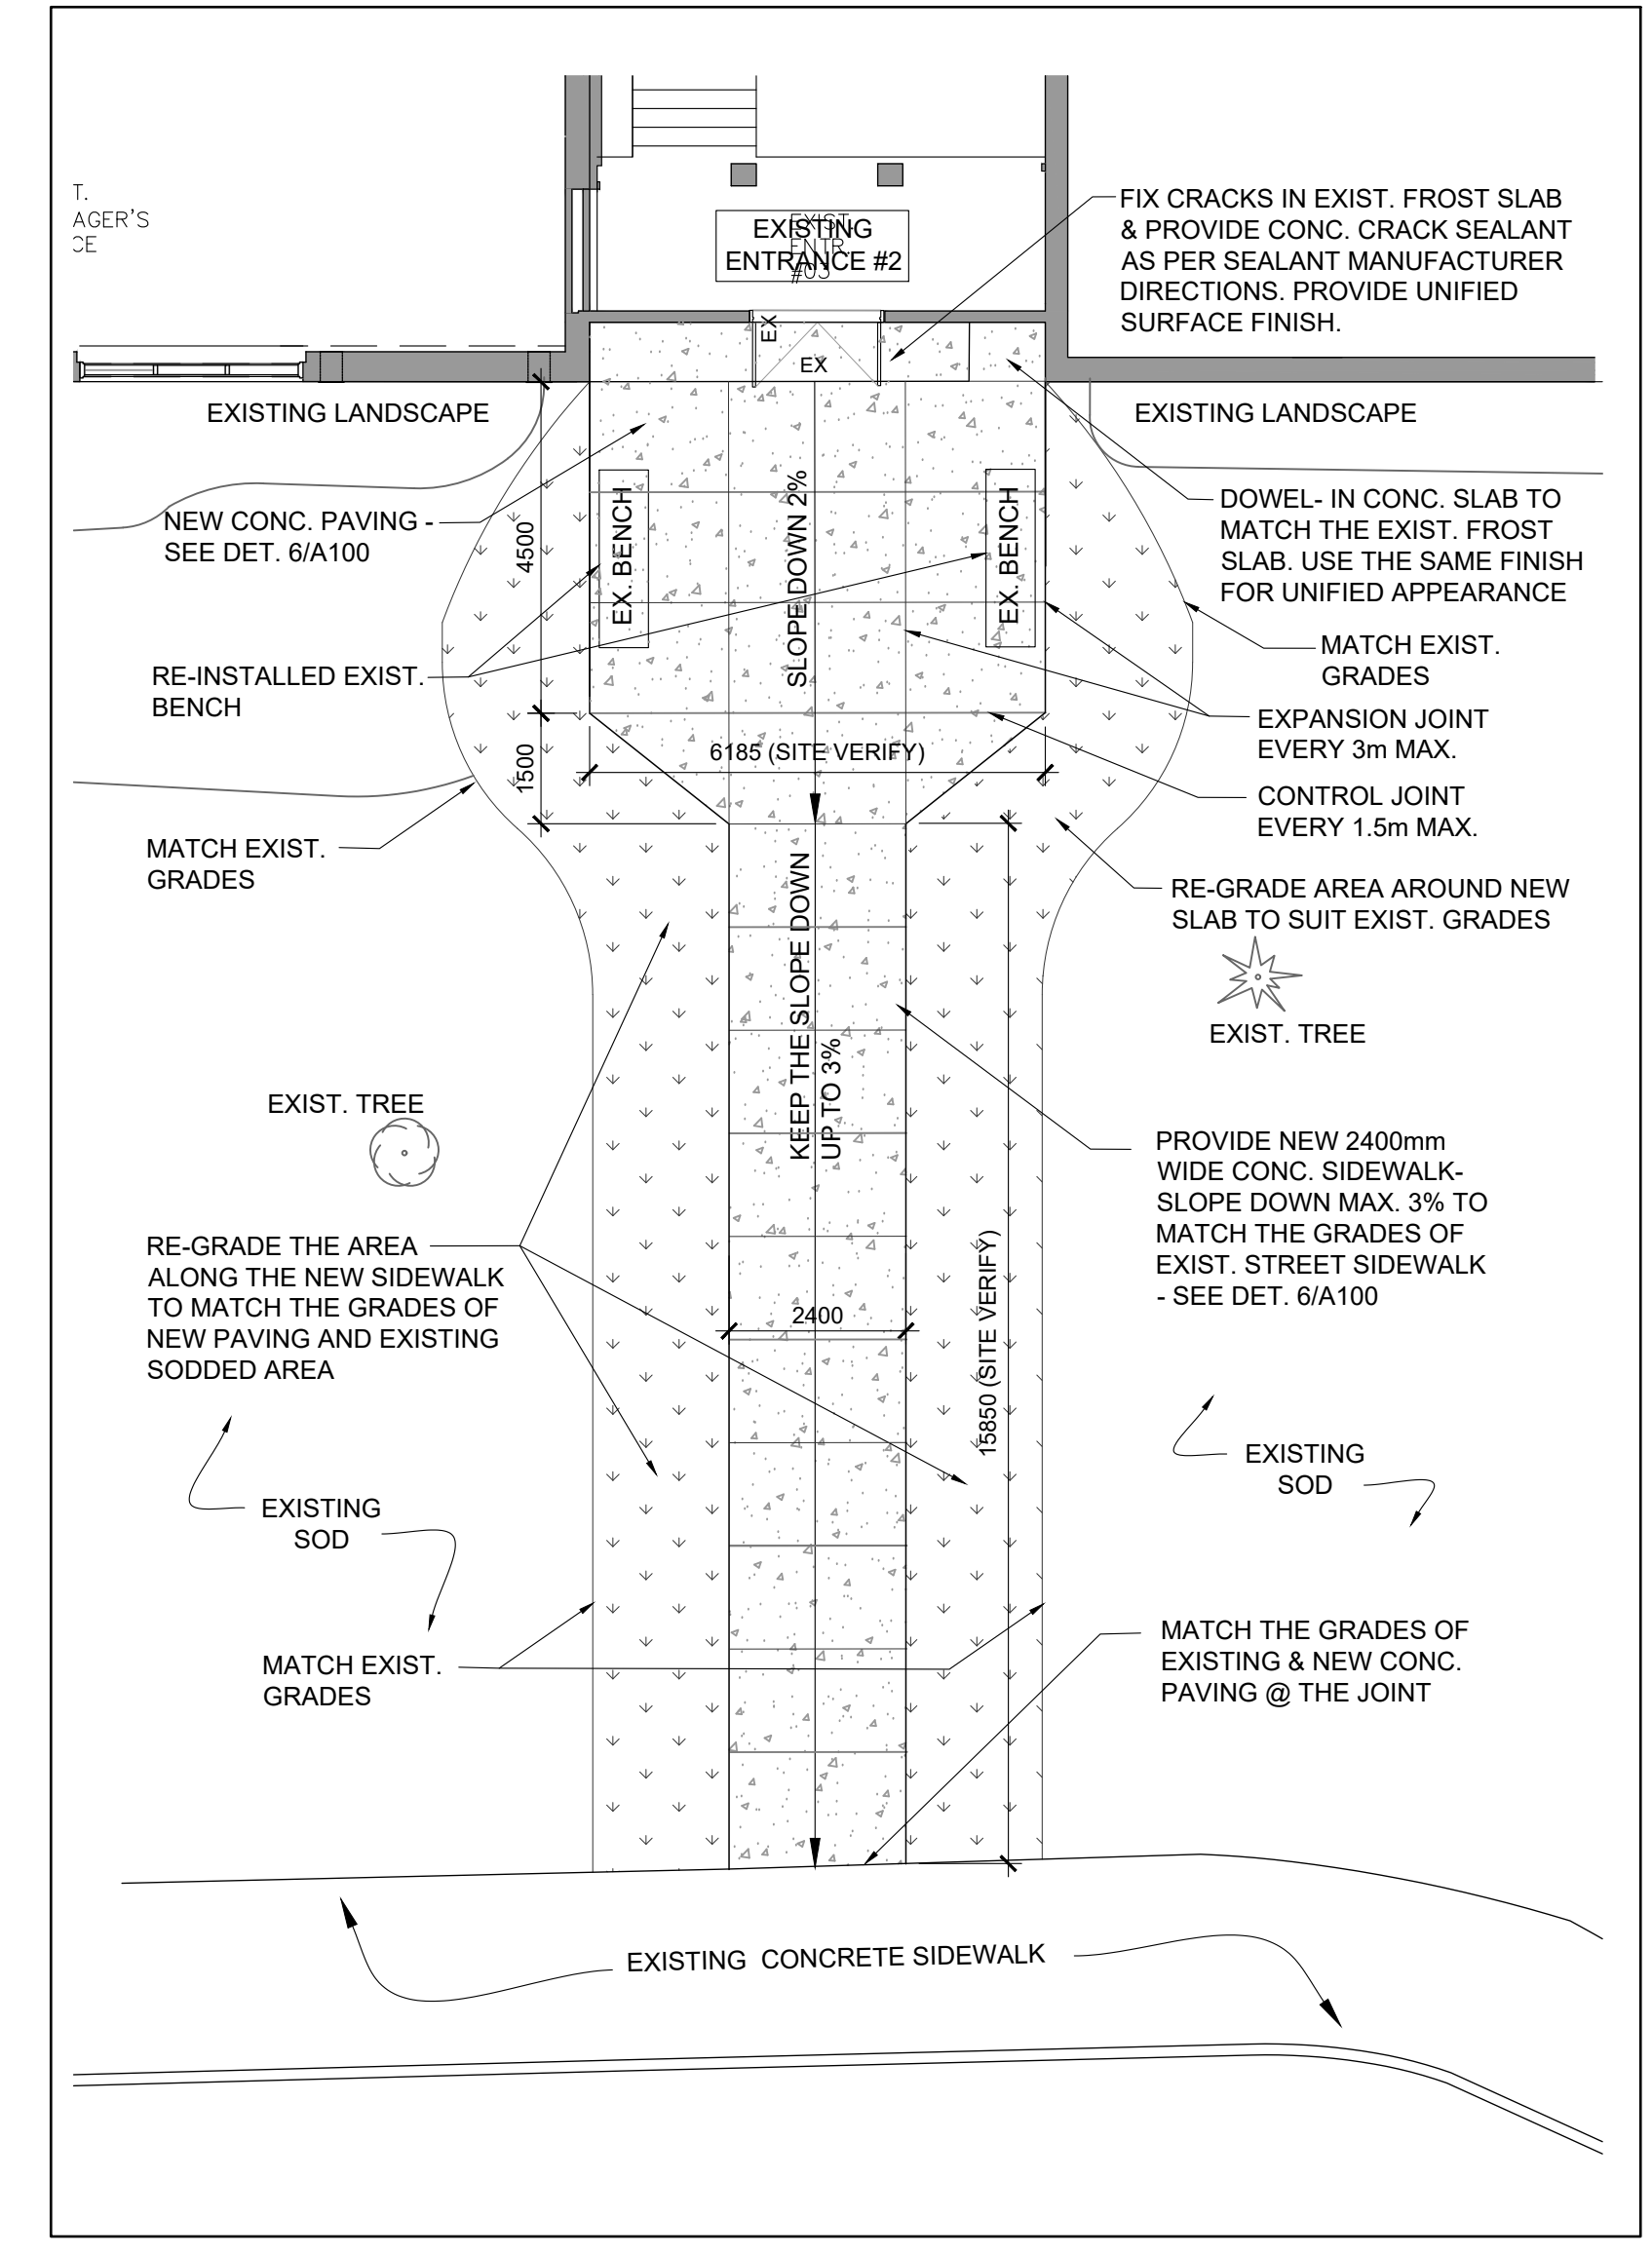


3 SITE PLAN - NEW CONCRETE WALKWAY @ ENTRANCE #3
A100 1:100

NOTES

- ALL CONSTRUCTION TO MEET ONTARIO BUILDING CODE REQUIREMENTS.
- ALL CONSTRUCTION WHETHER DETAILED ON PLAN OR NOT IS SUBJECT TO FIELD APPROVAL.
- REVISED PERMIT DRAWINGS MUST REMAIN AT THE JOB SITE UNTIL COMPLETION OF THE PROJECT.
- REVIEW OF THESE PLANS DOES NOT NECESSARILY GUARANTEE THAT THEY ARE IN CONFORMANCE WITH THE ONTARIO BUILDING CODE.
- IT IS THE OWNER/BUILDER'S RESPONSIBILITY TO CALL FOR INSPECTIONS IN ACCORDANCE WITH THE ONTARIO BUILDING CODE.

The ARCHITECT and/or PROFESSIONAL ENGINEERS shall be responsible for the field review of the building during construction to ensure conformance to the approved design. Field review reports must be submitted at least monthly to the Burlington Building Department. Prior to occupancy, the Architect and/or Professional Engineers must also submit a signed statement that, based upon their field review of the work falling within their discipline, they are of the opinion that such work has been carried out in general accordance with the approved plans.

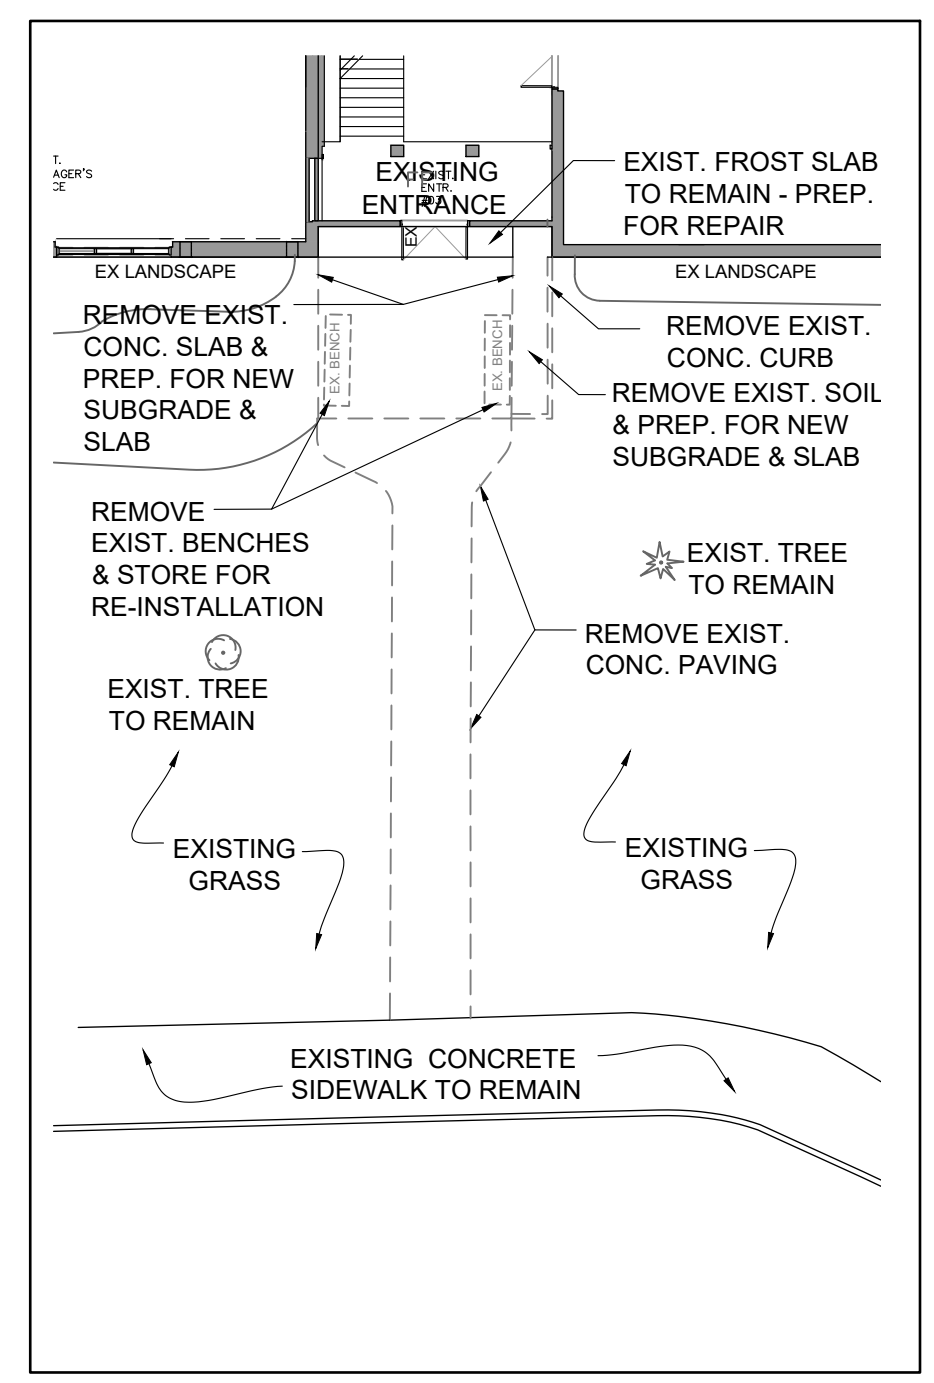

2 ENTRANCE #3 - SIDEWALK - DEMOLITION PLAN
A100 1:200

ALL ELECTRICAL WIRING MUST BE INSPECTED BY THE ELECTRICAL SAFETY AUTHORITY. SEPARATE INSPECTION APPLICATIONS (PERMITS) MUST BE FILED. FOR MORE INFORMATION PLEASE CALL ELECTRICAL SAFETY AUTHORITY CUSTOMER SERVICE CENTRE
PHONE 1-877-372-7233 FAX 1-800-667-4278

**BURLINGTON CENTRAL
H.S. RENOVATIONS**

1433 Baldwin Street
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Architect
sn/der
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Structural Consultants
Kalos Engineering Inc.
300 York Boulevard
Hamilton, Ontario, L8R 3K6
Tel: 905-333-9119

Mechanical and Electrical Consultants
CK Engineering Inc.
2400 Industrial Street
Burlington, Ontario, L7P 1A5
Tel: 905-631-1115

**CITY OF BURLINGTON
BUILDING SERVICES**


**REVIEWED
FOR PERMIT ISSUANCE**

DATE JAN 16 2024
PERMIT NUMBER 23-011806
EXAM EM

RECEIVED

JUNE 16 2023

CITY OF BURLINGTON
BUILDING DEPARTMENT

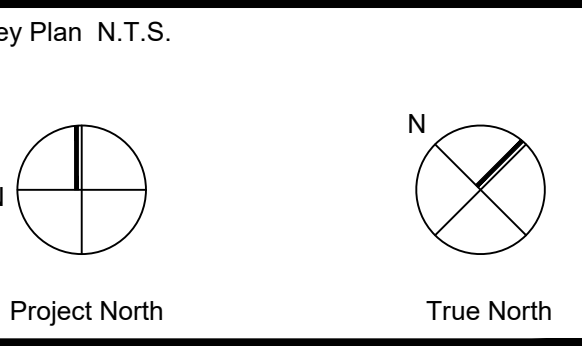

No.	Revisions	Date
2	ISSUED FOR PERMIT	2023/06/14
1	ISSUED FOR PC#14	2023/06/02
No.	Issue	Date

General Contractor shall check and verify all dimensions and report all errors and omissions to the Architect. Do not scale the drawings. Drawings shall not be used for construction purposes until issued by the Architect for construction.




Drawing Title:
SITE PLAN


Scale: AS NOTED Date: 05/26/2023

Drawn by: Checked by:
Job No. Drawing No.


All Exits and Access to Exits shall be clearly visible and accessible at all times.

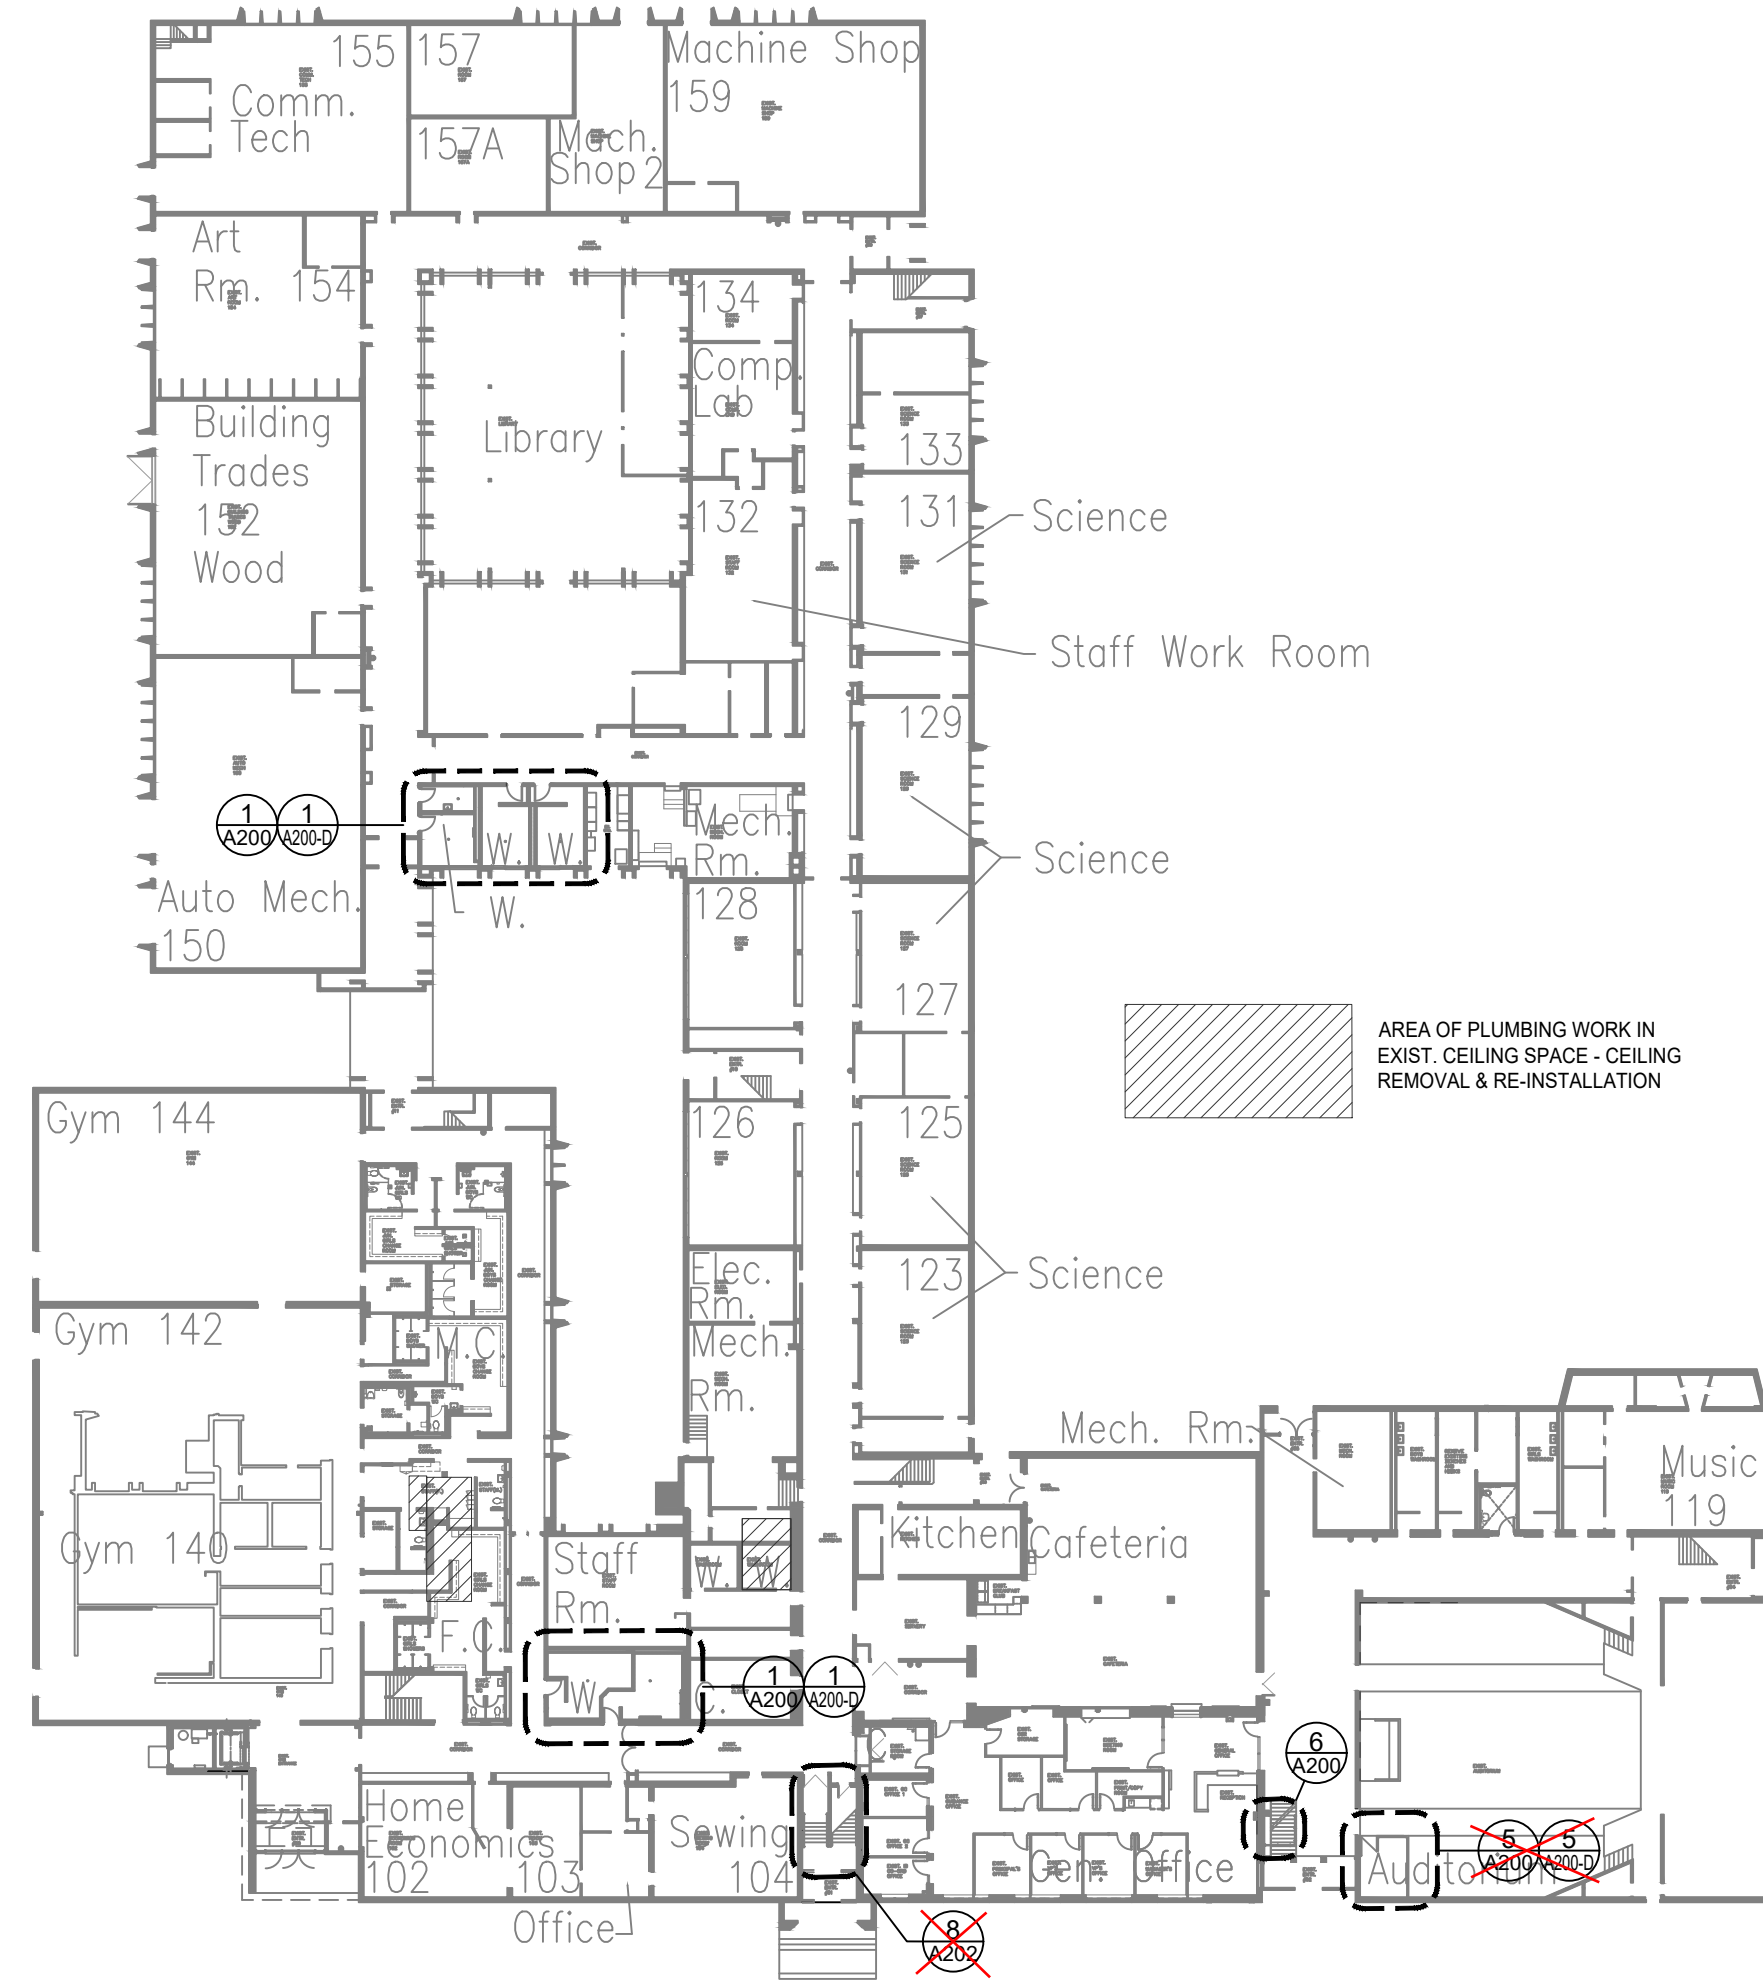

OVERALL FIRST FLOOR PLAN

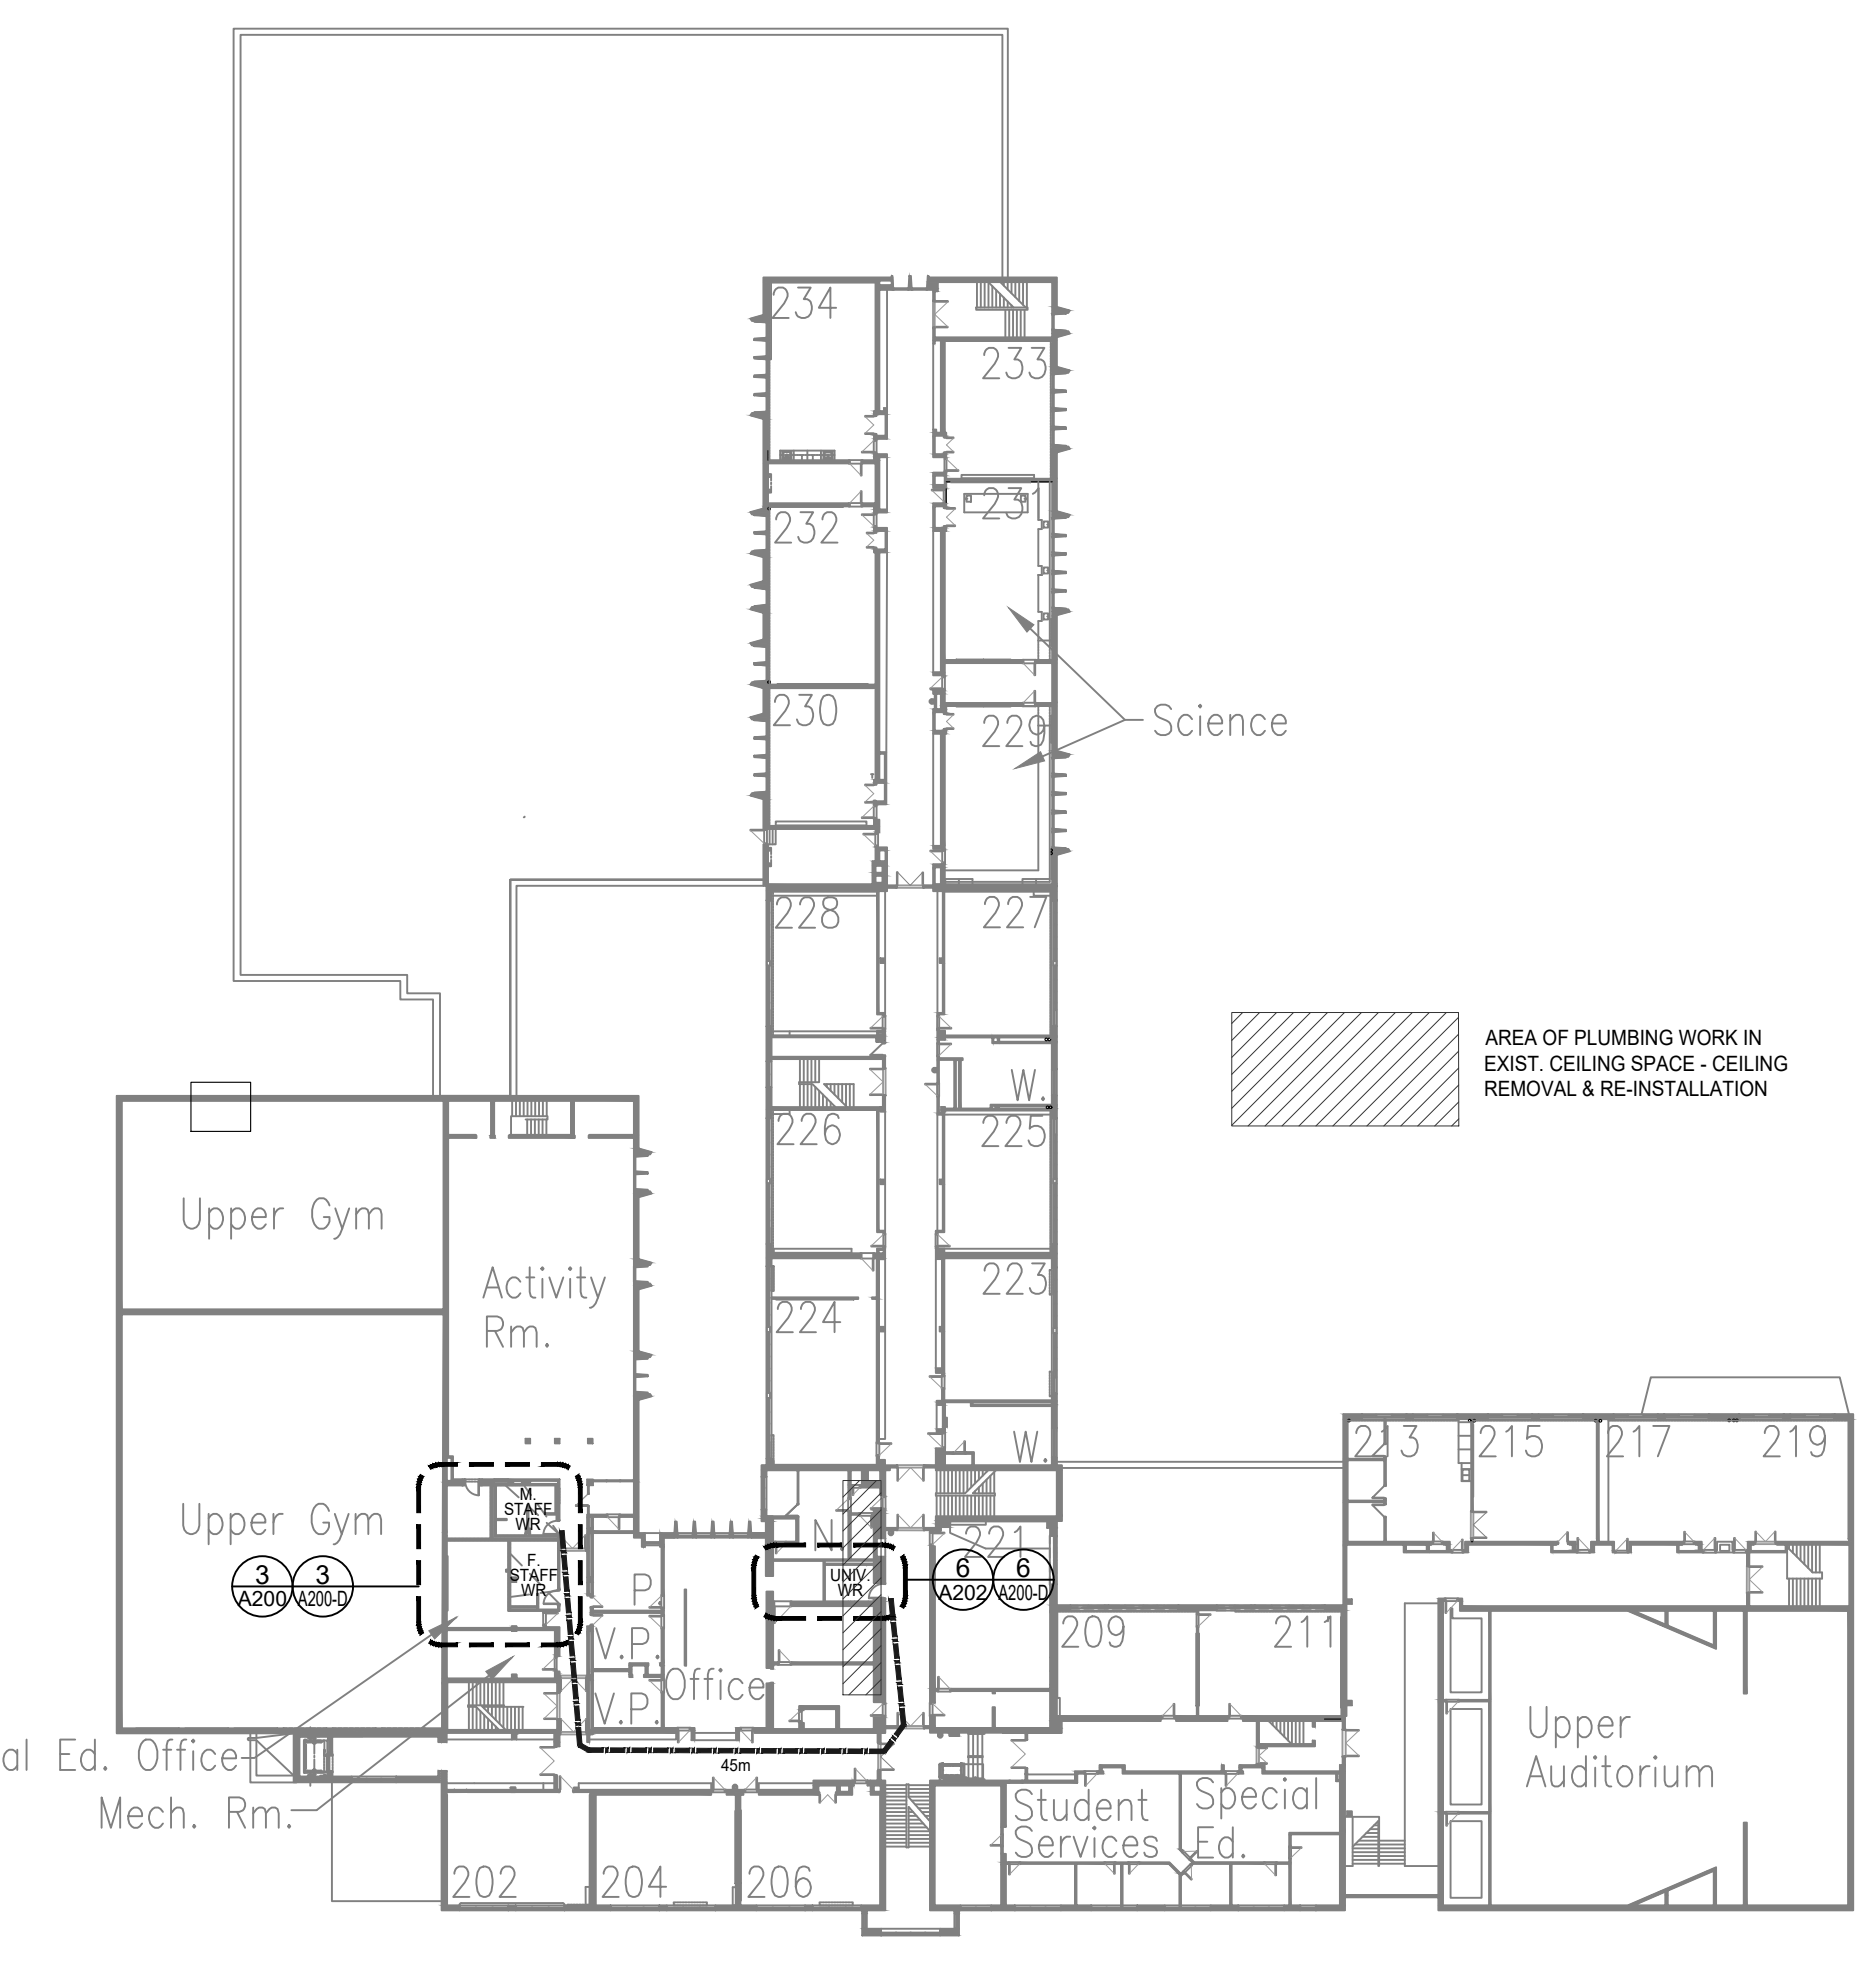

OVERALL SECOND FLOOR PLAN

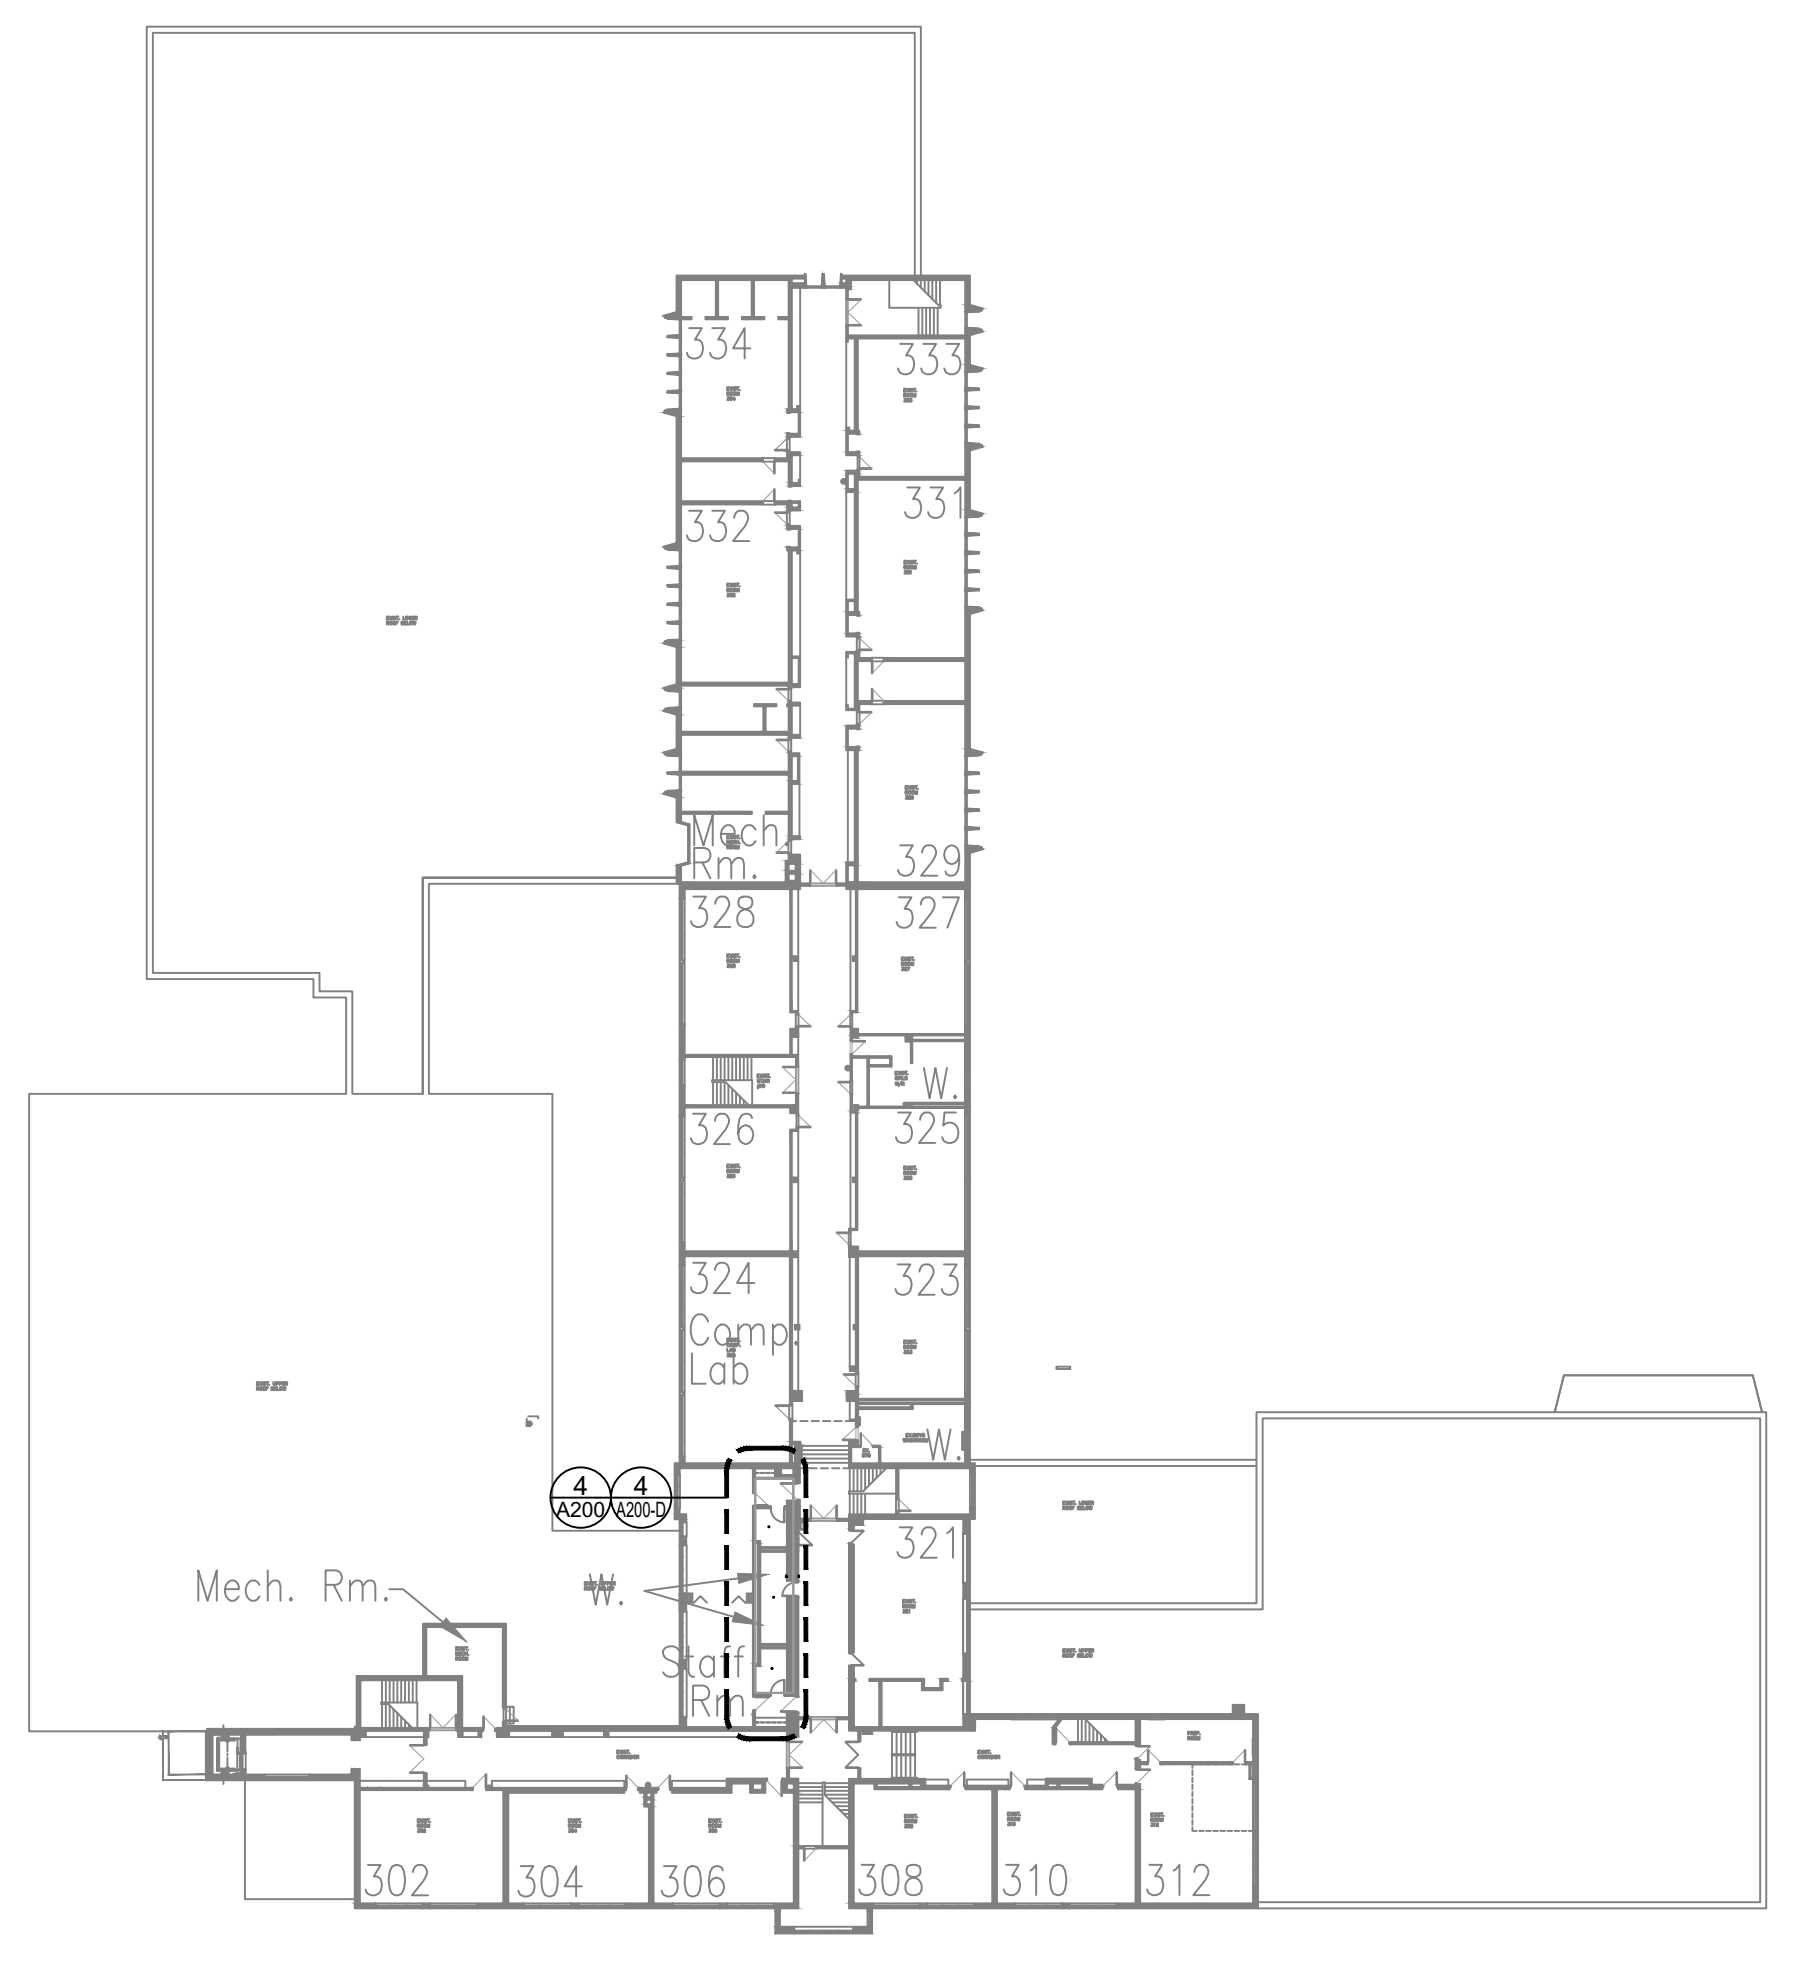

OVERALL THIRD FLOOR PLAN

Client
Halton District School Board
2050 Guelph Line
Burlington, Ontario

**BURLINGTON CENTRAL
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2400 Industrial Street
Burlington, Ontario, L7P 1A5
Tel: 905-631-1115

RECEIVED
NOV 01 2023
CITY OF BURLINGTON
BUILDING DEPARTMENT


ALL CONSTRUCTION TO MEET ONTARIO BUILDING CODE REQUIREMENTS

Key Plan N.T.S.




1 OVERALL KEY PLANS
A101 1:500


MAINTAIN INTEGRITY OF ALL EXISTING FIRE SEPARATIONS

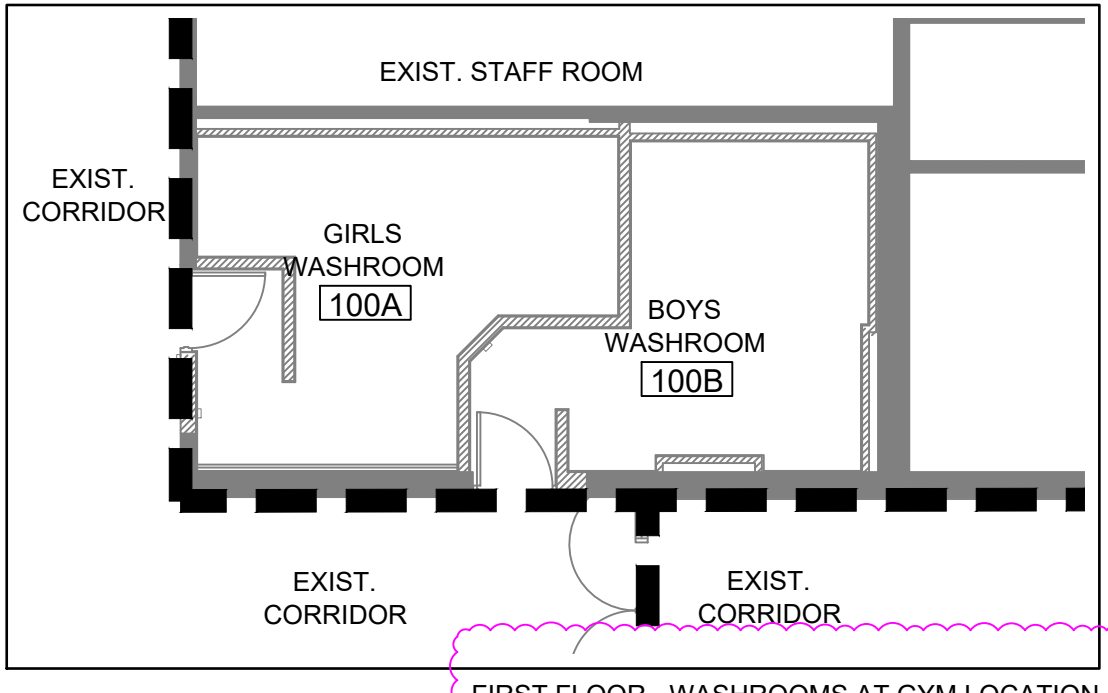



FIRST FLOOR - WASHROOMS AT GYM LOCATION

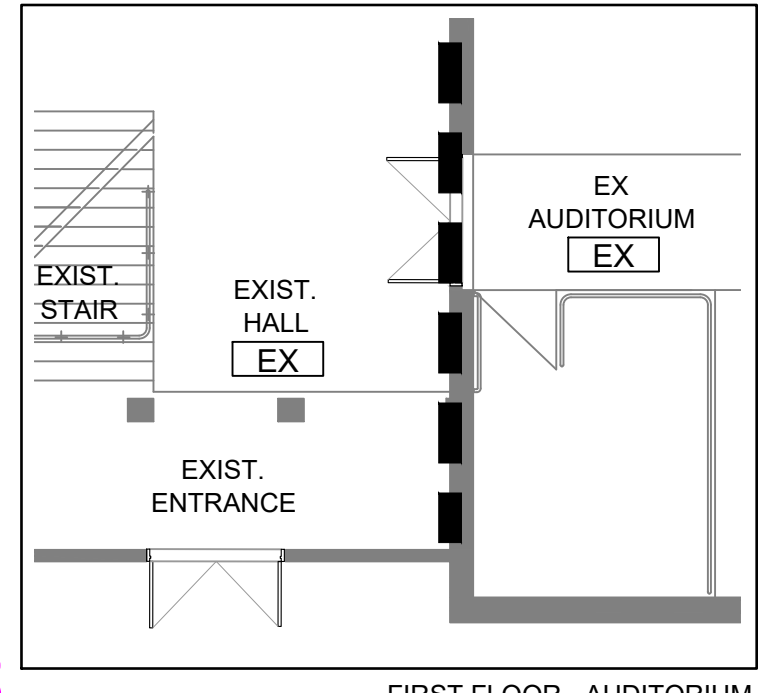


FIRST FLOOR - AUDITORIUM

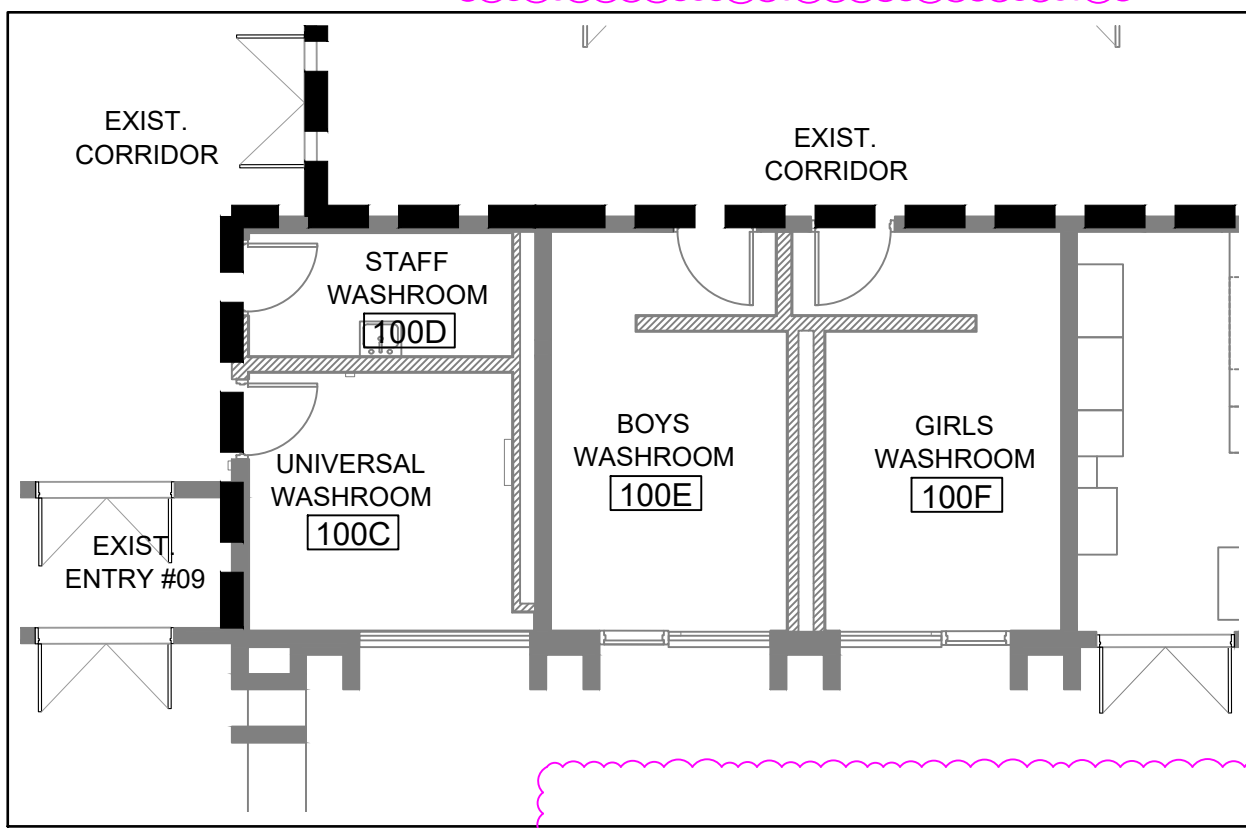


FIRST FLOOR - WASHROOMS AT LIBRARY LOCATION

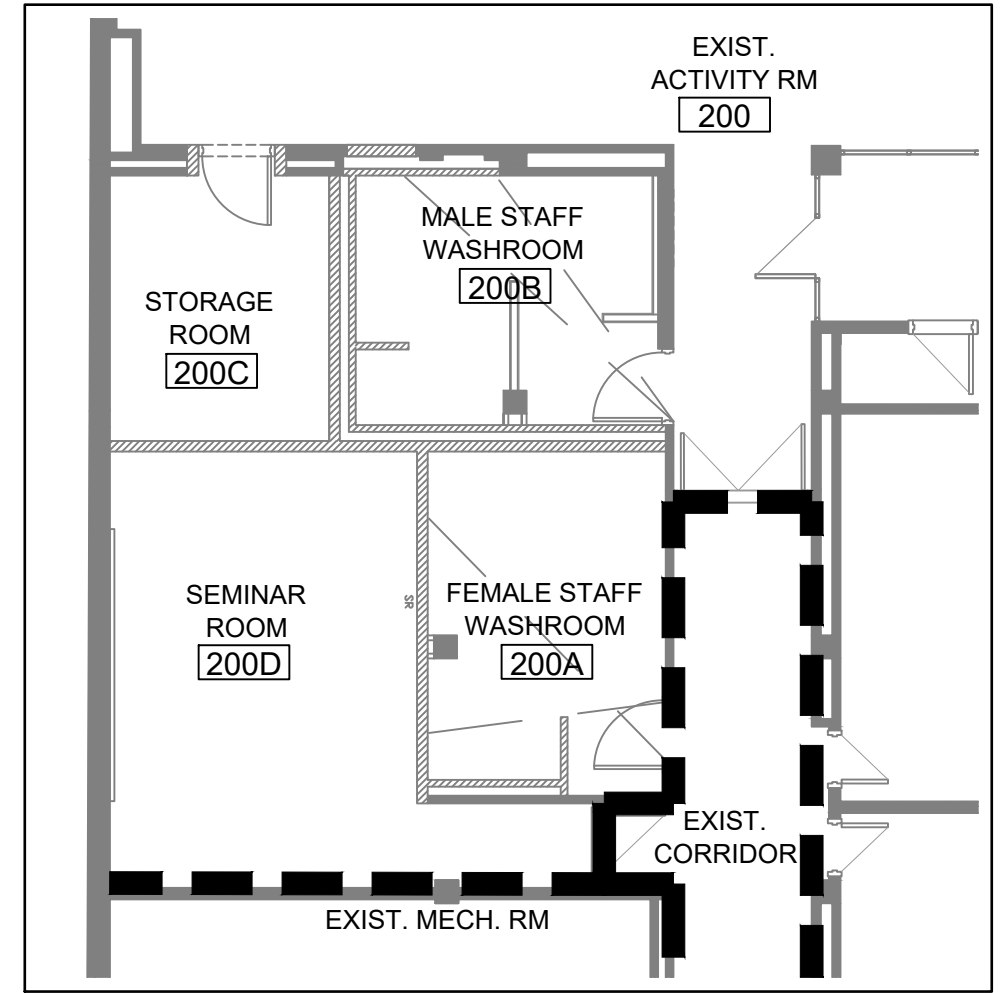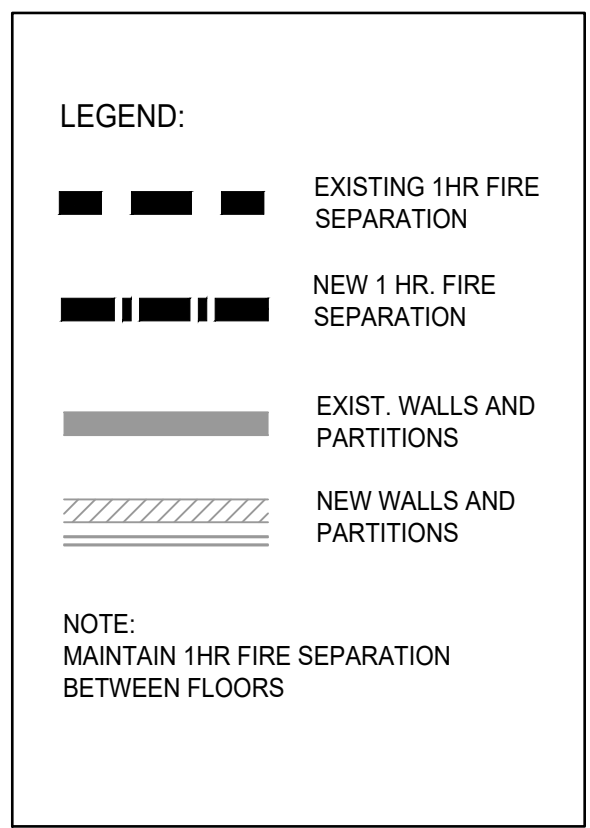

SECOND FLOOR - STAFF WASHROOMS

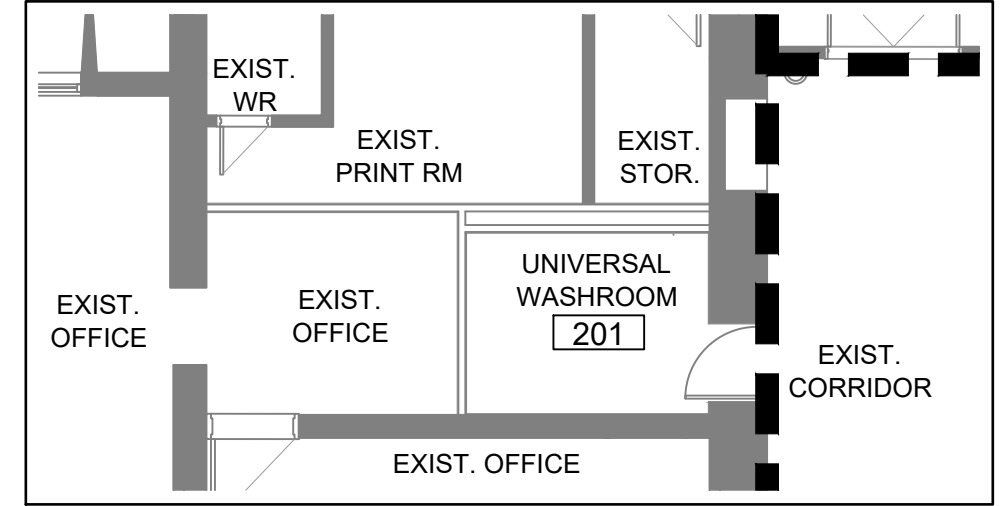

SECOND FLOOR - UNIVERSAL WASHROOM

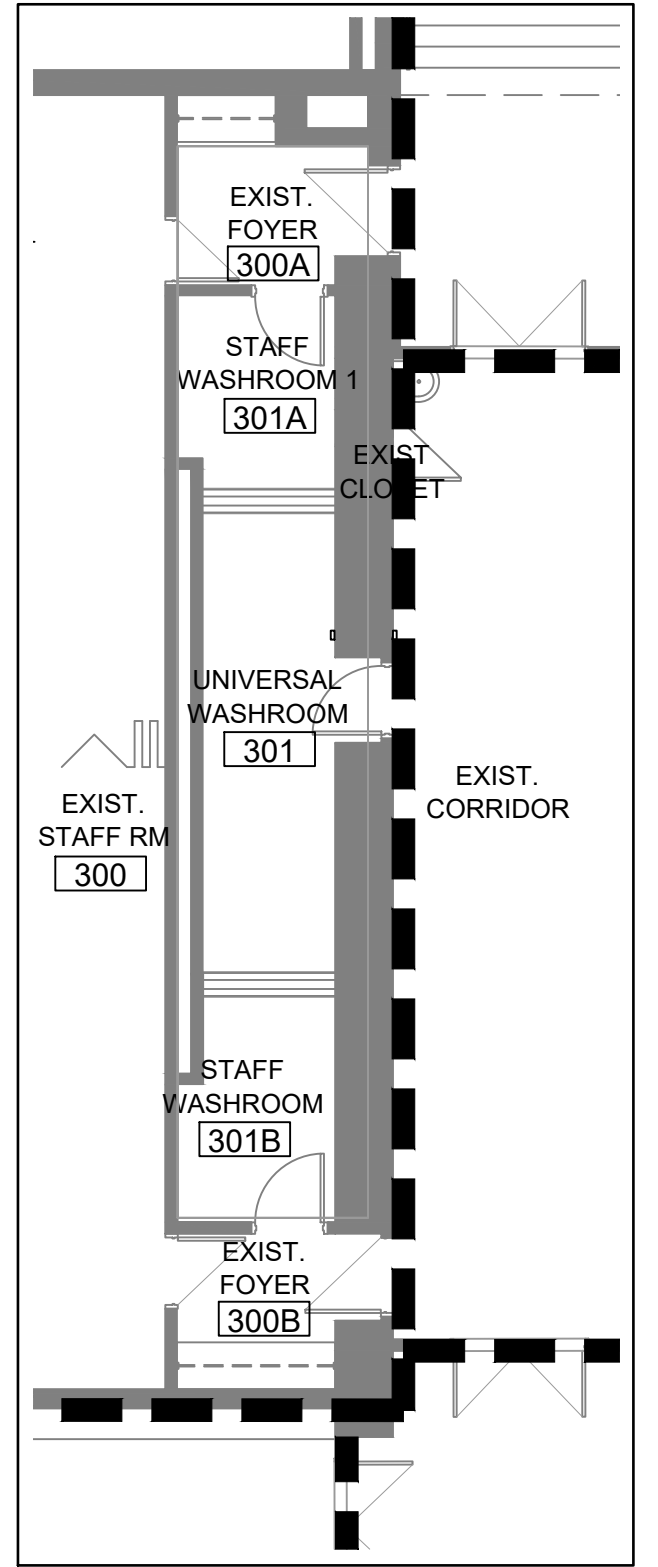

THIRD FLOOR - STAFF WASHROOMS

NOTE:
FOR PLUMBING FIXTURE COUNT
REFER TO DRAWING A202

ALL FIRE SEPARATIONS SHALL BE CONTINUOUS BETWEEN REQUIRED FIRE COMPARTMENTS. ALL OPENINGS IN THE FIRE SEPARATION MUST BE PROTECTED (UNLESS OTHERWISE NOTED).

Firestopping used at penetrations and joints in fire separations and fire-rated assemblies shall comply with Div. B, 3.1.9. of the OBC. The approved fire stop system and installation details must be submitted to the field inspector for approval. Installation shall be coordinated on site and is subject to the approval of the field inspector.

Except as permitted in articles 3.1.9.3. & 3.1.9.4. of the OBC, pipes, ducts, electrical outlet boxes, enclosed raceways or other service equipment that partly or wholly penetrate a fire-rated assembly shall be non-combustible unless the assembly has been tested using such equipment.

Ontario Building Code Data Matrix - Part 11 - Alteration of Existing Building			BC Reference
11.1	Existing Building classification: Describe Existing Use: School Construction Index: _N/A_ Hazard Index: _N/A_ ● Not Applicable (no change of major occupancy)		11.2.1 T 11.2.1.1A T 11.2.1.1B to N
11.2	Alteration to Existing Building is: Basic Renovation ● Extensive Renovation ○		11.3.3.1 11.3.3.2
11.3	Reduction in Performance Level: Structural: By increase in occupant load: ● No ○ Yes By change of major occupancy: ● No ○ Yes Plumbing: ● No ○ Yes Sewage-system: ● No ○ Yes		11.4.2 11.4.2.1 11.4.2.2 11.4.2.3 11.4.2.4 11.4.2.5
11.4	Compensating Construction: Structural: ● No ○ Yes (explain) Increase in occupant load: ● No ○ Yes (explain) Change of major occupancy: ● No ○ Yes (explain) Plumbing: ● No ○ Yes (explain) Sewage system: ● No ○ Yes (explain)		11.4.3 11.4.3.2 11.4.3.3 11.4.3.4 11.4.3.5 11.4.3.6
11.5	Compliance Alternatives Proposed: ● No ○ Yes (give number(s))		11.5.1

No.	Revisions	Date
5	RE-ISSUED FOR PERMIT	10/31/2023
4	ADDITIONAL RAILING	09/15/2023
3	RE-ISSUED FOR PERMIT	09/08/2023
2	RE-ISSUED FOR PERMIT	08/08/2023
1	ISSUED FOR PERMIT	06/12/2023
No.	Issue	Date

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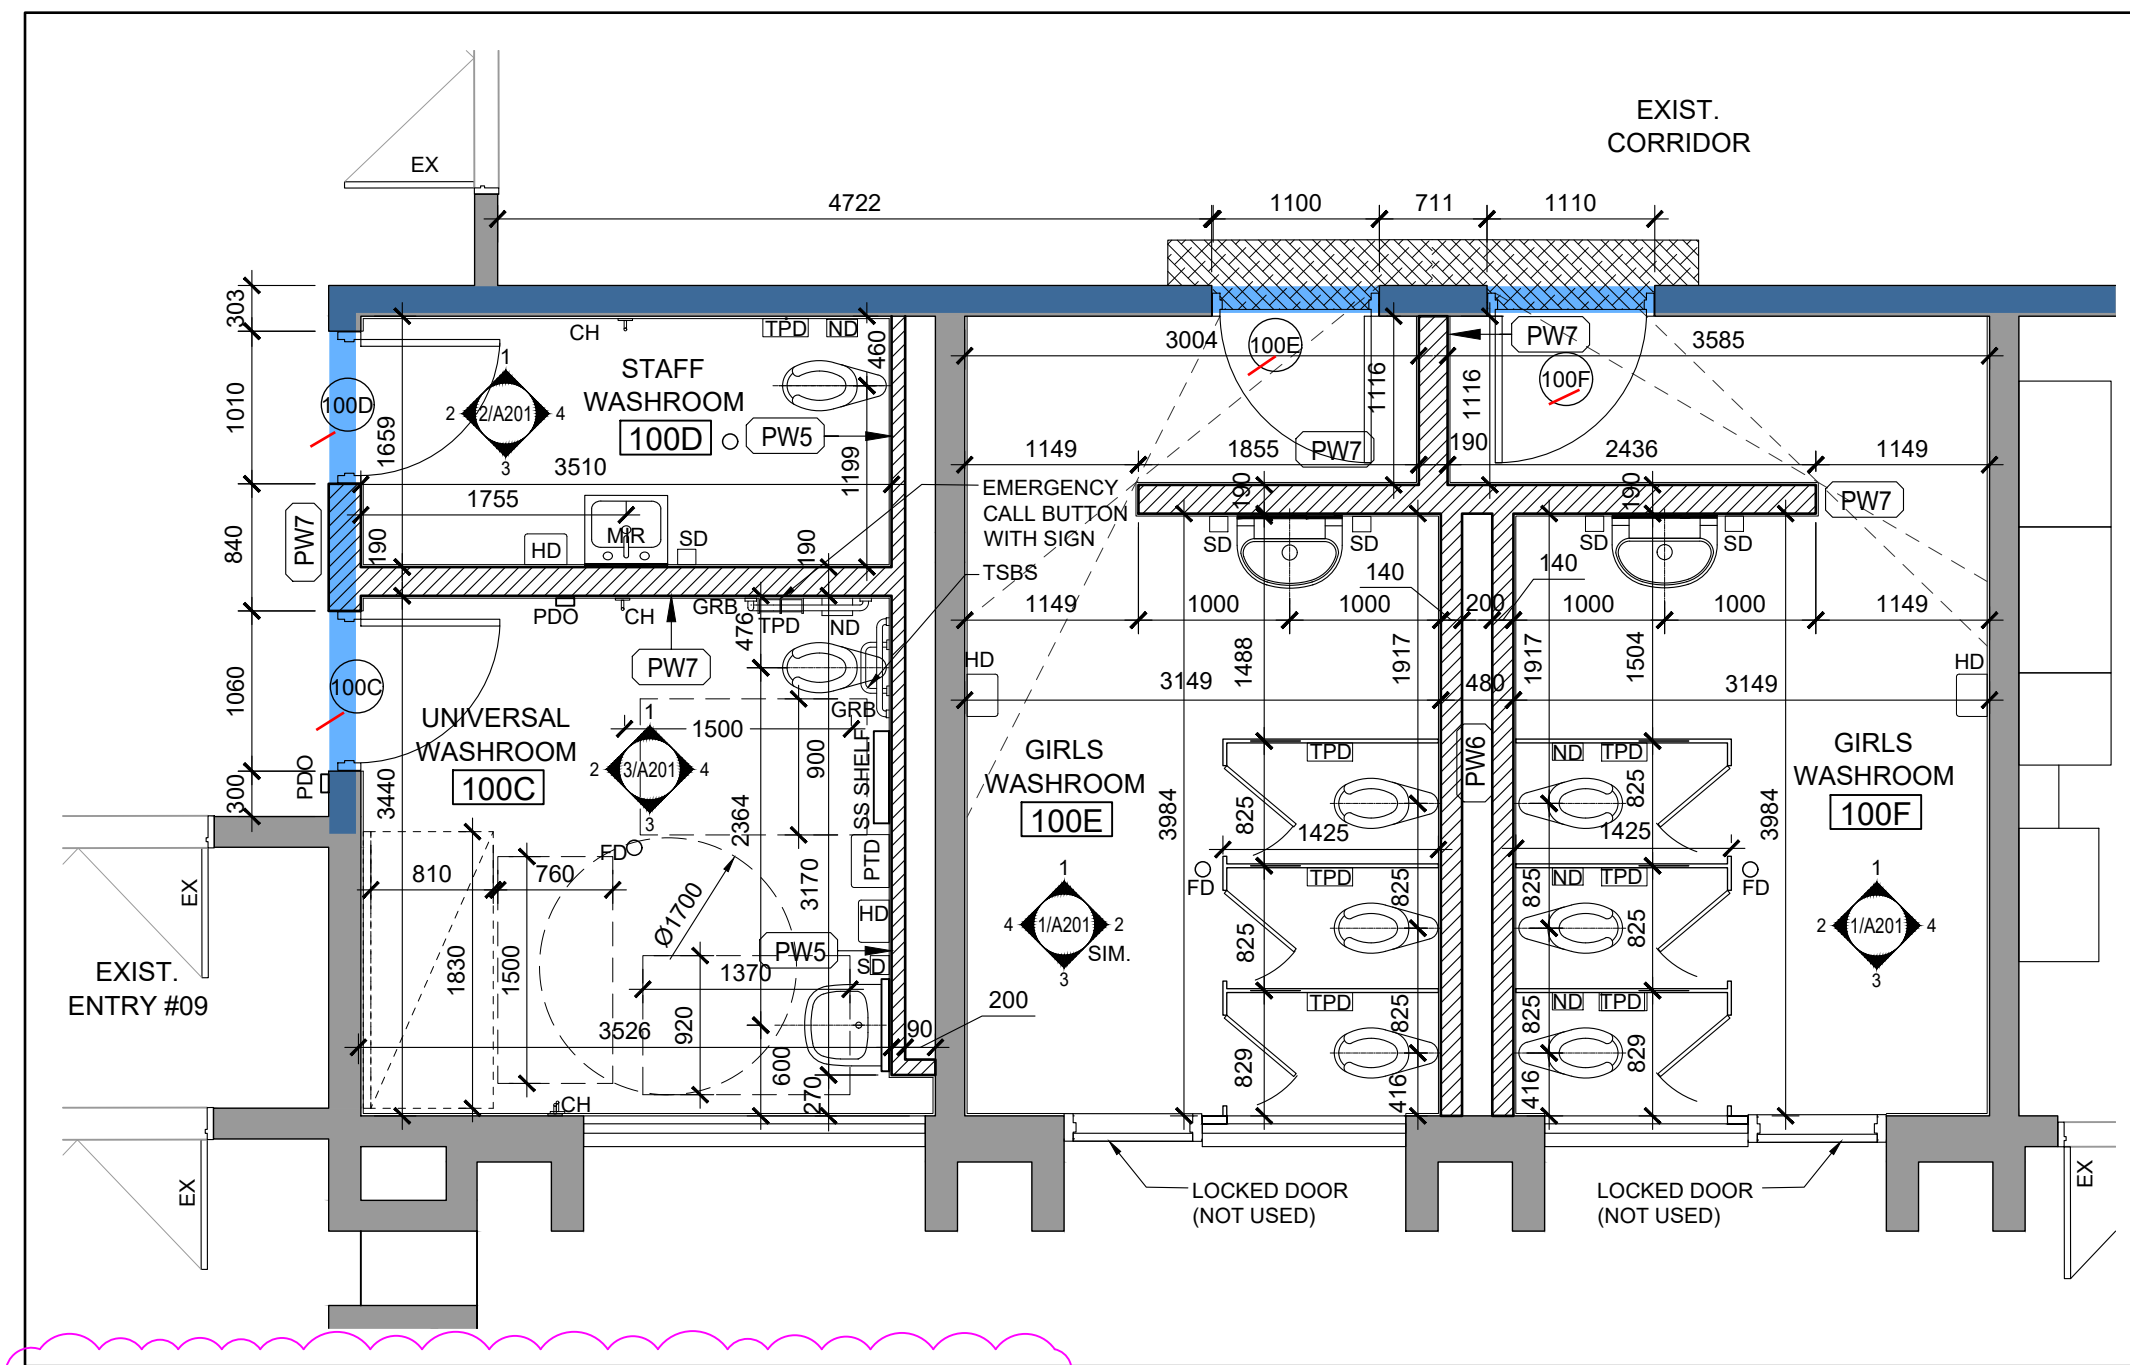


Drawing Title:
**KEY PLANS,
OBC MATRIX AND
FIRE SEPARATION**

Scale: AS NOTED Date: 04 23 2023

Drawn by: Checked by:

Job No. Drawing No.



1 FIRST FLOOR LIBRARY WASHROOMS NEW FLOOR PLAN
A200 1:50

1 HR. FRR

FIRE PROOFING NOTES:

- FIRE STOP AT ALL CORRIDOR PENETRATIONS NEW AND EXISTING. MAINTAIN EXISTING FIRE SEPARATIONS. ASSUME EXISTING CORRIDORS ARE 1 HOUR RATED. PROVIDE FLANGES ON DUCT PENETRATIONS AND FIRE DUMPERS AT CORRIDOR WALL FOR NEW DUCTS.
- PROVIDE FIRE STOP & SEAL AT ALL FIRE SEPARATIONS THAT TERMINATE AT EXTERIOR WALLS.
- FIRE STOP AT ALL SLAB PENETRATIONS. MAINTAIN EXISTING FIRE SEPARATIONS.
- ENSURE REQUIRED RATING WITH CMU; GROUT SOLID WHERE NECESSARY.
- SEAL TOP OF FIRE SEPARATION WITH FIRE STOPPING, OR ULC RATED ASSEMBLY OF SAME RATING AS THE FIRE SEPARATION.
- SPRAY ALL NEW BEAMS, COLUMNS SUPPORTING FLOOR ASSEMBLY W/ 1 HOUR FRR SPRAY FIREPROOFING EXCEPT WHERE INTUMESCENT PAINT IS SPECIFIED (ALL EXPOSED STRUCTURAL STEEL ELEMENTS).
- PRIME AND PAINT ALL LINTELS.

GENERAL FLOOR FINISH NOTES:

- TRANSITION STRIP IN EVERY CHANGE OF MATERIAL.
- ALL TRANSITIONS BETWEEN DIFFERING MATERIALS TO BE FLUSH.
- ALL FLOOR FINISH TRANSITIONS TO MEET UNDER DOOR (WHERE DOOR OCCURS).
- ALL TERRAZZO IN-FILLS TO EXTEND TO NEXT METAL STRIP.
- CONTROL JOINT IN TILING SYSTEM EVERY 10 METERS.
- ALL EXISTING BASE TO BE REMOVED PRIOR TO NEW BASE INSTALLATION.
- REFER TO DRAWING A400 FOR ROOM FINISH SCHEDULE.

All Exits and Access to Exits shall be clearly visible and accessible at all times.


Barrier free doorways and doors shall comply to Div. B, 3.8.3.3. of the OBC and maintain a minimum 1100mm unobstructed barrier free path of travel.

UNIVERSAL WASHROOMS to comply with Div. B, 3.8.3.12. Ontario Building Code 2012


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Except as permitted in articles 3.1.9.3. & 3.1.9.4. of the OBC, pipes, ducts, electrical outlet boxes, enclosed raceways or other service equipment that partly or wholly penetrate a fire-rated assembly shall be non-combustible unless the assembly has been tested using such equipment.




6 FIRST FLOOR - EXIST. HALL NEW RAILING
A200 1:50

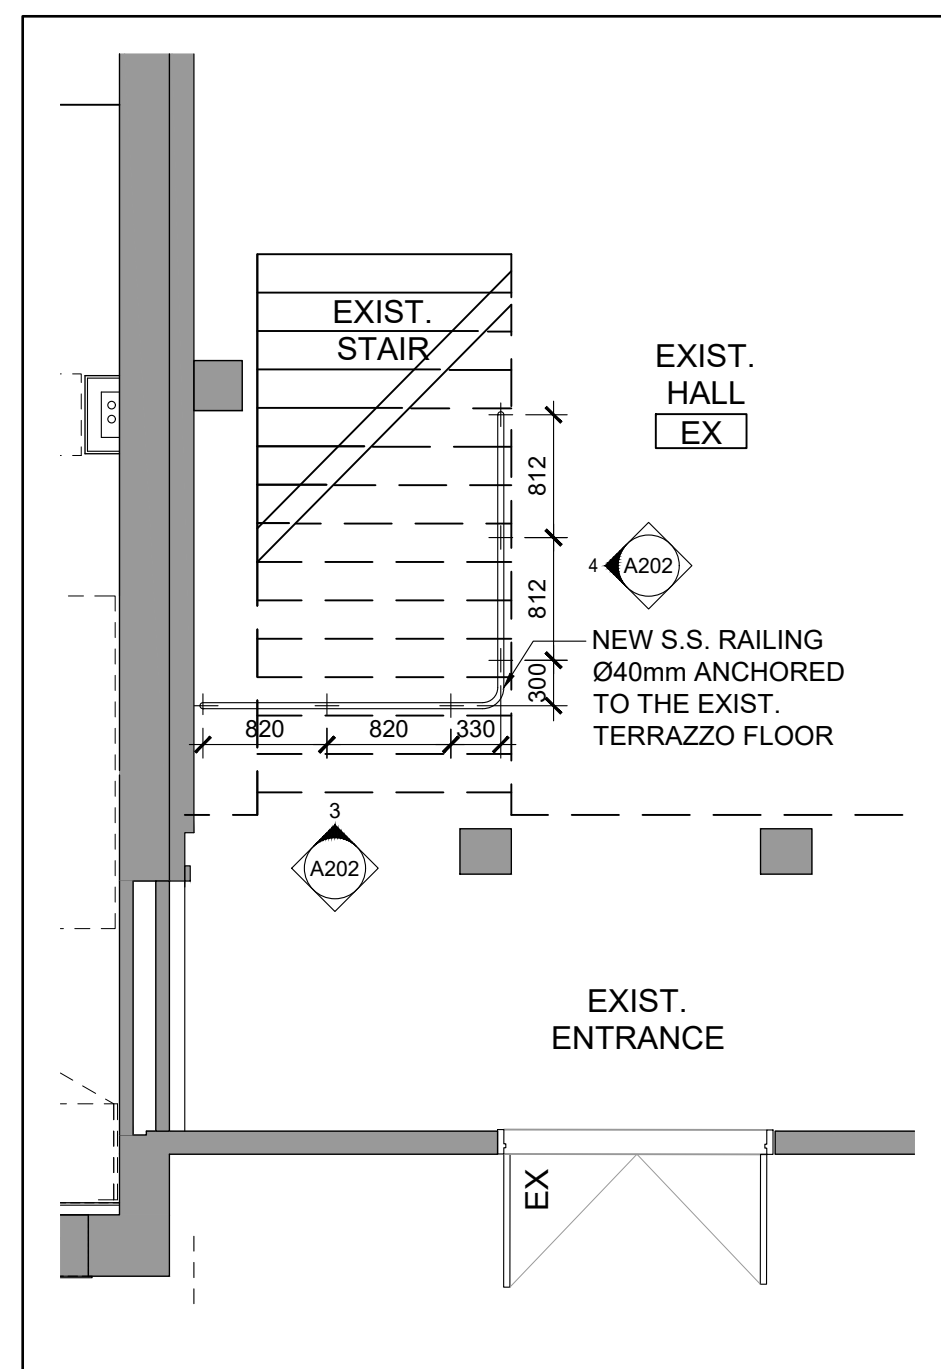


5 FIRST FLOOR - AUDITORIUM BF SEATING - PLAN
A200 1:50

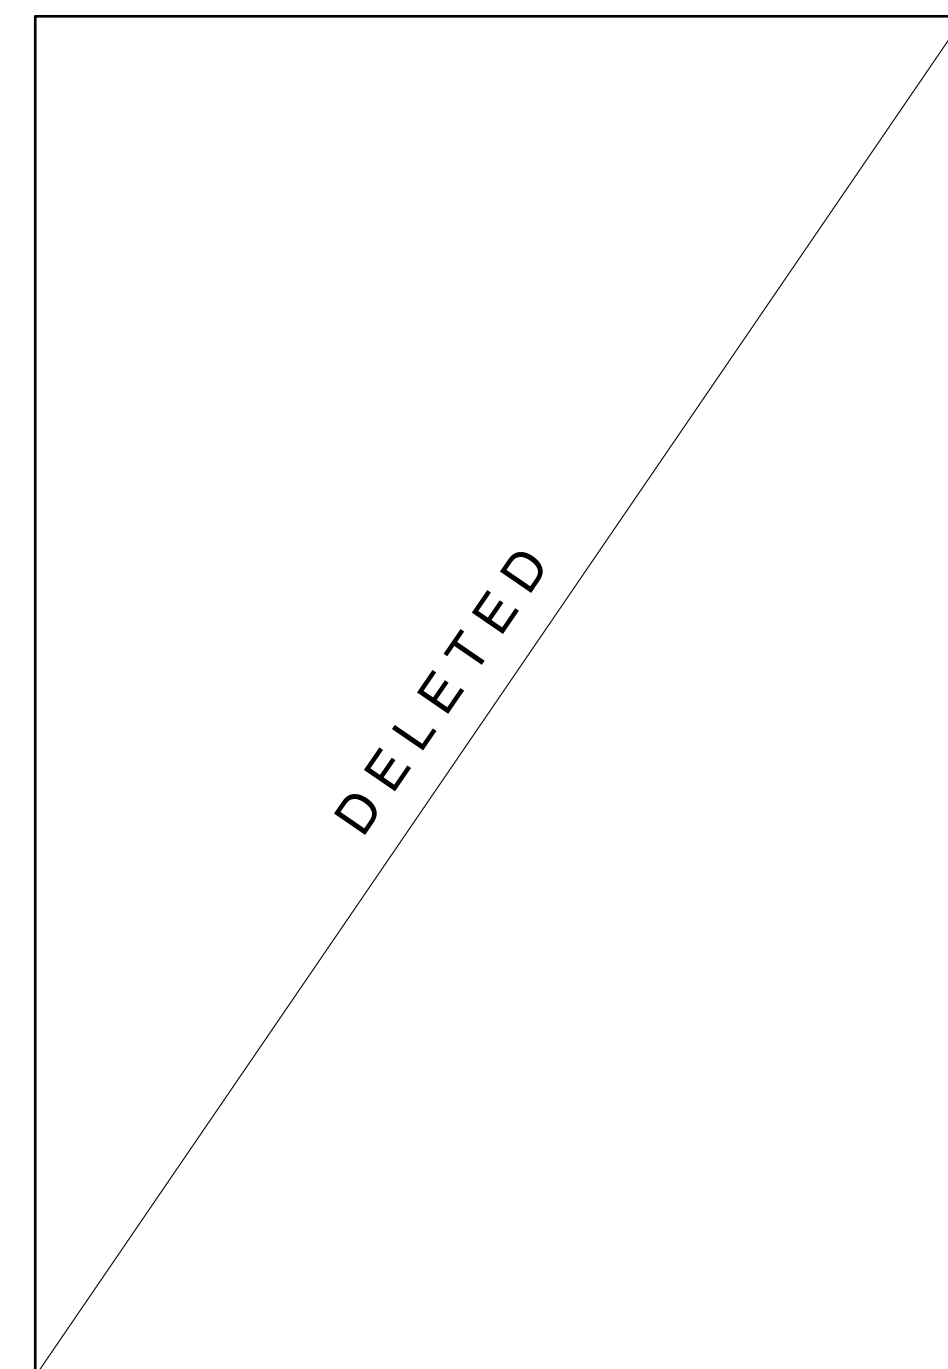NOTE:
ALL DIMENSIONS TO BE SITE VERIFIED

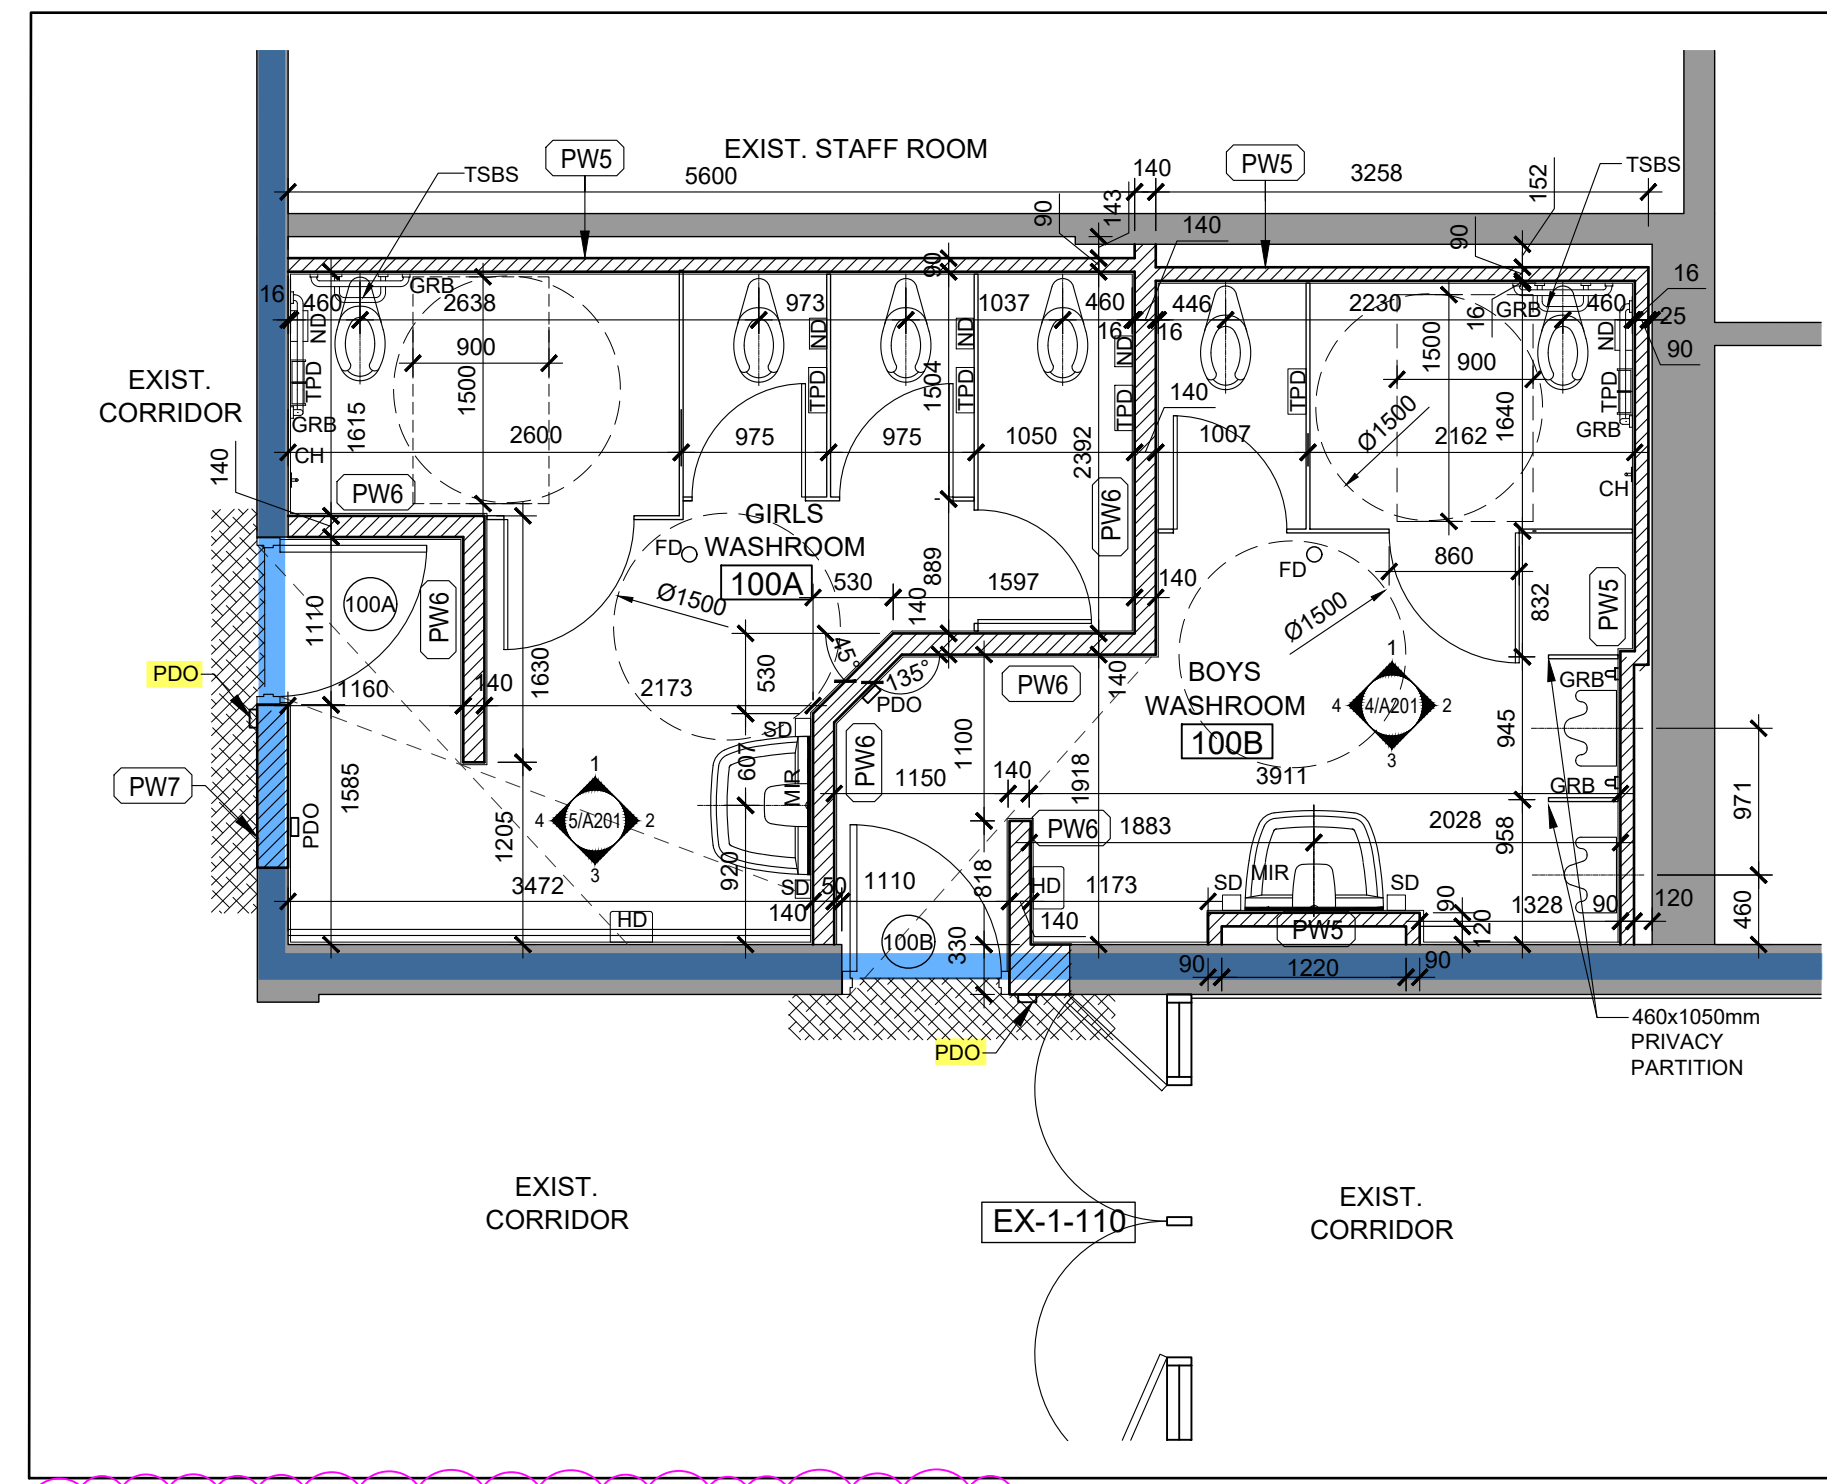


2 FIRST FLOOR GYM WASHROOMS NEW FLOOR PLAN
A200 1:50

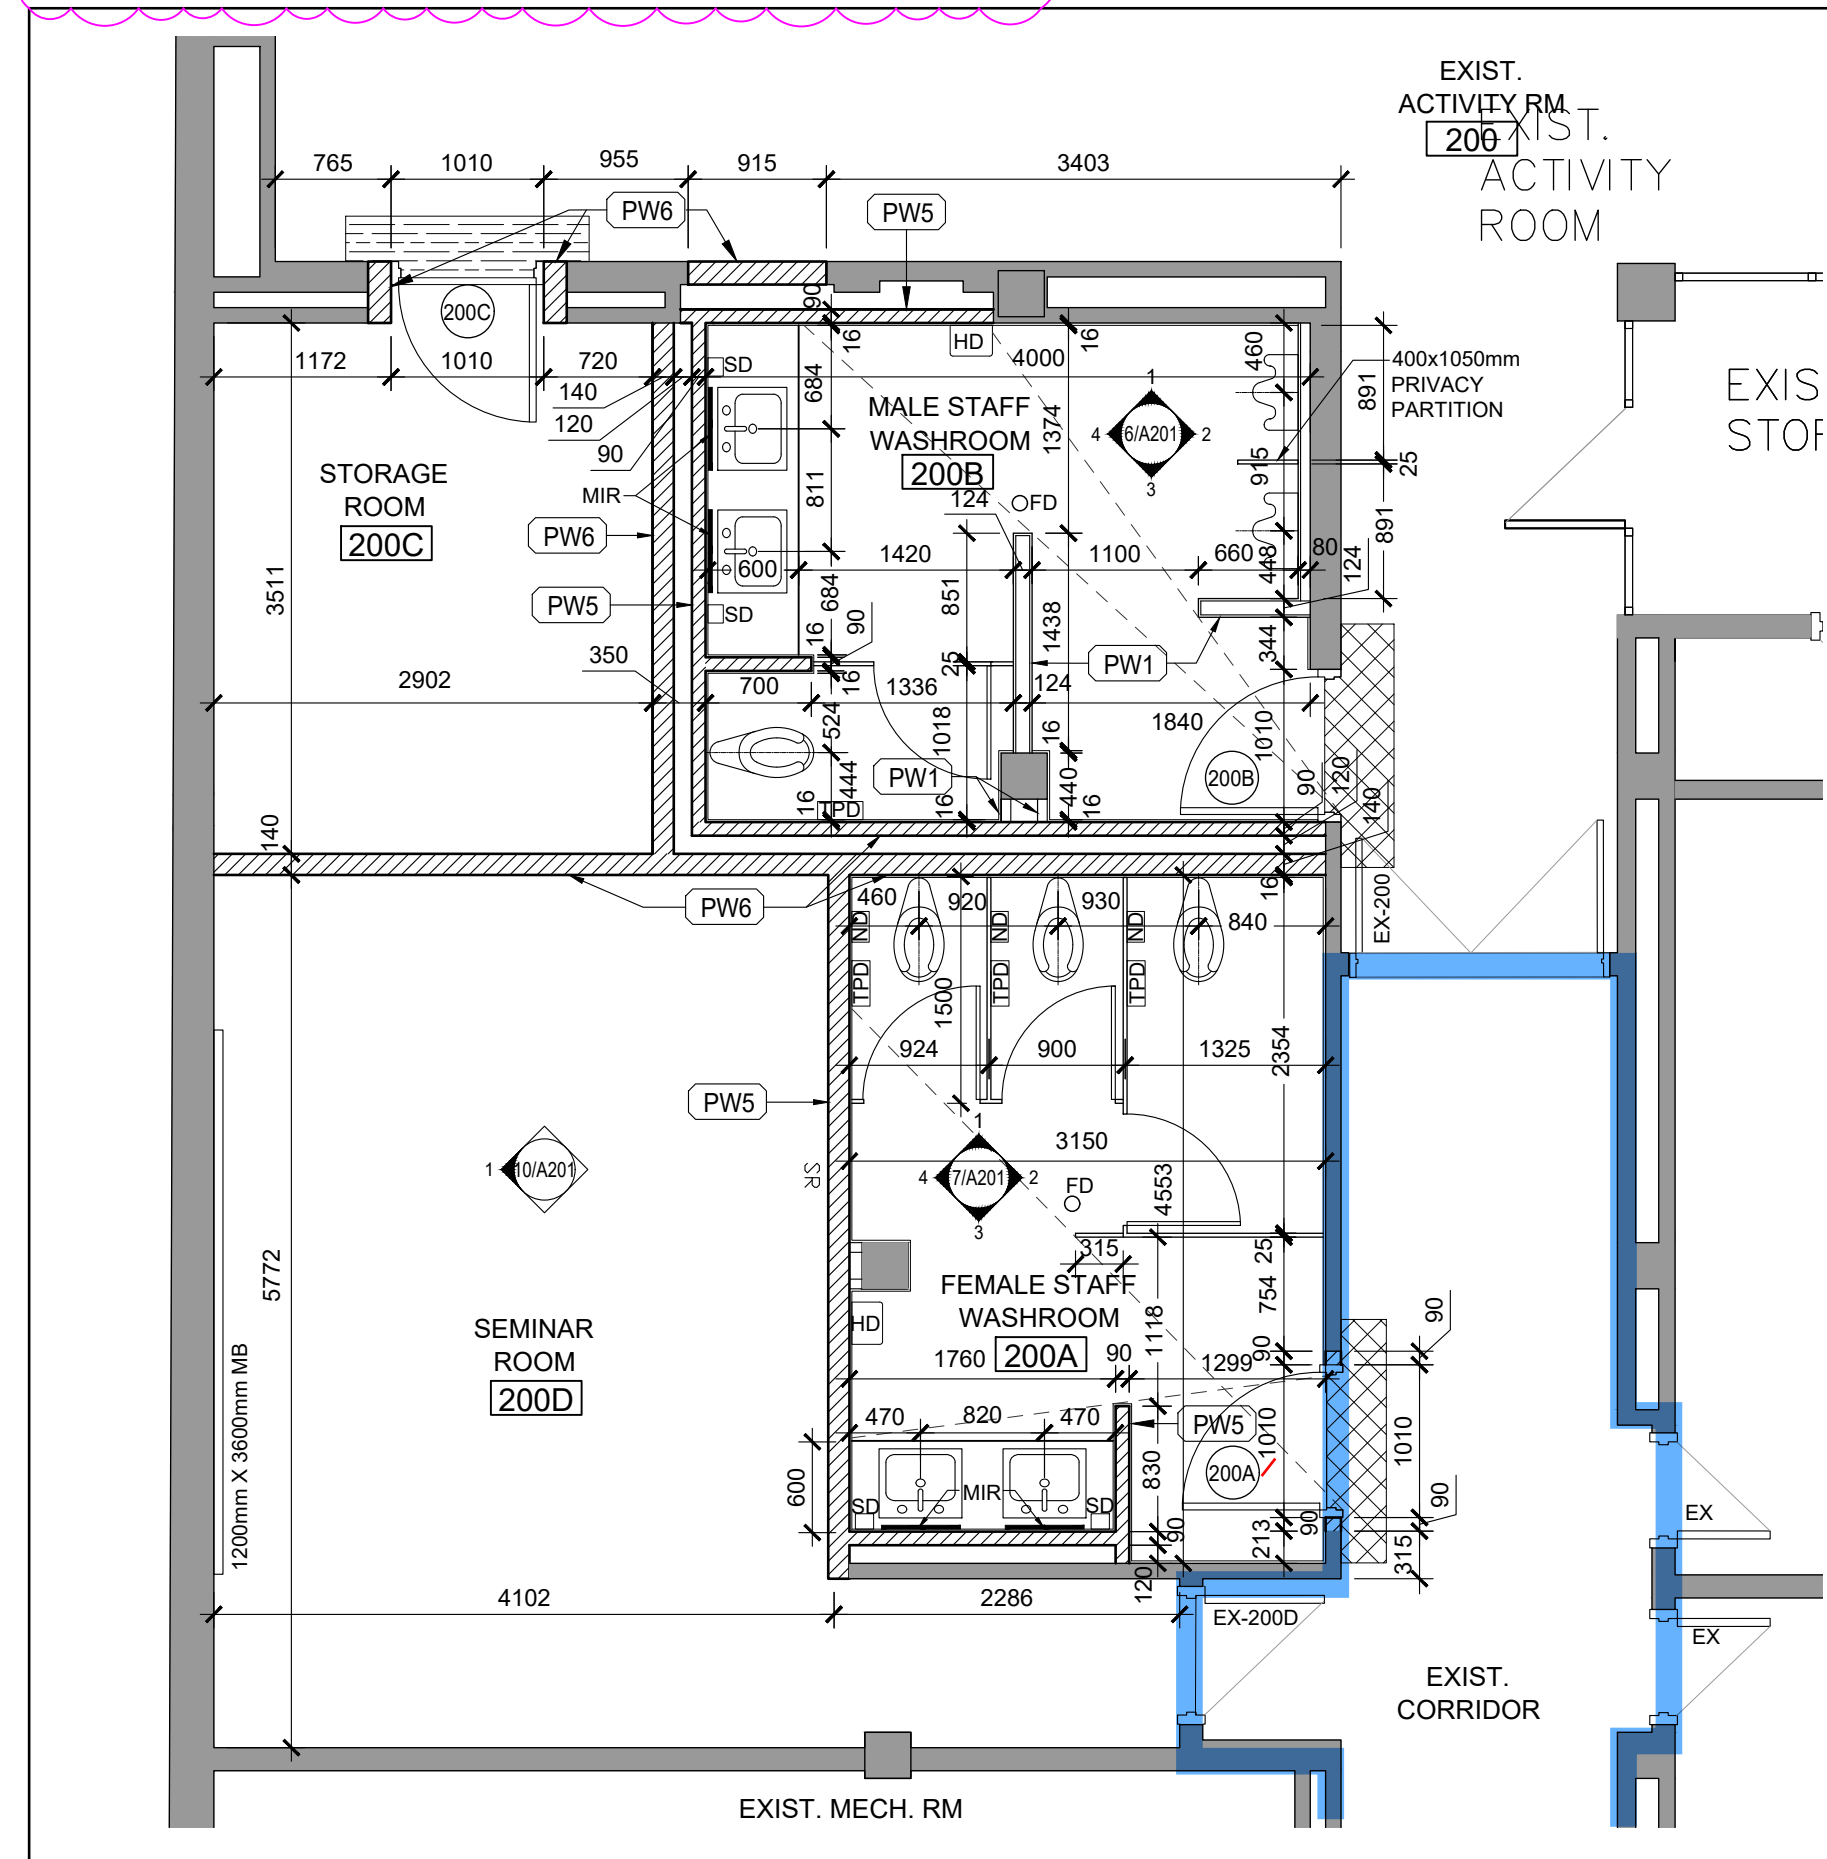

3 SECOND FLOOR WASHROOMS NEW FLOOR PLAN
A200 1:50

NEW INTERIOR WALL AND PARTITION TYPES:

- | | | | |
|------|--|------|--|
| PW1 | 15.9mm GYPSUM BOARD (GB-AR) ON BOTH SIDES OF 92 METAL STUDS 400mm O.C. FILLED WITH 89mm THICK MINERAL BATT INSULATION | PW3a | 15.9mm GYPSUM BOARD (GB-AR) ON 92mm METAL STUDS 400mm O.C. |
| PW1R | 1 LAYER OF 15.9mm SHEETROCK FIRECODE CORE GYPSUM PANELS ON BOTH SIDES OF 92mm STEEL STUDS 610mm O.C. - ALL THE WAY UP TO THE STRUCTURE. ALL JOINTS FINISHED - ULC Des W453 | PW4 | 90mm FILL-IN BRICK WALL |
| PW2 | 15.9mm GYPSUM BOARD (GB-AR) ON 22mm METAL FURRING 400mm O.C. | PW5 | 90mm CONCRETE MASONRY UNIT WALL |
| PW3 | 15.9mm GYPSUM BOARD (GB-AR) ON 64mm METAL STUDS 400mm O.C. | PW6 | 140mm CONCRETE MASONRY UNIT WALL |
| | | PW7 | 190mm CONCRETE MASONRY UNIT WALL |
| | | PW8 | 290mm CONCRETE MASONRY UNIT WALL |

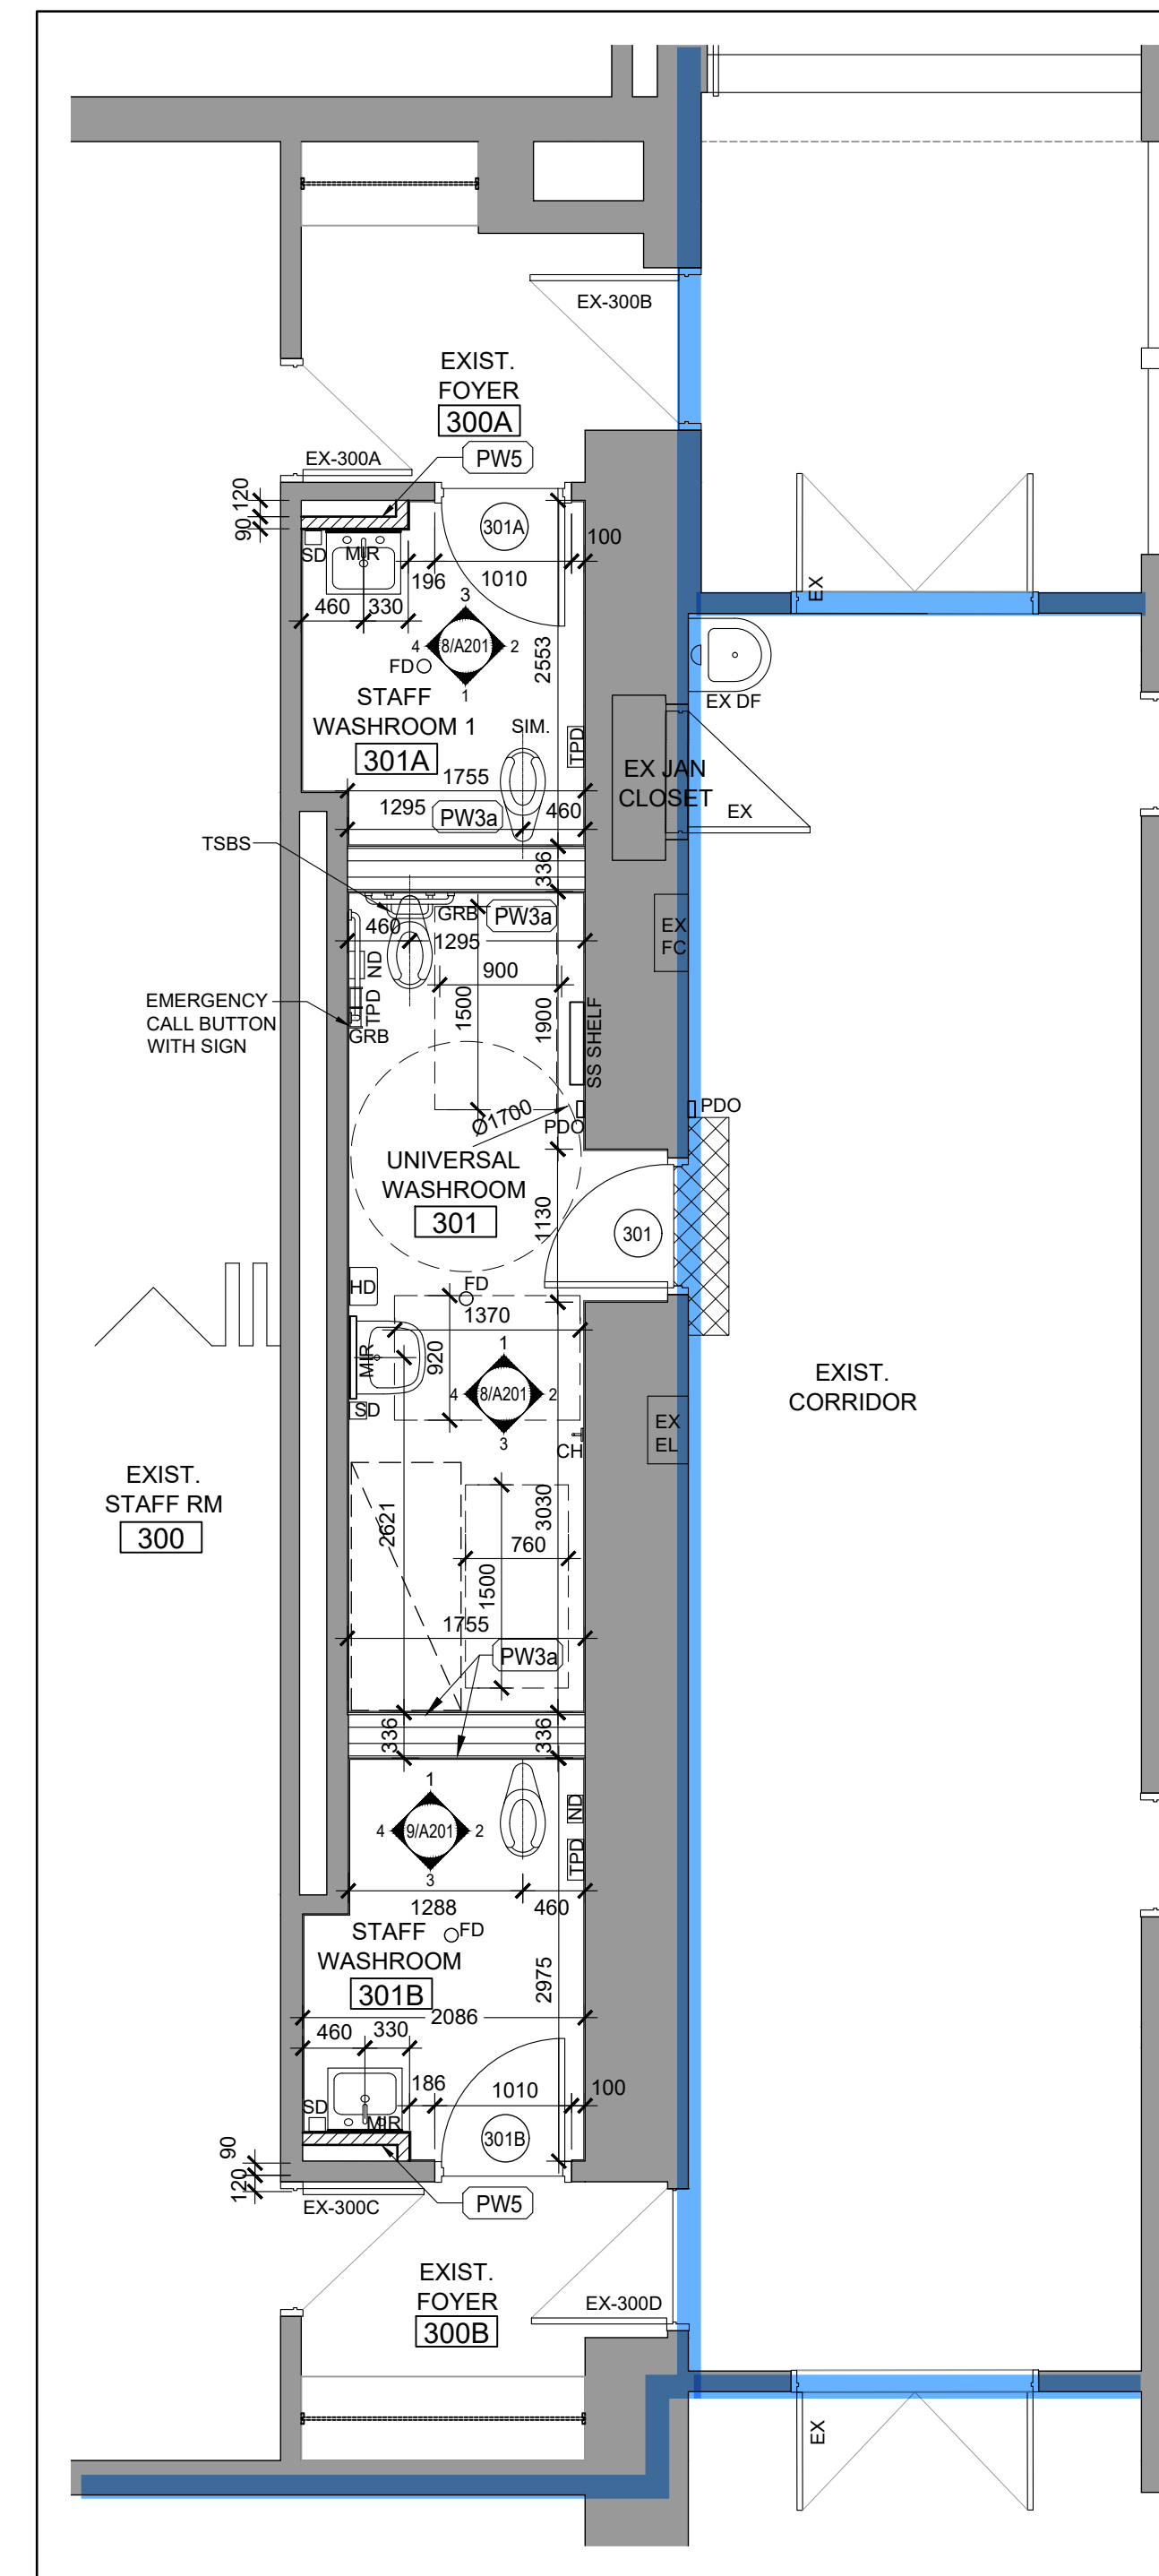

4 THIRD FLOOR WASHROOMS NEW FLOOR PLAN
A200 1:50

LEGEND

- EXISTING WALLS TO REMAIN
- NEW MASONRY WALL
- NEW STUD PARTITION
- AREA OF TERRAZZO FLOOR FILL-IN & REPAIR
- AREA OF VCT FLOOR BASE IN-FILL & REPAIR
- AREA OF CARPET FLOOR REPAIR
- EXISTING DOOR TO REMAIN
- NEW DOOR AND FRAME - REFER TO THE DOOR SCHEDULE
- NEW POWER DOOR OPERATOR - REFER TO EL. DWGS
- EXIST. FLOOR DRAIN TO REMAIN
- NEW FLOOR DRAIN - REFER TO MECH. DWGS

ABBREVIATIONS:

- EX EXISTING
- MB MARKER BOARD
- S.S. STAINLESS STEEL
- HD HAND DRYER
- PTD PAPER TOWEL DISPENSER
- GRB GRAB BAR
- TPD TOILET PAPER DISPENSER
- SD SOAP DISPENSER
- ND NAPKIN DISPOSAL
- TSBS TOILET SEAT BACK SUPPORT
- TERR TERRAZZO
- PFT PORCELAIN FLOOR TILES
- FD FLOOR DRAIN
- HM HOLLOW METAL
- PFT PORCELAIN FLOOR TILE
- CWT CERAMIC WALL TILE
- P PAINT

**BURLINGTON CENTRAL
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Tel: 905-631-1115

RECEIVED
NOV 01 2023
CITY OF BURLINGTON
BUILDING DEPARTMENT

ALL CONSTRUCTION TO MEET ONTARIO BUILDING CODE REQUIREMENTS

Key Plan N.T.S.



Project North True North

No.	Revisions	Date
5	RE-ISSUED FOR PERMIT	2023/10/31
4	RE-ISSUED FOR PERMIT	2023/09/08
3	RE-ISSUED FOR PERMIT	2023/08/08
2	ISSUED FOR PERMIT	2023/06/14
1	ISSUED FOR PC #14	2023/06/02
No.	Issue	Date

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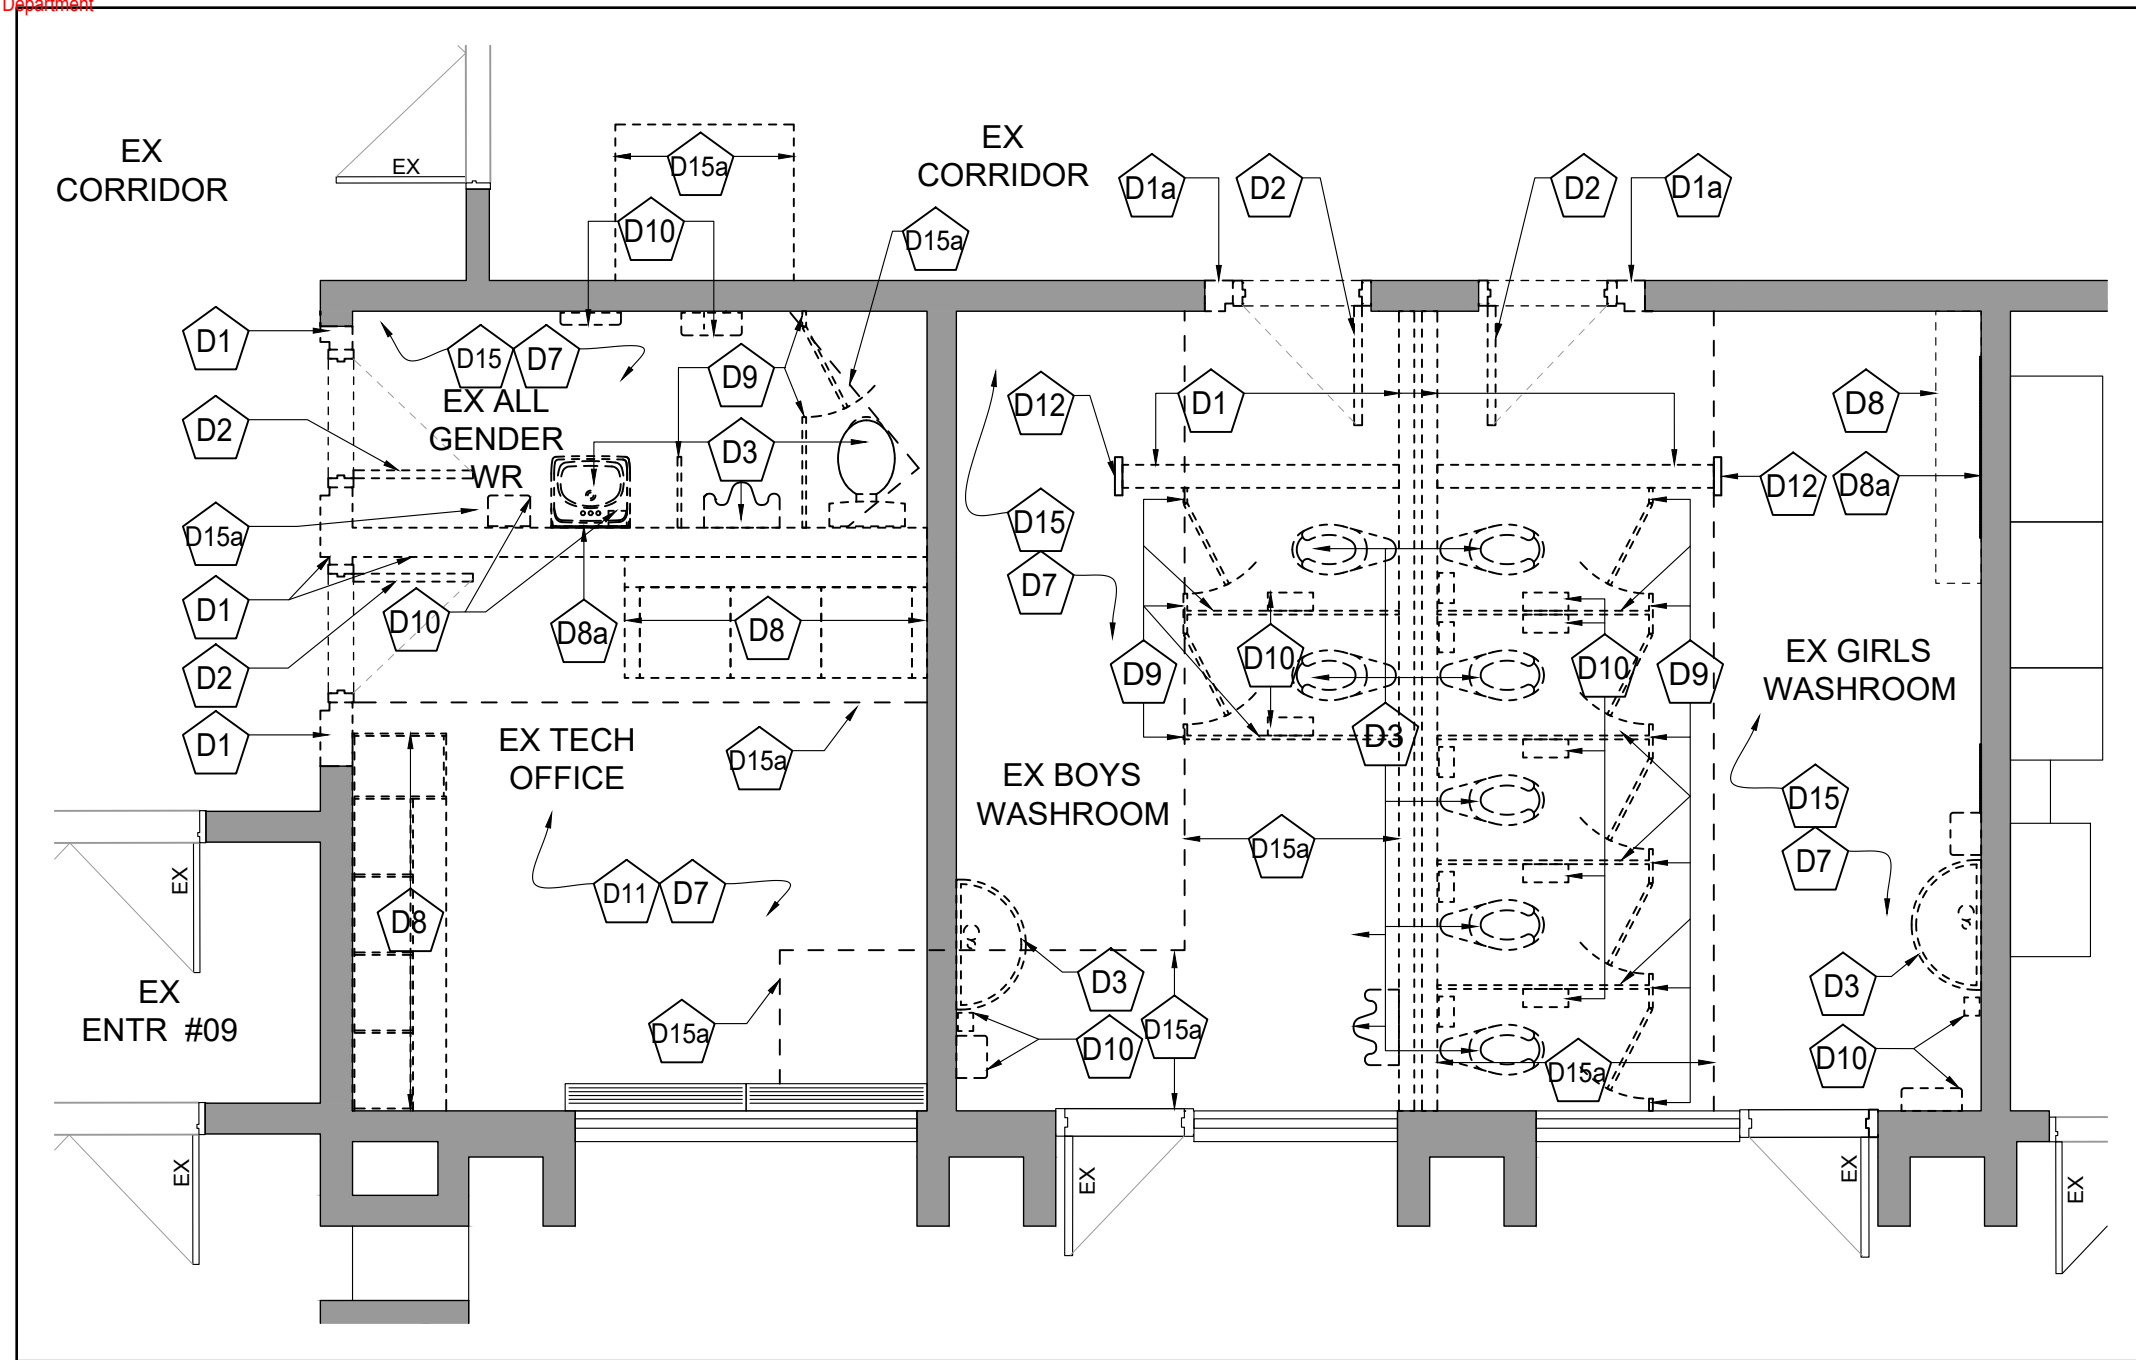
Drawing Title:
**FIRST, SECOND & THIRD
FLOOR- NEW WASHROOMS
LAYOUTS**

Scale: AS NOTED Date: 19-04-2023


Drawn by: Checked by:

Job No. Drawing No.

2005 A200




1 FIRST FLOOR LIBRARY WASHROOMS DEMOLITION PLAN
A200-D 1:50

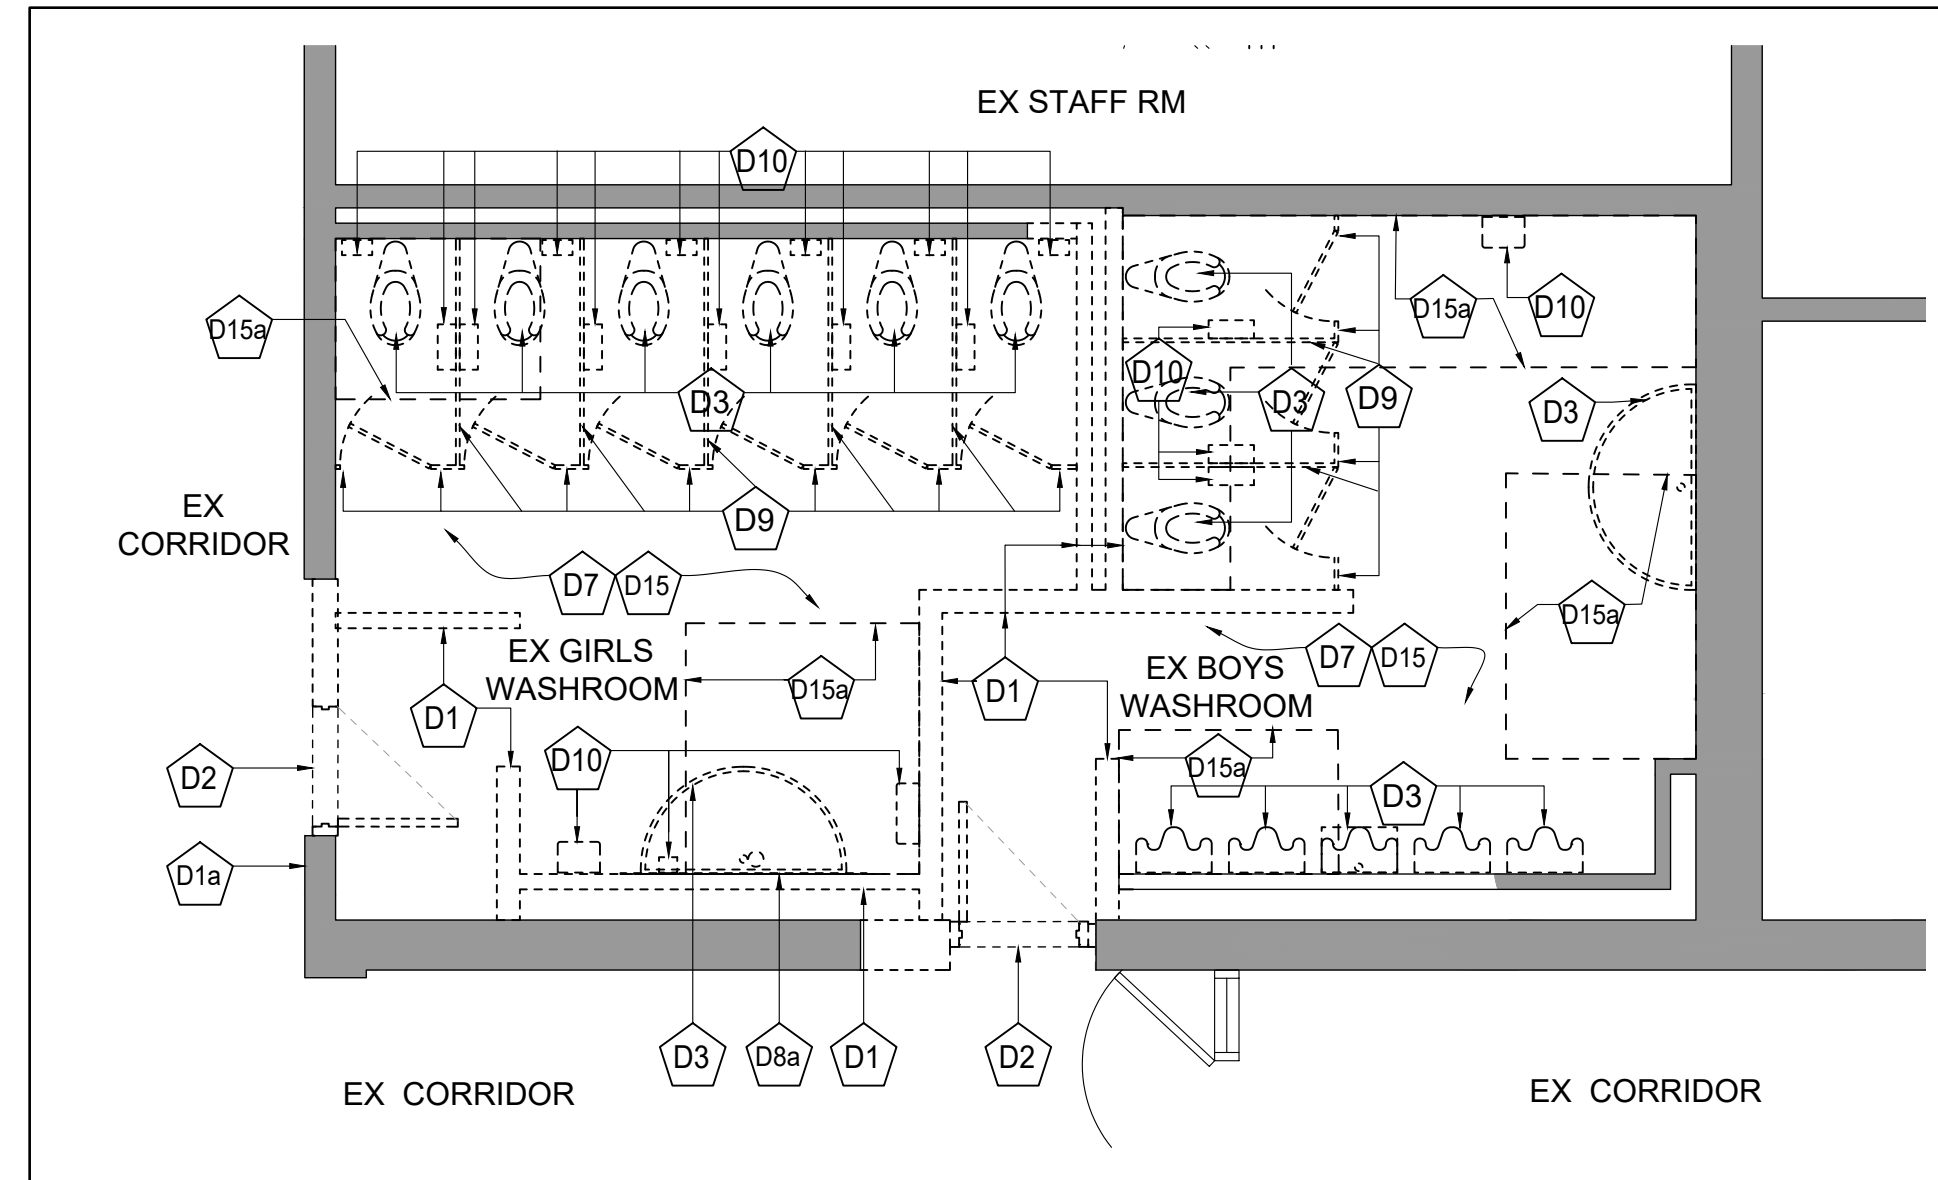


2 FIRST FLOOR GYM WASHROOMS DEMOLITION PLAN
A200-D 1:50



REMOVED FROM SCOPE OF WORK
SEE ARCHITECT'S RESPONSE LETTER
DATED SEP. 08, 2023 AND
ARCHITECTURAL DRAWING S/A200

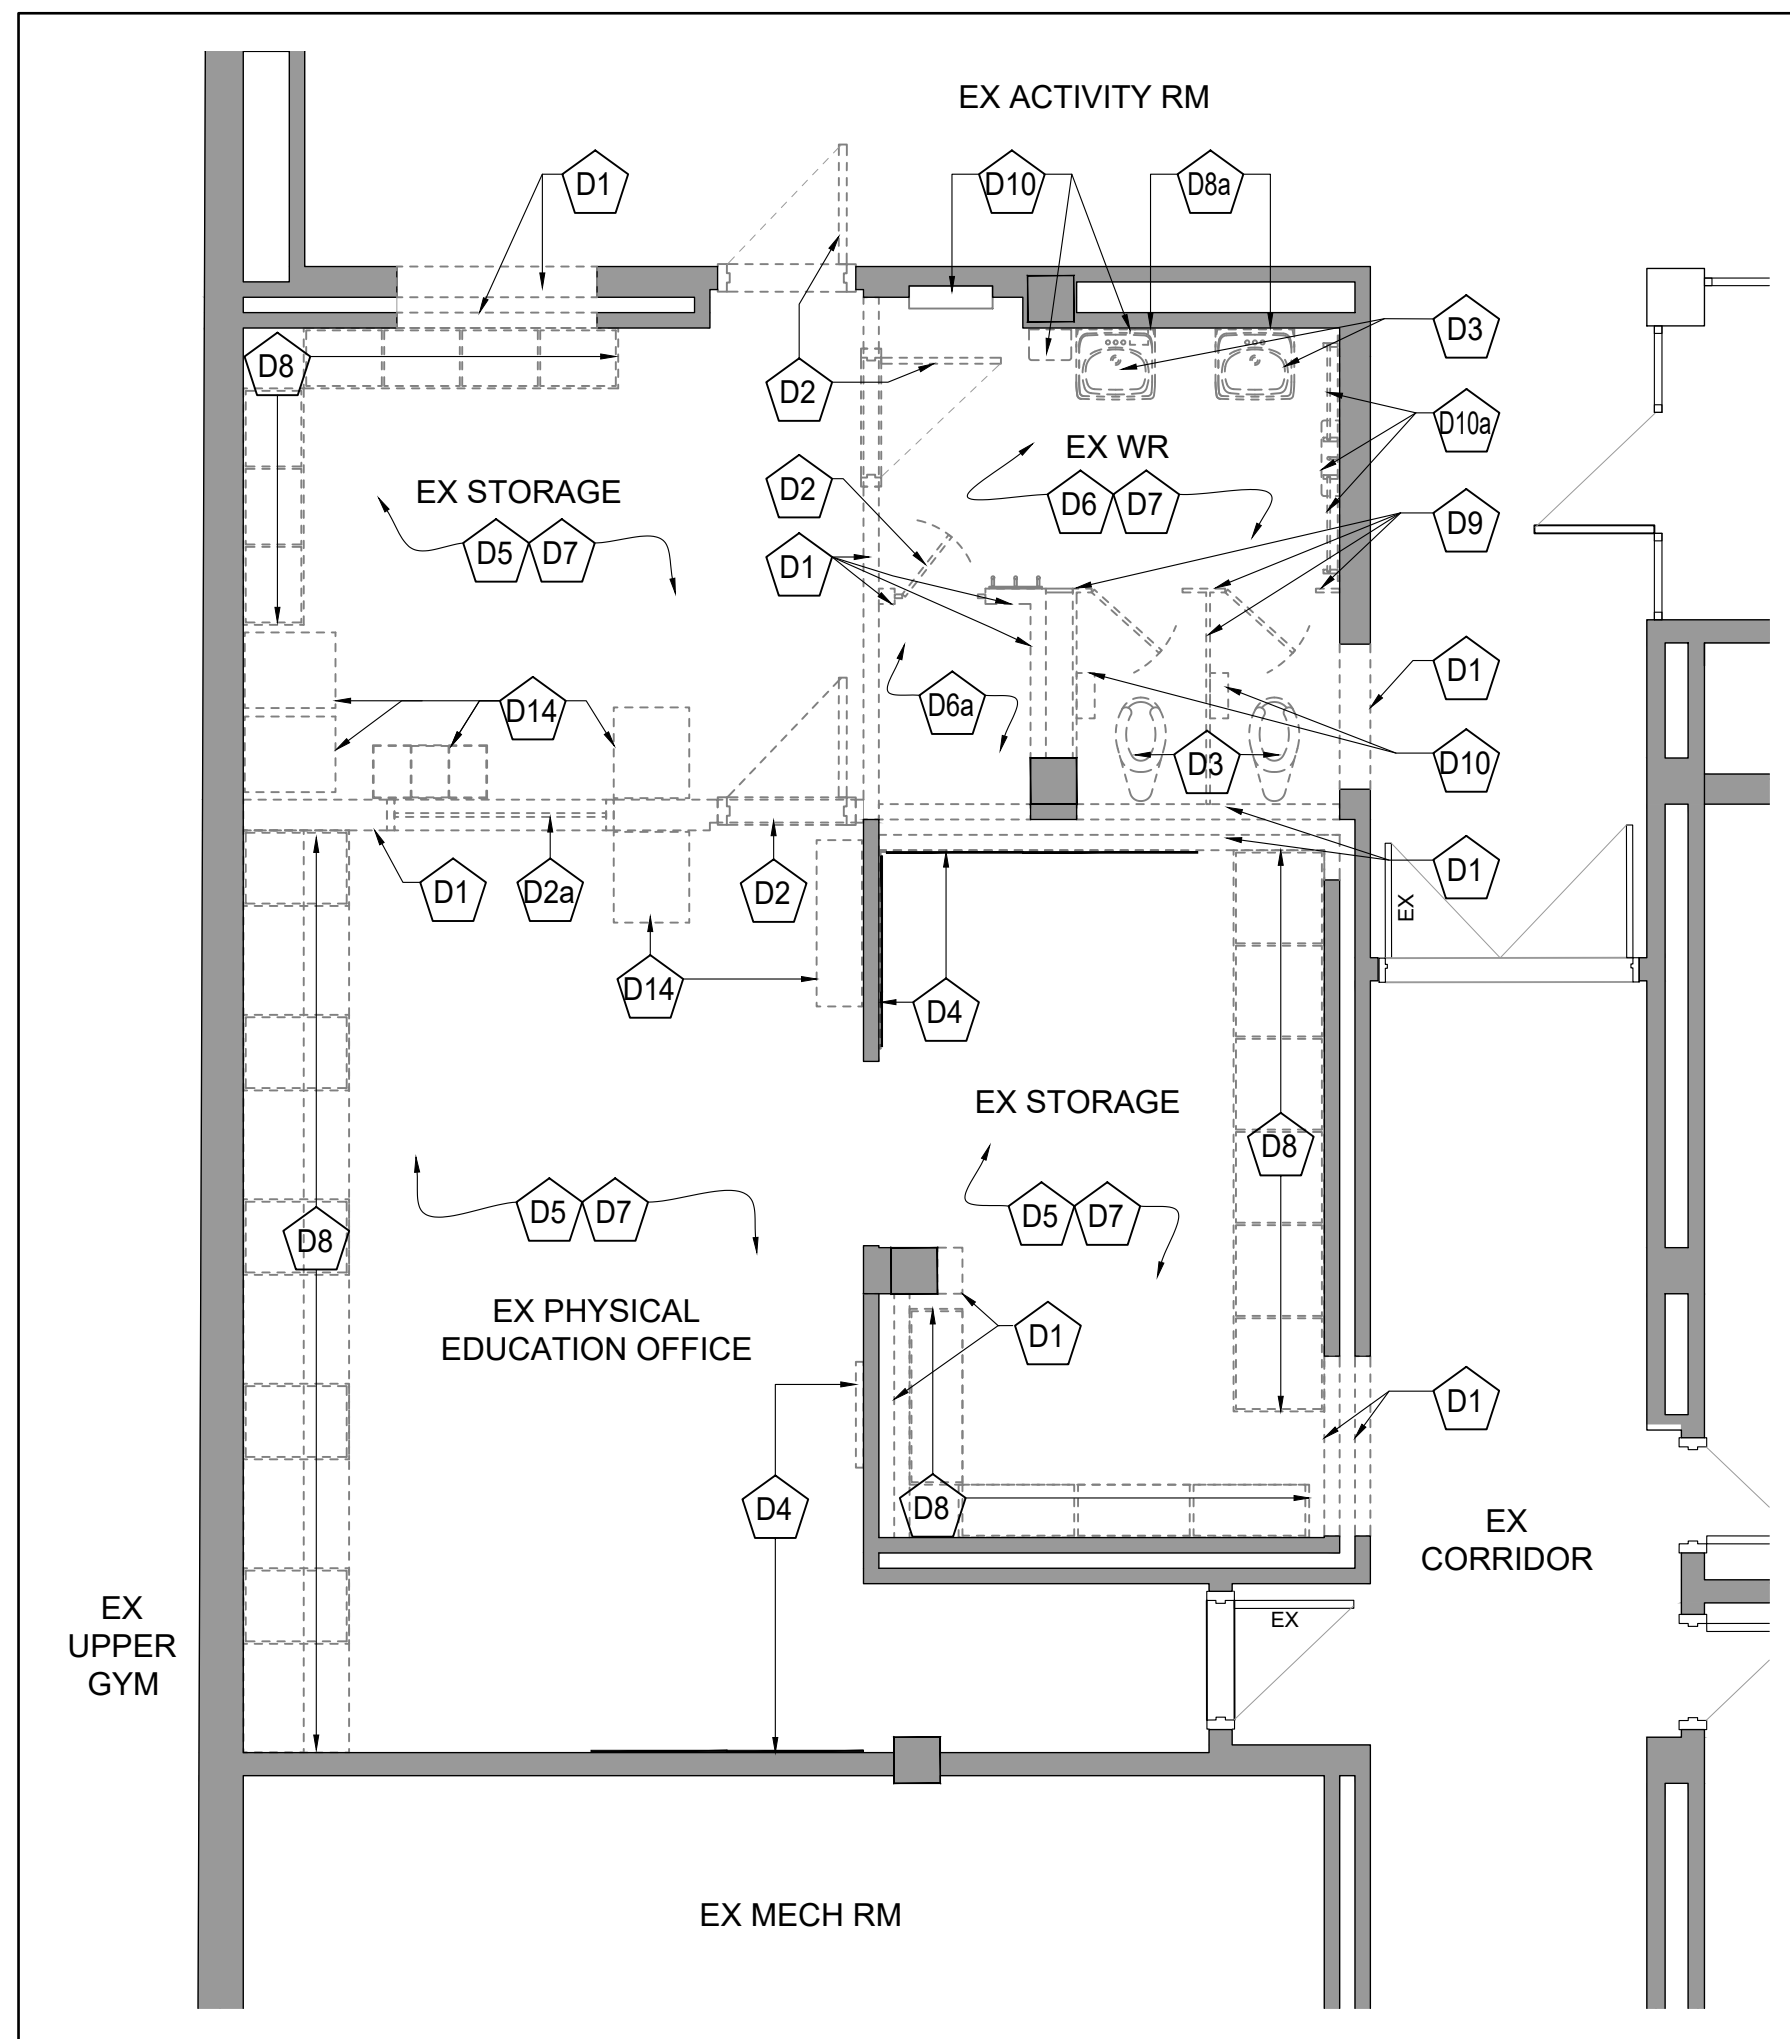

3 SECOND FLOOR DEMOLITION PLAN
A200-D 1:50

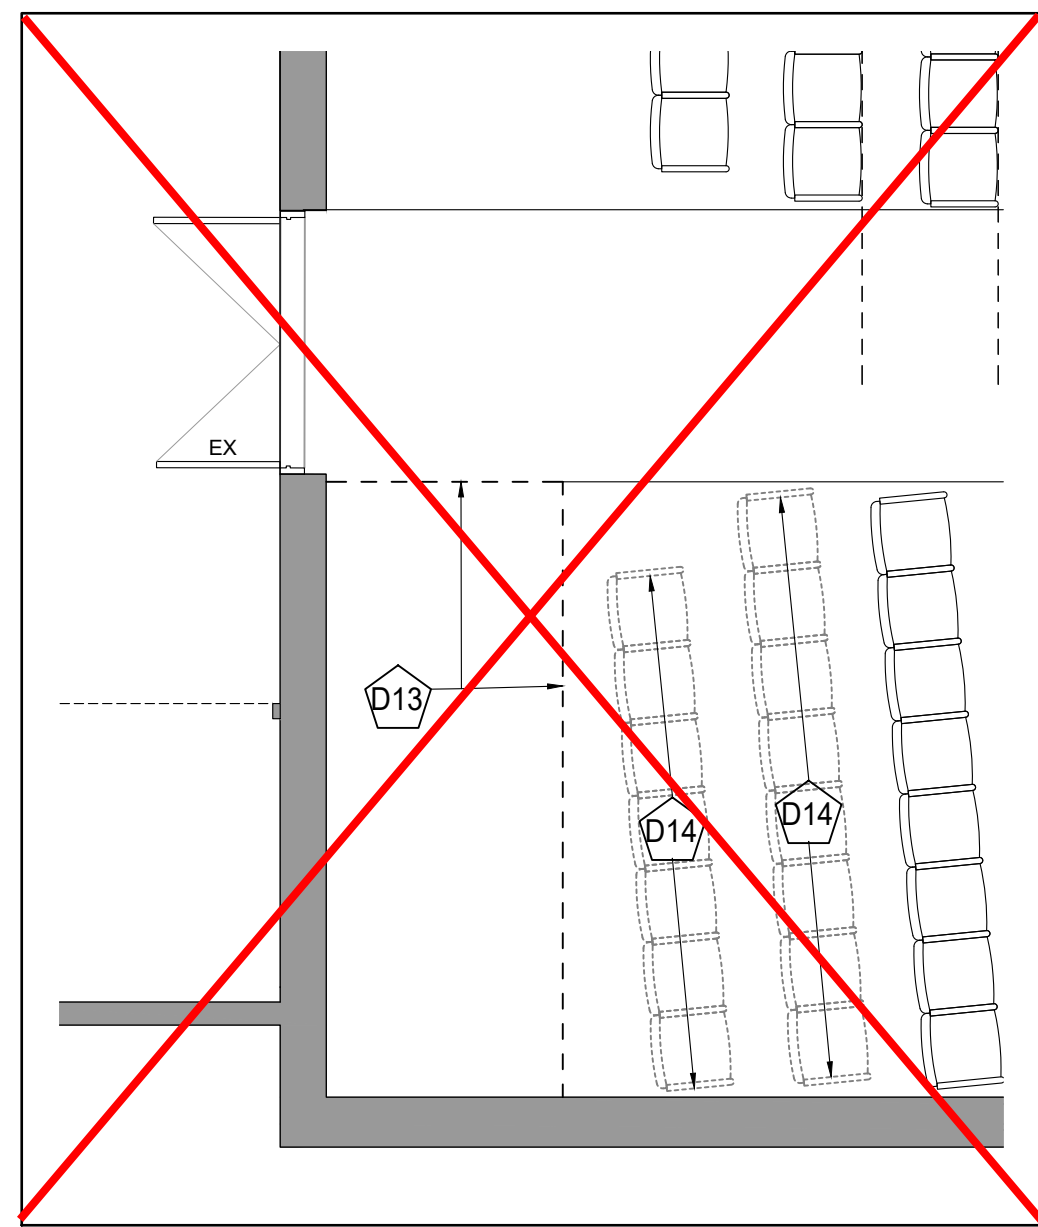


5 FIRST FLOOR - AUDITORIUM DEMOLITION PLAN
A200-D 1:50

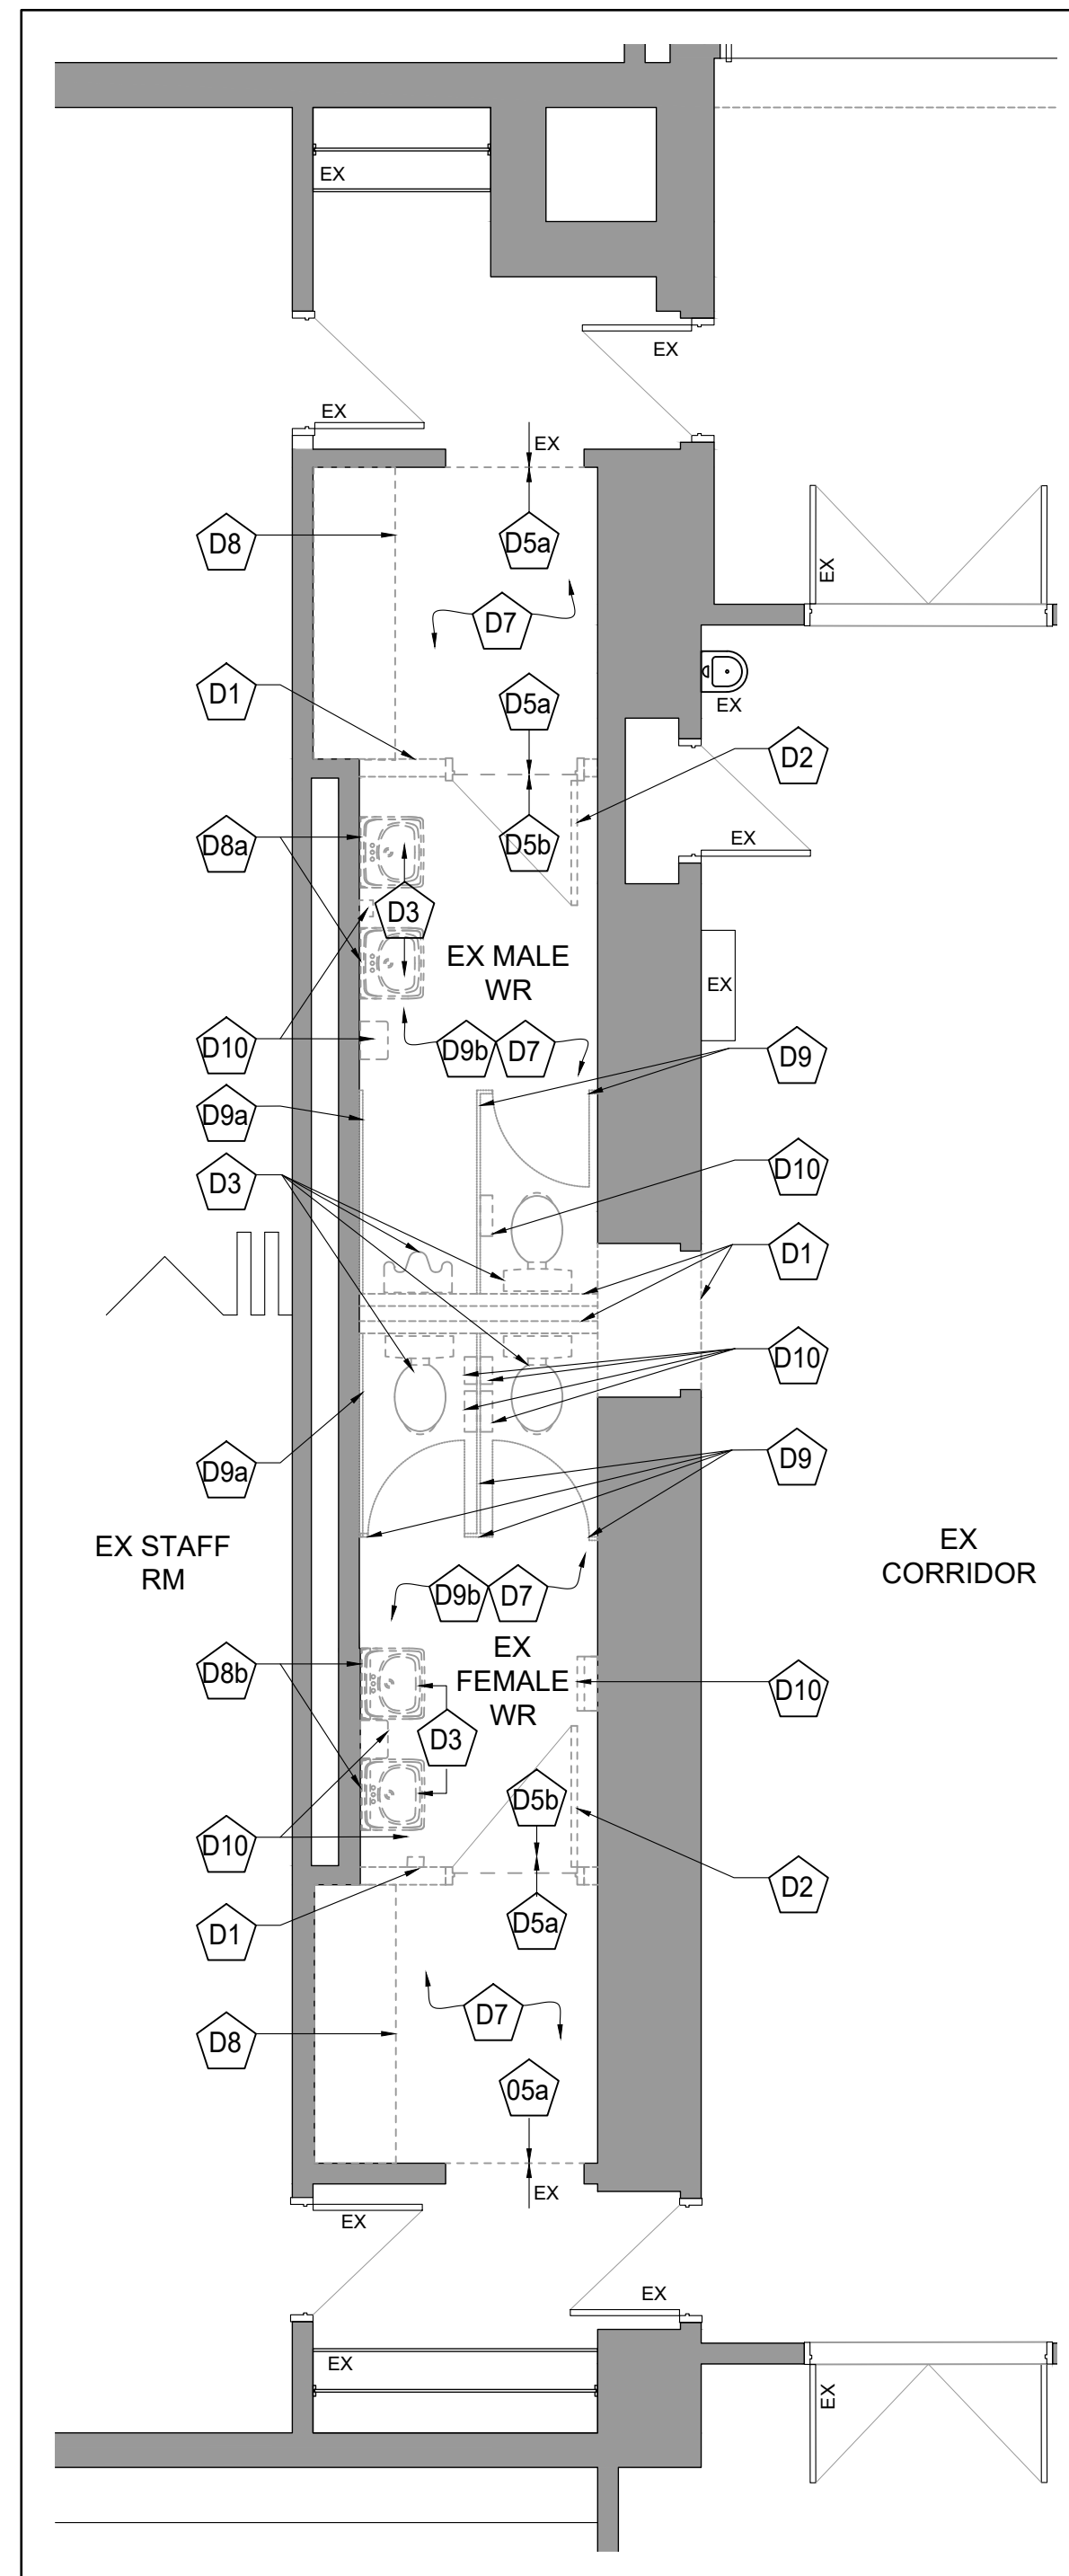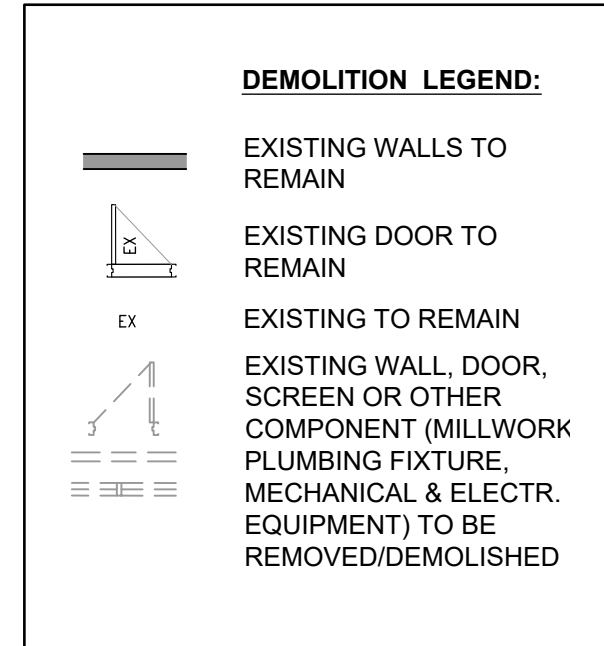

4 FIRST FLOOR GYM WASHROOMS DEMOLITION PLAN
A200-D 1:50

- DEMOLITION NOTES:**
- D1** REMOVE AND DISPOSE EXISTING MASONRY WALL, PARTITION WALL AND/OR CHASE WALL (FULL HEIGHT) C/W ALL ASSOCIATED AND/OR ATTACHED COMPONENTS. CAP TERMINATED SERVICES, OR PREPARE FOR RELOCATION - REFER TO MECHANICAL AND ELECTRICAL DRAWINGS FOR DETAILS. REPAIR AND MAKE GOOD ALL SURFACES. MAKE READY TO RECEIVE PROPOSED WORK.
 - D1a** REMOVE AND DISPOSE EXISTING MASONRY WALL FOR NEW DOOR AND/OR SCREEN OPENING. REMOVE ASSOCIATED AND/OR ATTACHED COMPONENTS. CAP TERMINATED SERVICES, OR PREPARE FOR RELOCATION - REFER TO MECHANICAL AND ELECTRICAL DRAWINGS FOR DETAILS. MAKE GOOD ALL SURFACES & READY TO RECEIVE NEW WORK. FOR NEW DOOR OPENING TOOTH SAW-CUT DETAIL REFER TO DWG 6/A211-D.
 - D2** REMOVE AND DISPOSE EXISTING DOOR AND FRAME/SCREEN C/W ALL ASSOCIATED COMPONENTS AND/OR ATTACHED COMPONENTS. MAKE GOOD AND READY TO RECEIVE PROPOSED WORK.
 - D2a** REMOVE AND DISPOSE EXISTING SCREEN C/W ALL ASSOCIATED COMPONENTS.
 - D3** REMOVE AND DISPOSE ALL EXISTING PLUMBING, MECH. & ELEC. FIXTURES AND THEIR ASSOCIATED COMPONENTS IN THIS AREA. MAKE GOOD, PATCH ALL AFFECTED CMU WALL OR CONCRETE FLOOR SLAB WHERE NEEDED. LEAVE SURFACES CLEAR AND READY TO RECEIVE NEW PROPOSED WORK (COORDINATE WITH DESCRIBED ACTIVITIES D15 & D15a).
 - D4** REMOVE EXISTING CHALKBOARD, MARKER BOARD, OR TACK BOARD INCLUDING ADHESIVE. MAKE GOOD (INCLUDE FILLING IN DAMAGED BLOCK & PATCHING) & READY TO RECEIVE NEW WORK.
 - D5** REMOVE EXISTING CARPET FLOORING INCLUDING ADHESIVE. PREPARE SURFACE TO RECEIVE NEW FLOOR FINISH - REFER TO FLOOR FINISH & ROOM FINISH SCHEDULE DRAWINGS. ALLOW FOR CUT IN EXISTING SLAB TO REMOVE EXISTING OR/AND TO INSTALL NEW SERVICES - REFER TO MECH. DWGS.
 - D5a** CUT & REMOVE EXISTING SHEET FLOORING INCLUDING ADHESIVE. PREPARE SURFACE TO RECEIVE NEW FLOOR FINISH - REFER TO FLOOR FINISH & ROOM FINISH SCHEDULE DRAWINGS. ALLOW FOR CUT IN EXISTING SLAB TO REMOVE EXISTING OR/AND TO INSTALL NEW SERVICES - REFER TO MECH. DWGS.
 - D5b** REMOVE EXISTING CERAMIC TILE FLOORING. CLEAN, LEVEL THE SURFACE AND PREPARE TO RECEIVE NEW FLOOR FINISH - REFER TO FLOOR FINISH & ROOM FINISH SCHEDULE DRAWINGS. ALLOW FOR CUT IN EXISTING SLAB TO REMOVE EXISTING OR/AND TO INSTALL NEW SERVICES - REFER TO MECH. DWGS.
 - D6** REMOVE EXISTING FLOORING. ALLOW FOR CUTTING EXISTING CONC. SLAB FOR THE PURPOSE OF REMOVING EXISTING, OR PLACING NEW SERVICES. REFER TO MECH. DWGS FOR MORE INFO.
 - D6a** REMOVE EXISTING FLOORING AND RAISED SHOWER SLAB. ALLOW FOR CUTTING EXISTING CONC. SLAB UNDER FOR THE PURPOSE OF REMOVING EXISTING, OR PLACING NEW SERVICES. REFER TO MECH. DWGS FOR MORE INFO. LEVEL & MAKE GOOD THE SURFACE AND PREPARE FOR NEW FINISH.
 - D7** CAREFULLY PREPARE ALL EXISTING MASONRY WALL SURFACES TO RECEIVE PROPOSED NEW WORK (REFER TO ARCH., MECH., AND ELEC. DWGS).
 - D8** REMOVE EXISTING MILLWORK WITH SUPPORTING FRAMING, AND ALL ASSOCIATED COMPONENTS. MAKE GOOD AND PREPARE TO RECEIVE NEW FINISHES. ALLOW FOR FILL IN OF DAMAGED MASONRY WALL.
 - D8a** REMOVE EXISTING MIRROR WITH SUPPORTING BACKING, AND ALL ASSOCIATED COMPONENTS. MAKE GOOD AND PREPARE TO RECEIVE NEW PAINT. ALLOW FOR FILL IN OF DAMAGED MASONRY WALL.
 - D8b** REMOVE EXISTING SHELF AND MIRROR WITH SUPPORTING BACKING, AND ALL ASSOCIATED COMPONENTS. MAKE GOOD AND PREPARE TO RECEIVE NEW FINISH. ALLOW FOR FILL IN OF DAMAGED MASONRY WALL.
 - D9** REMOVE AND DISPOSE ALL EXISTING TOILET PARTITIONS INCLUDING DOORS AND ALL THEIR ASSOCIATED COMPONENTS. MAKE GOOD, PATCH ALL AFFECTED SURFACES AND LEAVE THEM CLEAR AND READY TO RECEIVE PROPOSED NEW WORK.
 - D9a** REMOVE AND DISPOSE EXISTING WALL PANEL W/ ALL ASSOCIATED COMPONENTS. IN-FILL, PATCH & MAKE GOOD EXISTING MASONRY WALL & PREPARE IT TO RECEIVE NEW FINISH.
 - D9b** REMOVE AND DISPOSE EXISTING CERAMIC WALL TILES. CLEAN THE WALLS FROM MORTAR, IN-FILL & PATCH, MAKE GOOD AND READY TO RECEIVE NEW WALL FINISH.
 - D10** REMOVE AND DISPOSE EXISTING WALL MOUNTED DISPENSER OR DISPOSAL CONTAINER.
 - D10a** REMOVE AND DISPOSE EXISTING WALL MOUNTED ACCESSORIES.
 - D11** REMOVE AND DISPOSE EXISTING VCT FLOORING, ADHESIVE AND BASE. PATCH AND MAKE GOOD SLAB TO RECEIVE NEW FLOOR FINISH.
 - D12** REMOVE AND DISPOSE EXISTING METAL UPRIGHT PANEL AND ITS ATTACHED COMPONENTS. PATCH, MAKE GOOD & READY ALL AFFECTED SURFACES TO RECEIVE PROPOSED WORK.
 - D13** CUT & REMOVE EXISTING CONCRETE SLAB. PREPARE AREA FOR NEW WORK.
 - D14** REMOVE EXISTING FIXED THEATRE SEATING.
 - D15** REMOVE EXISTING TERRAZZO FLOORING AND PREPARE THE SURFACE TO RECEIVE NEW CONCRETE TOPPING. INCLUDE FOR EXCAVATION FOR SANITARY LINE CONNECTIONS - REFER TO MECH. DWGS.
 - D15a** REMOVE EXISTING FLOOR FINISH, SLAB & SUB-GRADE FOR NEW SANITARY CONNECTIONS. REFER TO MECH. DWGS. RE-INSTATE THE SLAB AFTER COMPLETION OF WORK & PREPARE THE SURFACE TO RECEIVE NEW FLOOR FINISH.

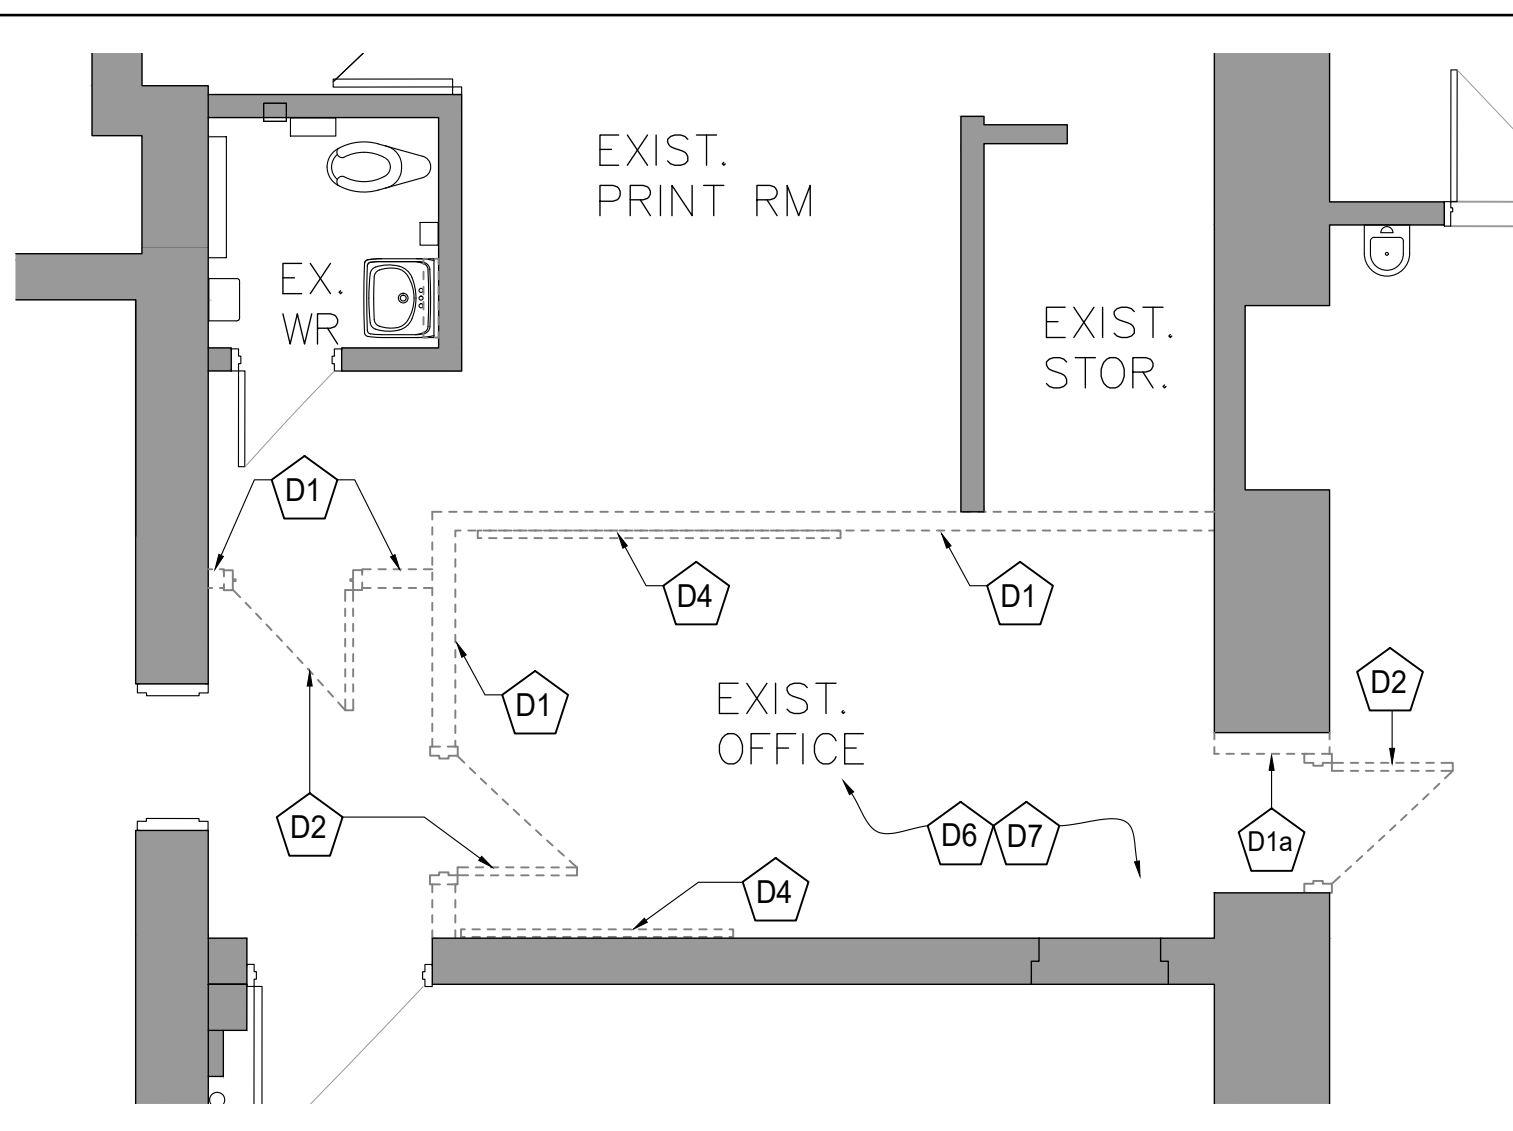

6 SECOND FLOOR GENERAL OFFICE DEMOLITION PLAN
A200-D 1:50

**BURLINGTON CENTRAL
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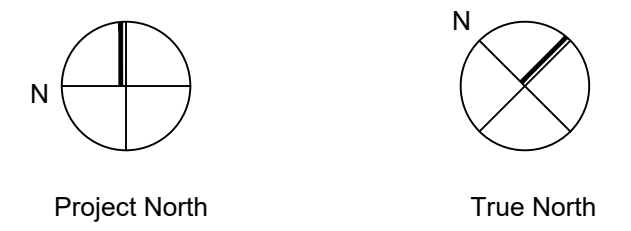
RECEIVED

AUG 11 2023

CITY OF BURLINGTON
BUILDING DEPARTMENT

ALL CONSTRUCTION TO
MEET ONTARIO BUILDING
CODE REQUIREMENTS

Key Plan N.T.S.



No.	Revisions	Date
3	RE-ISSUED FOR PERMIT	2023/08/08
2	ISSUED FOR PERMIT	2023/06/14
1	ISSUED FOR PC #14	2023/06/02
No.	Issue	Date

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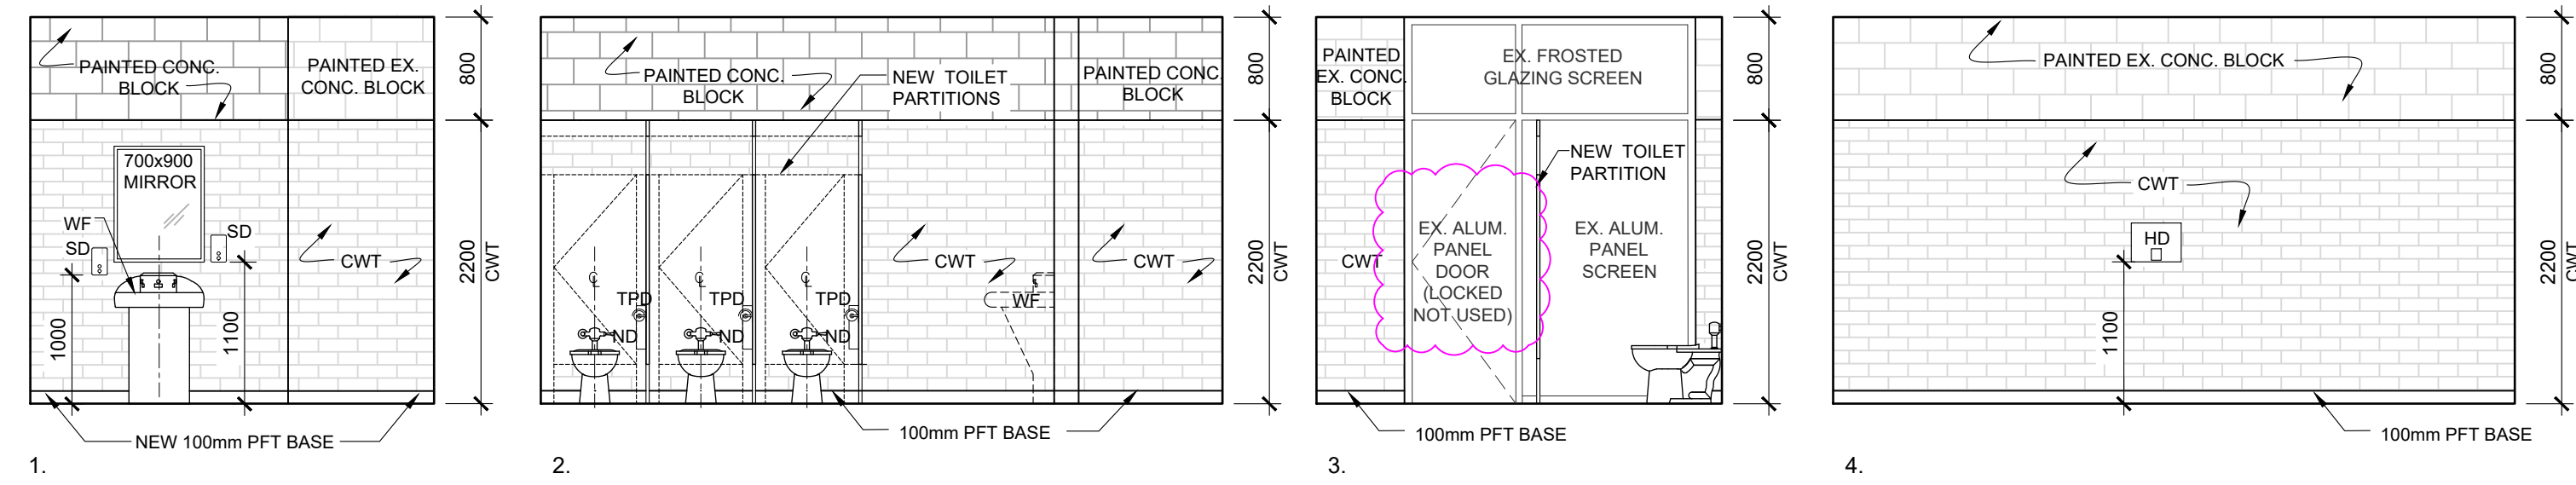
Drawing Title:
**FIRST, SECOND & THIRD
FLOOR - DEMOLITION PLANS**

Scale: AS NOTED Date: 19-04-2023


Drawn by: Checked by:

Job No. Drawing No.


2005 A200-D




1 INTERIOR ELEVATIONS - WASHROOM 100F
A201 1:50

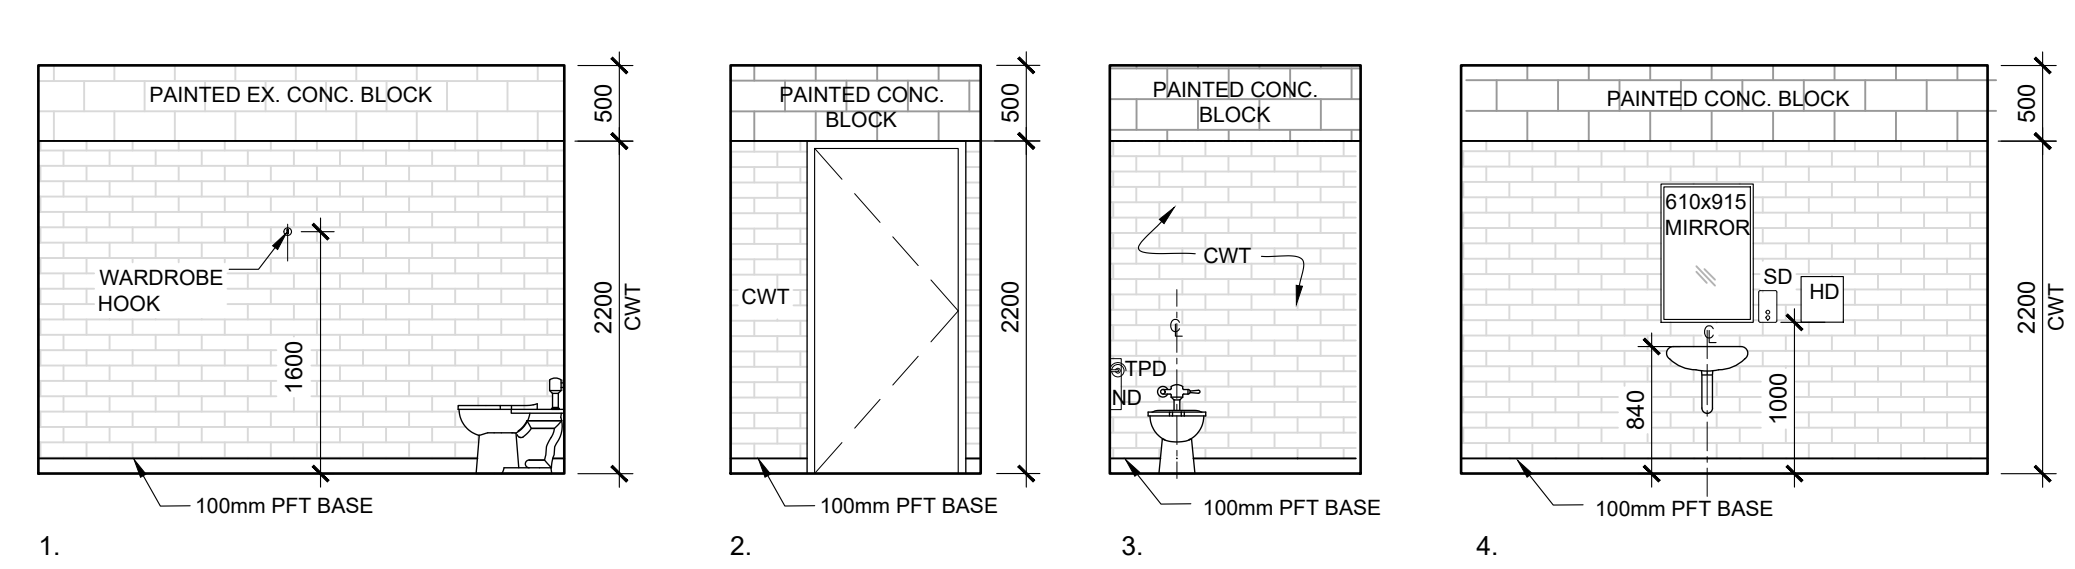


2 INTERIOR ELEVATIONS - STAFF WASHROOM 100D
A201 1:50

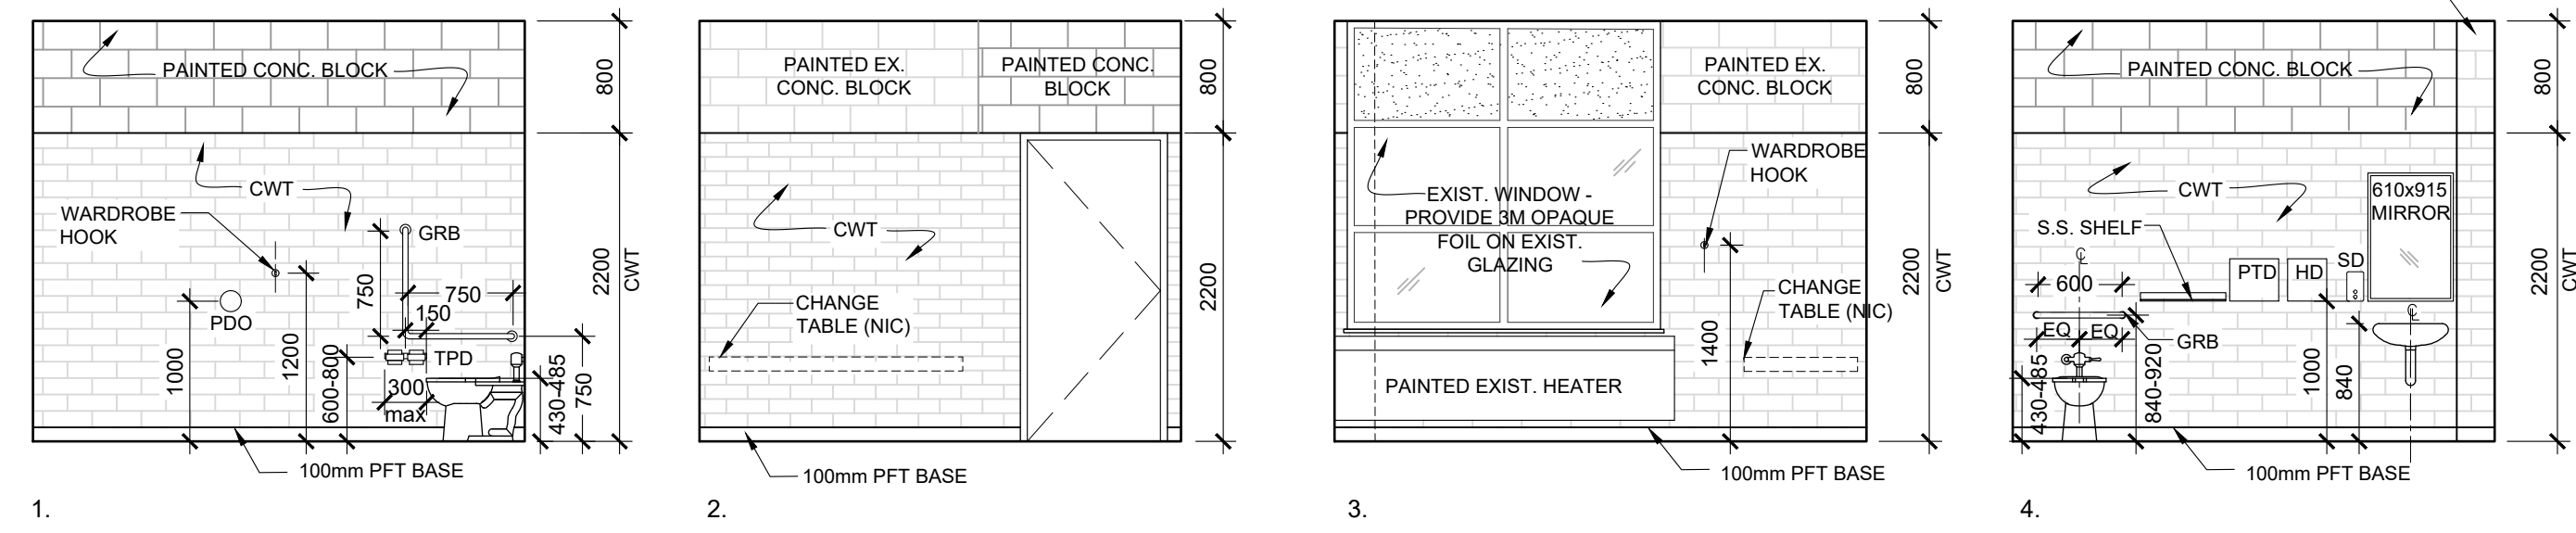


3 INTERIOR ELEVATIONS - UNIVERSAL WASHROOM 100C
A201 1:50

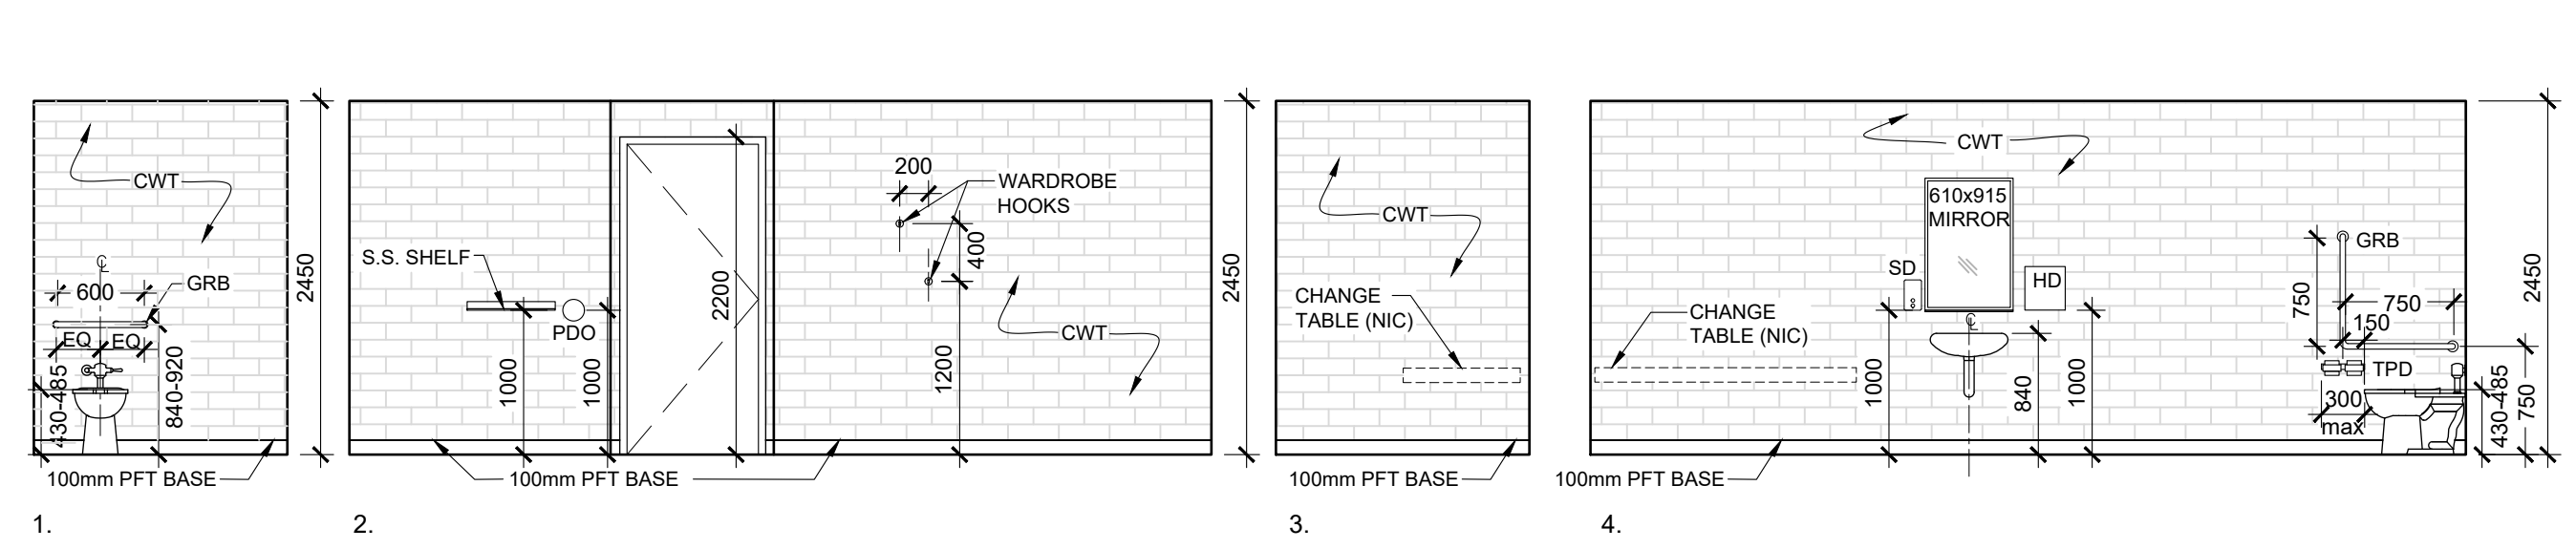


8 INTERIOR ELEVATIONS - UNIVERSAL WASHROOM 301
A201 1:50

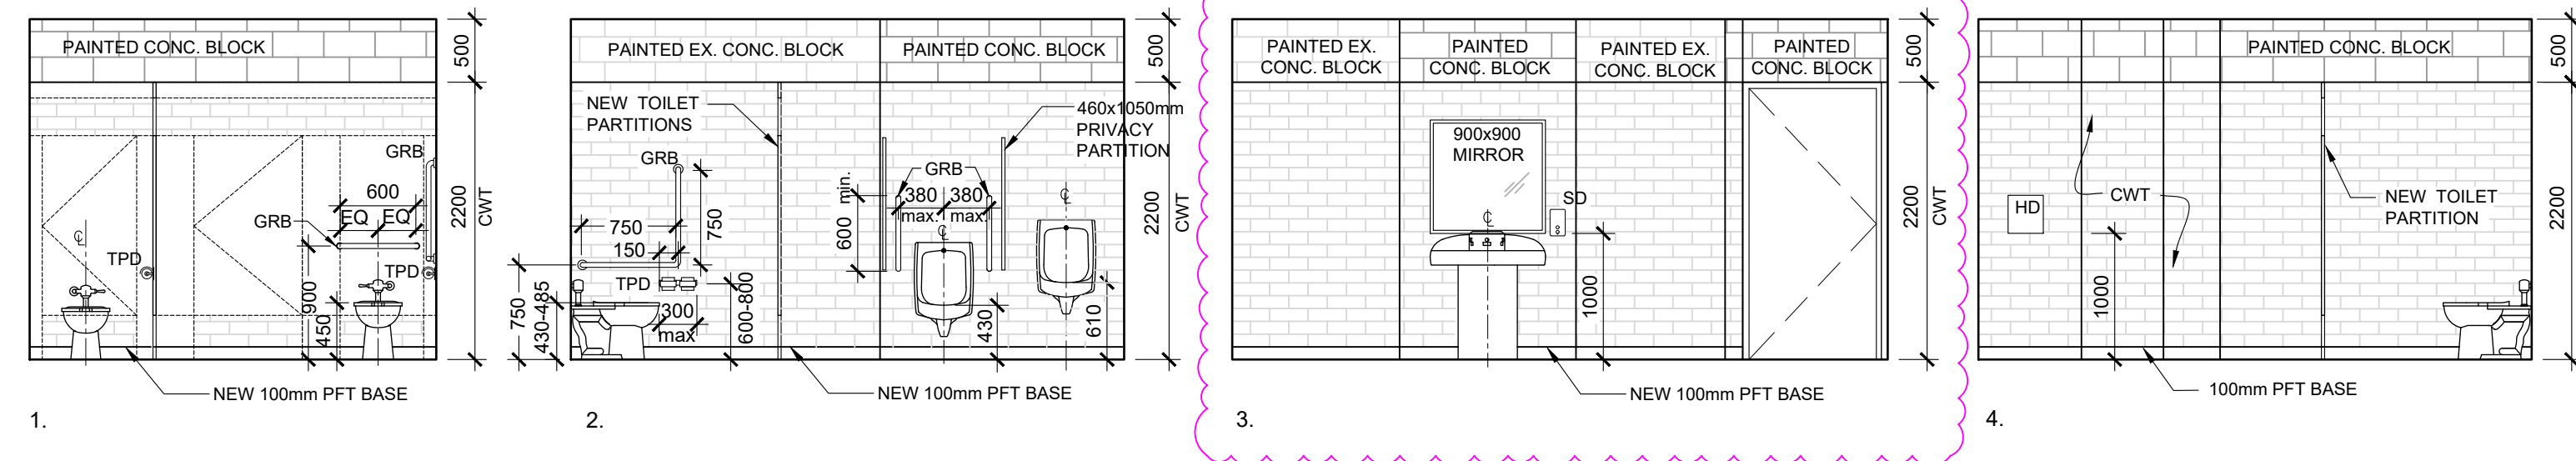


4 INTERIOR ELEVATIONS - BOYS WASHROOM 100B
A201 1:50

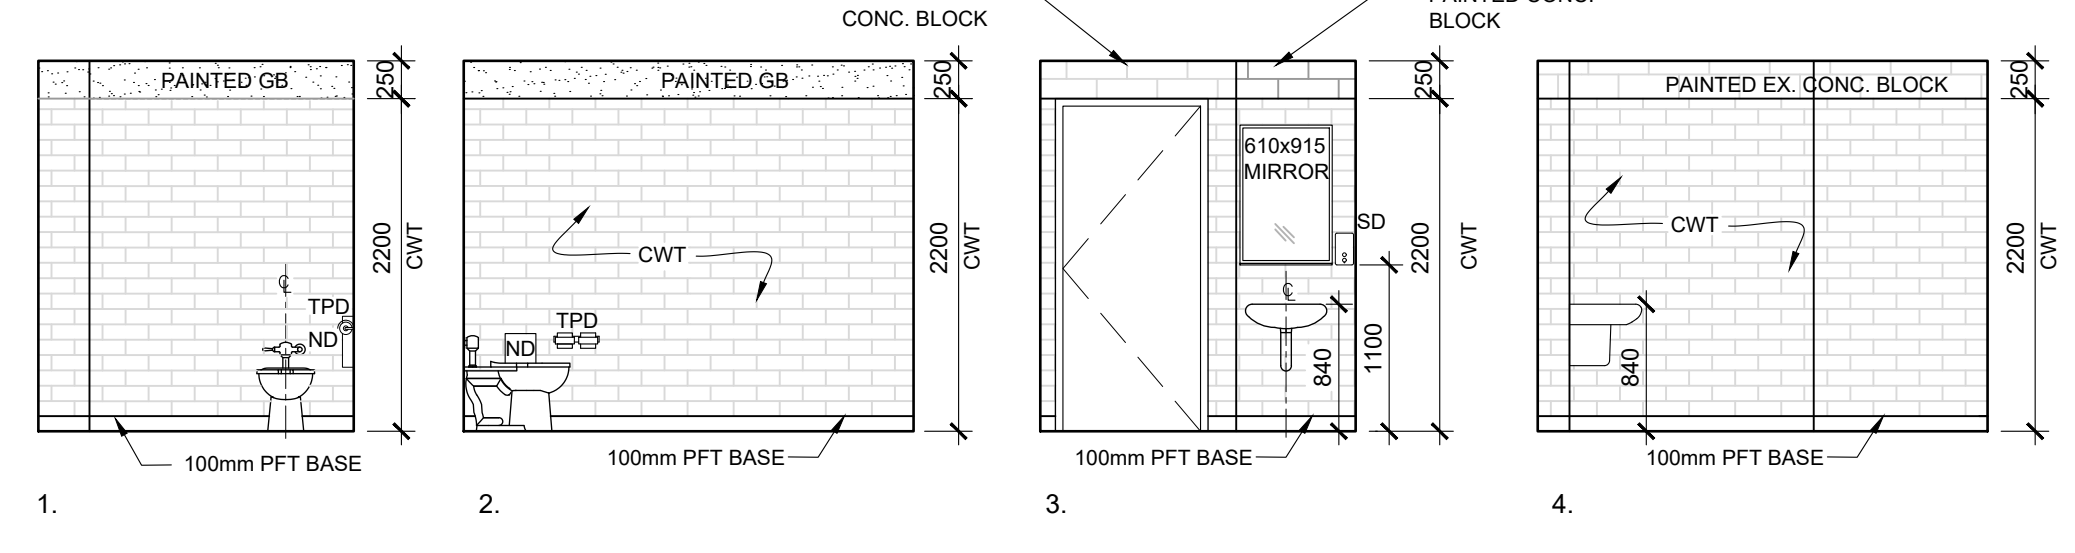

9 INTERIOR ELEVATIONS - STAFF WASHROOM 301B
A201 1:50

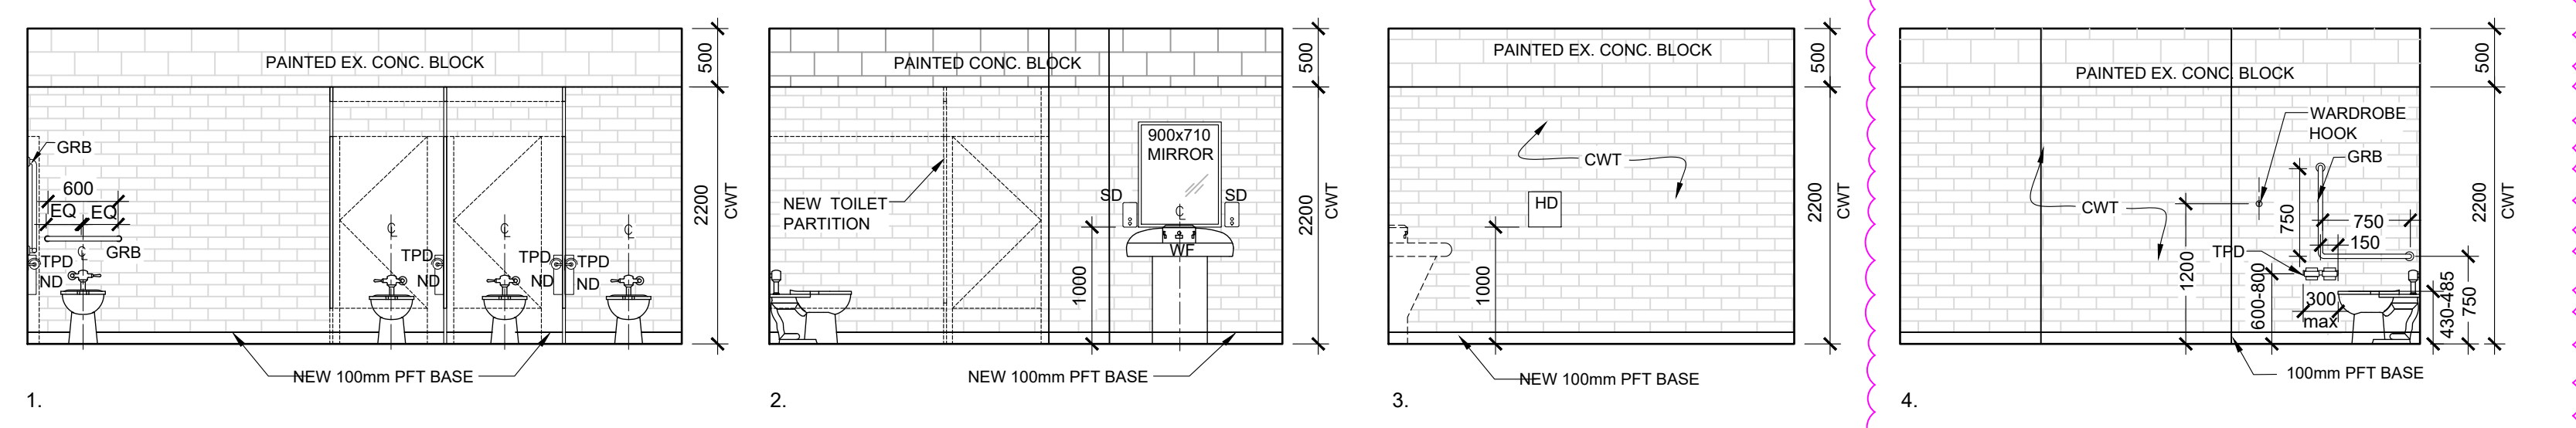


5 INTERIOR ELEVATIONS - GIRLS WASHROOM 100A
A201 1:50

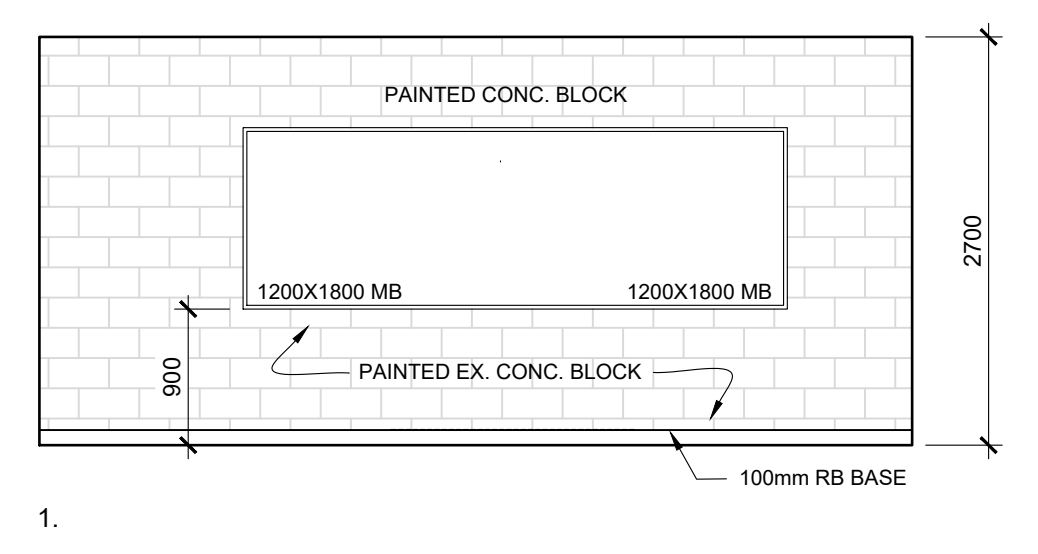


10 INTERIOR ELEVATIONS - SEMINAR ROOM 200D
A201 1:50

ABBREVIATIONS:

- EX EXISTING
- PDO POWER DOOR OPERATOR
- S.S. STAINLESS STEEL
- HD HAND DRYER
- GRB GRAB BAR
- TPD TOILET PAPER DISPENSER
- SD SOAP DISPENSER
- ND NAPKIN DISPOSAL
- CWT CERAMIC WALL TILES
- PFT PORCELAIN FLOOR TILES
- WF WASHFOUNTAIN
- MB MARKER BOARD

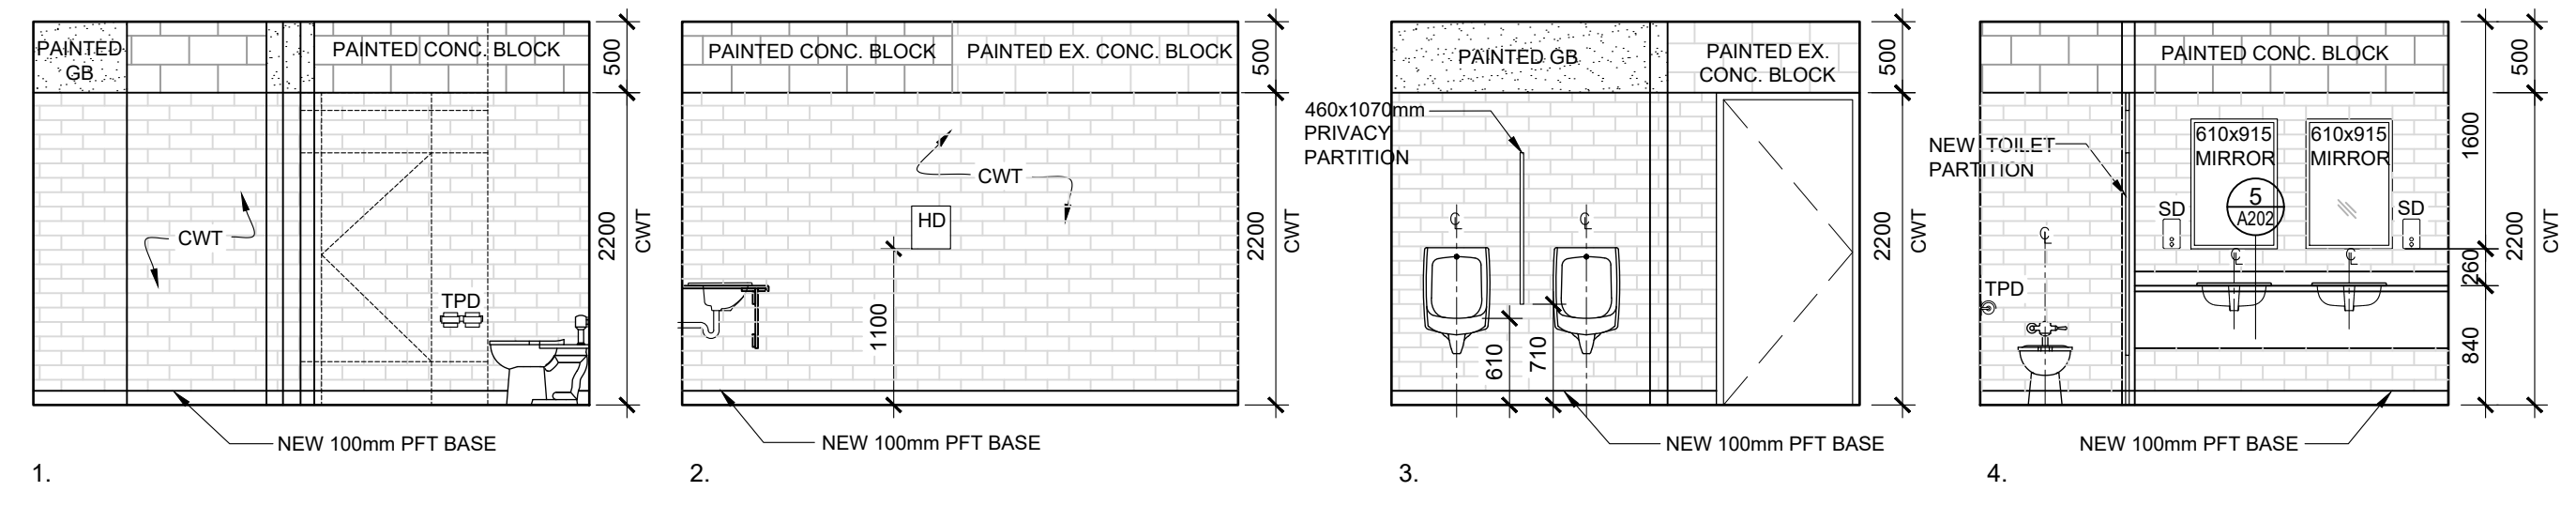

6 INTERIOR ELEVATIONS - MALE STAFF WASHROOM 200B
A201 1:50

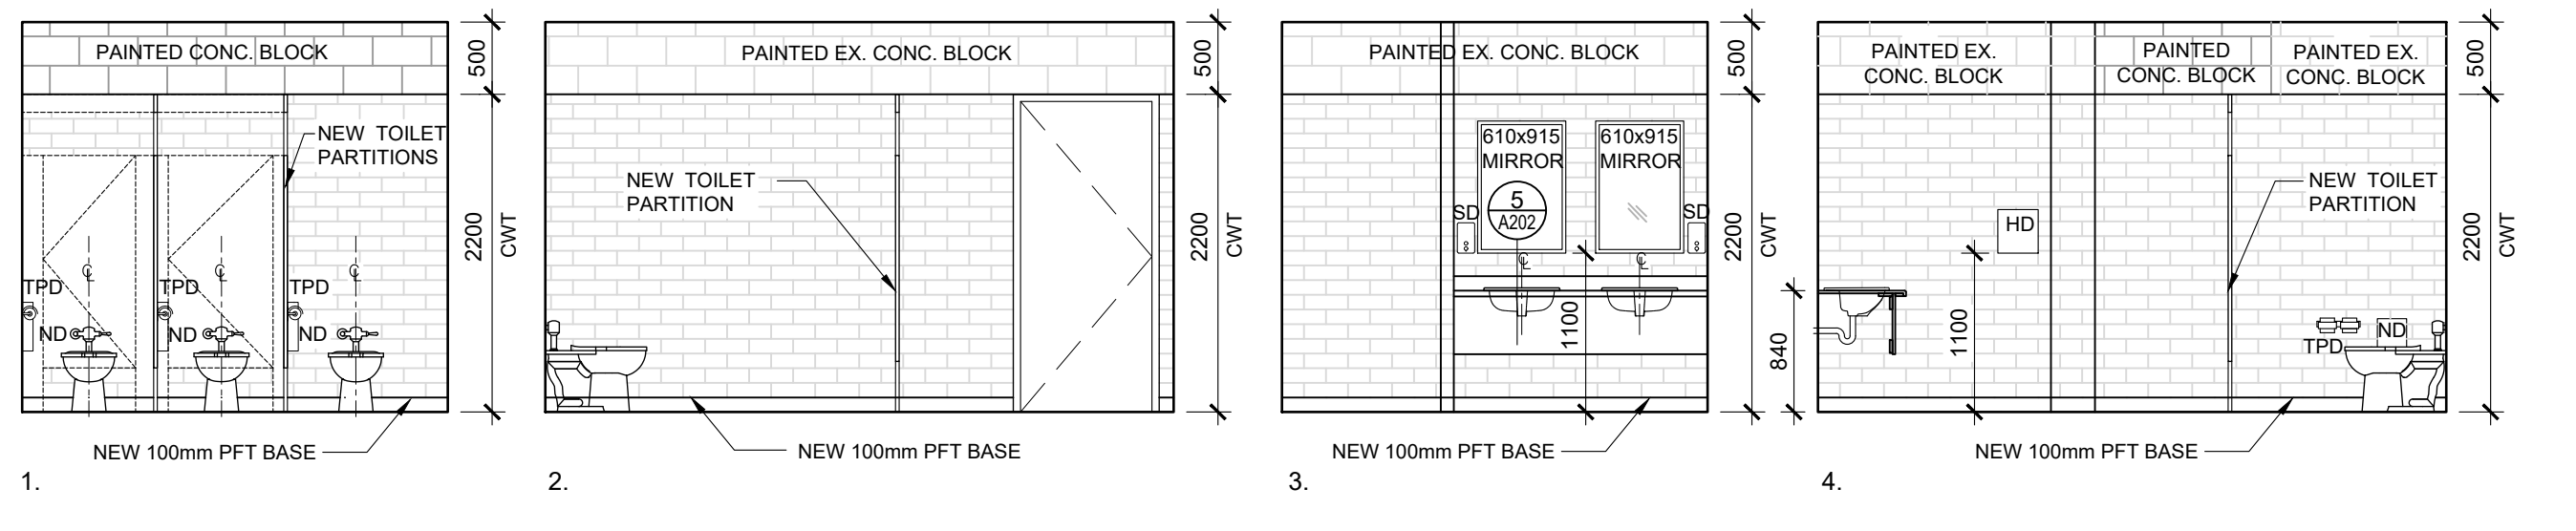

7 INTERIOR ELEVATIONS - FEMALE STAFF WASHROOM 200A
A201 1:50

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BUILDING DEPARTMENT

ALL CONSTRUCTION TO
MEET ONTARIO BUILDING
CODE REQUIREMENTS

Key Plan N.T.S.

No.	Revisions	Date
4	RE-ISSUED FOR PERMIT	2023/10/31
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No.	Issue	Date

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Drawing Title:

INTERIOR ELEVATIONS

Scale: AS NOTED Date: 19-04-2023


Drawn by: Checked by:

Job No. Drawing No.


2005 A201

OCCUPANT LOAD FOR PLUMBING		
STUDENTS		
59 CLASSROOMS X 28 STUDENTS	=	1652
TOTAL STUDENTS	=	1652
STAFF		
59 CLASSROOMS X 1 TEACHER	=	59
GENERAL OFFICE 290sqm / 9.3	=	31
STUDENT SERVICES & SPEC. ED. OFFICE 227sqm / 9.3	=	25
LIBRARY AND OTHER SUPPORT STAFF	=	10
MAINTENANCE STAFF	=	10
TOTAL STAFF	=	135
TOTAL STUDENTS & STAFF	=	1787


PLUMBING FIXTURES COUNT						
FIXTURE	TOILETS		URINALS	LAVATORY	PERMISSIBLE OCCUPANT LOAD	
	MALE	FEMALE			TOTAL	PERMISSIBLE
STUDENTS						
FIRST FLOOR						
MALE	6	6	12	9	12X30 = 360	
FEMALE	18		18	11	18X26 = 468	
UNIVERSAL WASHROOMS	3		3	3	3X30 = 90	
UNI-SEX WASHROOMS	-		-	-	-	
SECOND FLOOR						
MALE	4	4	8	4	8X30 = 240	
FEMALE	6		6	3	6X26 = 156	
UNIVERSAL WASHROOMS	1		1	1	1X30 = 30	
UNI-SEX WASHROOMS	-		-	-	-	
THIRD FLOOR						
MALE	4	5	9	5	9X30 = 270	
FEMALE	7		7	4	7X26 = 182	
UNIVERSAL WASHROOMS	1		1	1	1X30 = 30	
UNI-SEX WASHROOMS	-		-	-	-	
TOTAL FOR STUDENTS						
			65			1826
STAFF						
FIRST FLOOR						
MALE	2	2	4	2	4X30 = 120	
FEMALE	2		2	2	2X26 = 52	
UNI-SEX WASHROOMS	3		3	3	3X26 = 78	
SECOND FLOOR						
MALE	1	2	3	2	3X30 = 90	
FEMALE	3		3	2	3X26 = 78	
UNI-SEX WASHROOMS	1		1	1	1X26 = 26	
THIRD FLOOR						
MALE	-	-	-	-	-	
FEMALE	-	-	-	-	-	
2 UNI-SEX WASHROOMS	2		2	2	2X26 = 52	
TOTAL FOR STAFF						
			18			496

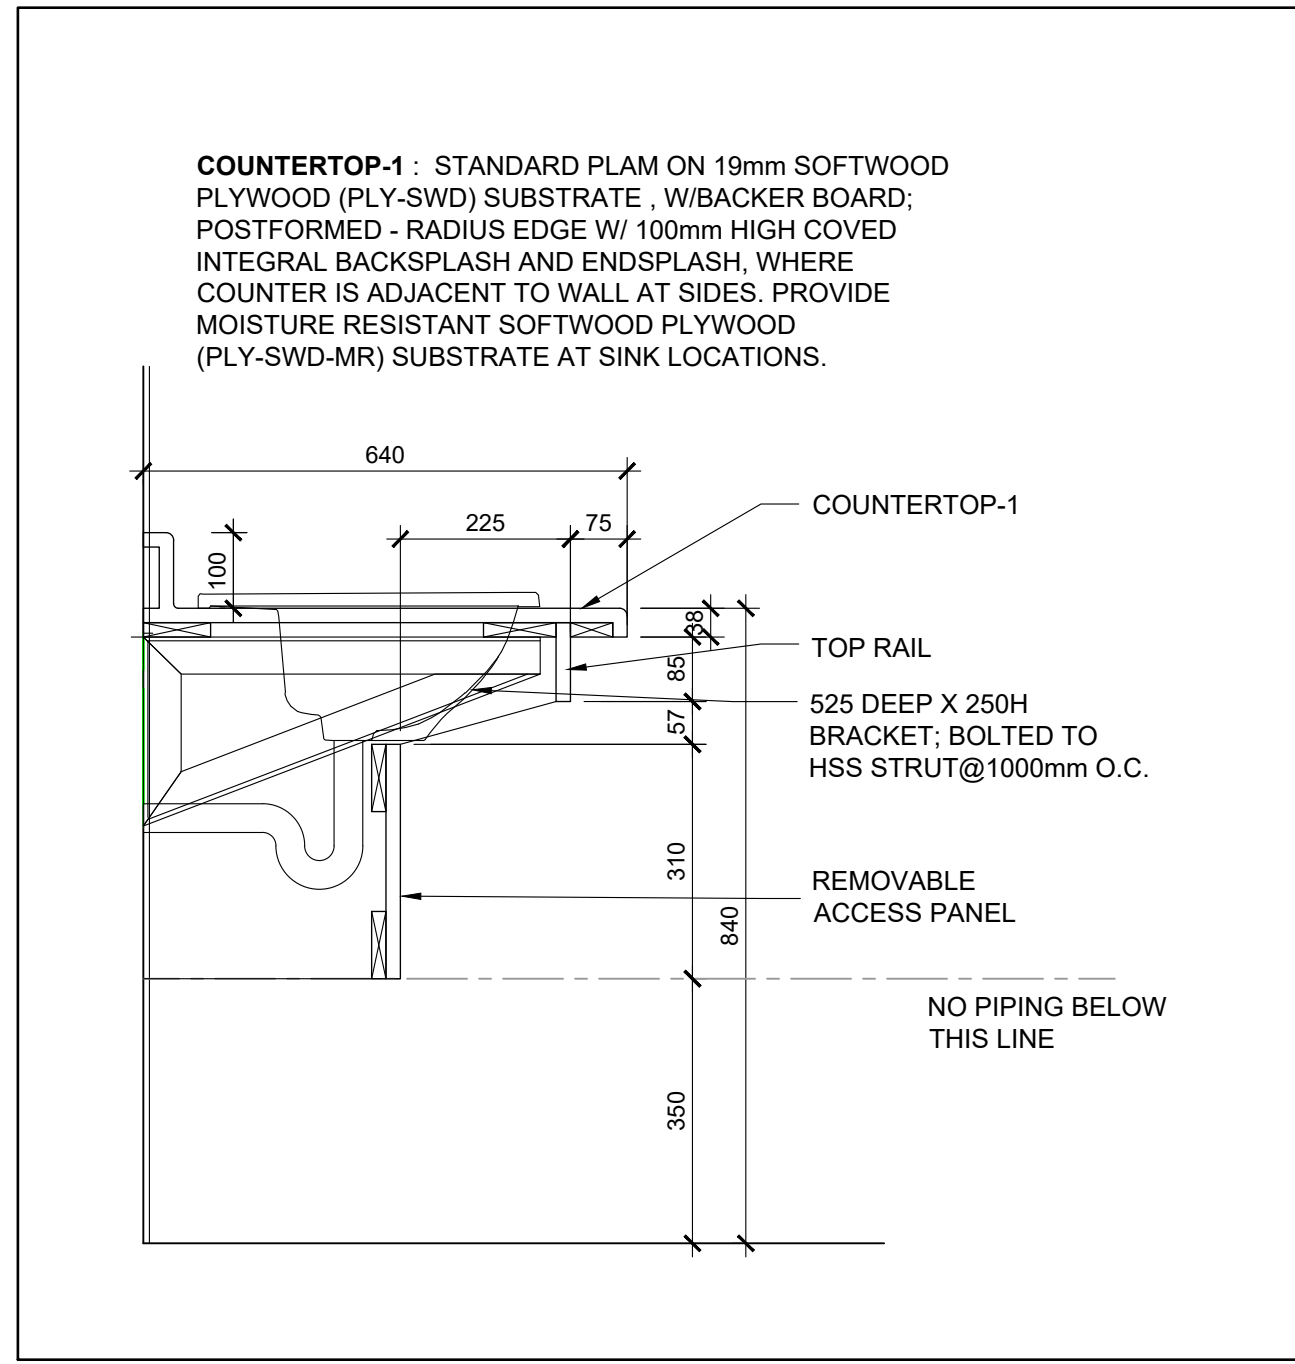


5 STAFF WR LAVATORY SECTION DETAIL
A202 1:10

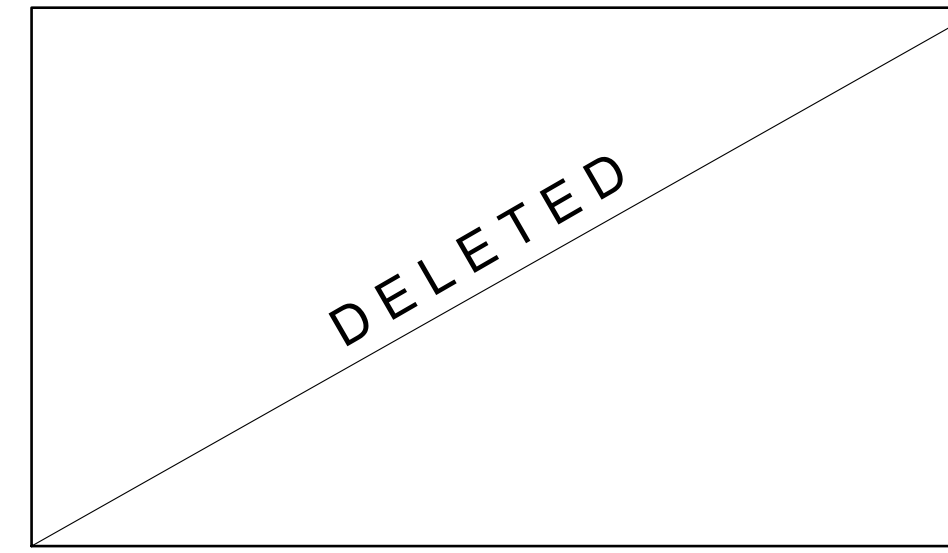


1 FIRST FLOOR - AUDITORIUM BF SEATING - SECTION 1
A202 1:50

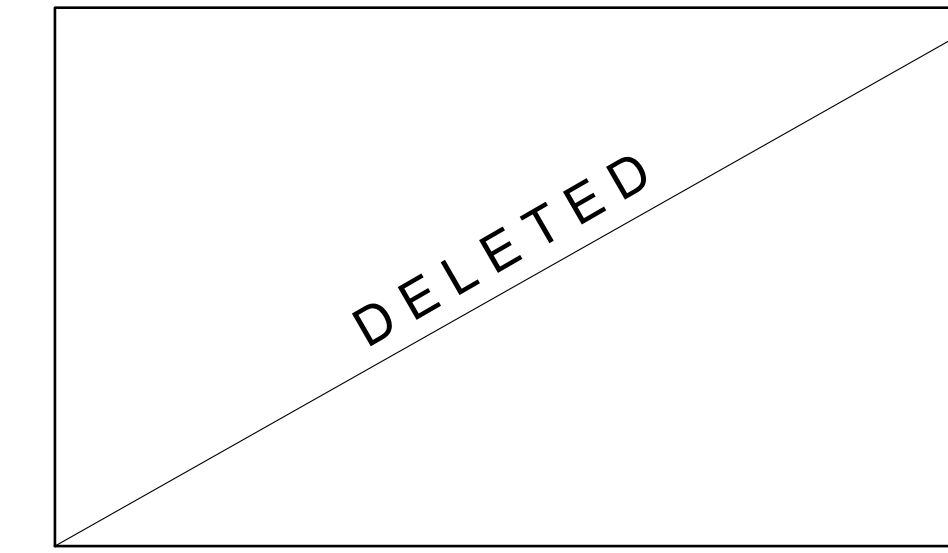


2 FIRST FLOOR - AUDITORIUM BF SEATING - SECTION 2
A202 1:50

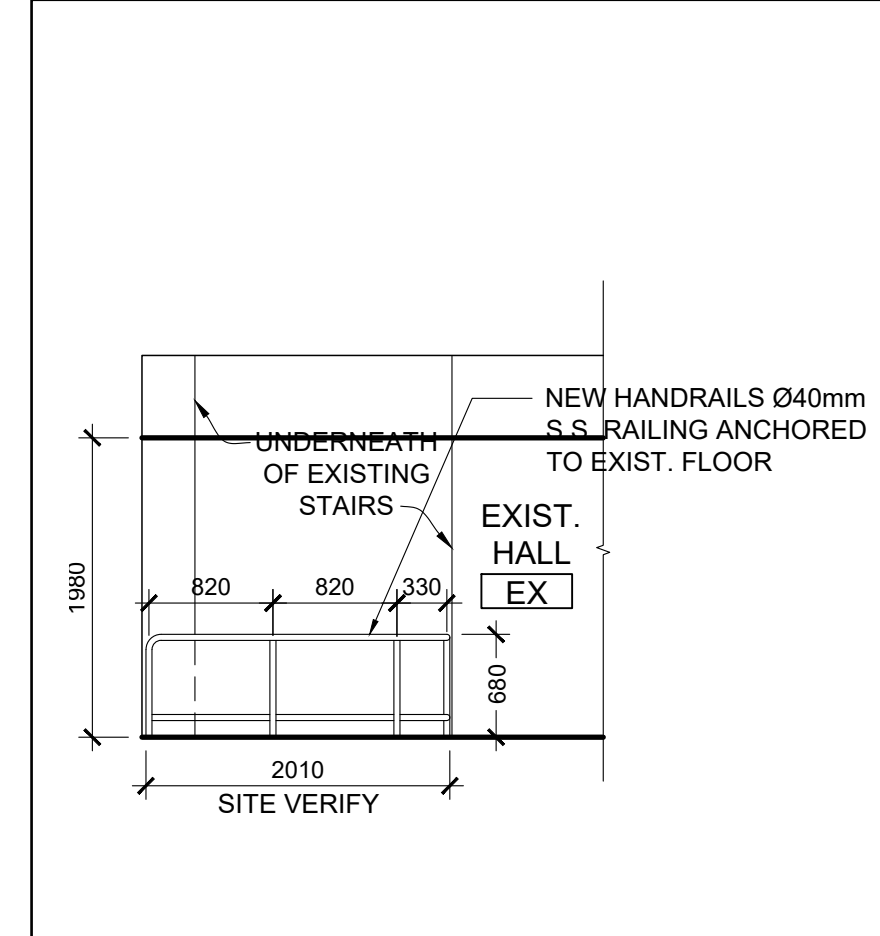

3 RAILING UNDER STAIR IN EXIST. HALL - ELEVATION 1
A202 1:50

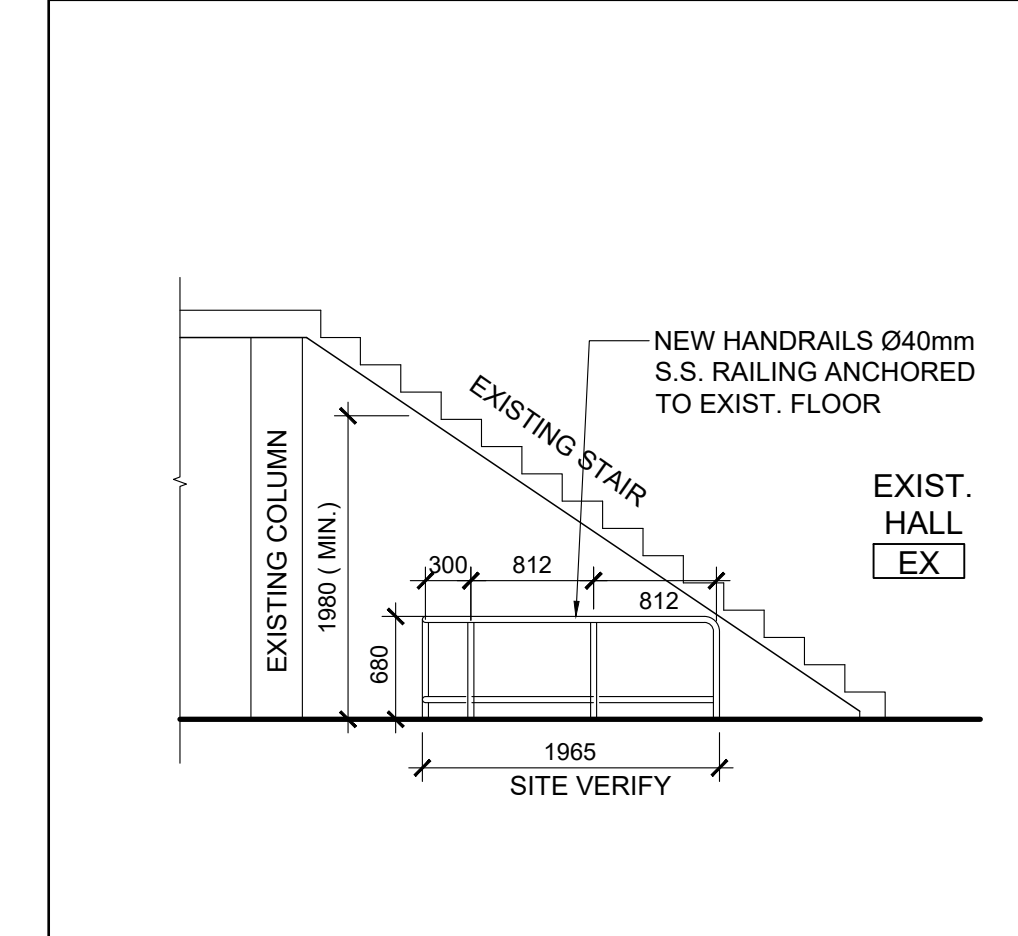

4 RAILING UNDER STAIR IN EXIST. HALL - ELEVATION 2
A202 1:50

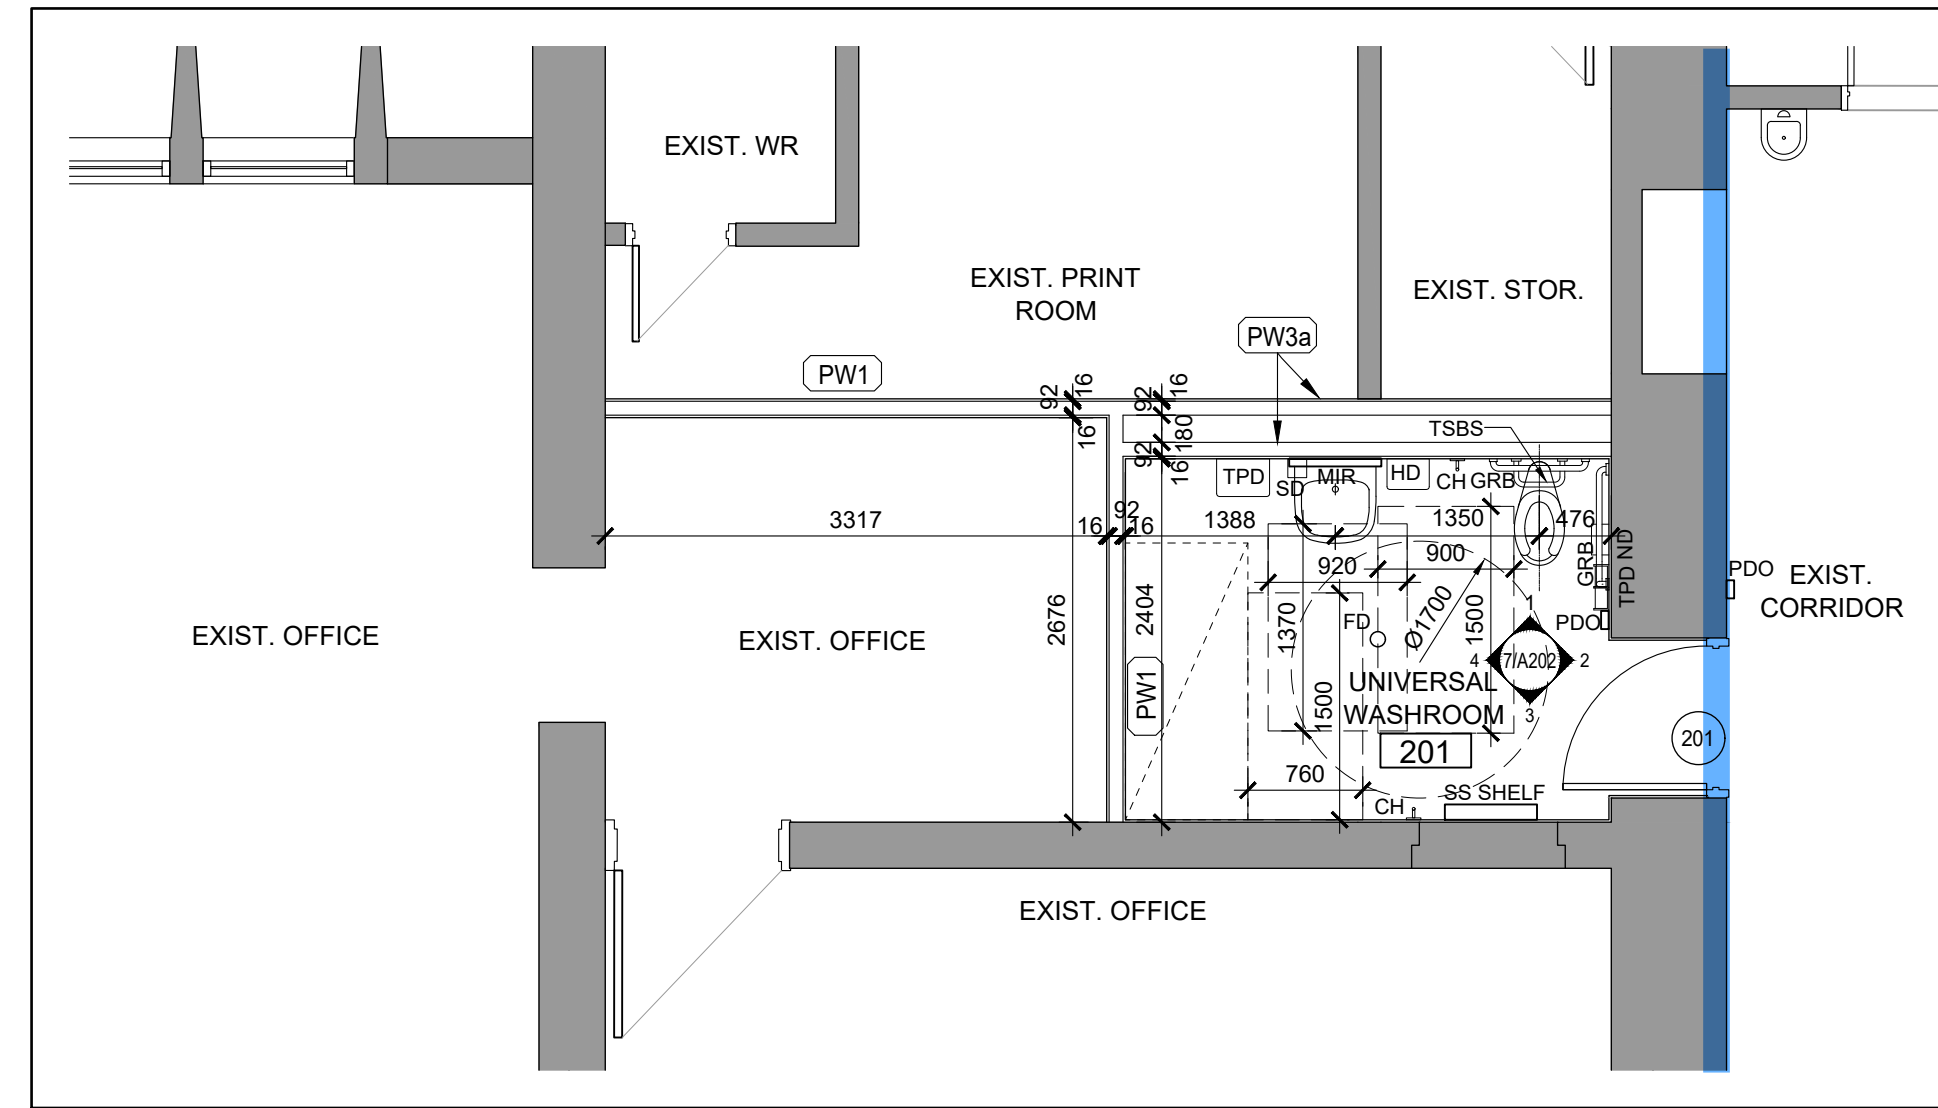

6 SECOND FLOOR UNIVERSAL WASHROOM
A202 1:50

1 HR. FRR

ALL FIRE SEPARATIONS SHALL BE CONTINUOUS BETWEEN REQUIRED FIRE COMPARTMENTS. ALL OPENINGS IN THE FIRE SEPARATION MUST BE PROTECTED (UNLESS OTHERWISE NOTED).


Firestopping used at penetrations and joints in fire separations and fire-rated assemblies shall comply with Div. B, 3.1.9. of the OBC. The approved fire stop system and installation details must be submitted to the field inspector for approval. Installation shall be coordinated on site and is subject to the approval of the field inspector.

Except as permitted in articles 3.1.9.3. & 3.1.9.4. of the OBC, pipes, ducts, electrical outlet boxes, enclosed raceways or other service equipment that partly or wholly penetrate a fire-rated assembly shall be non-combustible unless the assembly has been tested using such equipment.

All Exits and Access to Exits shall be clearly visible and accessible at all times.

Barrier free doorways and doors shall comply to Div. B, 3.8.3.3. of the OBC and maintain a minimum 1100mm unobstructed barrier free path of travel.

UNIVERSAL WASHROOMS to comply with Div. B, 3.8.3.12. Ontario Building Code 2012

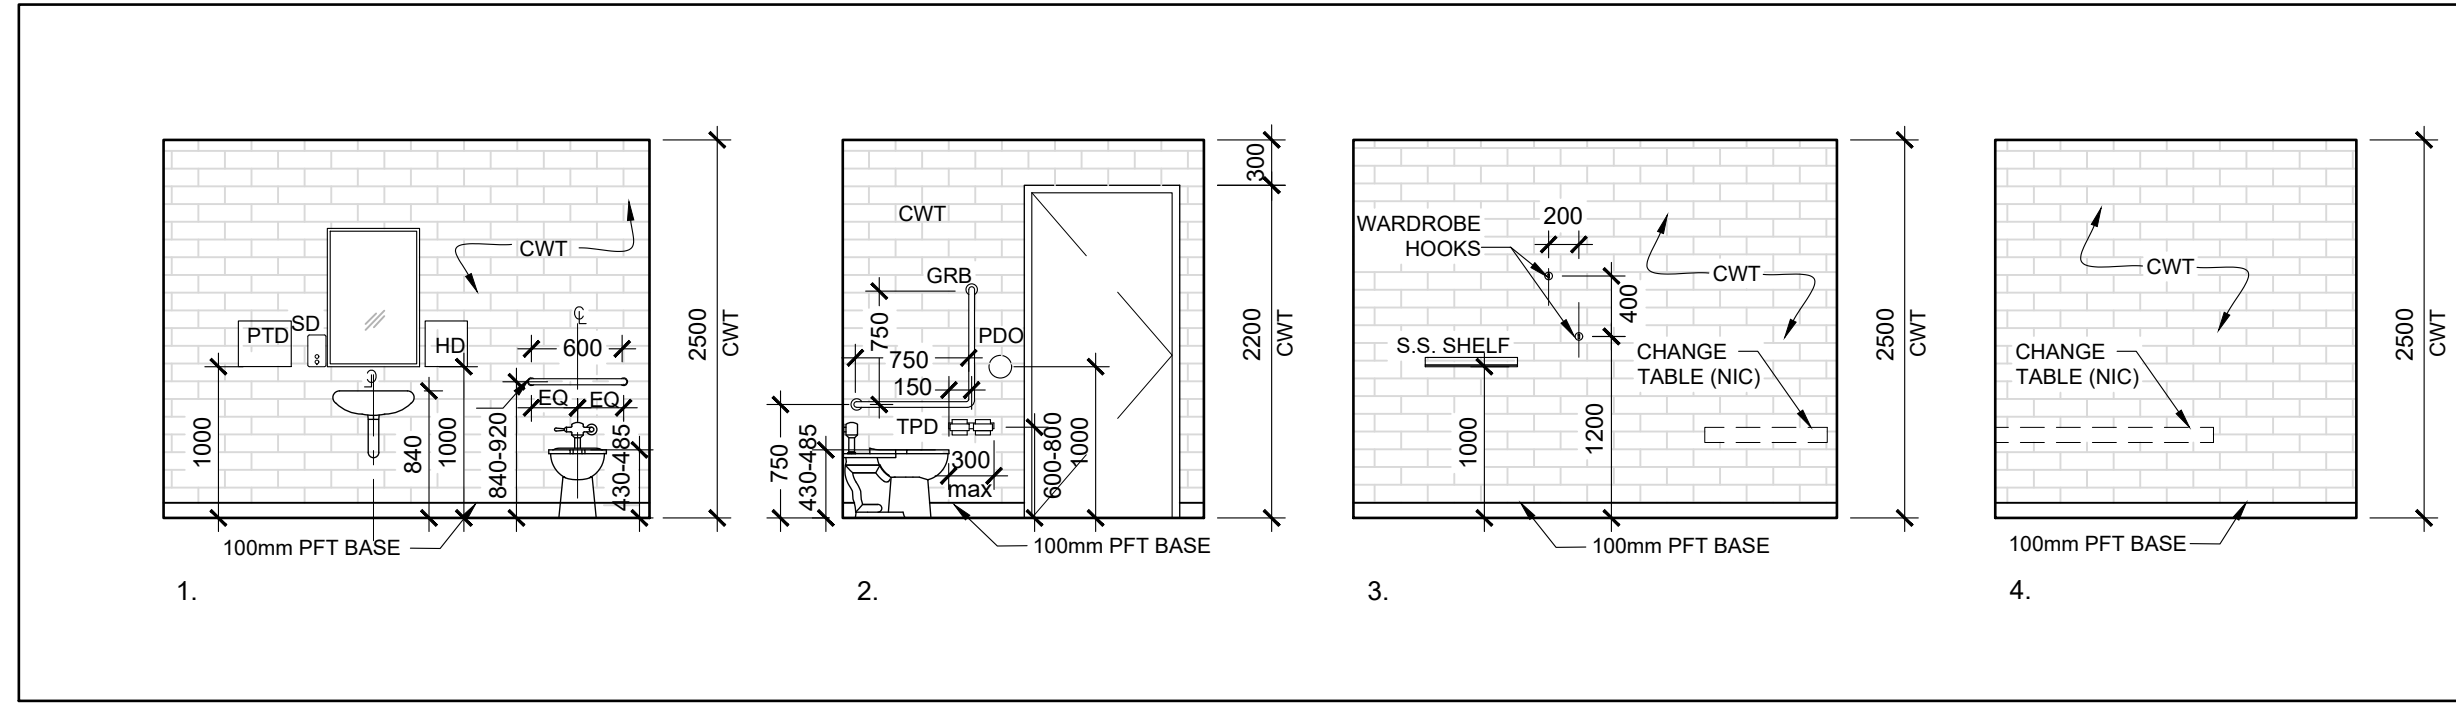

7 SECOND FLOOR UNIVERSAL WASHROOM - INTERIOR ELEVATIONS
A202 1:50

Client
Halton District School Board
2050 Guelph Line
Burlington, Ontario

**BURLINGTON CENTRAL
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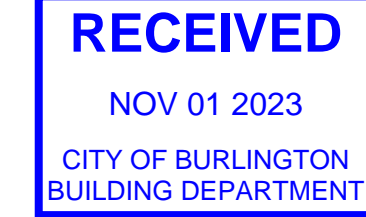
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Mechanical and Electrical Consultants

CK Engineering Inc.

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Burlington, Ontario, L7P 1A5
Tel: 905-631-1115



ALL CONSTRUCTION TO MEET ONTARIO BUILDING CODE REQUIREMENTS

Key Plan N.T.S.



No. Revisions Date

No.	Revisions	Date
5	RE-ISSUED FOR PERMIT	2023/10/31
4	RE-ISSUED FOR PERMIT	2023/09/08
3	RE-ISSUED FOR PERMIT	2023/08/08
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1	ISSUED FOR PC #14	2023/06/02
No.	Issue	Date

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Drawing Title:
INTERIOR ELEVATIONS AND SECTIONS & SECOND FLOOR UNIVERSAL WR - PLAN


Scale: AS NOTED Date: 19-04-2023

Drawn by: _____ Checked by: _____


Job No. _____ Drawing No. _____

2005 A202


COB - Building Department

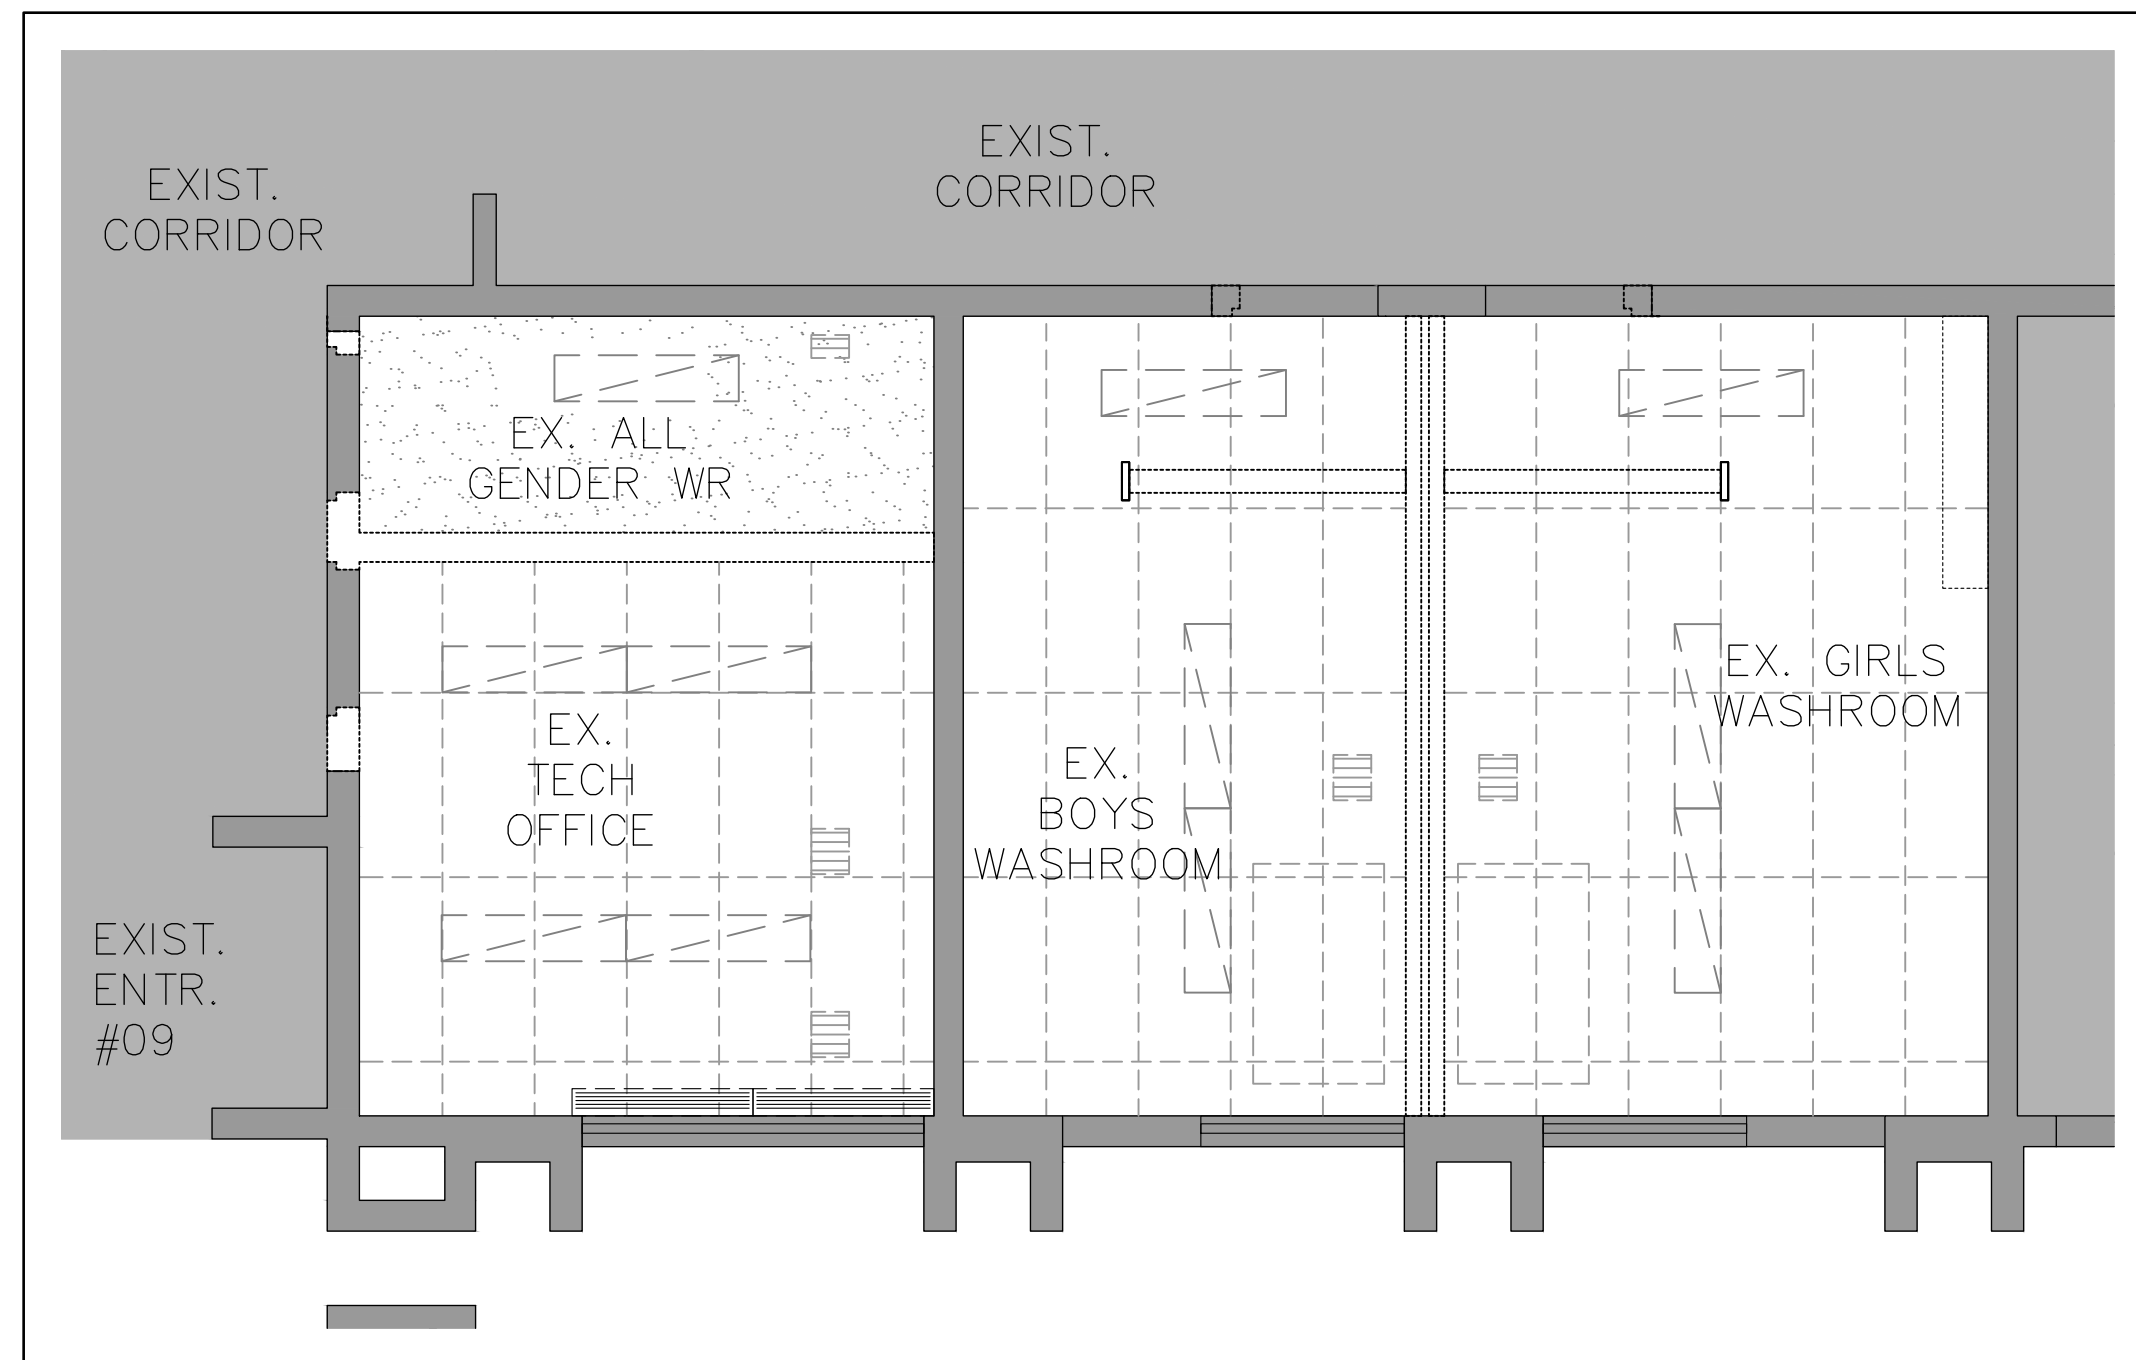


1 FIRST FLOOR LIBRARY WASHROOMS
A300-D 1:50

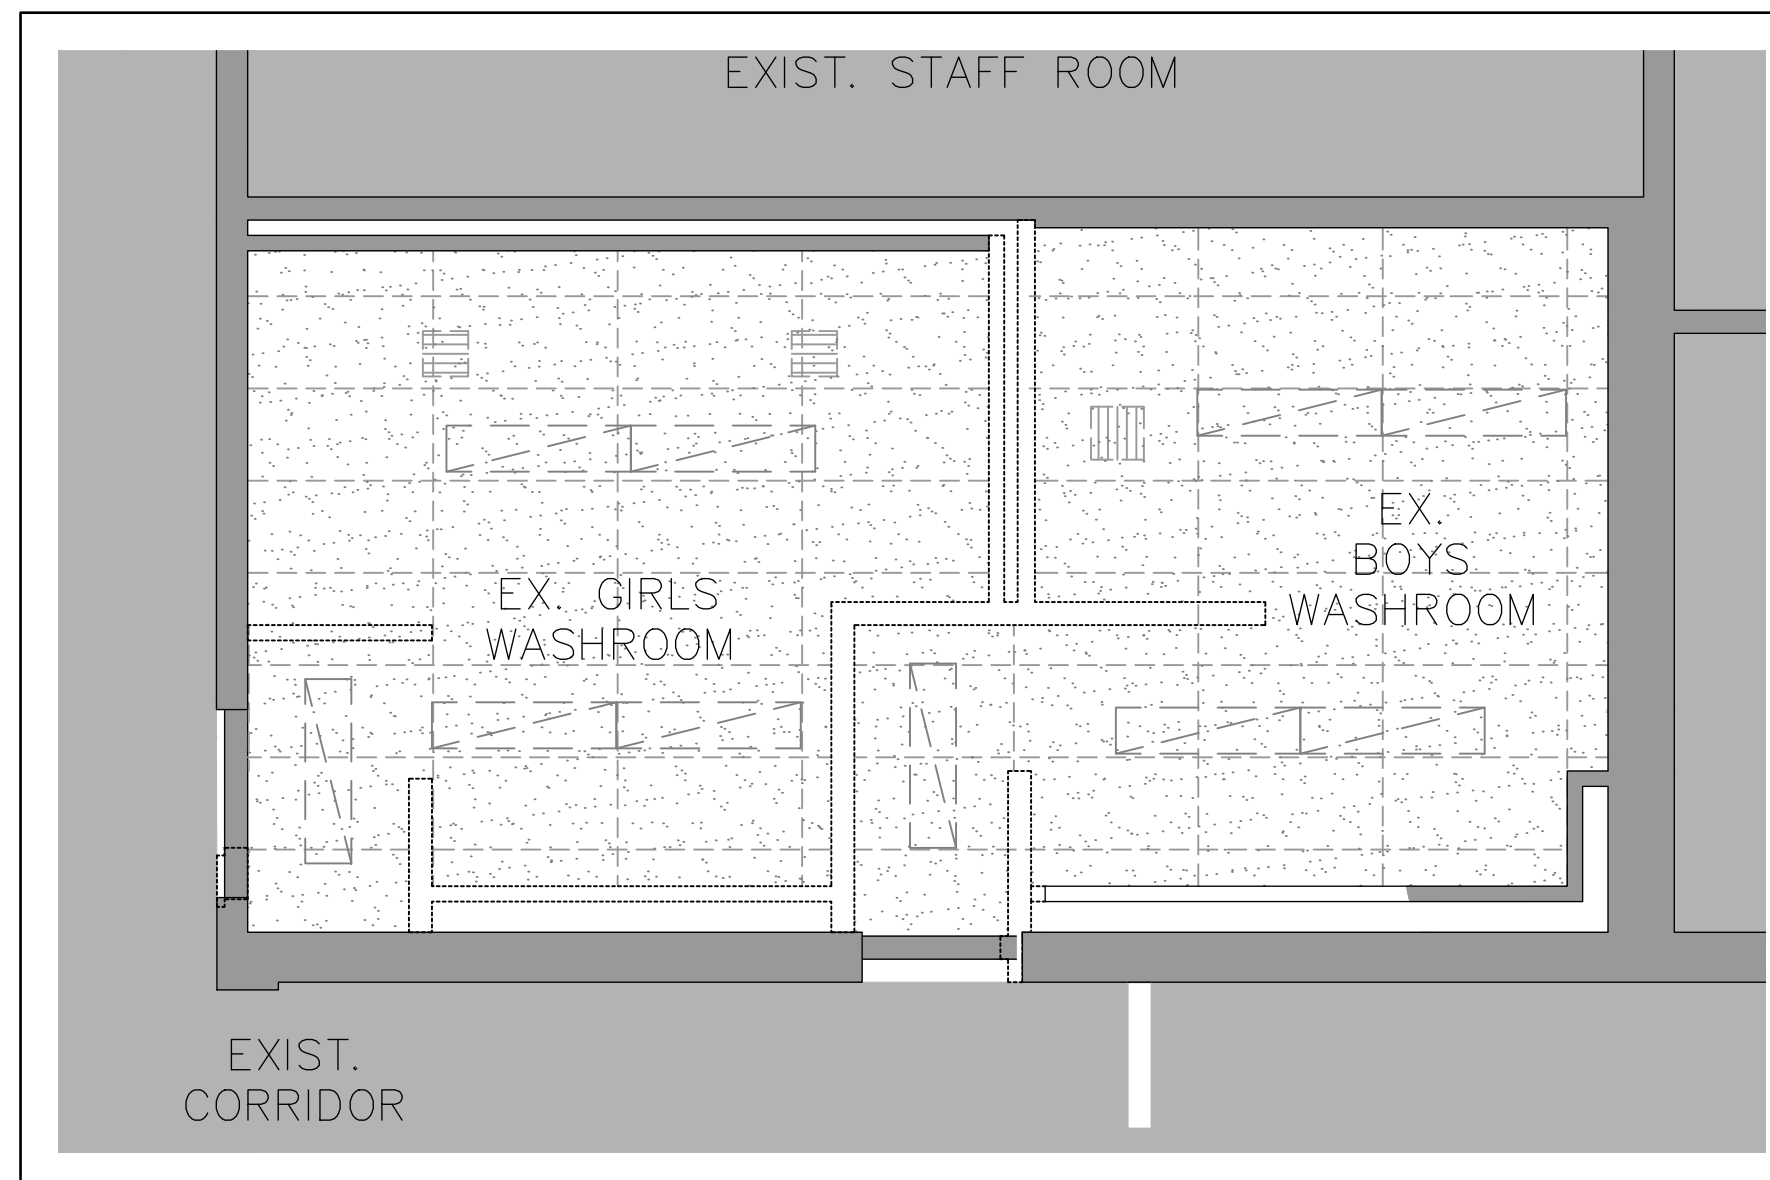

2 FIRST FLOOR GYM WASHROOMS
A300-D 1:50

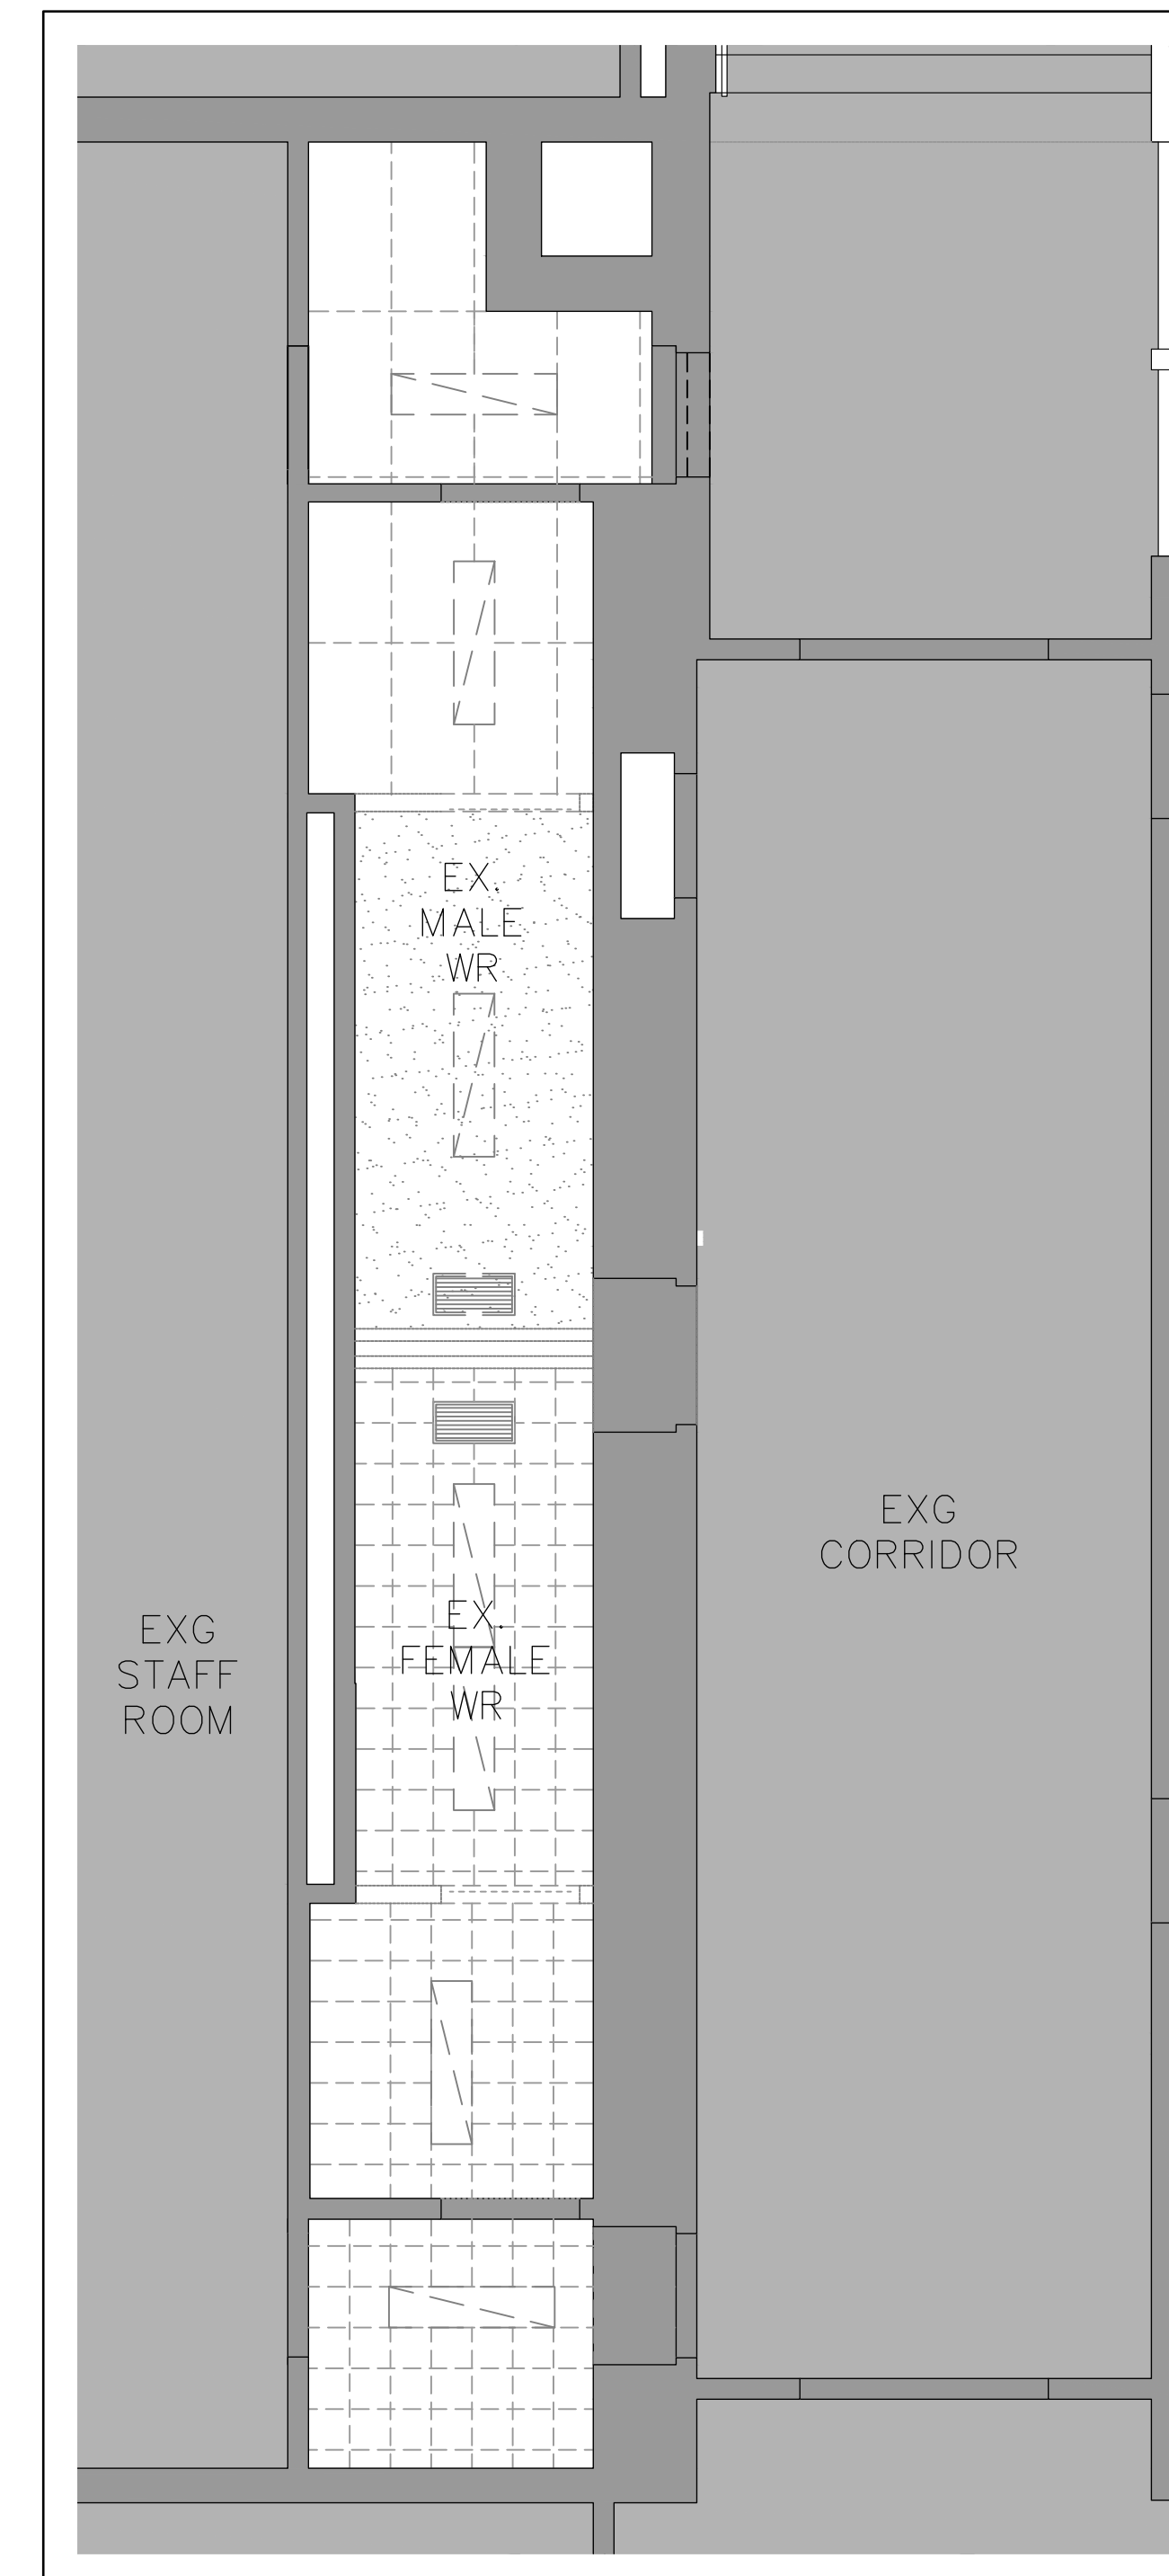

4 THIRD FLOOR WASHROOMS
A300-D 1:50

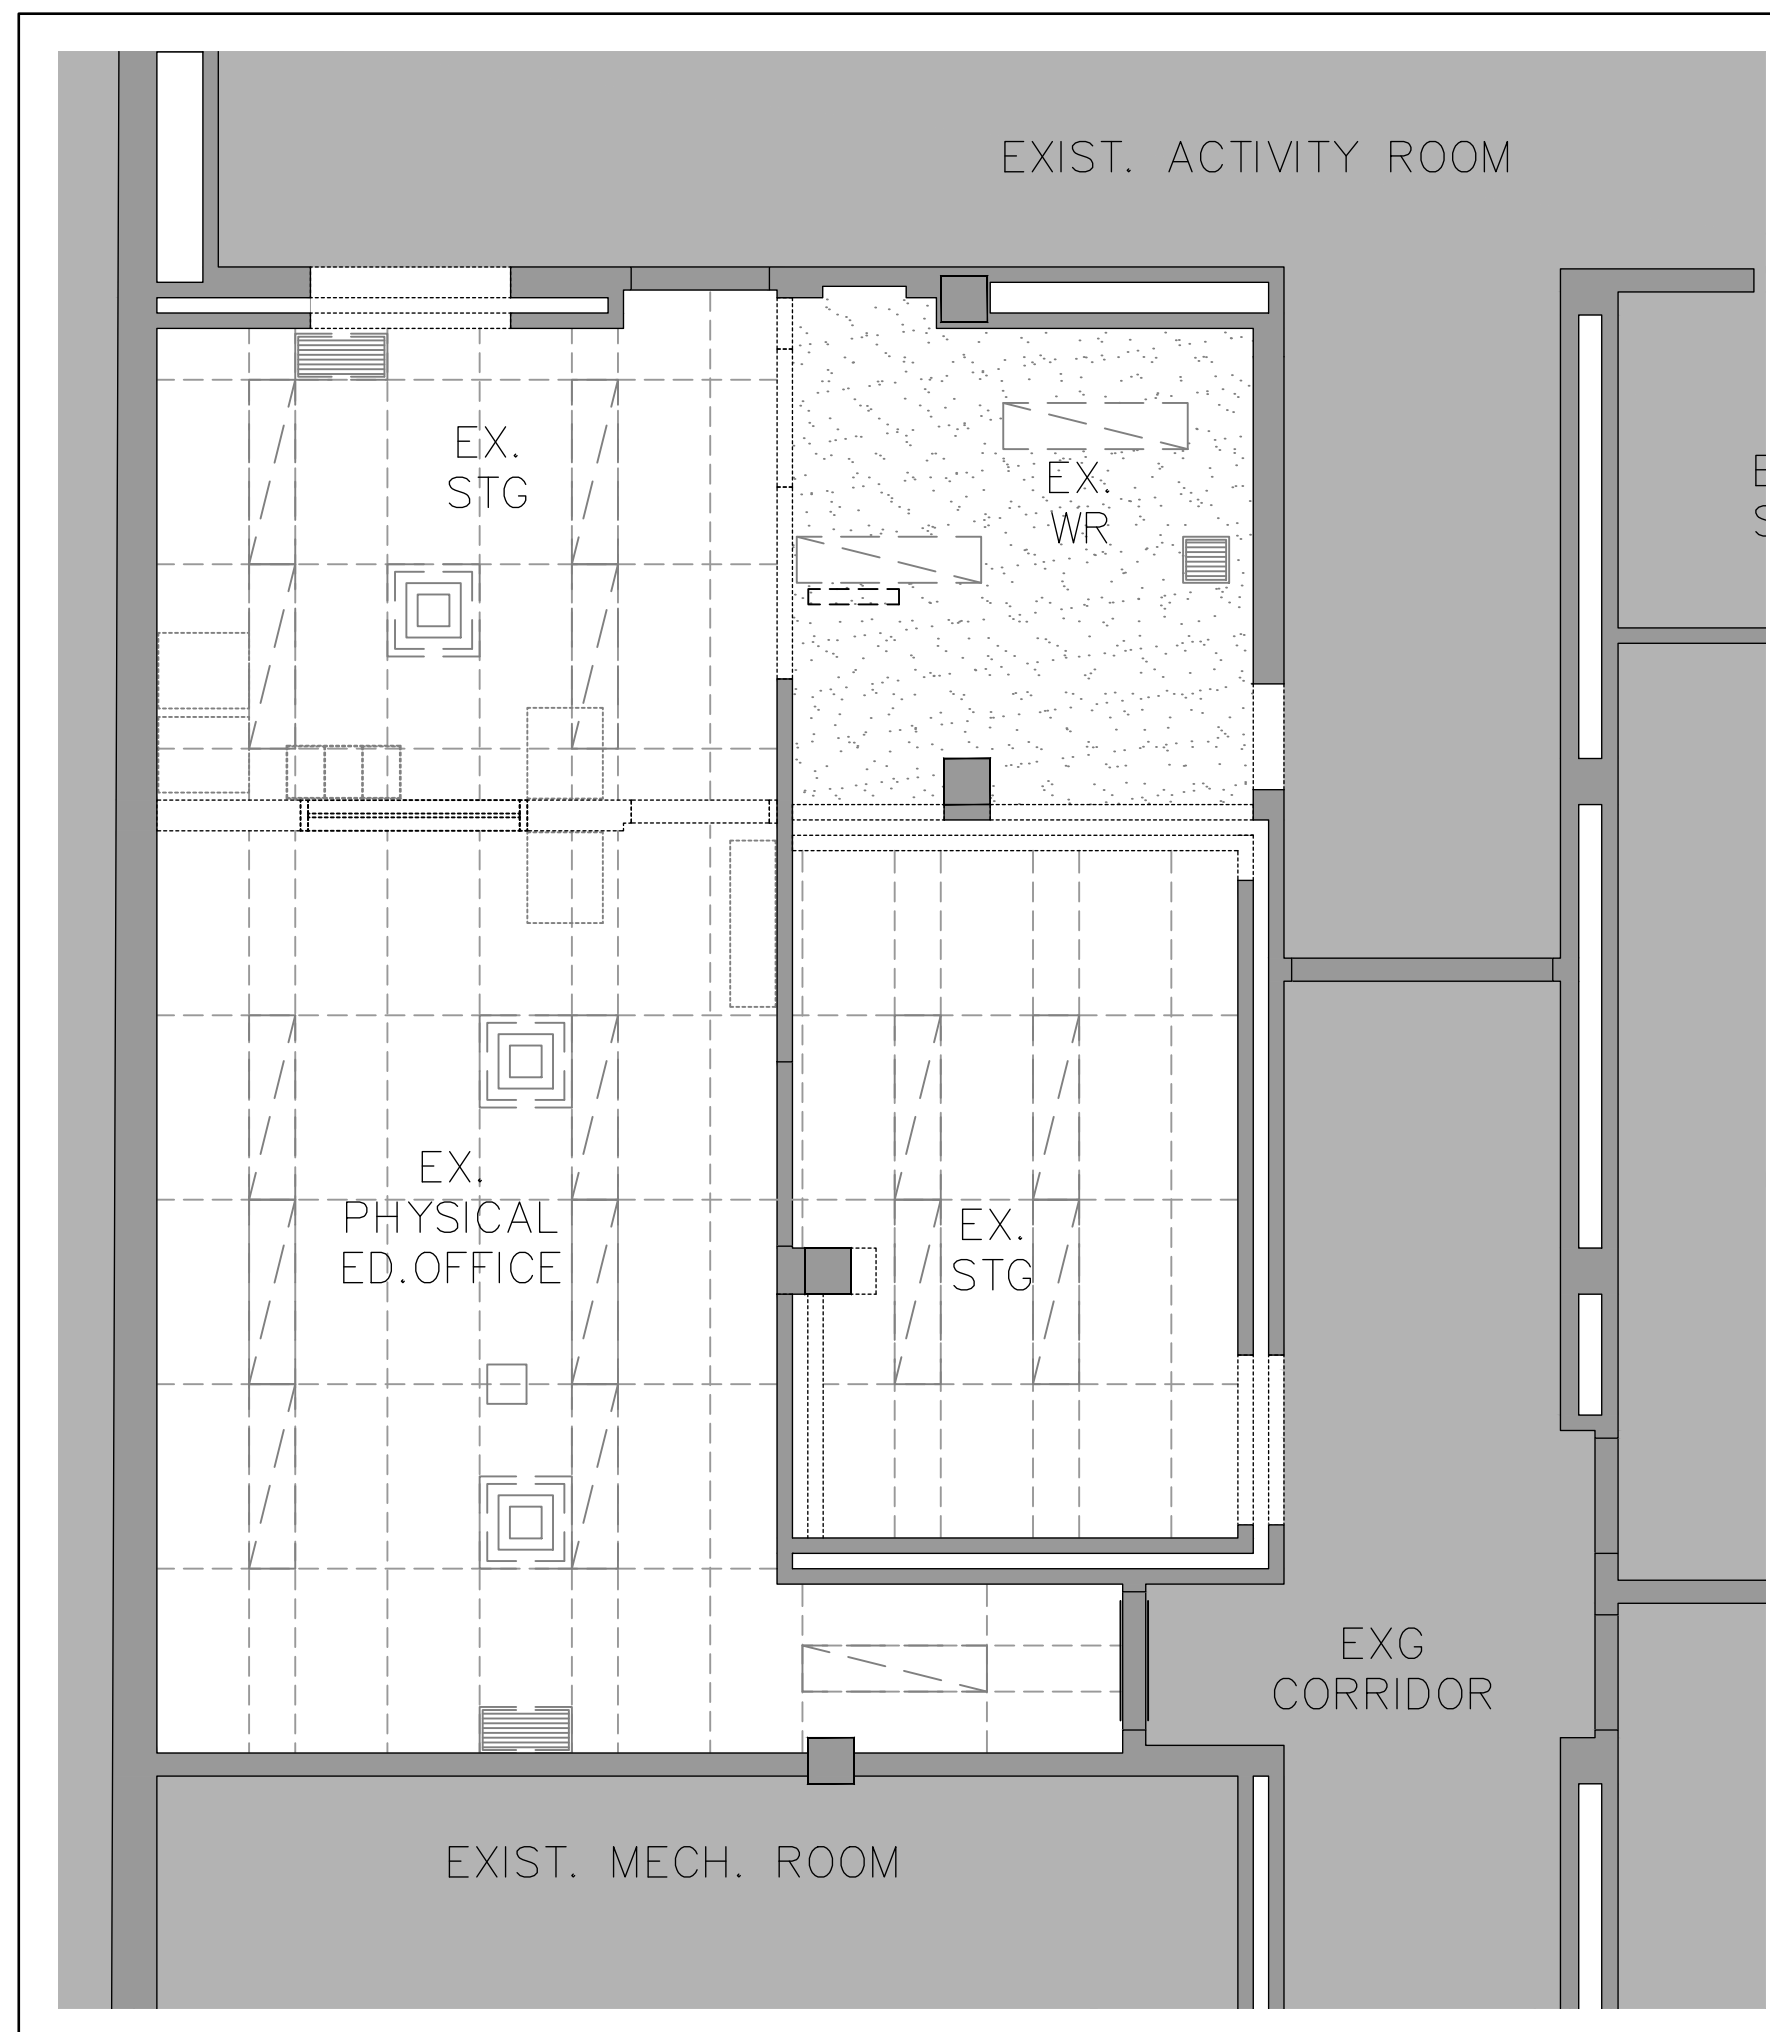

3 SECOND FLOOR WASHROOMS
A300-D 1:50

ALL CONSTRUCTION TO MEET ONTARIO BUILDING CODE REQUIREMENTS

- REFLECTED CEILING PLAN LEGEND:**
- EXIST. T-BAR CEILING WITH ALL ASSOCIATED COMPONENTS TO BE REMOVED (REFER TO MECH. & EL. DWGS)
 - EXIST. TWO CEILING LAYERS TO BE REMOVED: (CEILING TILES & GRID) WITH ALL ASSOCIATED COMPONENTS (REFER TO MECH. & EL. DWGS), AND GLUED ON BOARD CEILING TILES - SECOND CEILING ABOVE
 - EXIST. CEILING - GLUED ON BOARD CEILING TILES TO BE REMOVED WITH ALL ASSOCIATED COMPONENTS - REFER TO MECH. & EL. DWGS
 - EXIST. GYPSUM BOARD CEILING TO BE REMOVED WITH ALL ASSOCIATED COMPONENTS - REFER TO MECH. & EL. DWGS
 - EXIST. AREA TO REMAIN AS IS
 - EXISTING WALLS TO REMAIN
 - EXISTING COMPONENTS TO BE REMOVED / DEMOLISHED
- GENERAL DEMOLITION NOTES:**
- REFER TO SPECS & ABATEMENT REPORT REGARDING DESIGNATED SUBSTANCES REMOVAL.
 - REFER TO MECHANICAL & ELECTRICAL DEMOLITION DRAWINGS FOR MORE INFORMATION.

Client
Halton District School Board
2050 Guelph Line
Burlington, Ontario


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Key Plan N.T.S.

No.	Revisions	Date
2	ISSUED FOR PERMIT	2023/06/14
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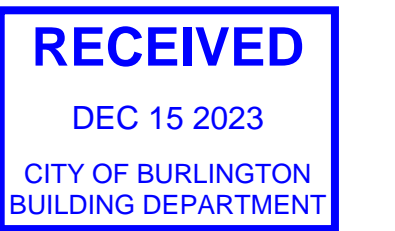
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ALL CONSTRUCTION TO MEET ONTARIO BUILDING CODE REQUIREMENTS

Key Plan N.T.S.



Project North True North

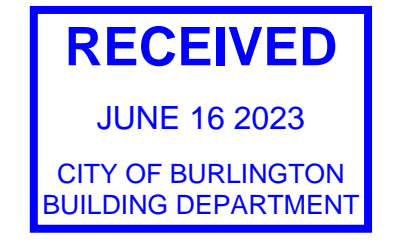No.	Revisions	Date
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No.	Issue	Date
5	RE-ISSUED FOR PERMIT	2023/12/14
4	RE-ISSUED FOR PERMIT	2023/10/31
3	RE-ISSUED FOR PERMIT	2023/08/08
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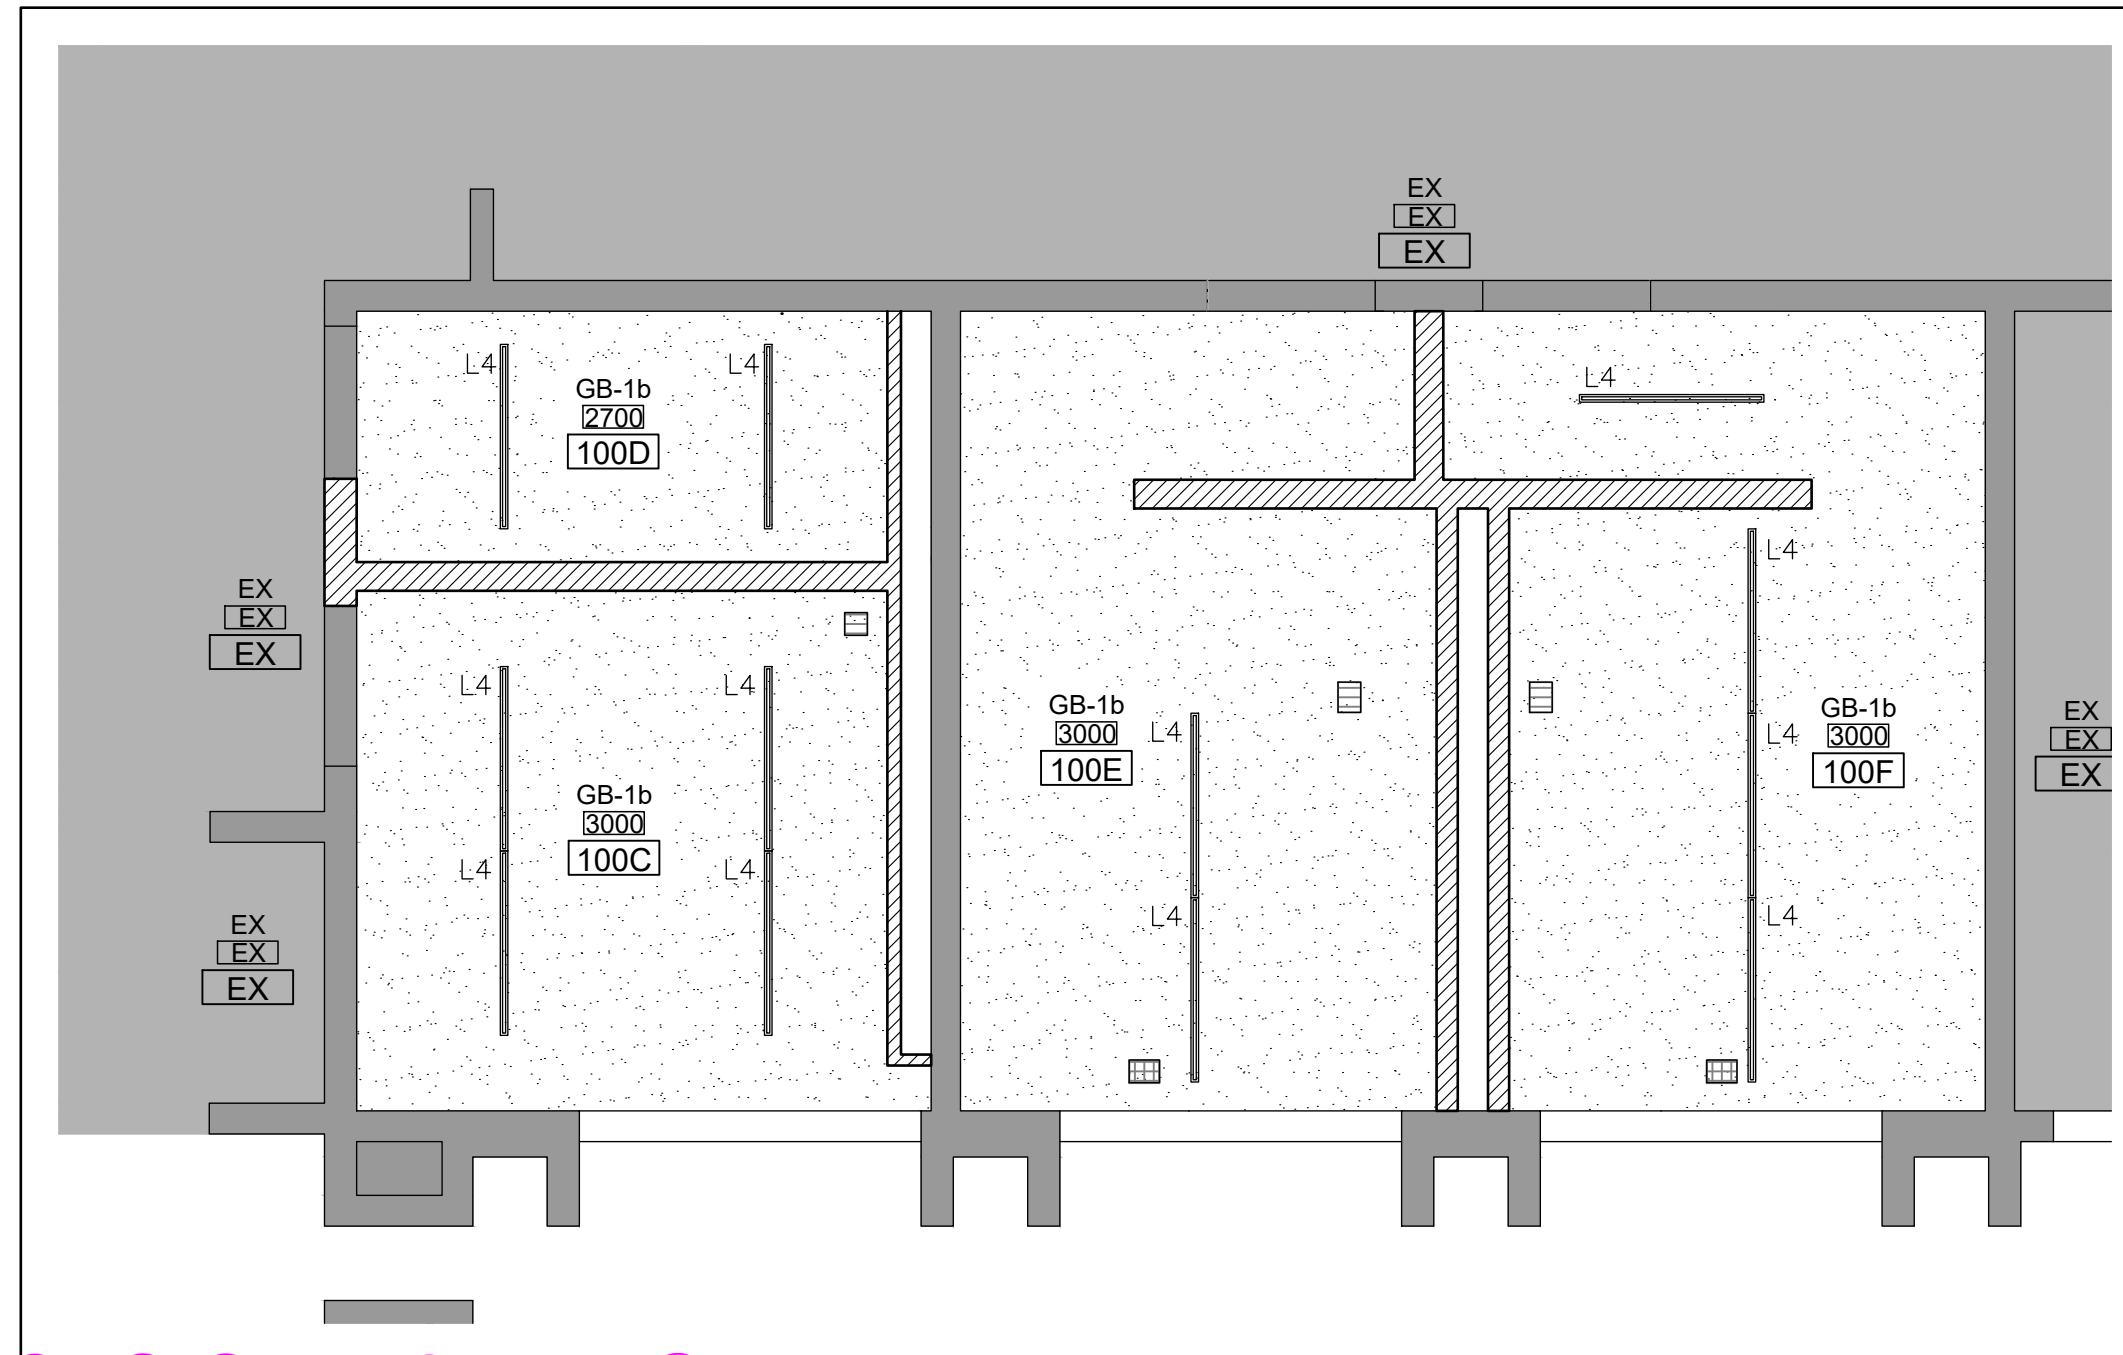
Drawing Title:
**ALL FLOORS - NEW
REFLECTED
CEILING PLANS**

Scale: AS NOTED Date: 19-04-2023


Drawn by: Checked by:

Job No. Drawing No.


2005
A300



1 FIRST FLOOR LIBRARY WASHROOMS
A300 1:50

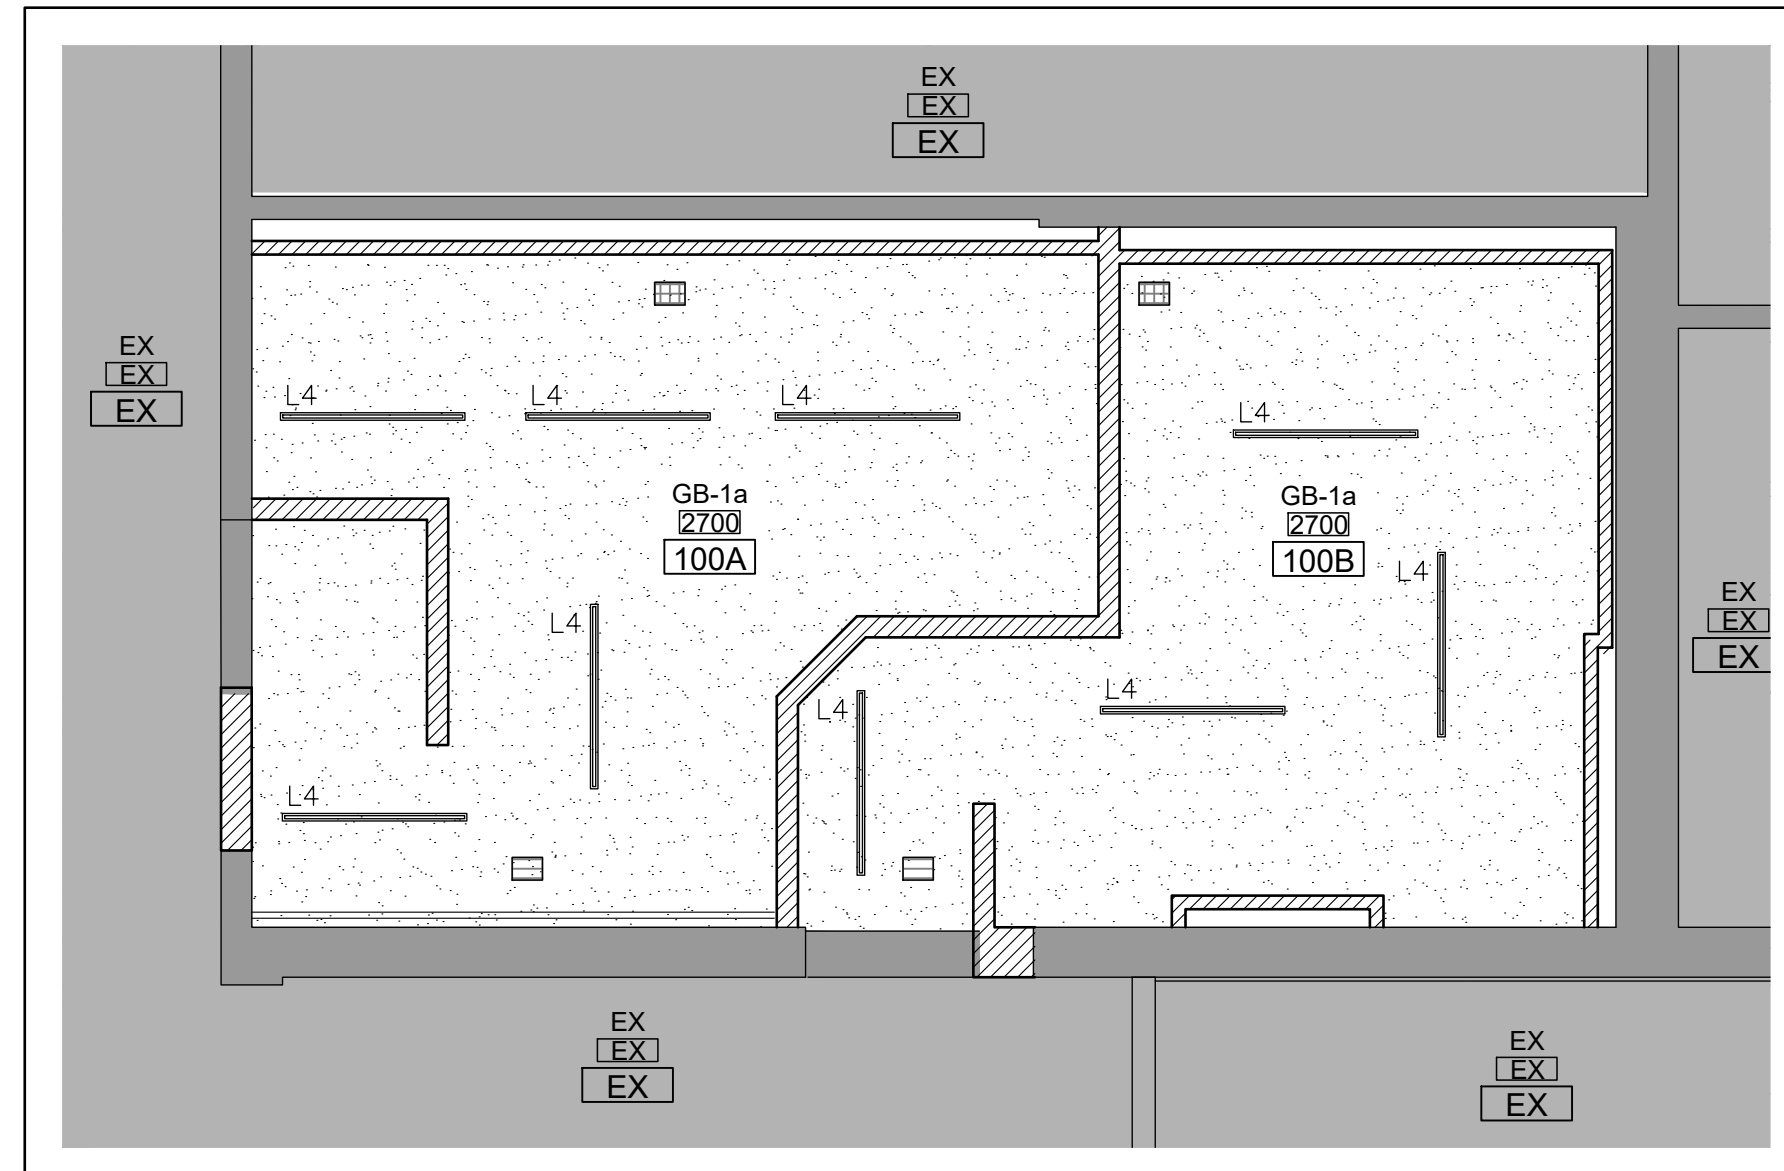

2 FIRST FLOOR GYM WASHROOMS
A300 1:50

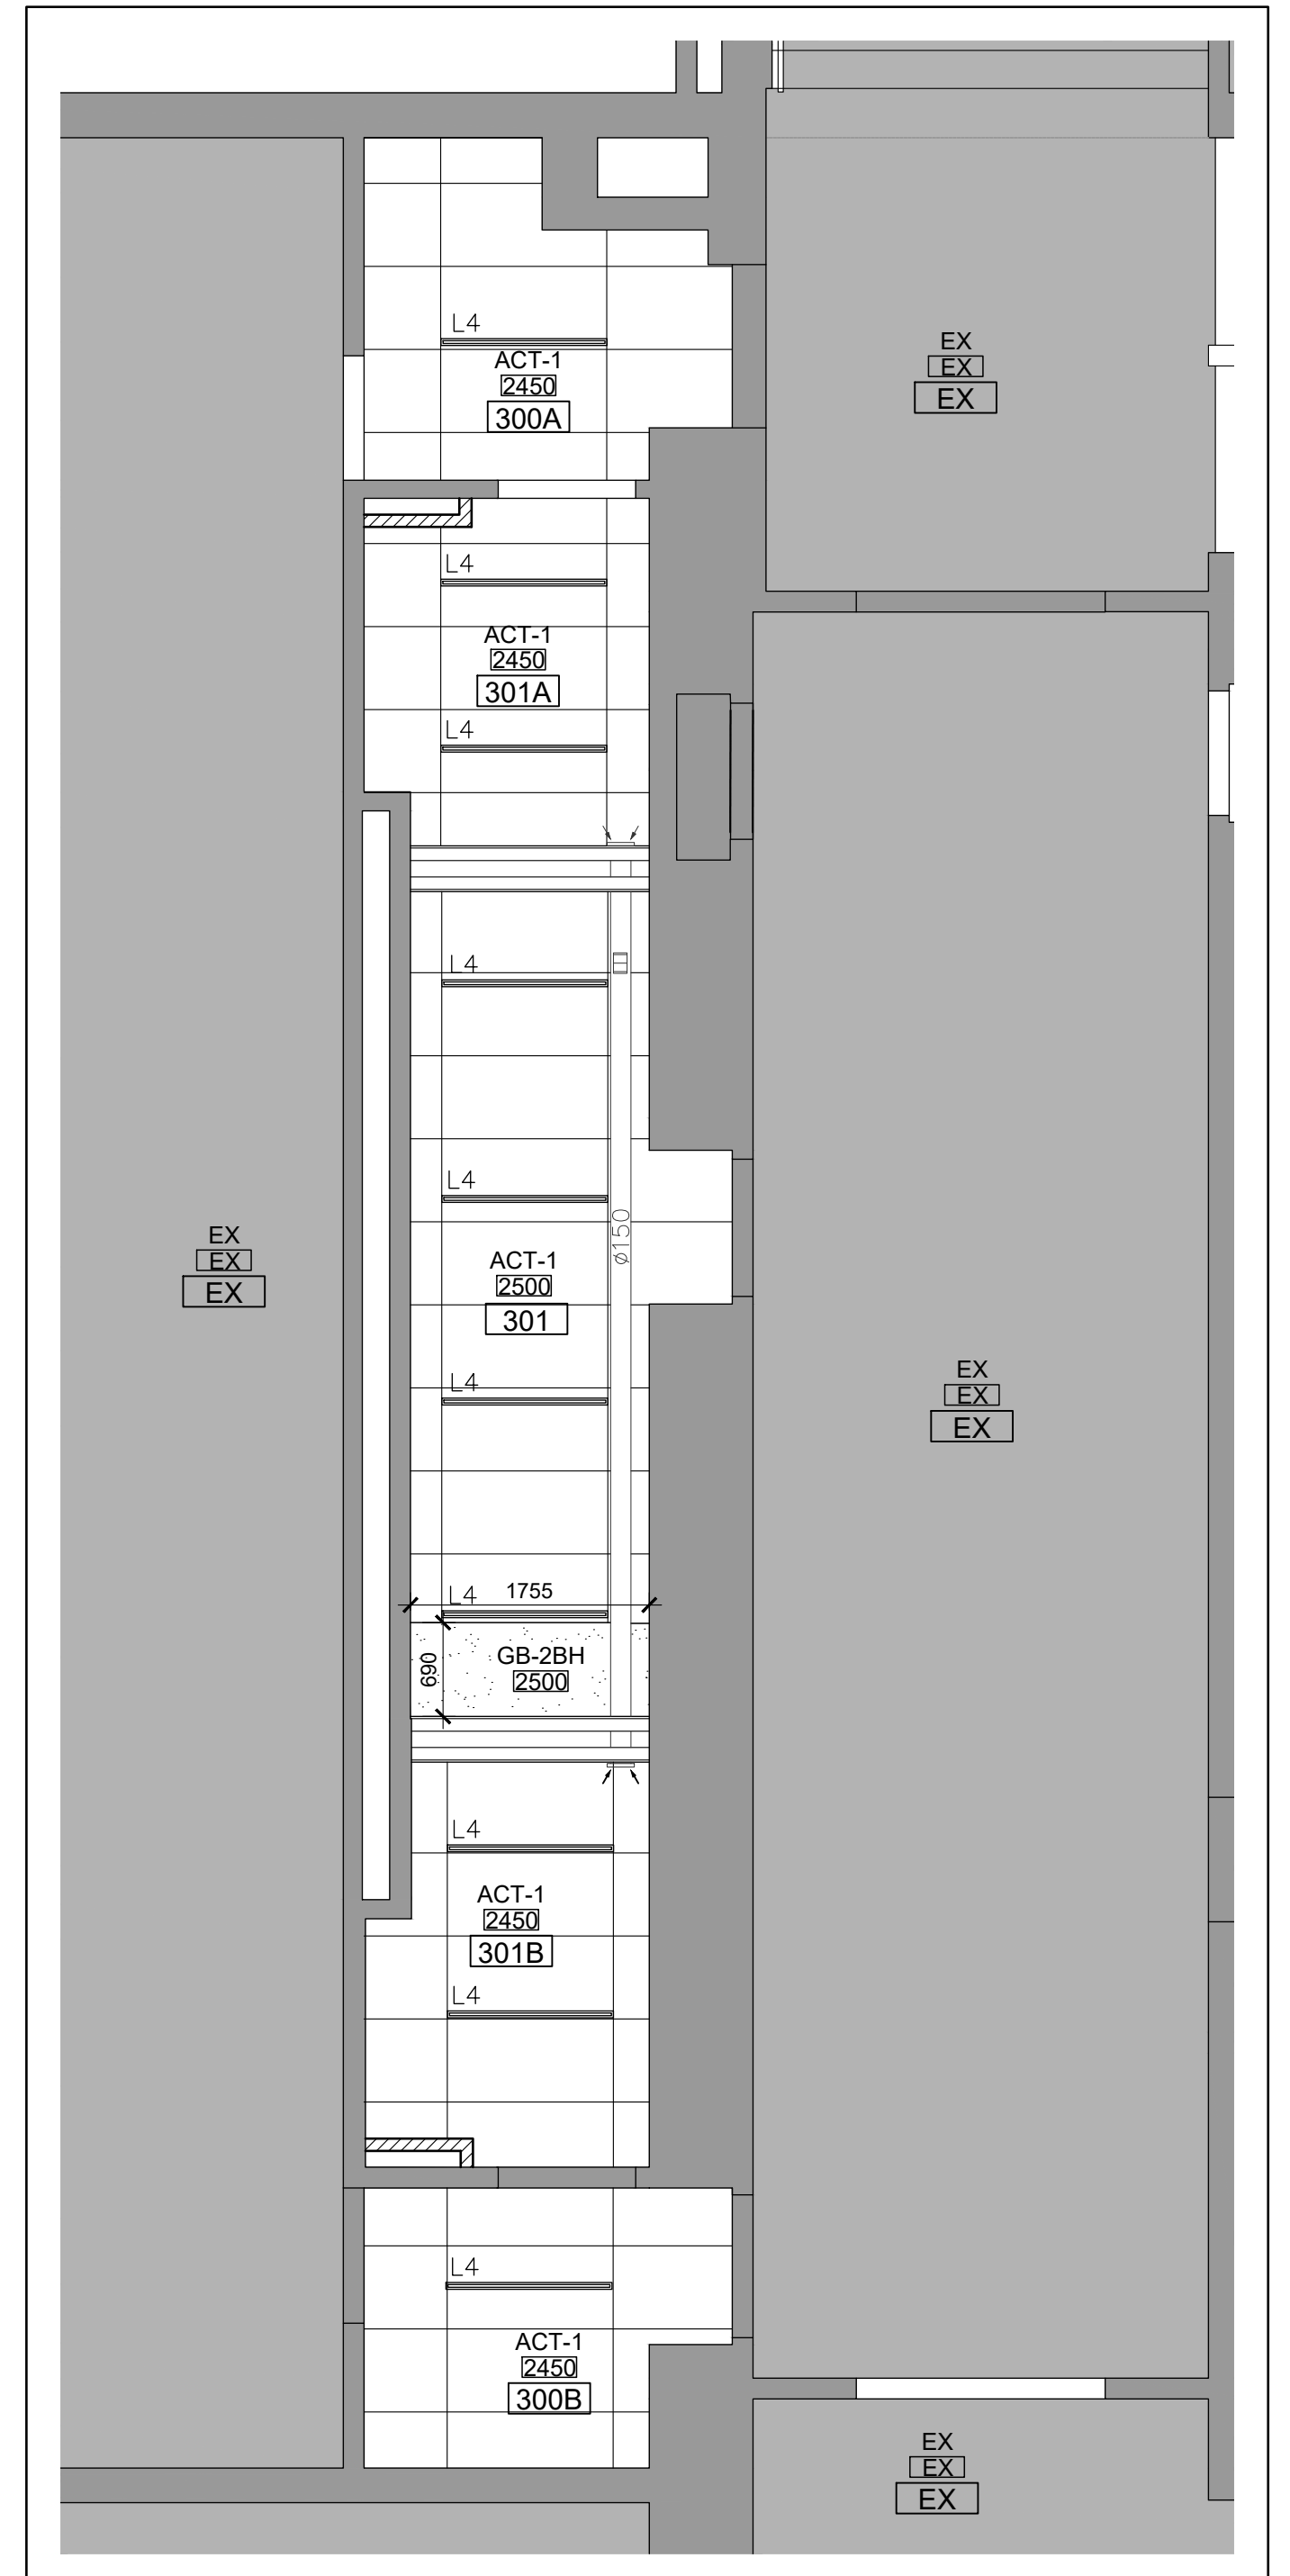

4 THIRD FLOOR WASHROOMS
A300 1:50


ULC listed assemblies shall be constructed in accordance with the OBC and the conditions of the listings. (See attached listings)

FIRE PROOFING NOTES:


- FIRE STOP AT ALL CORRIDOR PENETRATIONS NEW AND EXISTING. MAINTAIN EXISTING FIRE SEPARATIONS. ASSUME EXISTING CORRIDORS ARE 1 HOUR RATED. PROVIDE FLANGES ON DUCT PENETRATIONS AND FIRE DUMPERS AT CORRIDOR WALL FOR NEW DUCTS.
- PROVIDE FIRESTOP & SEAL AT ALL FIRE SEPARATIONS THAT TERMINATE AT EXTERIOR WALLS.
- ENSURE REQUIRED RATING WITH CMU; GROUT SOLID WHERE NECESSARY.
- SEAL TOP OF FIRE SEPARATION WITH FIRE STOPPING, OR ULC RATED ASSEMBLY OF SAME RATING AS THE FIRE SEPARATION.
- SPRAY ALL NEW BEAMS, COLUMNS SUPPORTING FLOOR ASSEMBLY W/ 1 HOUR FRR SPRAY FIREPROOFING EXCEPT WHERE INTUMESCENT PAINT IS SPECIFIED (ALL EXPOSED STRUCTURAL STEEL ELEMENTS).
- PRIME ALL LINTELS.
- PROVIDE FIRE PROOFING PRODUCTS AS LISTED IN THE ULC/ cUL NOTED, OR APPROVED EQUIVALENT.

GENERAL FLOOR FINISH NOTES:

- TRANSITION STRIP IN EVERY CHANGE OF MATERIAL.
- ALL TRANSITIONS BETWEEN DIFFERING MATERIALS TO BE FLUSH.
- ALL FLOOR FINISH TRANSITIONS TO MEET UNDER DOOR (WHERE DOOR OCCURS).
- ALL TERRAZZO IN-FILLS TO EXTEND TO NEXT METAL STRIP.
- CONTROL JOINT IN TILING SYSTEM EVERY 10 METERS.
- ALL EXISTING BASE TO BE REMOVED PRIOR TO NEW BASE INSTALLATION.
- REFER TO DRAWING A800 FOR ROOM FINISH SCHEDULE.

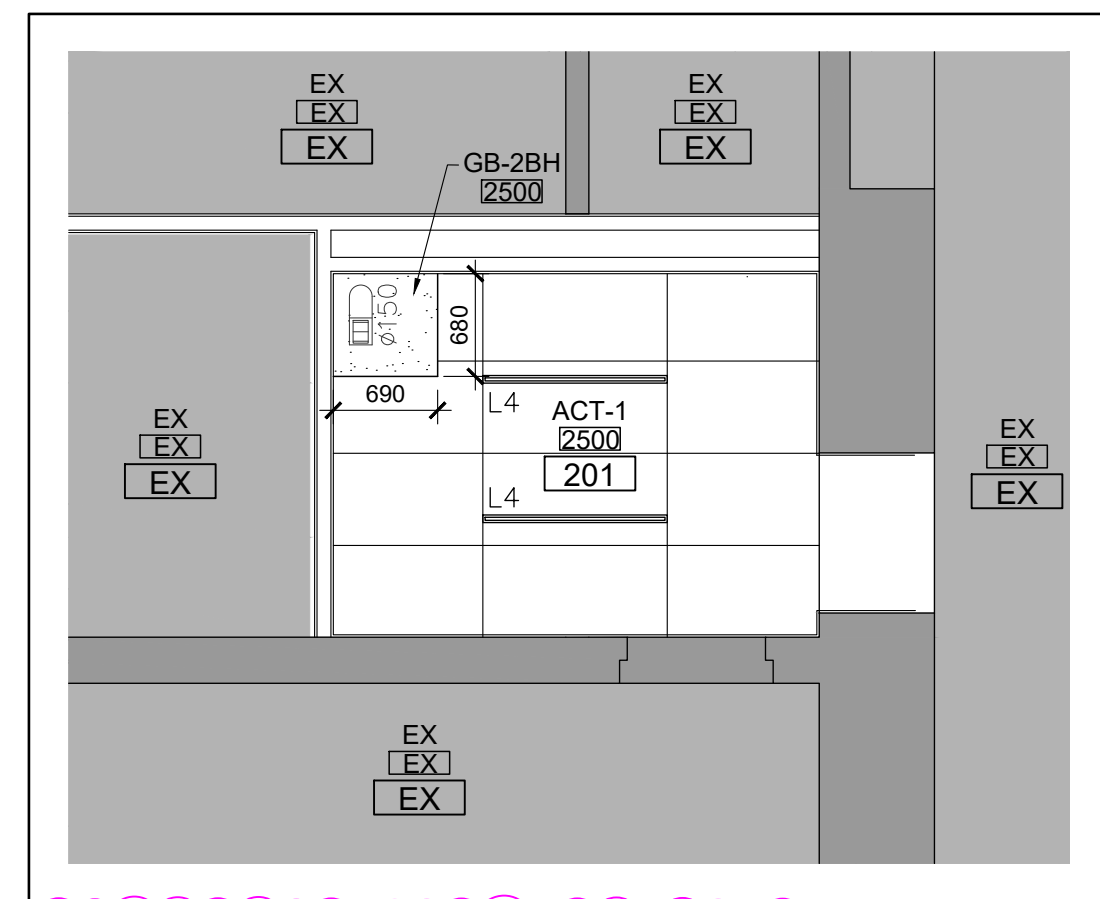

5 SECOND FLOOR - UNIVERSAL WASHROOM
A300 1:50

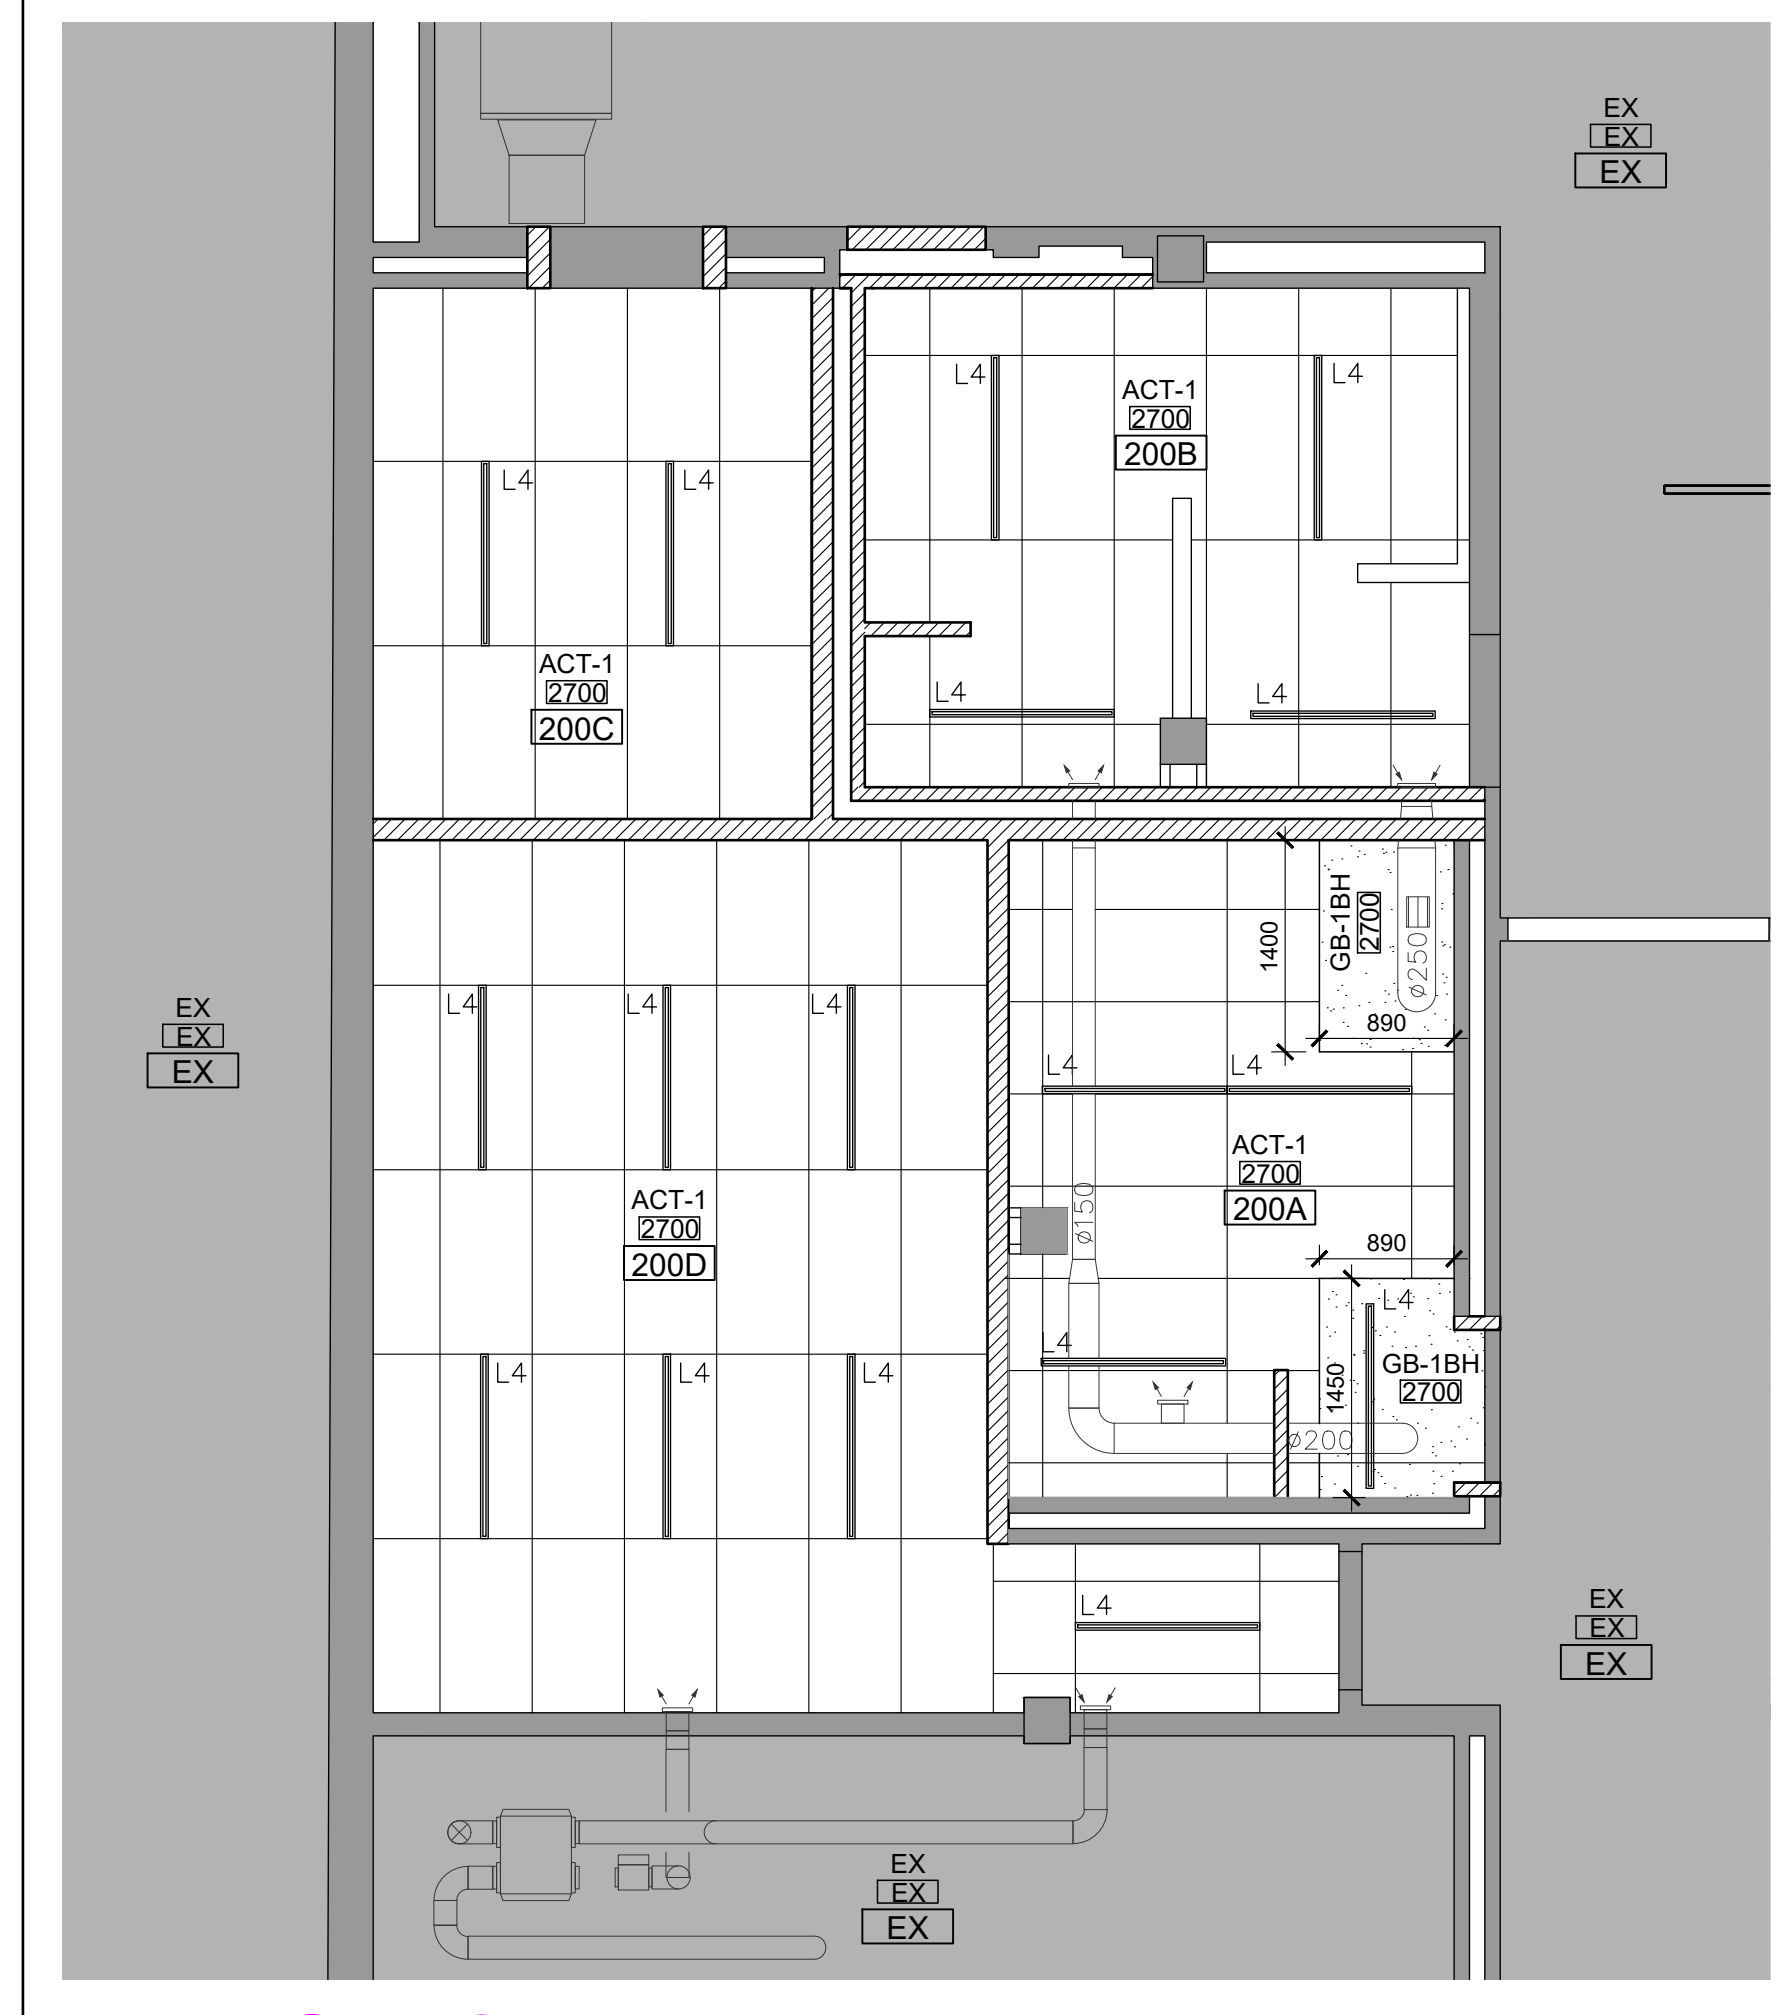

3 SECOND FLOOR WASHROOMS
A300 1:50

GENERAL NOTES:

- IN AREAS WITH EXPOSED STRUCTURE, DUCTS / PIPES AND CONDUITS SHALL BE MOUNTED TIGHT TO US OF SLAB OR DECK, ROUTED PARALLEL AND PERPENDICULAR TO WALLS.
- PAINT ALL GYPSUM BOARD SURFACES.
- PAINT ALL EXPOSED STRUCTURE, DUCTS, PIPES & CONDUITS, UNO.
- PROVIDE GYPSUM BOARD BULKHEAD AT CEILING HEIGHT CHANGES, COMPLETE WITH SHADOW MOLDING TYP. UNO.
- FOR CEILING @ WINDOW MULLION, PROVIDE METAL REVEAL TYP.
- FOR LOCATIONS OF DIFFUSERS, AIR GRILLES, SPRINKLER HEADS, SPEAKERS & EXIT LIGHTS, REFER TO MECHANICAL & ELEC. DWGS
- ALLOW 50 ADDITIONAL ACOUSTIC CEILING TILES FOR REPLACEMENT OF EXISTING DAMAGE TILES.

REFLECTED CEILING PLAN LEGEND:

- EXIST. AREA TO REMAIN AS IS
- ACT-1 NEW ACOUSTIC CEILING TILES CEILING SIMILAR COMPLIANCE TO ULC DESIGN NO. L201 (1HR FIRE RATING) IN CONJUNCTION WITH EXISTING DECK AND JOISTS CONDITIONS CW COMPLIANT GRIDS
- GB-1a - 12.7mm GYPSUM BOARD CEILING FINISH ON 92mm MTL STUDS FRAME OVER - 1HR RATED ASSEMBLY ULC DESIGN No. F816
- GB-1b - 12.7mm GYPSUM BOARD CEILING FINISH ON 92mm MTL STUDS FRAME OVER - 1HR RATED ASSEMBLY cUL DESIGN No. P819
- GB-2BH 1HR FIRE RATED BULKHEAD: HORIZONTAL MEMBRANE: CBMEC #89-1-118; 3X13mm GB-FR C-H METAL STUDS; W/25mm GB-SL; VERTICAL MEMBRANE: 15.9mm GB-FR ON BOTH SIDES OF 92mm MTL STUDS - ULC Design W453
- EXISTING WALLS TO REMAIN
- NEW WALLS & PARTITIONS
- L4 NEW SURFACE MOUNTED/HANGING LIGHT FIXTURE - REFER TO ELECTRICAL DWGS
- NEW AND EXIST. MECH. DIFFUSERS, GRILLS & FANS - REFER TO MECH. DWGS

ROOM FINISH SCHEDULE


ROOM #	ROOM NAME	FINISHES					COMMENTS
		FLOOR FINISH	BASE FINISH	WALL FINISH	CEILING FINISH		
GROUND FLOOR							
100A	GIRLS WASHROOM	PFT	PFT	EX/CB - P; CWT	GB - P		
100B	BOYS WASHROOM	PFT	PFT	EX/CB - P; CWT	GB - P		
100C	UNIVERSAL WASHROOM	PFT	PFT	EX/CB - P; CWT	GB - P		
100D	STAFF WASHROOM	PFT	PFT	EX/CB - P; CWT	GB - P		
100E	BOYS WASHROOM	PFT	PFT	EX/CB - P; CWT	GB - P		
100F	GIRLS WASHROOM	PFT	PFT	EX/CB - P; CWT	GB - P		
SECOND FLOOR							
200A	FEMALE STAFF WASHROOM	PFT	PFT	EX/CB - P; CWT	GB - P		
200B	MALE STAFF WASHROOM	PFT	PFT	EX/CB - P; CWT	GB - P		
200C	STORAGE ROOM	LVT	RB	EX/CB - P	ACT		
200D	SEMINAR ROOM	LVT	RB	EX/CB - P	ACT		
201	UNIVERSAL WASHROOM	PFT	PFT	EX/CB - P; CWT	GB - P		
THIRD FLOOR							
300A	EXISTING FOYER	EX	RB	GB - P	ACT		
300B	EXISTING FOYER	EX	RB	GB - P	ACT		
301	UNIVERSAL WASHROOM	PFT	PFT	EX/CB/GB - P; CWT	ACT		
301A	STAFF WASHROOM	PFT	PFT		EX/P		
301B	STAFF WASHROOM	PFT	PFT		EX		

ROOM FINISH SCHEDULE LEGEND:

EXP	EXPOSED CEILING	CWT	CERAMIC WALL TILES
EX	EXISTING FINISH	PCT	PORCELAIN CERAMIC TILES
GB	GYPSUM BOARD	LVT	LUXURY VINYL TILE
CB	CONCRETE BLOCK	RB	RESILIENT BASE
P	PAINT	ACT	ACOUSTIC CEILING TILE

ROOM FINISH SCHEDULE NOTES:

- PROVIDE STAINLESS STEEL TRANSITION STRIP FOR ALL DOOR THRESHOLDS WHERE FLOOR FINISH CHANGES.
- AT TRANSITIONS WHEN ADJACENT FLOOR FINISHES ARE OF DIFFERENT THICKNESS, SLOPE THE FLOOR SO AS TO SET A SEAMLESS FLUSH TRANSITION.
- ALL NEW WALLS AND GB CEILINGS TO BE PAINTED.
- FOR INTERIOR ELEVATIONS AND MORE INFORMATION REFER TO DRAWING A201.

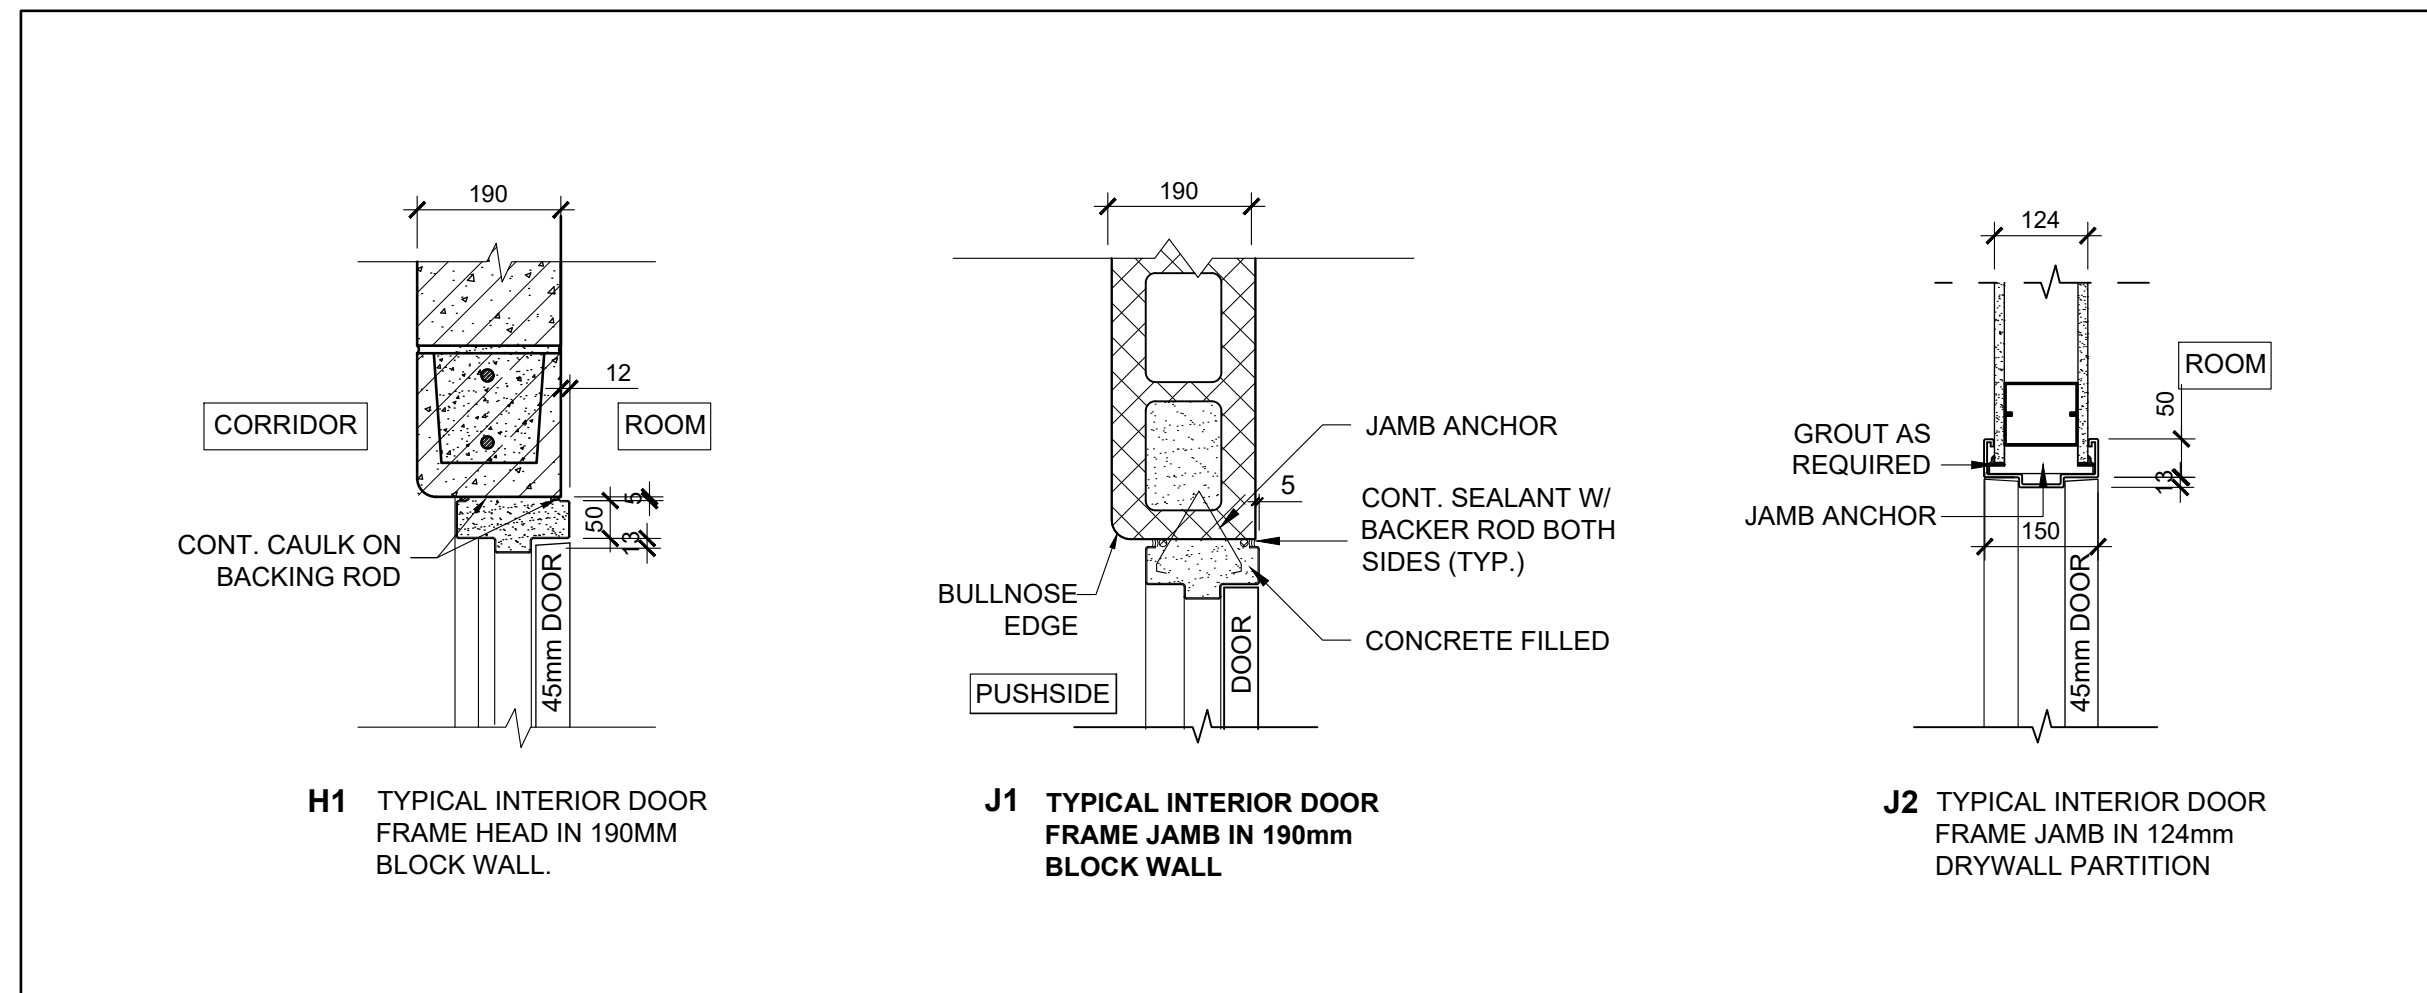

3 HEAD AND JAMB DETAILS
A400 1:10

DOOR SCHEDULE (NEW & EXISTING DOORS)

MARK	ROOM NAME	INTERIOR DOOR						INTERIOR FRAME / SCREEN						COMMENTS		
		FIRE RATING	DOOR TYPE	LEAF WIDTH	LEAF HEIGHT	NO. OF LEAFS	THICKNESS	MATERIAL	FINISH	GLAZING	SCREEN / FRAME TYPE	GLAZING	MATERIAL		FINISH	MULLION
100A	GIRLS WASHROOM	45 min. FRR	A	1000	2150	1	45	HM	P	-	F1	-	HM	P	-	PDO
100B	BOYS WASHROOM	45 min. FRR	A	1000	2150	1	45	HM	P	-	F1	-	HM	P	-	PDO
100C	UNIVERSAL WASHROOM	45 min. FRR	A	950	2150	1	45	HM	P	-	F1	-	HM	P	-	PDO
100D	STAFF WASHROOM	45 min. FRR	A	950	2150	1	45	HM	P	-	F1	-	HM	P	-	PDO
100E	GIRLS WASHROOM	45 min. FRR	A	1000	2150	1	45	HM	P	-	F1	-	HM	P	-	PDO
100F	GIRLS WASHROOM	45 min. FRR	A	1000	2150	1	45	HM	P	-	F1	-	HM	P	-	PDO
EX-200	EXISTING ACTIVITY ROOM	EX	EX	EX	EX	EX	EX	EX	P	-	EX	-	EX	P	-	
200A	FEMALE STAFF WASHROOM	45 min. FRR	A	900	2150	1	45	HM	P	-	F1	-	HM	P	-	PDO
200B	MALE STAFF WASHROOM	-	A	900	2150	1	45	HM	P	-	F1	-	HM	P	-	PDO
200C	STORAGE ROOM	-	A	900	2150	1	45	WD	P	-	F1	-	HM	P	-	PDO
EX-200D	SEMINAR ROOM	EX	EX	EX	EX	EX	EX	EX	P	-	EX	-	EX	P	-	
201	UNIVERSAL WASHROOM	45 min. FRR	A	950	2150	1	45	HM	P	-	F1	-	HM	P	-	PDO
EX-300A	EXISTING STAFF ROOM	EX	EX	EX	EX	EX	EX	EX	P	-	EX	-	EX	P	-	
EX-300B	EXISTING FOYER	EX	EX	EX	EX	EX	EX	EX	P	-	EX	-	EX	P	-	
EX-300C	EXISTING STAFF ROOM	EX	EX	EX	EX	EX	EX	EX	P	-	EX	-	HM	P	-	
EX-300D	EXISTING FOYER	EX	EX	EX	EX	EX	EX	EX	P	-	EX	-	HM	P	-	
301	UNIVERSAL WASHROOM	45 min. FRR	A	950	2150	1	45	HM	P	-	F1	-	HM	P	-	PDO
301A	STAFF WASHROOM 1	-	A	900	2150	1	45	WD	P	-	F1	-	HM	P	-	PDO
301B	STAFF WASHROOM 2	-	A	900	2150	1	45	WD	P	-	F1	-	HM	P	-	PDO

DOOR & FRAME SCHEDULE SCHEDULE LEGEND:

HM	HOLLOW METAL	GL-3	TEMPERED SAFETY GLASS	SIG	SEALED INSULATING GLASS UNITS
AL	ALUMINUM	GL-4	TEMPERED FIRE-RATED GLASS	P	PAINT
WD	WOOD	GL-5	FIRE-RATED LAMINATED GLASS	PF	PRE FINISHED
FRR	FIRE RESISTANT RATING	PDO	POWER DOOR OPERATOR	EX	EXISTING

DOOR & FRAME SCHEDULE NOTES:


- ALL DOORS AND FRAMES MUST HAVE APPROPRIATE REINFORCING.
- ALL FRAMES TO BE CONCRETE FILLED.
- FOR HARDWARE, REFER TO HARDWARE SCHEDULE.
- ALL FRAME IN FIRE SEPARATION AREAS TO BE FIRE RATED.

All doors requiring a fire resistance rating shall be labelled, be installed in labelled frames, and be equipped with listed hardware complying to NFPA80 and 3.1.8.4. OBC.


A DOOR IN AN ACCESS TO EXIT SHALL BE READILY OPENABLE IN TRAVELLING TO AN EXIT WITHOUT REQUIRING KEYS, SPECIAL DEVICES OR SPECIALIZED KNOWLEDGE OF THE DOOR OPENING MECHANISM. DOOR RELEASE HARDWARE SHALL BE OPERABLE BY ONE HAND AND NOT MORE THAN ONE RELEASING OPERATION AS PER DIV. B, 3.3.1.12.(2) & (3) OBC 2012

3.8.3.3.(10) – Barrier Free Doorways
Barrier free doorways, unless equipped with a power door operator, shall have a clear space beyond a latch side of not less than:
•600 mm where the door swings towards the approach side,
•300 mm where the door swings away from the approach side, and
•300 mm beyond both sides of a sliding door.

3.8.3.3.(17). – Power Door Operators
Where a power door operator is provided, it shall be installed on the latch side. The control for a power door operator shall:
•Have a face dimension of not less than 150 mm in diameter where the control is circular or 50 mm by 100 mm where the control is rectangular,
•Be operable using a closed fist,
•Be located between 900 mm and 1100 mm above the floor,
•Be located not less than 600 mm and not more than 1500 mm beyond the door swing where the door opens towards the control,
•Be located in a clearly visible position, and
•Contain a sign incorporating the International Symbol of Access.

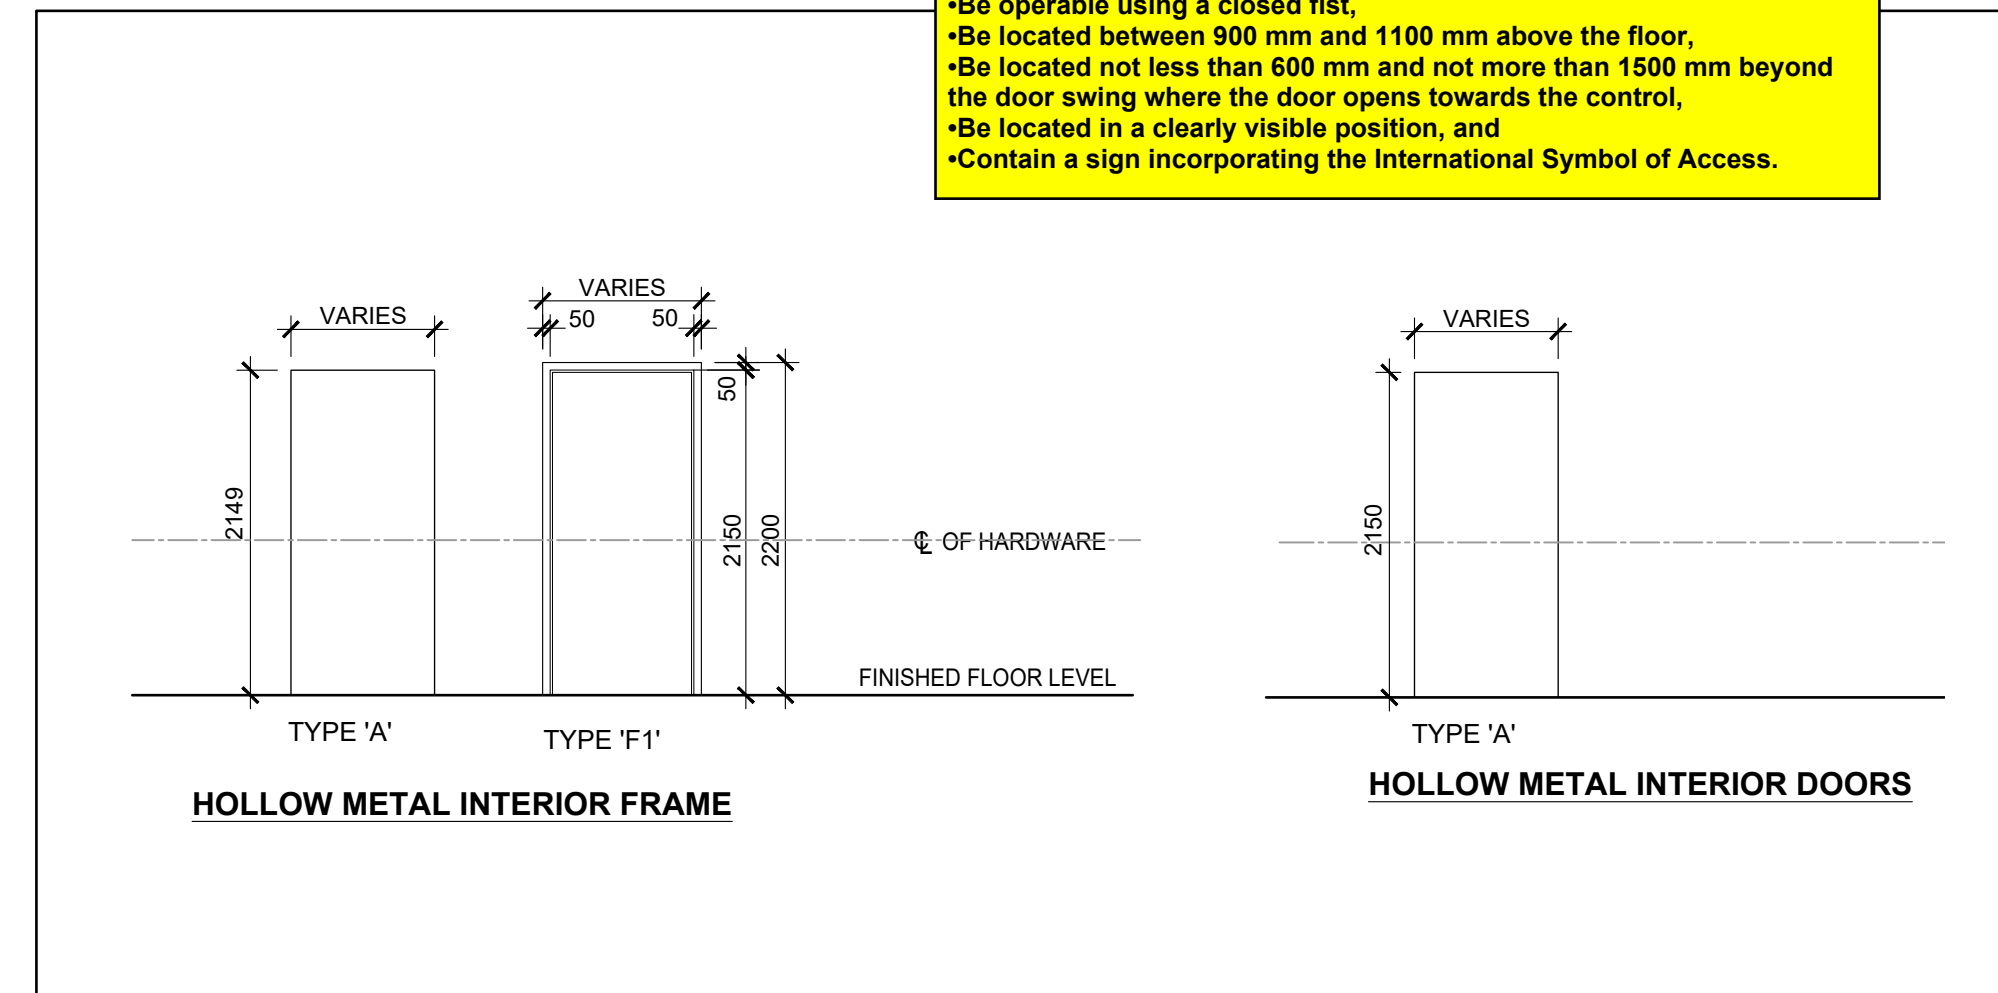

1 DOOR & FRAME TYPES
A400 1:50

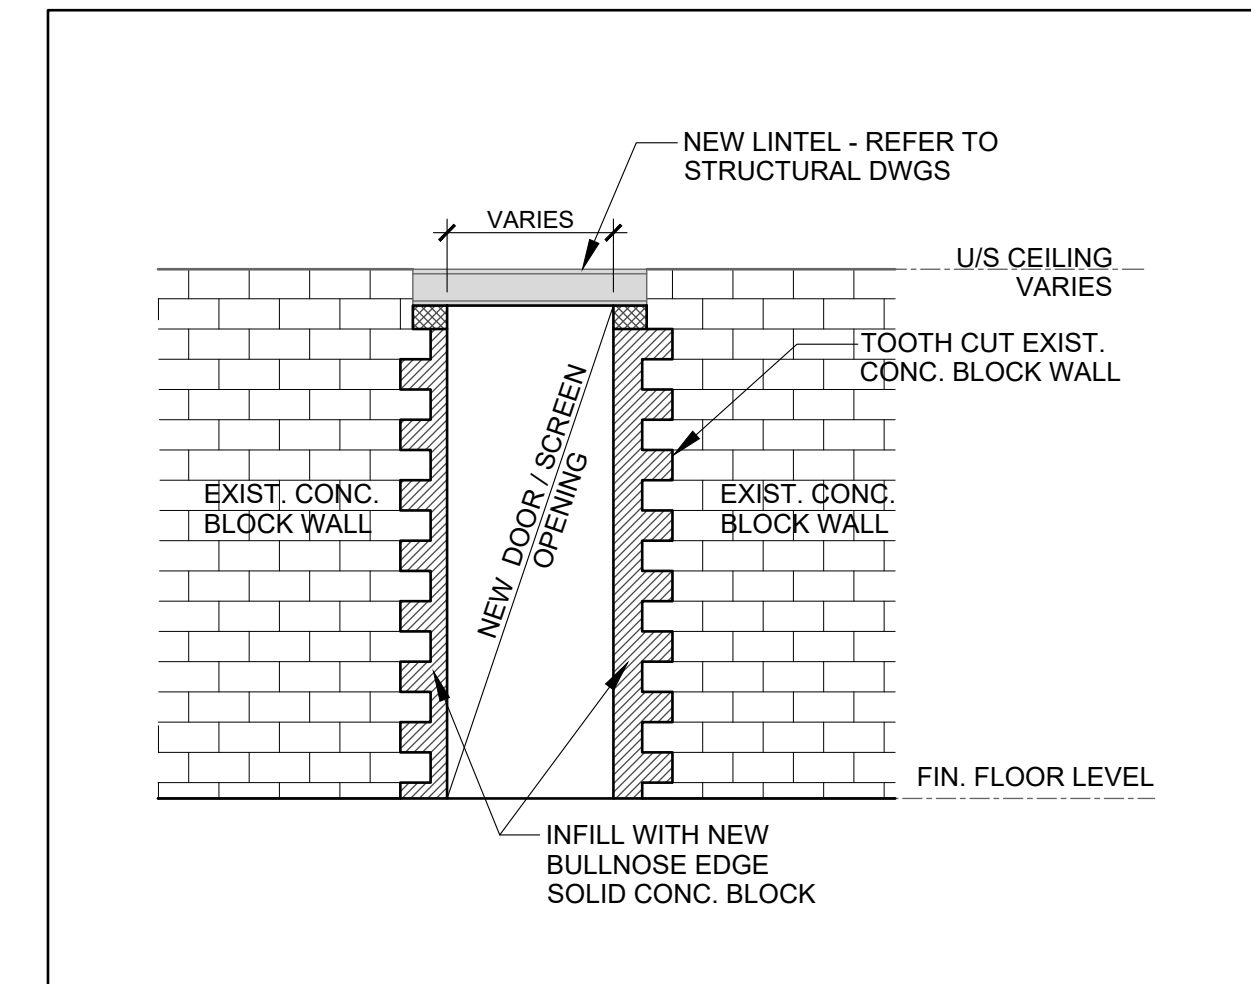

2 NEW DOOR OPENING IN EXIST. WALL
A400 1:50

**BURLINGTON CENTRAL
H.S. RENOVATIONS**

1433 Baldwin Street
Burlington, ON

Architect

sn/yder


Snyder Architects Inc.
260 King St. E. Unit A101, Toronto, ON M5A 4L5
Tel: 416.968.5444 Fax: 416.968.4443
www.snyderarchitects.ca

Consultants

Structural Consultants
Kalos Engineering Inc.
300 York Boulevard
Hamilton, Ontario, L8R 3K6
Tel: 905-333-9119


Mechanical and Electrical Consultants

CK Engineering Inc.
2400 Industrial Street
Burlington, Ontario, L7P 1A5
Tel: 905-631-1115

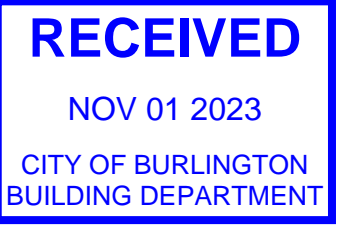

ALL CONSTRUCTION TO MEET ONTARIO BUILDING CODE REQUIREMENTS

Key Plan N.T.S.

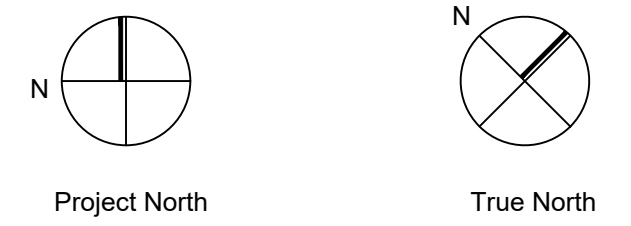

No.	Revisions	Date
4	RE-ISSUED FOR PERMIT	2023/10/31
3	RE-ISSUED FOR PERMIT	2023/08/11
2	ISSUED FOR PERMIT	2023/06/14
1	ISSUED FOR PC #14	2023/06/02

No.	Issue	Date
4	RE-ISSUED FOR PERMIT	2023/10/31
3	RE-ISSUED FOR PERMIT	2023/08/11
2	ISSUED FOR PERMIT	2023/06/14
1	ISSUED FOR PC #14	2023/06/02

General Contractor shall check and verify all dimensions and report all errors and omissions to the Architect. Do not scale the drawings. Drawings shall not be used for construction purposes until issued by the Architect for construction.




Drawing Title:
FIRST, SECOND & THIRD FLOOR- NEW WASHROOMS LAYOUTS

Scale: AS NOTED Date: 19-04-2023


Drawn by: _____ Checked by: _____

Job No. _____ Drawing No. _____


2005 A400

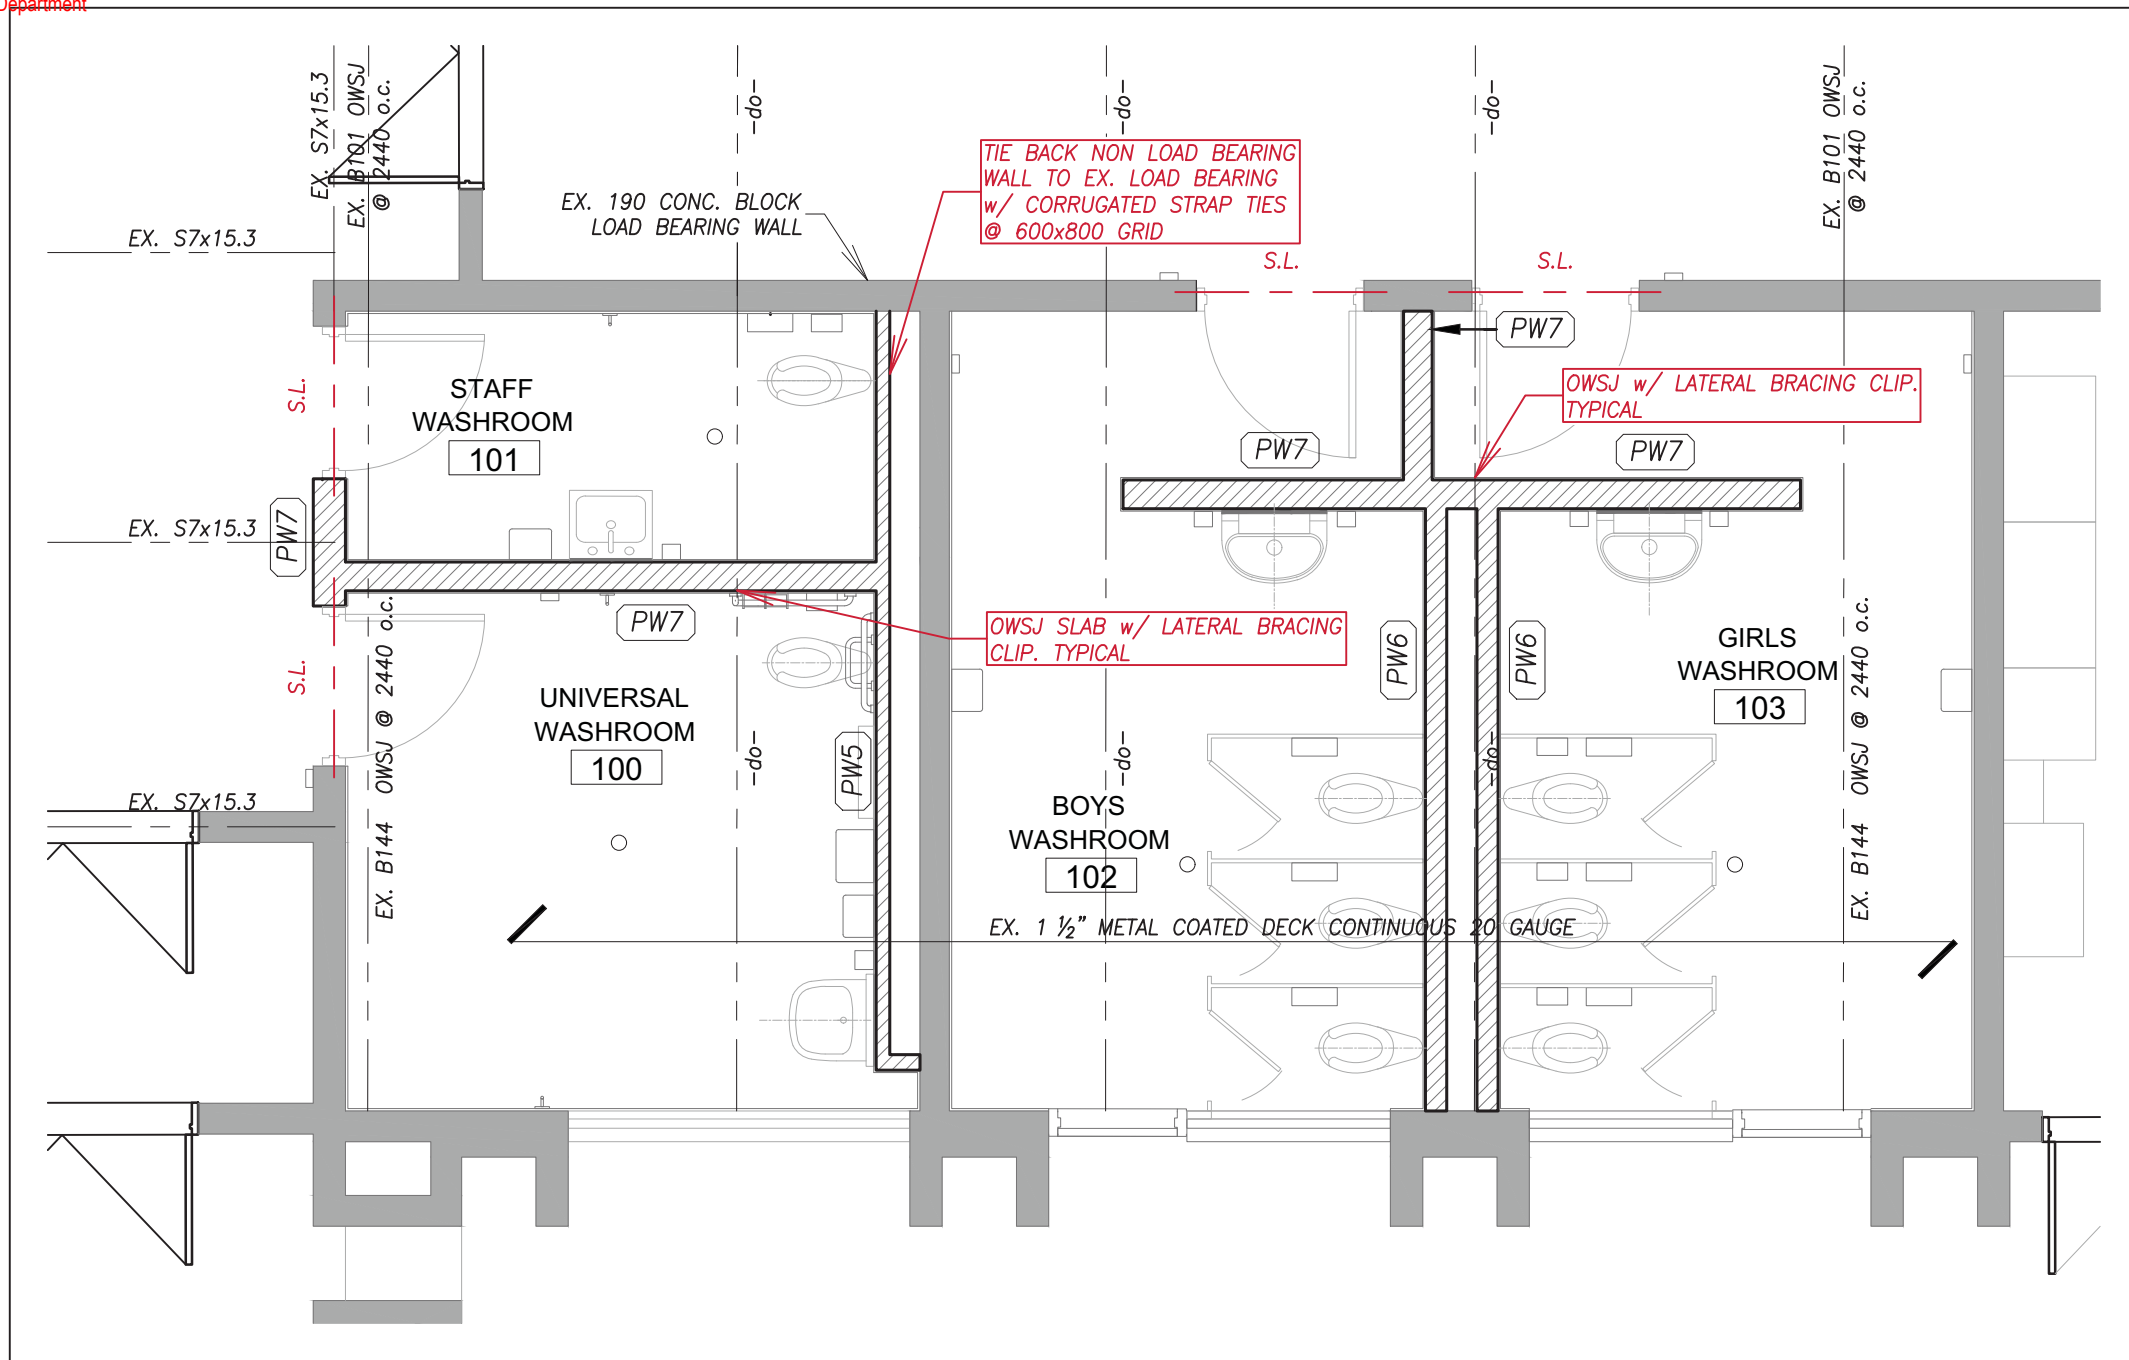


FIRST FLOOR LIBRARY WASHROOMS NEW FLOOR PLAN (1)
SCALE: 1:50 S200

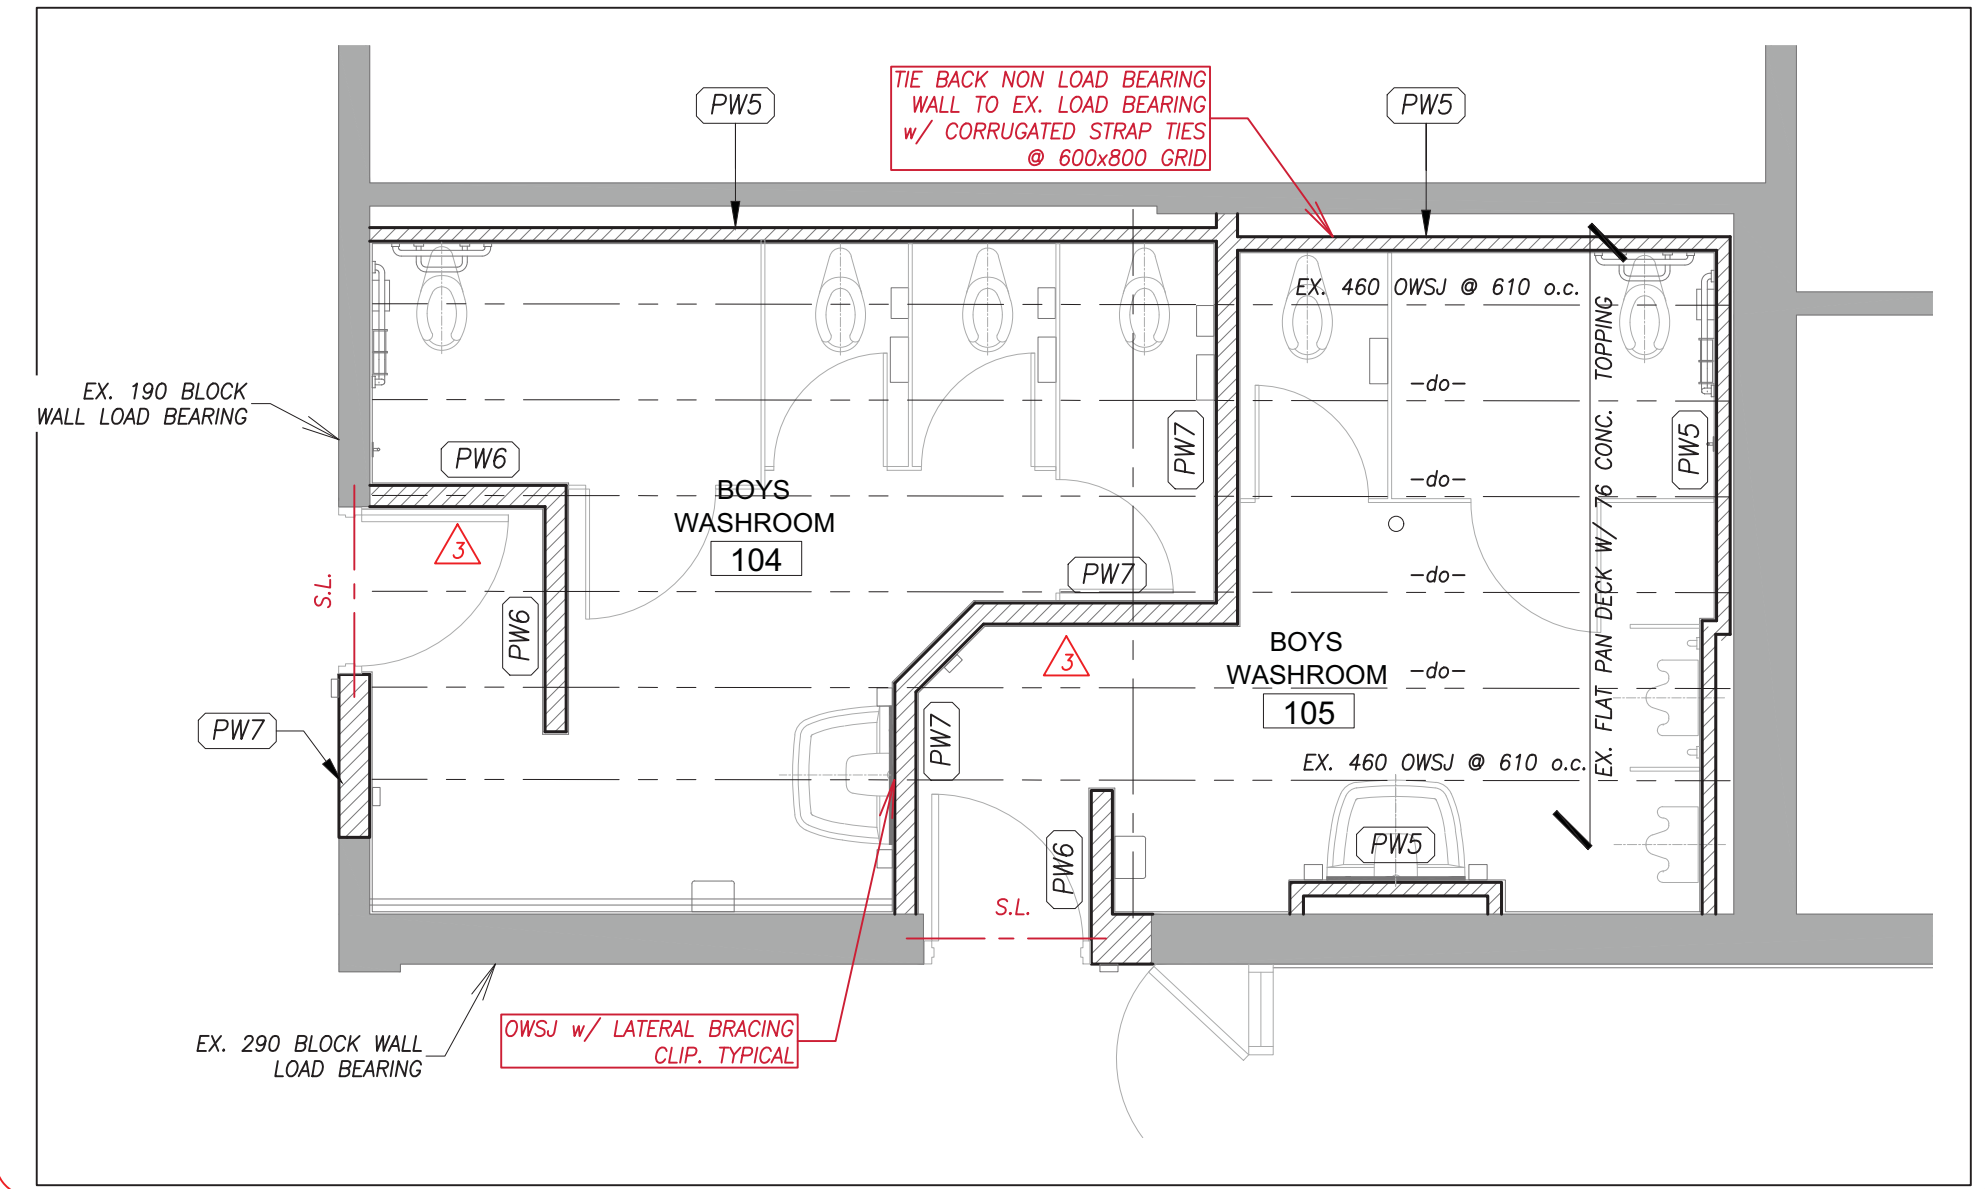


FIRST FLOOR GYM WASHROOMS NEW FLOOR PLAN (2)
SCALE: 1:50 S200

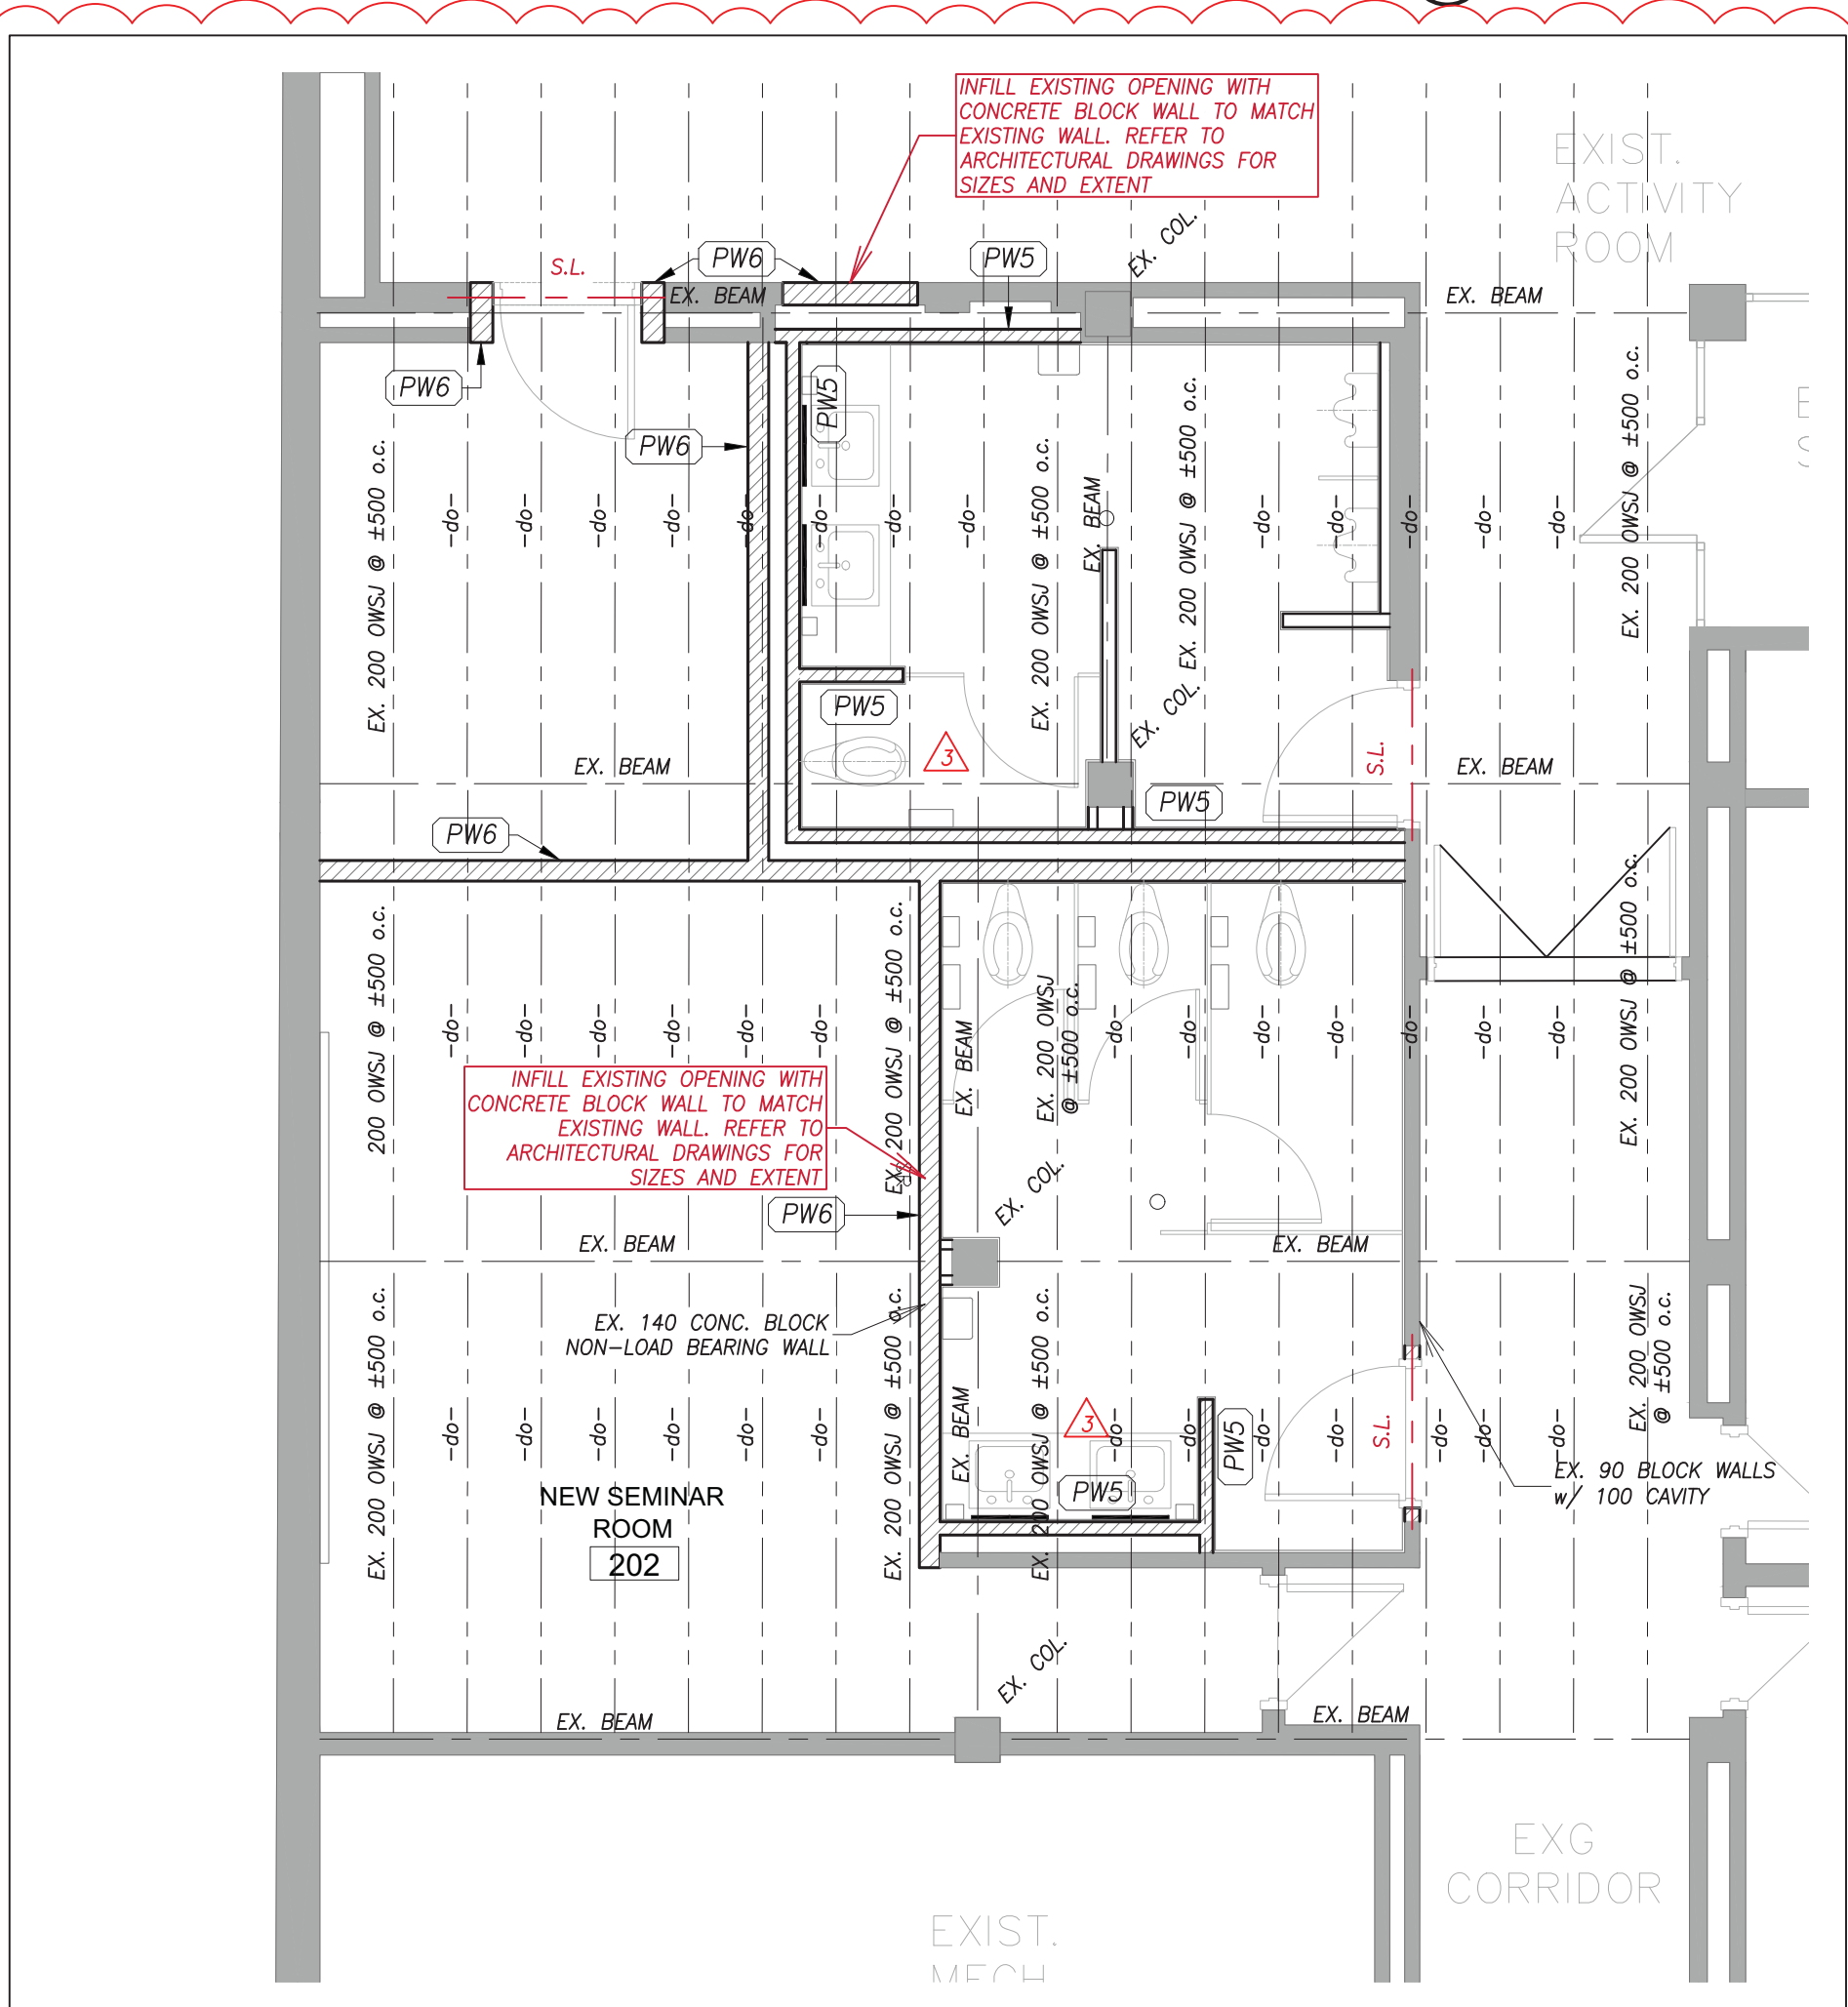


SECOND FLOOR WASHROOMS NEW FLOOR PLAN (3)
SCALE: 1:50 S200

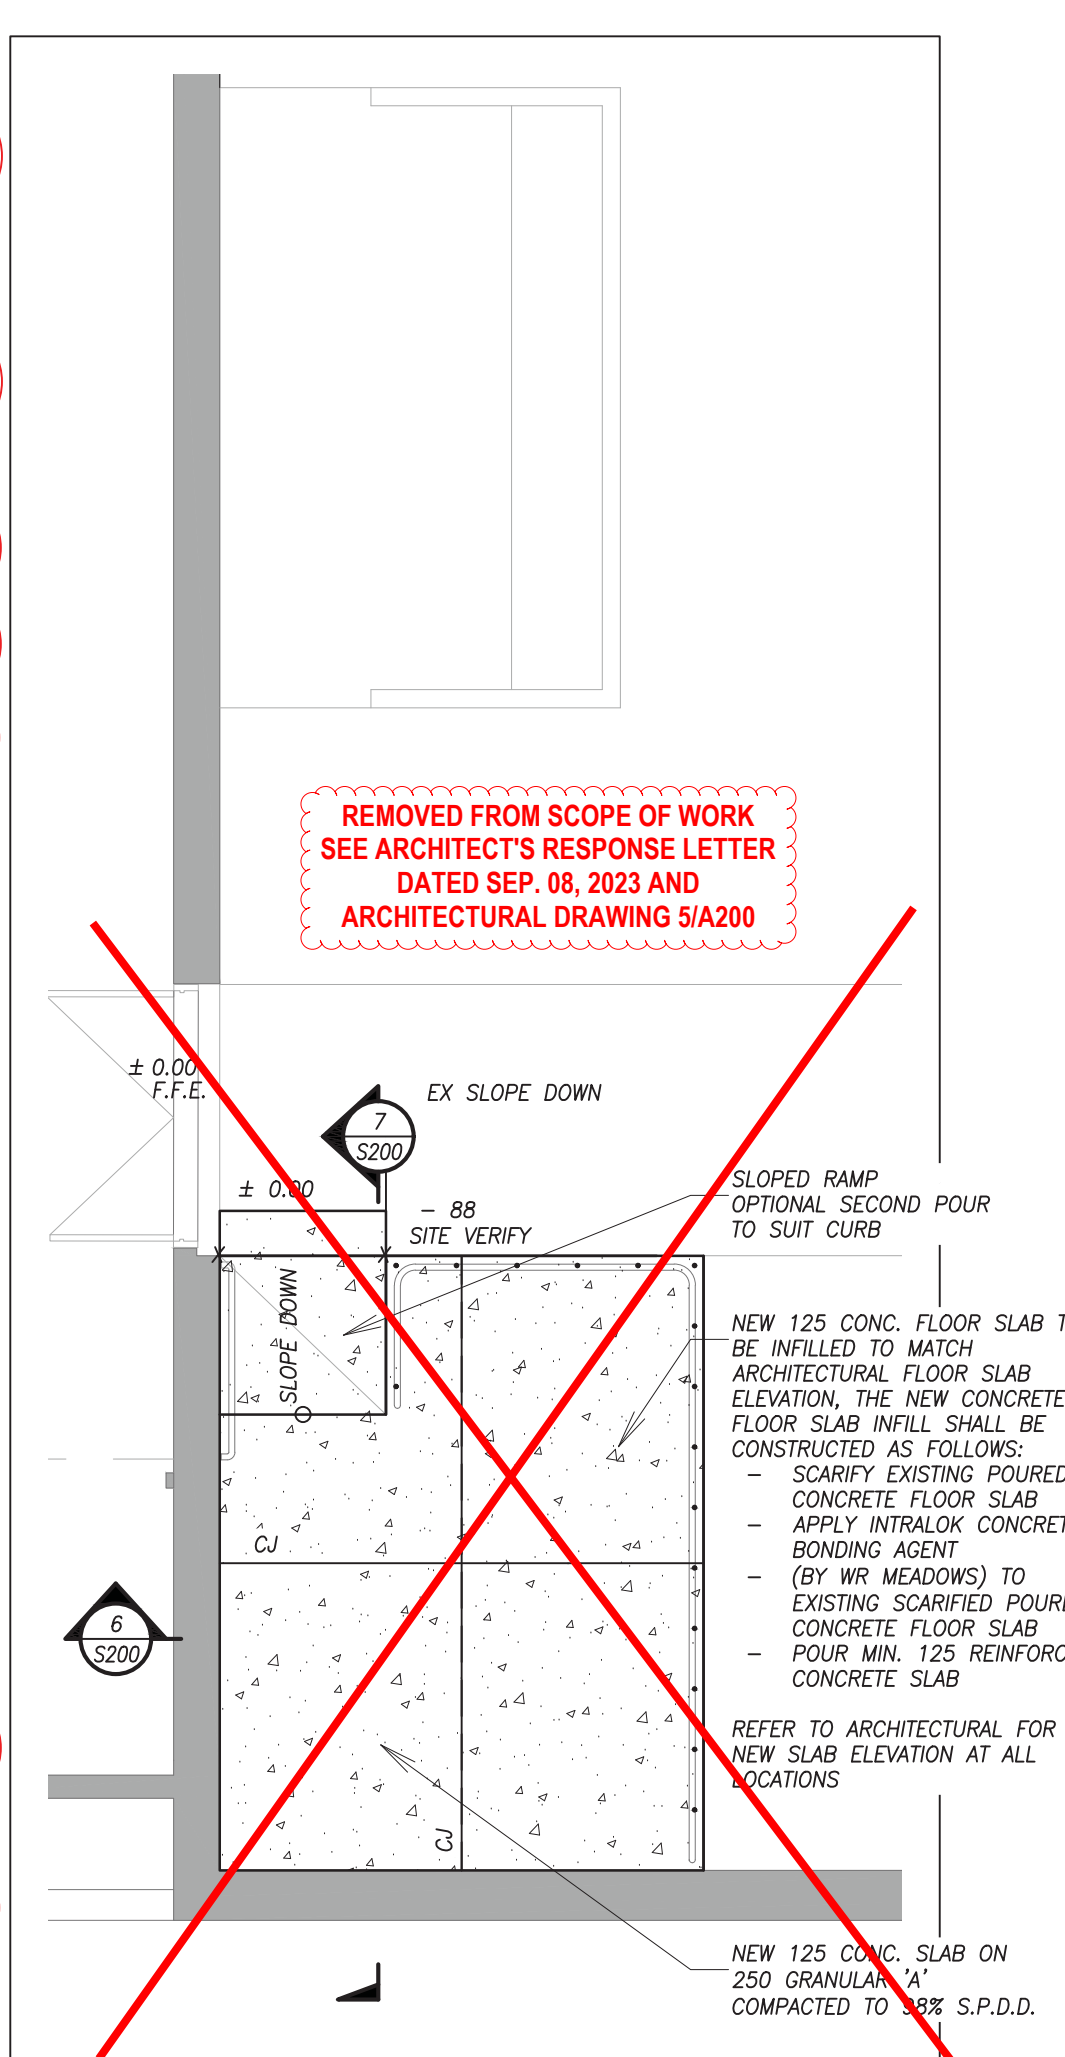


AUDITORIUM BF SEATING - FOUNDATION PLAN (5)
SCALE: 1:50 S200

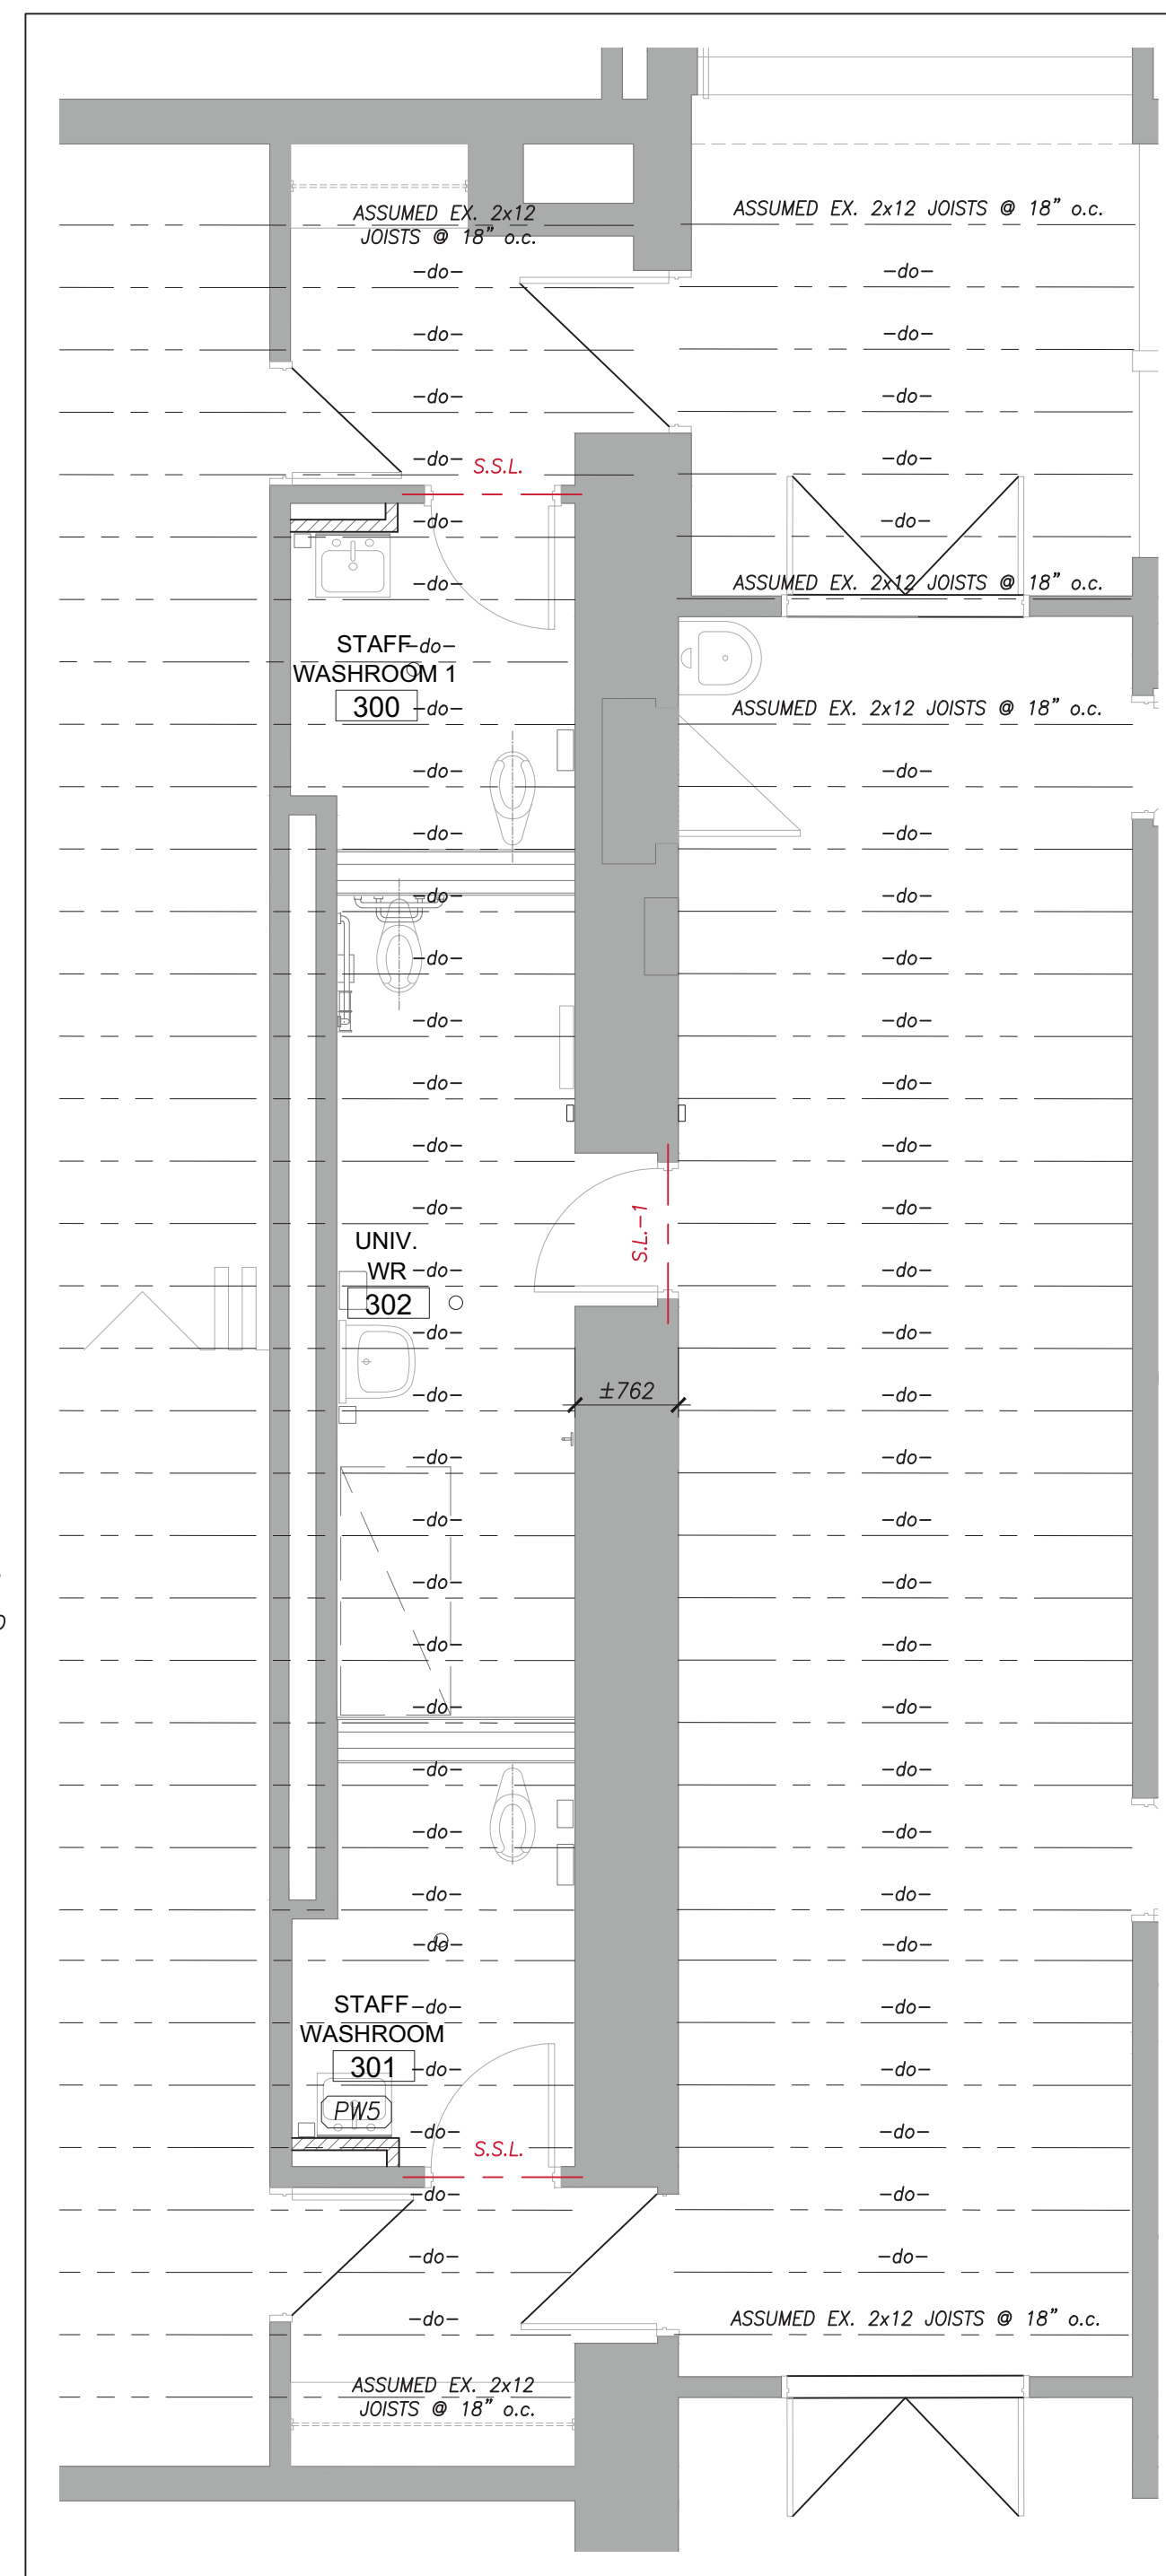


THIRD FLOOR WASHROOMS NEW FLOOR PLAN (4)
SCALE: 1:50 S200

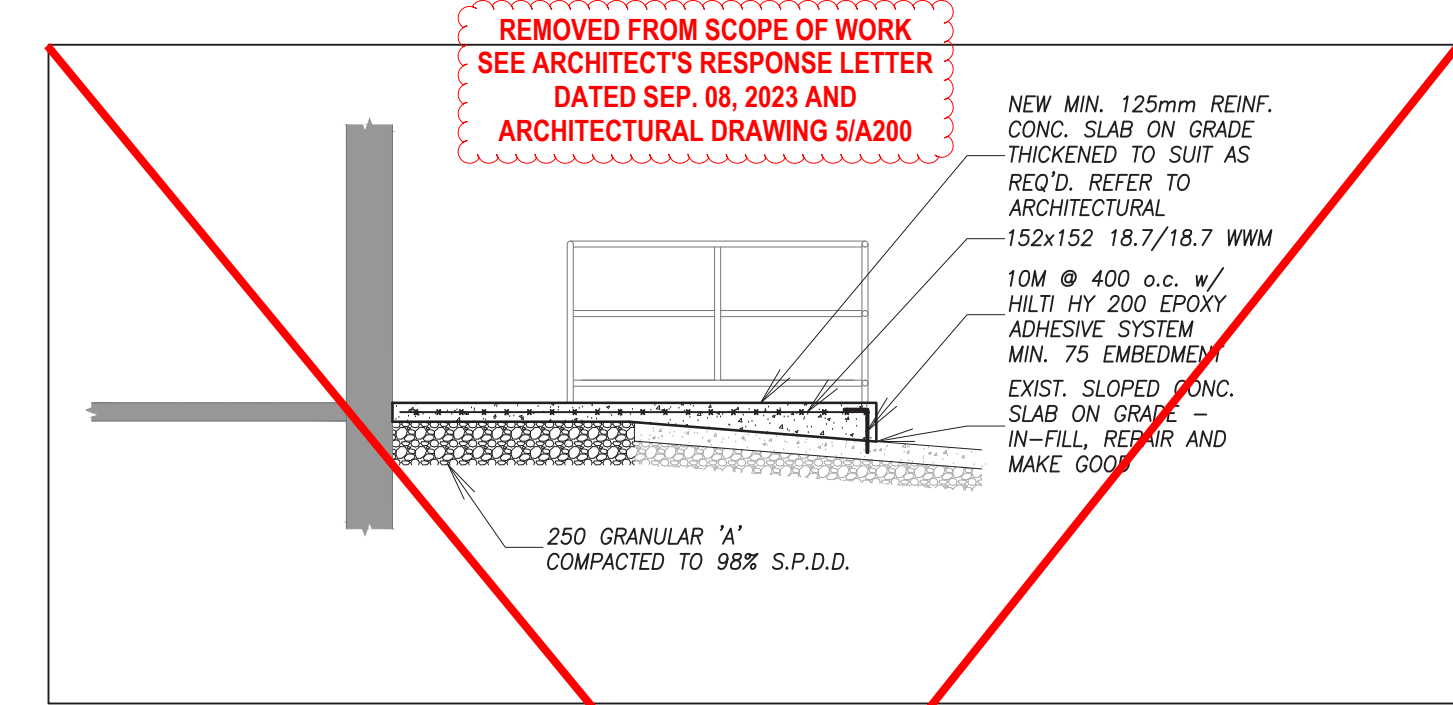

AUDITORIUM BF SEATING - SECTION (6)
SCALE: 1:50 S200

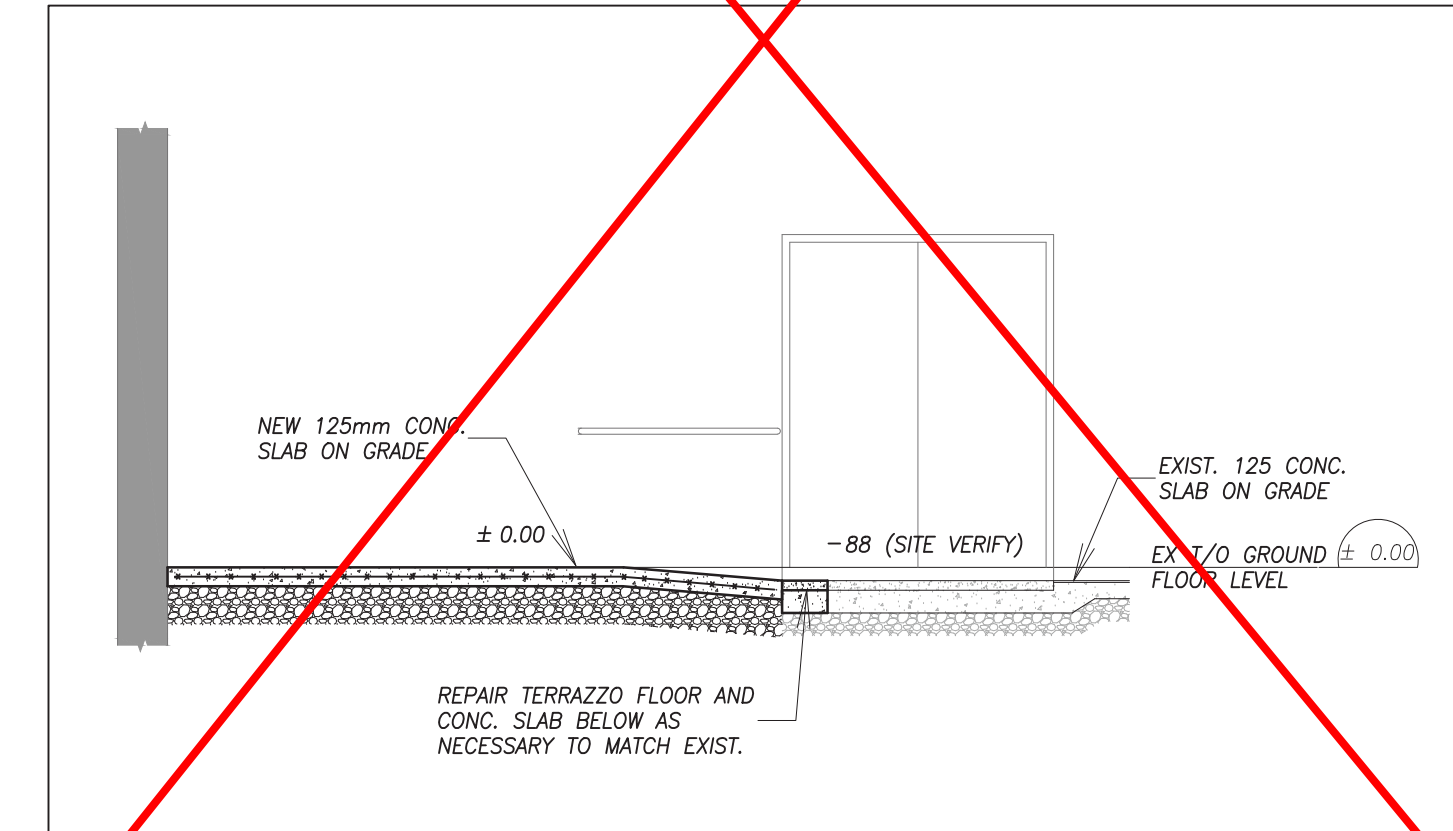

AUDITORIUM BF SEATING - SECTION (7)
SCALE: 1:50 S200

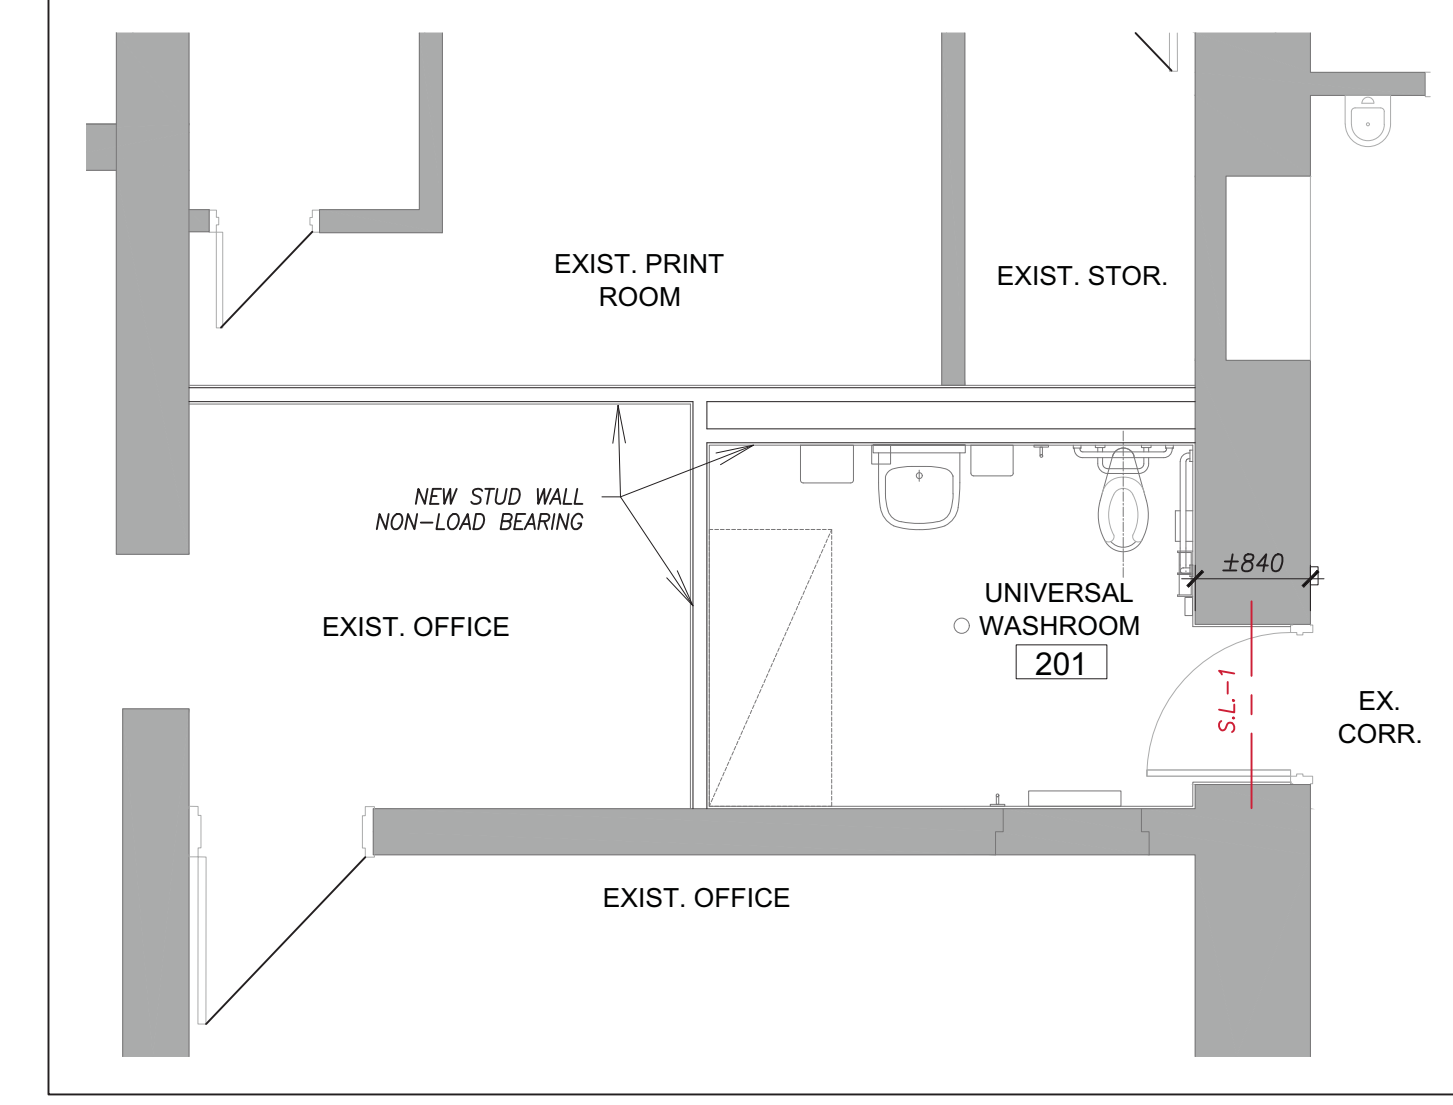

SECOND FLOOR UNIVERSAL WASHROOM (8)
SCALE: 1:50 S200

NEW INTERIOR WALL AND PARTITION TYPES:

- (PW4) 90mm FILL-IN BRICK WALL
- (PW5) 90mm CONCRETE MASONRY UNIT WALL
- (PW6) 140mm CONCRETE MASONRY UNIT WALL
- (PW7) 190mm CONCRETE MASONRY UNIT WALL (LOAD BEARING)
- (PW8) 290mm CONCRETE MASONRY UNIT WALL

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CITY OF BURLINGTON
BUILDING DEPARTMENT

ALL CONSTRUCTION TO MEET ONTARIO BUILDING CODE REQUIREMENTS

NOTE:
1. INFORMATION FROM EXISTING DRAWINGS PREPARED BY:
-SHORE & MOFFAT ARCHITECTS PROJECT FILE #158 DATED DEC 1949.
-SHORE & MOFFAT ARCHITECTS PROJECT FILE #158B DATED MAR 1954.
-SHORE & MOFFAT ARCHITECTS PROJECT FILE #158D DATED JUN 1961.
-WALL YAMAMOTO & MATTHEWS ARCHITECTS PROJECT FILE #6410 DATED APR 1965.

Client
Halton District School Board
2050 Guelph Line
Burlington, Ontario

**BURLINGTON CENTRAL
H.S. RENOVATIONS**

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Project No. 23069
Key Plan N.T.S.



Project North True North

No.	Revisions	Date
3	RE-ISSUED FOR PERMIT	23-10-10
2	RE-ISSUED FOR PERMIT	23-08-11
1	ISSUED FOR PERMIT	23-06-13

No.	Issue	Date
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2	RE-ISSUED FOR PERMIT	23-08-11
1	ISSUED FOR PERMIT	23-06-13

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Disclaimer:
This drawing is being issued at this time in response to a request made by a sub-contractor. The burden of coordinating the information contained in this drawing rests solely on the sub-contractor. The information included in this drawing is subject to change without notice and the Architect does not assume any liability for its content.

Drawing Title:
**FIRST, SECOND & THIRD
FLOOR- NEW WASHROOMS
LAYOUTS**

Scale: AS NOTED Date: 19-04-2023

Drawn by: Checked by:

Job No. Drawing No.

2005 S200