

Addendum # 1

Bid Opportunity: 24-7556-RFT – Waterloo-Oxford District Secondary School Family Studies Renovation & HVAC Upgrades

Closing Date: Thursday, April 18, 2024 2:00 PM

The following issued by the Board shall form part of the Bid / Proposal Solicitation document. The revisions and additions noted herein along with any attachments shall be read in conjunction with all other related documents. This Addendum shall, take precedence over the previously issued documents where differences occur. Receipt of this addendum must be acknowledged in the Bidding System, bids&tenders.

If you have already submitted a Bid / Proposal, it will be automatically withdrawn as a result of this addendum. You must resubmit the Bid / Proposal acknowledging all addenda and revising your Bid / Proposal to comply with all addenda.

1.1 QUESTIONS/ ANSWERS

Question 1:

On drawing M3.1, what are the specs for the EF-1? I also don't see a size for the louver near the canopy hood.

Answer 1:

Refer to Mechanical/ Electrical Addendum 01 attached, for clarification.

1.2 ARCHITECTURAL DRAWINGS

- .1 Drawing A0.01 Site Key Plan, OBC Matrix, Room Finish Schedule, Wall Types, Drawing List, & Typical Details
 - .1 ROOM FINISH SCHEDULE
 - .1 IN STORAGE 511A, REVISE WEST WALL MATERIAL FROM "EX" TO "CB".
 - .2 ADD ROOM 511F, AS FOLLOWS:

	FLOOR			WALLS						CEILINGS					
ROOM NAME		FM	FF	BASE	NO	NORTH EAST		SOUTH		WEST		СМ	CF	CE REMARKS	
		FIVI	FF	DASE	WF	WM	WF	WM	WF	WM	WF	WM	CIVI	CF	
511F	ELECTRICAL	EX	EX	EX	EX	Р	СВ	Р	EX	Р	EX	Р	EX	Р	*SEE NOTE FOR ROOM 511A.

- .2 Drawing A1.2 Partial Ground Floor Demolition Plans and Enlarged Fan and Storage Room Demolition Plans
 - .1 REPLACE DRAWING A1.2 WITH DRAWING A1.2R, ATTACHED.
 - .2 REFER TO DRAWING ASK-001, ATTACHED, FOR DEMOLITION OF EXTERIOR GAS STORAGE AREA.
- .3 Drawing A4.1 Roof Key Plan, General Notes, and Partial Roof Plan
 - .1 REPLACE DRAWING A4.1 WITH DRAWING A4.1R, ATTACHED.
- .4 Drawing A5.1 Interior & Exterior Elevations
 - .1 REPLACE DRAWING A5.1 WITH DRAWING A5.1R, ATTACHED.


1.3 STRUCTURAL DRAWINGS


- .1 Drawing S2.01 Existing Level 2 Framing Plan
 - .1 REPLACE DRAWING S2.01 WITH REISSUED DRAWING S2.01, ATTACHED.
 - ADD FRAMING FOR NEW ROOF OPENINGS AT 5 LOCATIONS.

- .2 Drawing S2.02 Existing Roof Framing Plan
 - .1 REVISE NOTE FOR NEW ROOF FRAMING AROUND NEW ROOF OPENING NEAR GRID LINES B AND C TO REFERENCE DETAIL 5-B ON DRAWING \$2.01. NOTE CURRENTLY REFERENCES DETAIL 5-M.
- 1.4 MECHANICAL/ ELECTRICAL
 - .1 REFER TO THE ATTACHED MECHANICAL & ELECTRICAL ADDENDUM #1 PREPARED BY MNE ENGINEERING LTD. DATED 12 APRIL 2024 (9 PAGES).

END OF ADDENDUM 01

+ Drawings ASK-001, A1.2R, A2.1R, A4.1R, A5.1R; Reissued Drawing S2.01; Mechanical/ Electrical Addendum (9 pages)

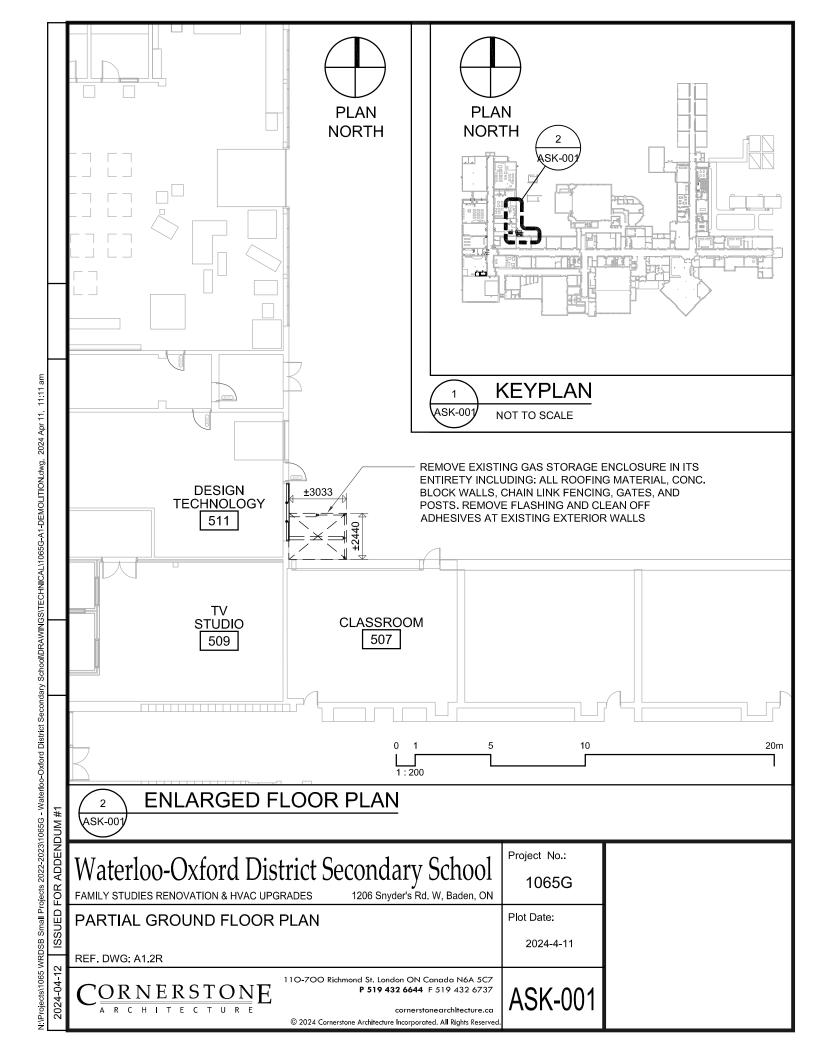

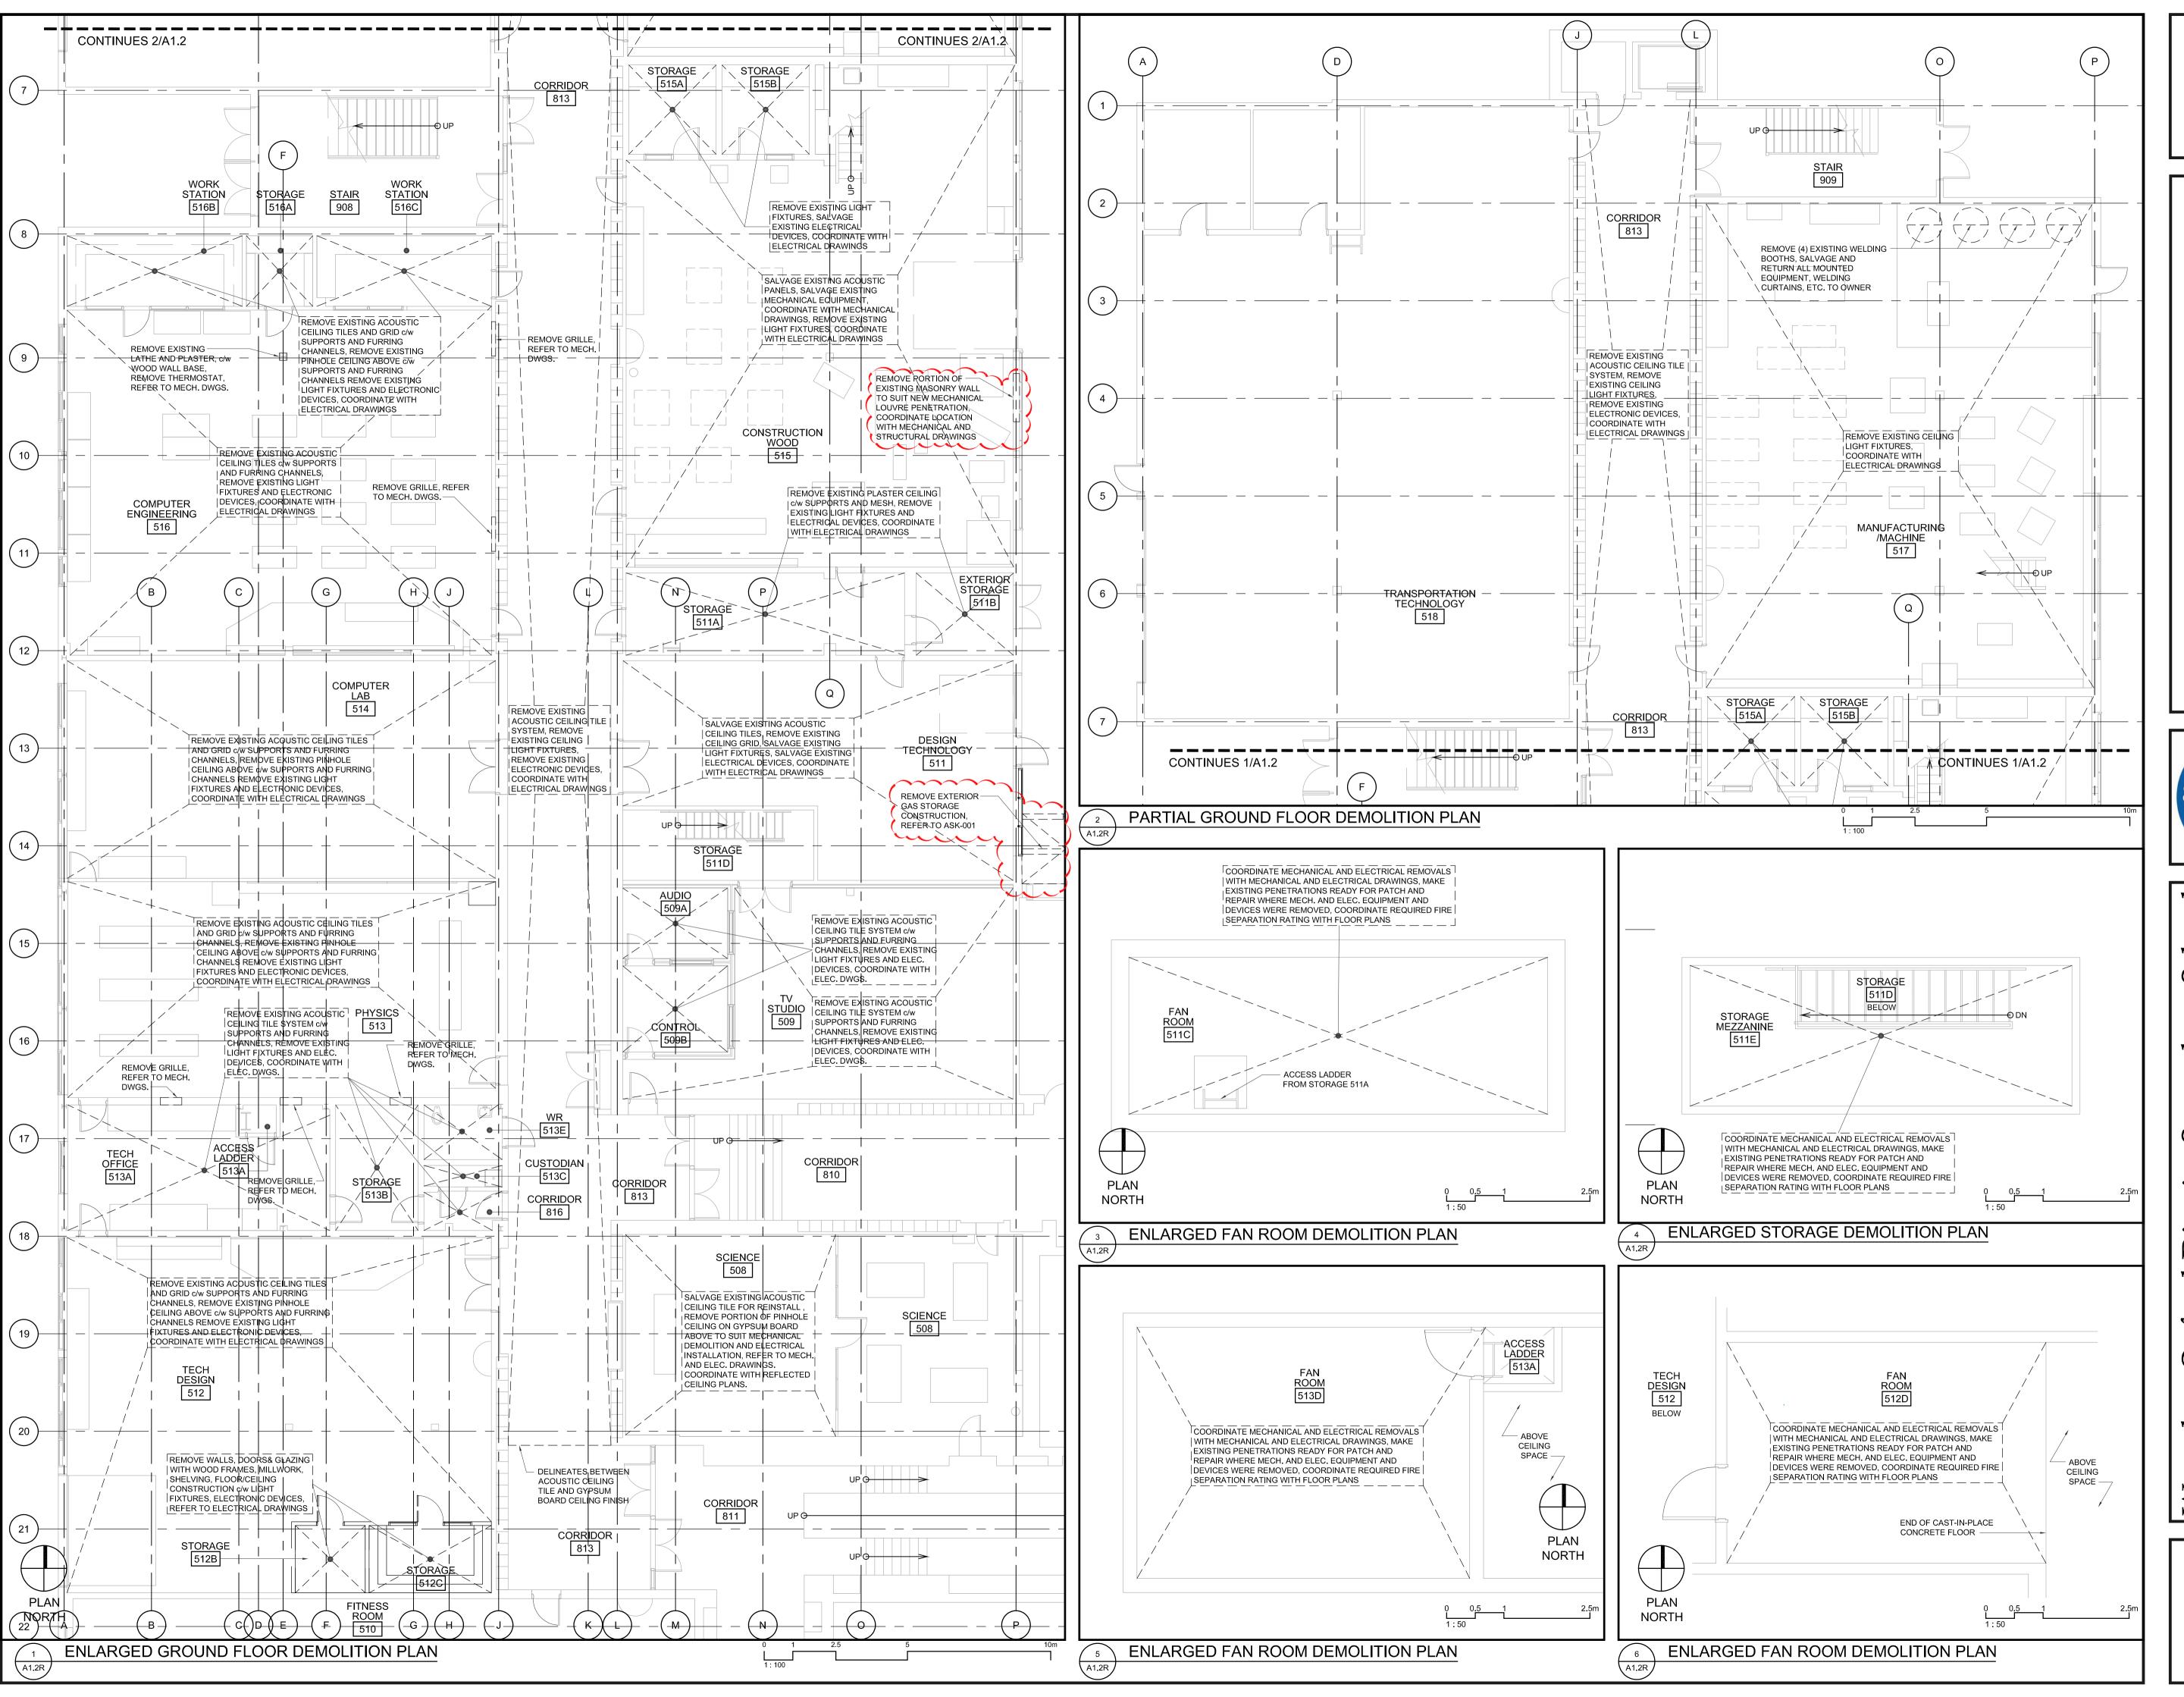


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School

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District -Oxford aterloo



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2024-03-22 ISSUED FOR OWNER REVIEW

2024-04-12 REISSUED FOR ADDENDUM #1
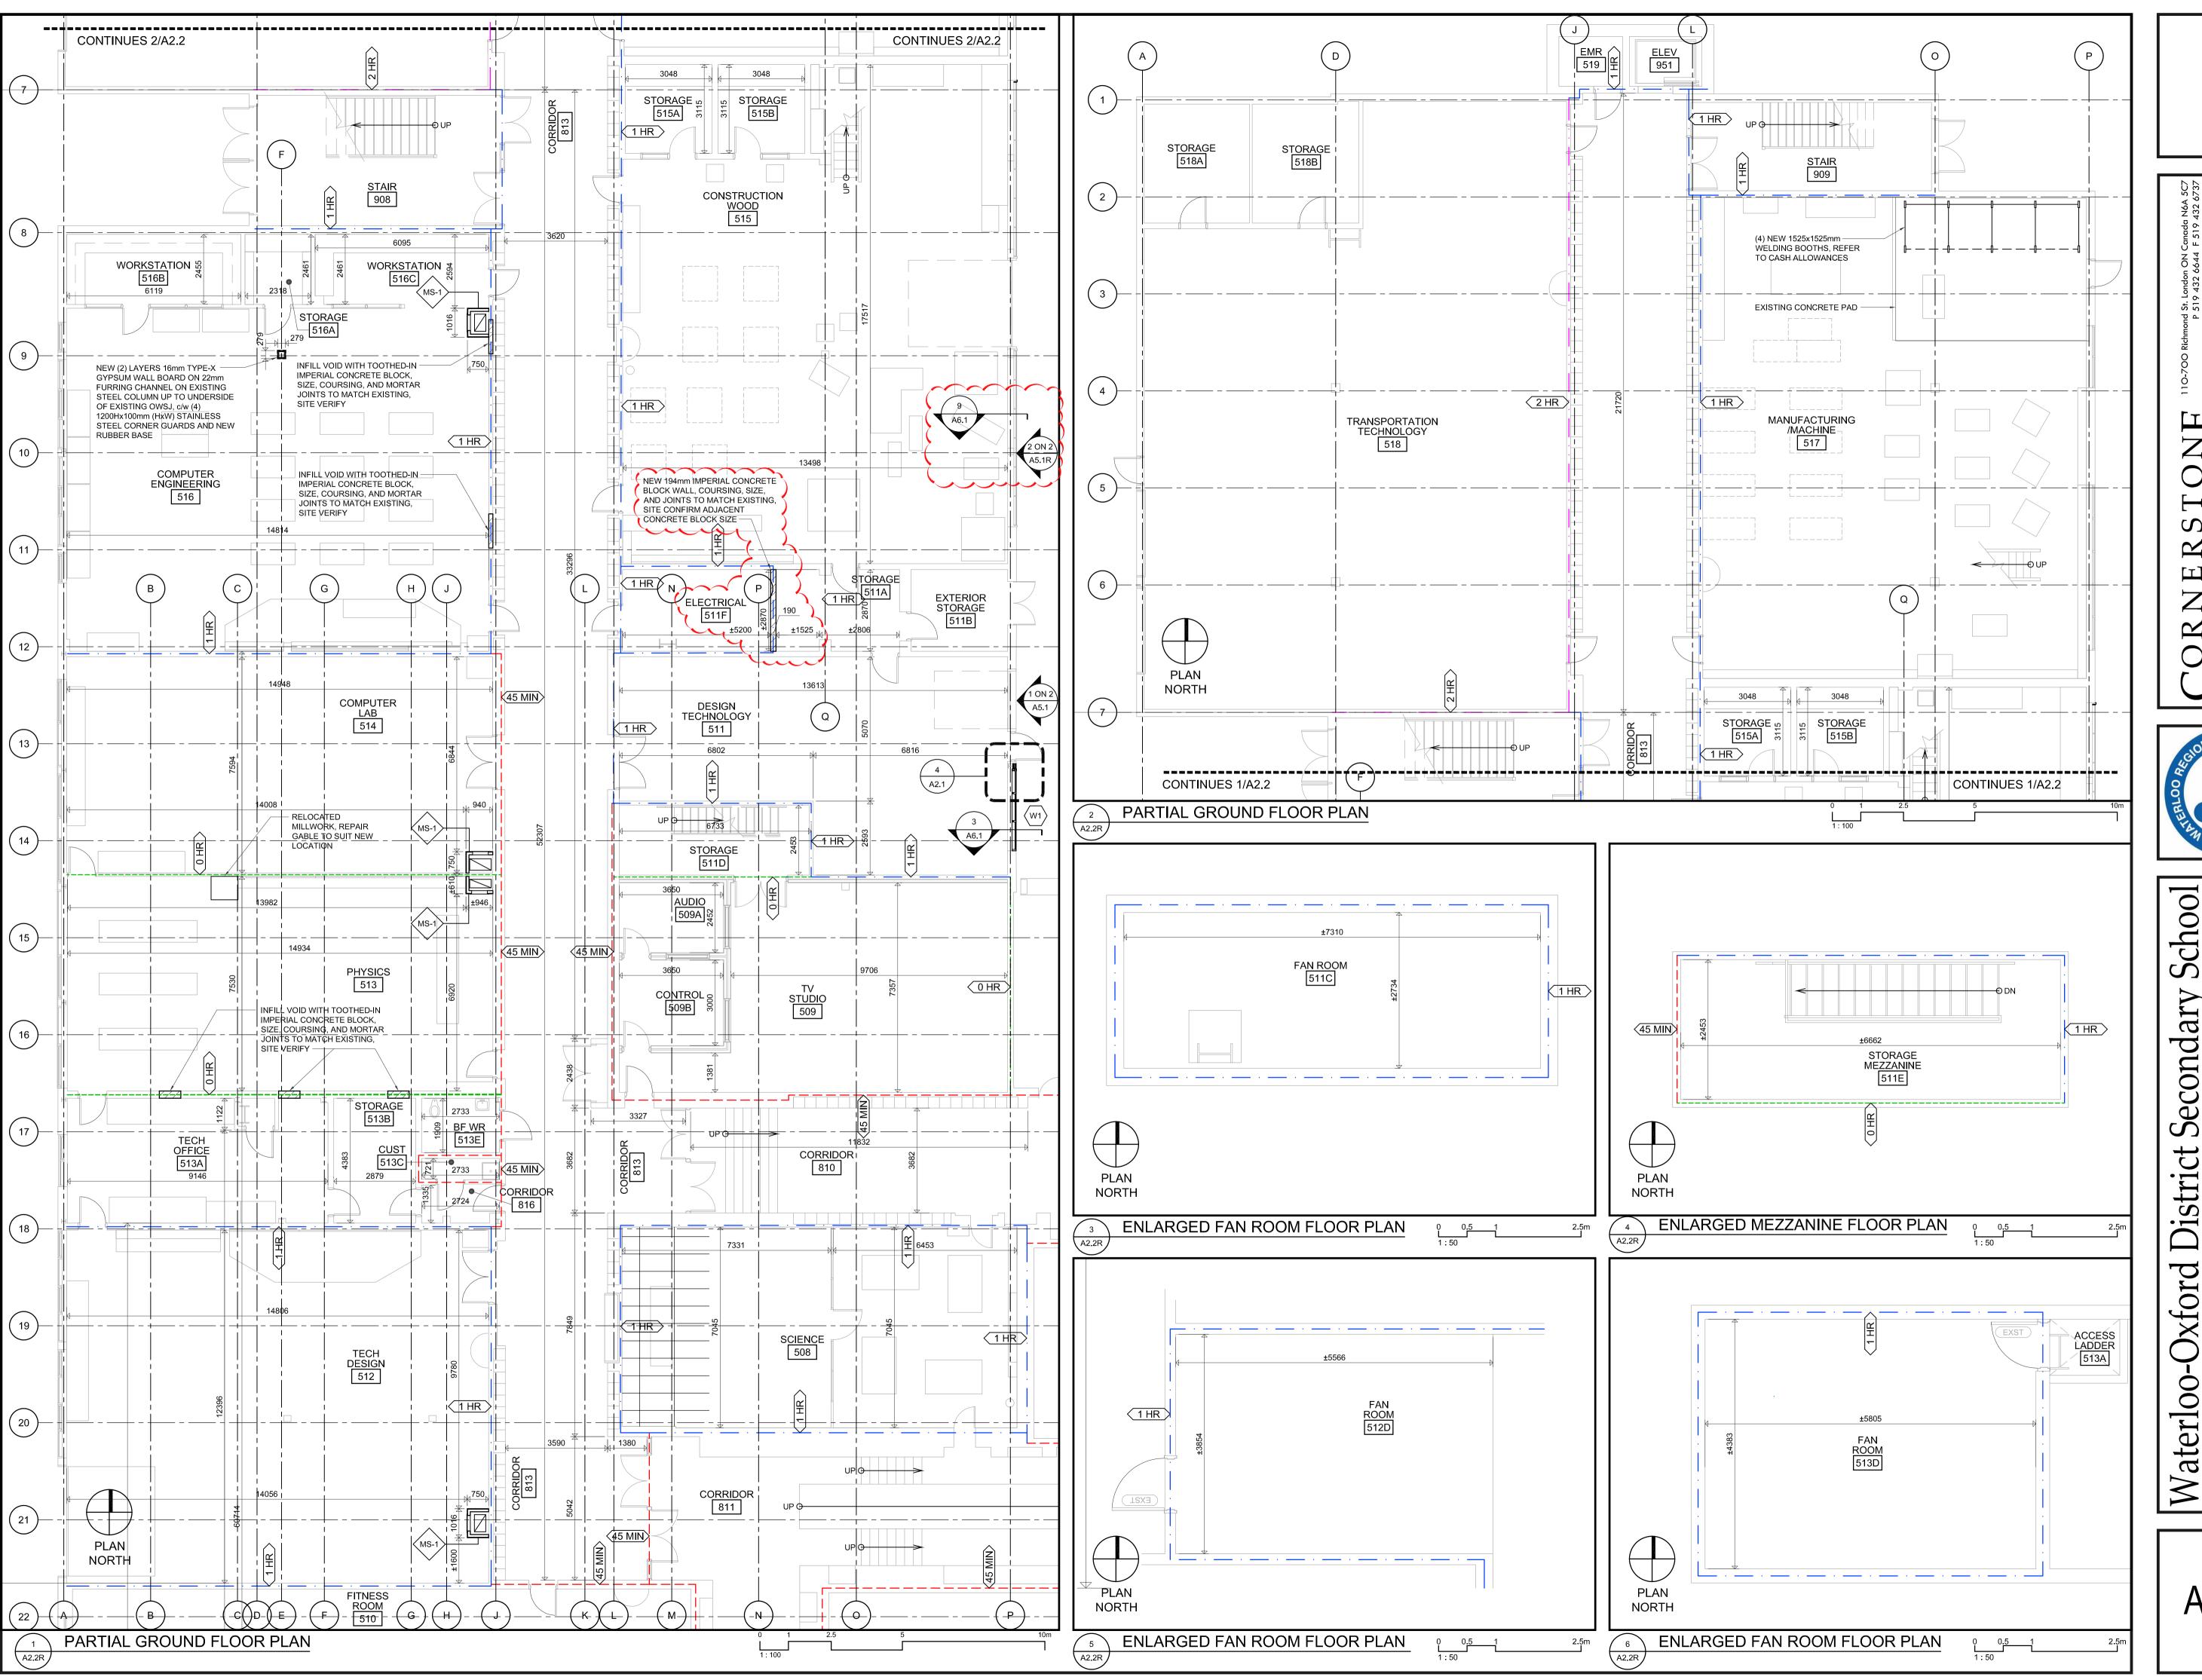
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Waterloo-Oxford District Secondary School Family studies renovation & haze upgarders

Enlarged Ground Floor Plans, enlarged Fan Room & Storage Floor Plans


Fan Room & Storage Floor Plans

1065G

JNL


2024-4-12

A2.2R

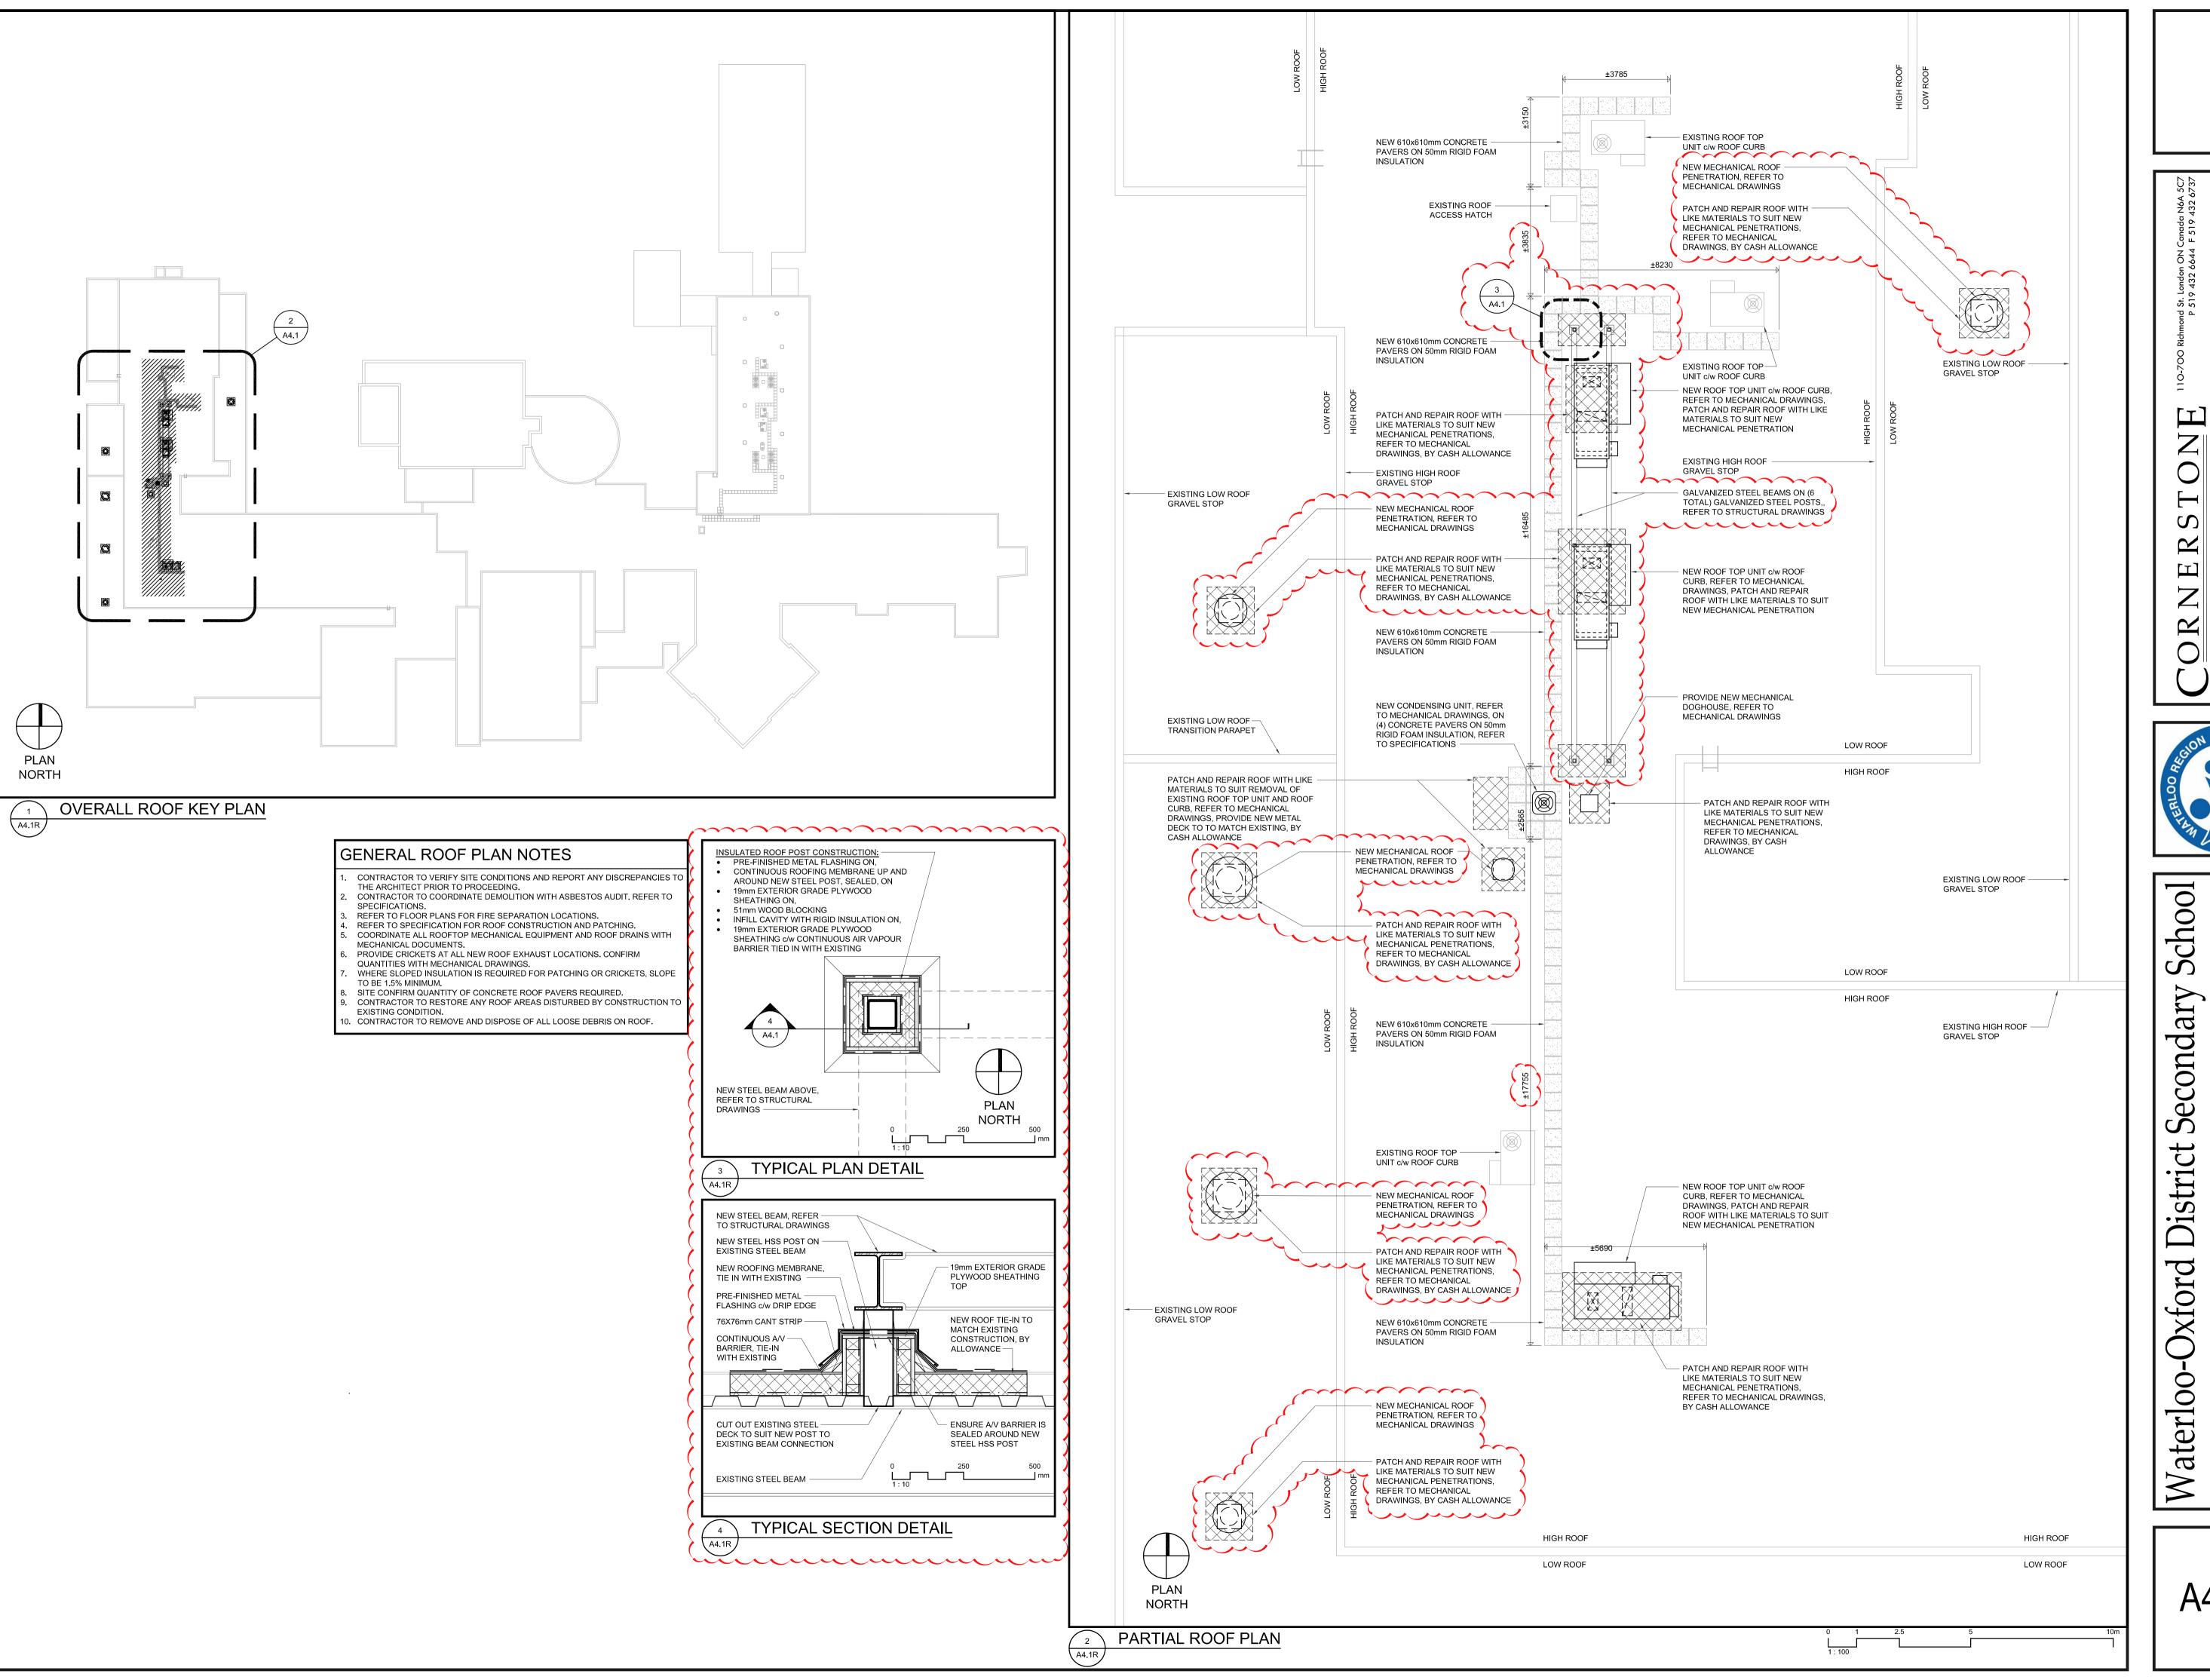



EY PLAN, GENERA PARTIAL ROOF F ROOF KEY NOTES & F

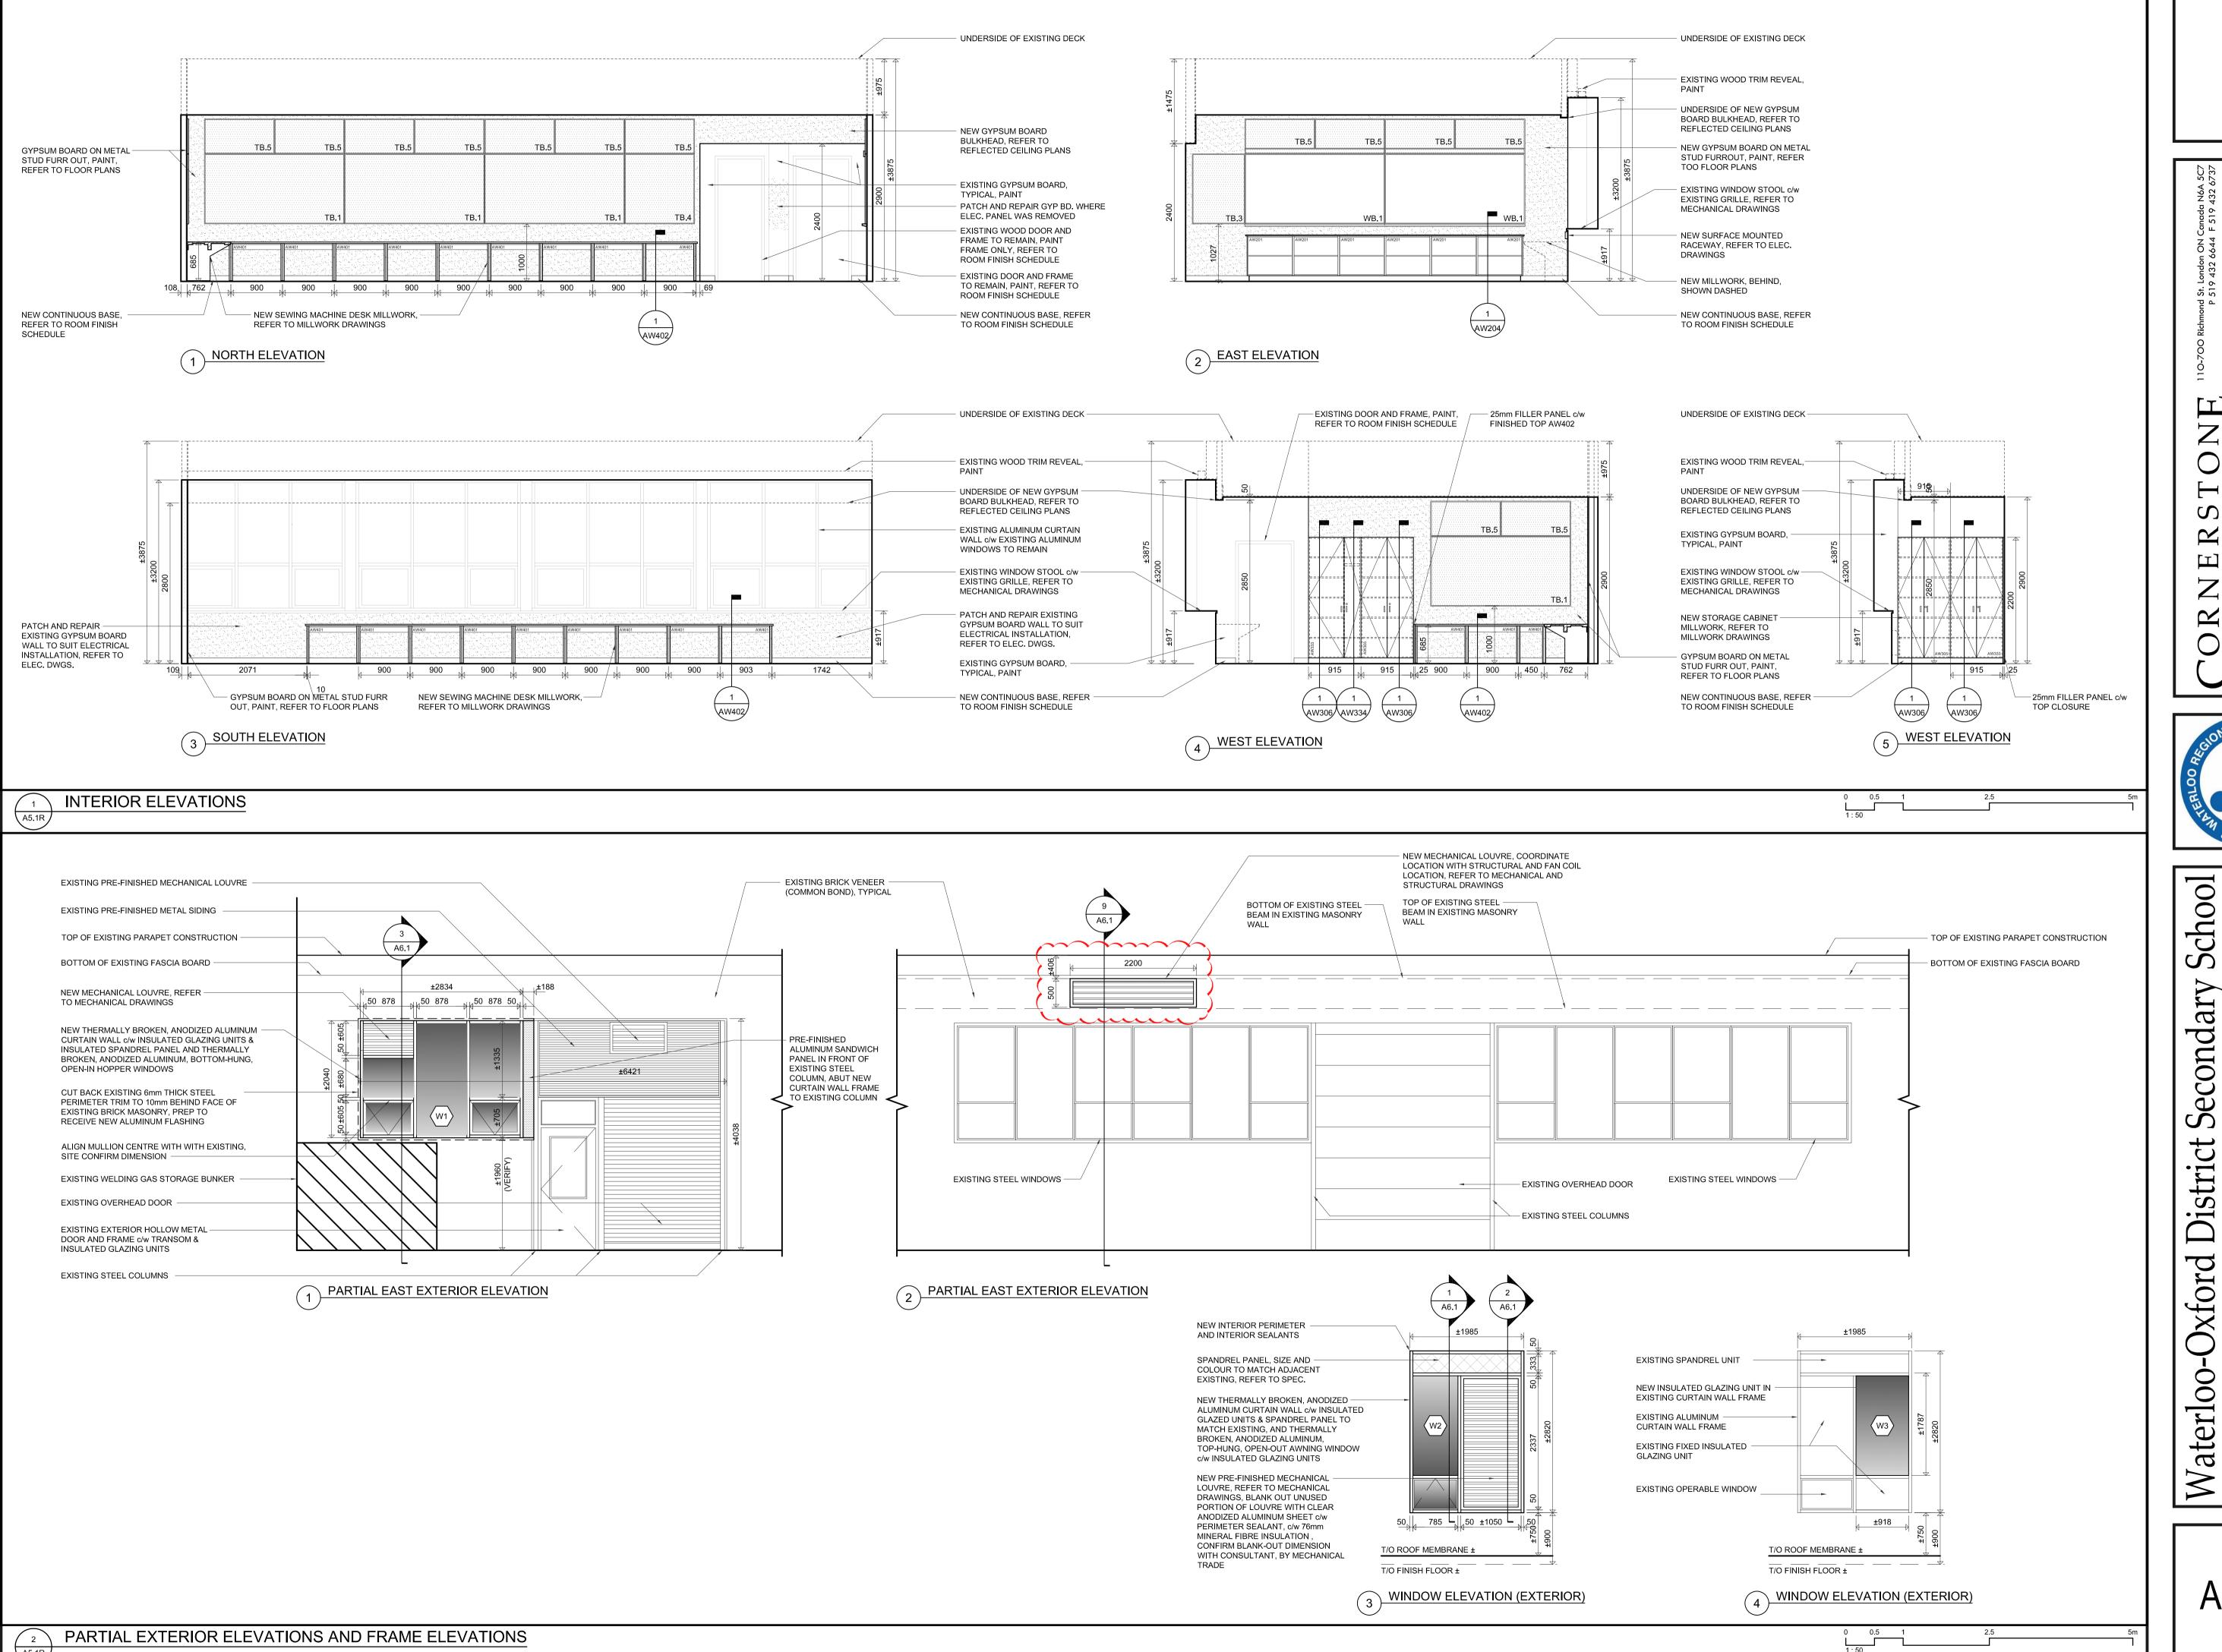




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A5.1R





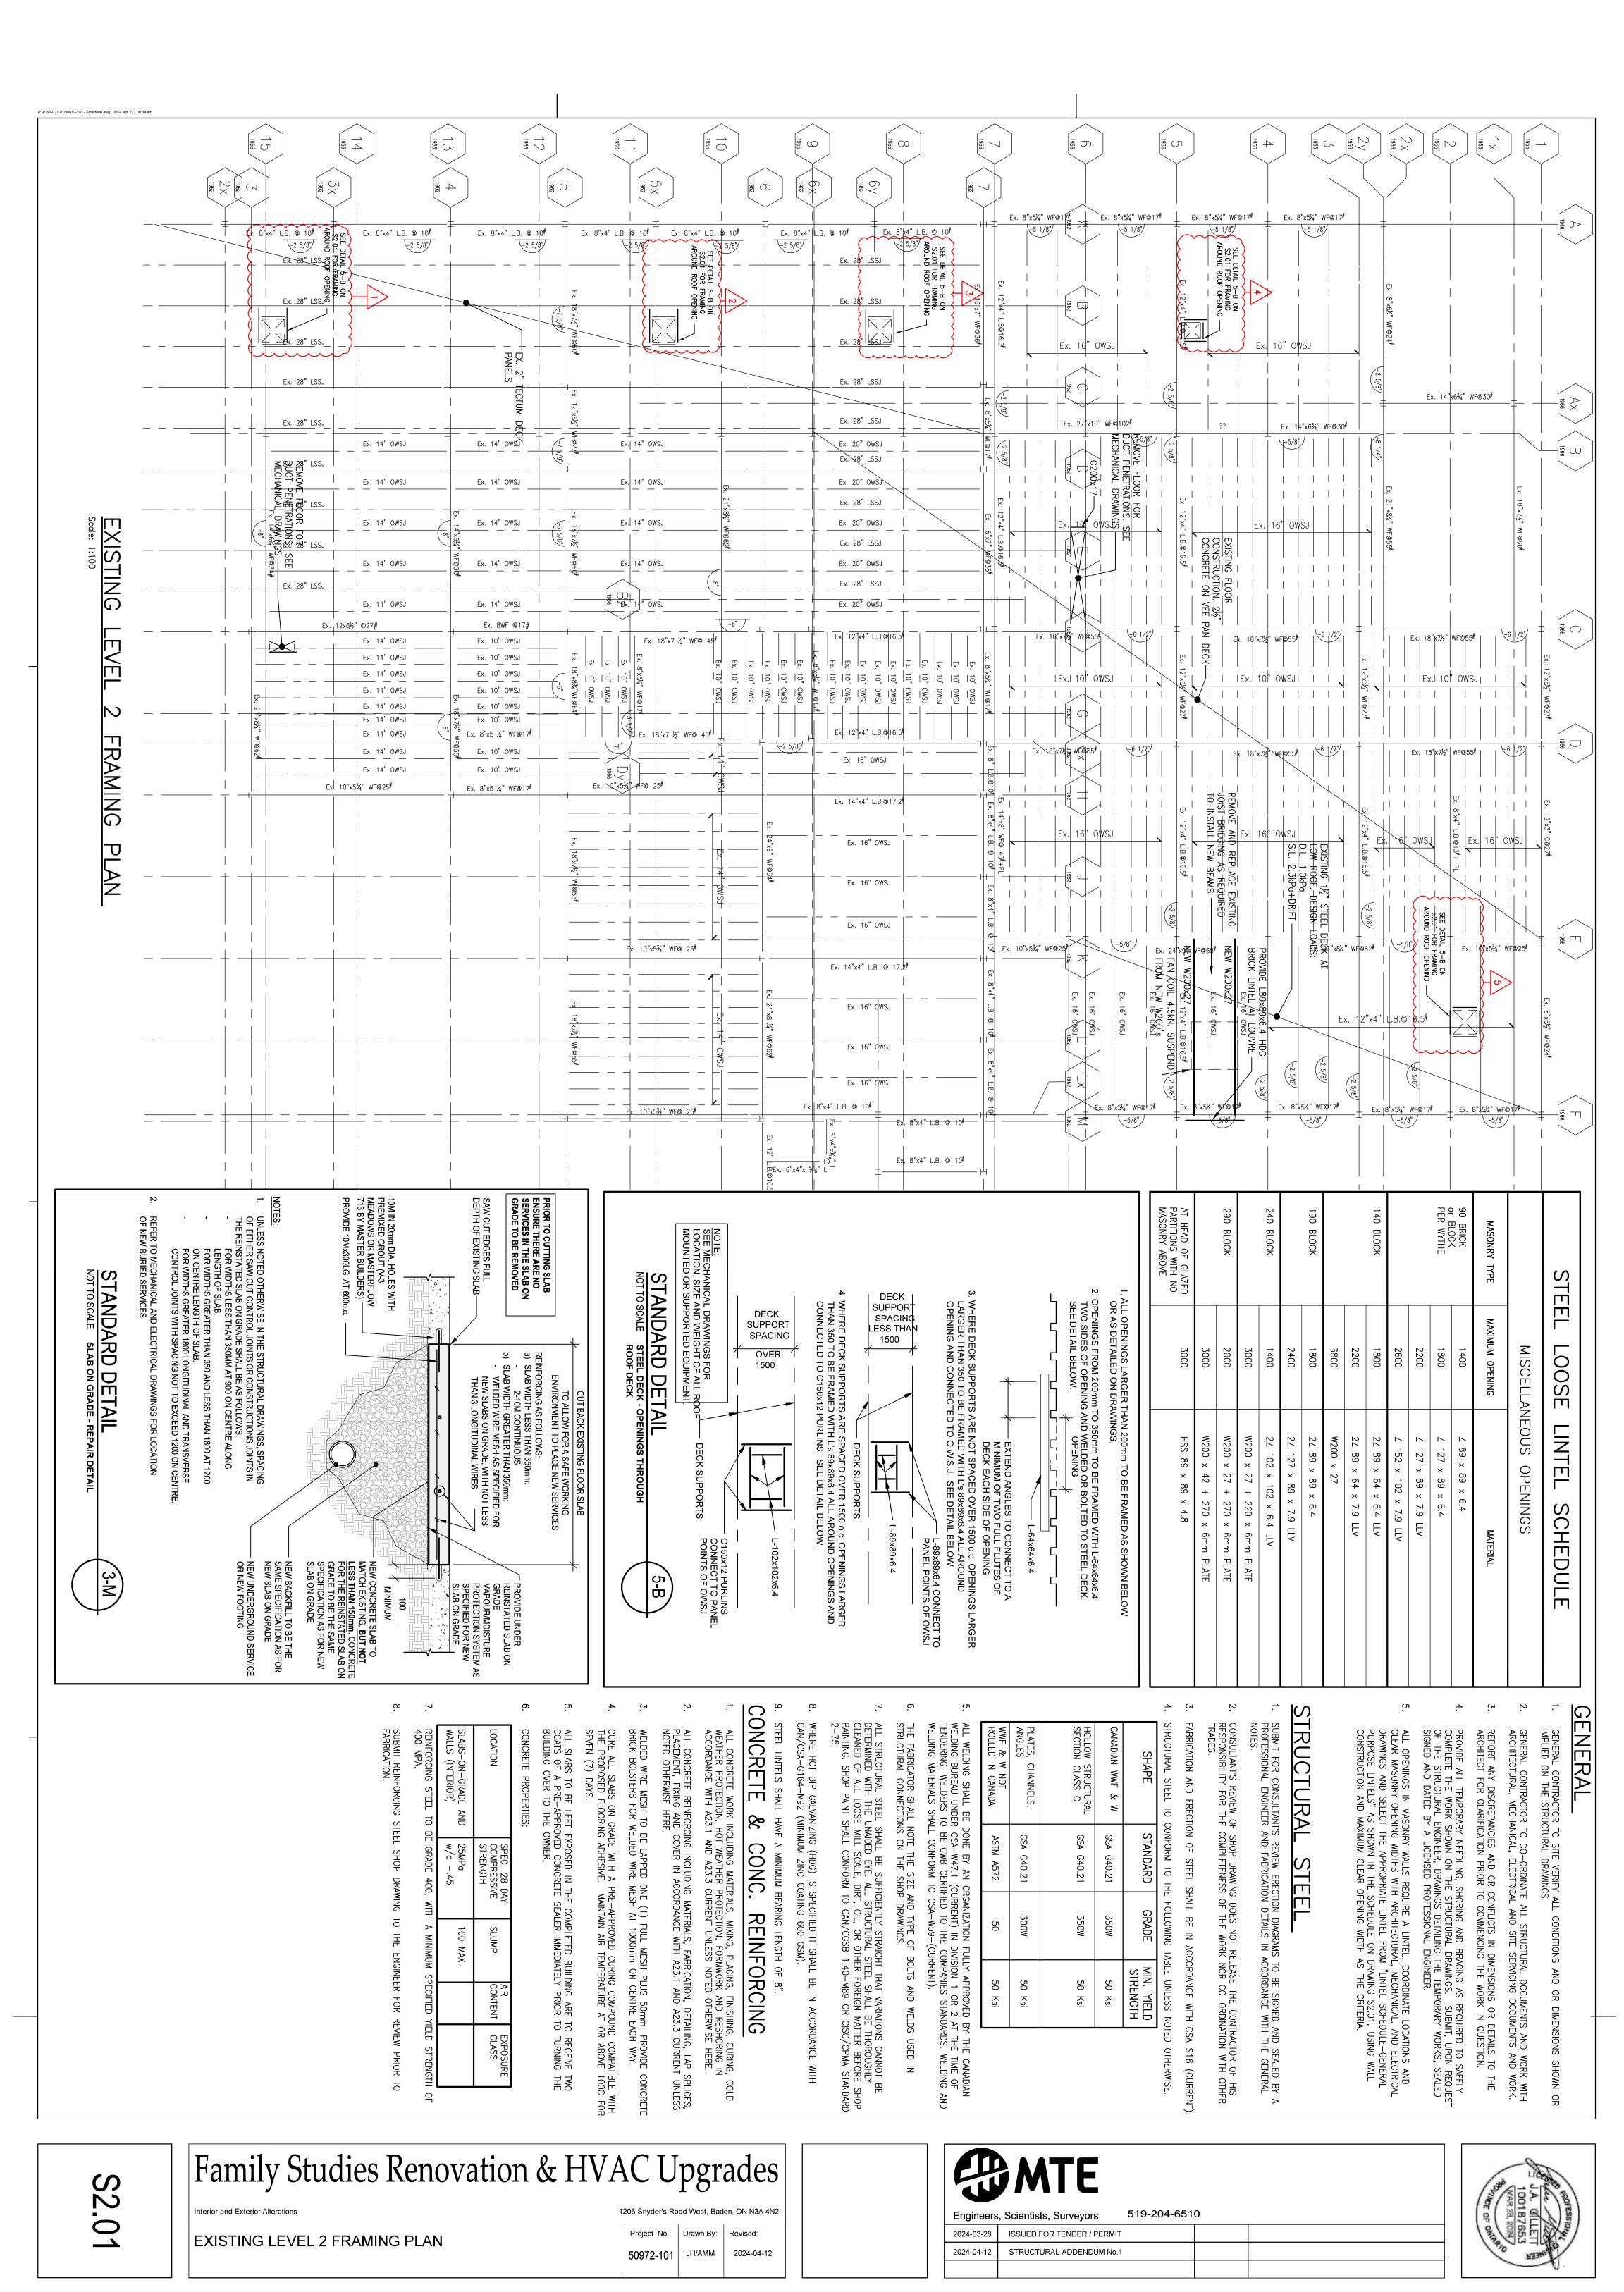

22 Kevco Place - Box A Kitchener, Ontario N2C 2G5 519 894 9408 www.mneengineering.ca

ADDENDUM 01

To:	Cornerstone Architecture	Date:	April 12, 2024
		Project:	Waterloo-Oxford District Secondary School Family Studies Renovations & HVAC Upgrades
cc:	WRDSB	Project No:	24008

This addendum forms part of the contract documents and amends the drawings and specifications.


Mechanical

1. Reference M1.2

- a. In Diffuser & Grile Schedule, revise diffuser D Manufacturer & Model to Krueger 1450A-F23-24X24-00-00-44.
- b. In Rooftop Unit Schedule:
 - i Revise HVAC-10 supply air flow external static pressure to 1.4" WC.
 - ii Revise HVAC-11 supply air flow external static pressure to 1.8" WC.
 - iii Remove roof curb from rooftop unit HVAC-10,11 Remarks.

2. Reference M1.3

a. Add Unit Heater Piping Detail as per below:

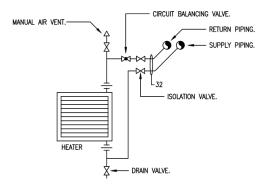

3. Reference 1/M2.1

- a. To suit relocation of compressed gas storage from outside 511 Design Technology, remove redundant gas piping from storage area, on exterior wall and in 511 Design Technology.
- b. In 813 Corridor, remove asbestos-containing firespray from gas piping to be removed.

4. Reference 1/M2.1 and 1/M3.1

- a. Revise 511A Storage as per attached sketch SK-M01.
- b. Revise 515A and 515B room names to 515A Storage and 515B Storage.

5. Reference 2/M2.1

a. In 517 Manufacturing/Machine, remove exhaust fan on north wall complete with louvre, controls, etc.

6. Reference 2/M2.1 and 2/M3.1

a. In 517 Manufacturing/Machine, relocate compressed air outlet on north wall approximately 12' (3.6m) to the west to suit installation of electrical panel.

7. Reference 1/M2.2

- a. In 534 Computer Lab, remove window air conditioner (and turn over to the Owner) on west wall complete with controls, etc.
- b. In 534 Computer Lab, remove pneumatic thermostat in southeast corner complete with pneumatic tubing (cap at main).

8. Reference 2/M2.2 and 2/M3.2

- a. Revise gas piping on roof as per attached sketches SK-M03 and SK-M04.
- b. In 517 Manufacturing/Machine, remove pneumatic controls for one fan coil (complete with one thermostat) and provide BAS controls.
- c. In 518 Automotive, remove pneumatic controls for two fan coils (complete with one thermostat) and one unit heater (complete with one thermostat) and provide BAS controls.

9. Reference M3.1

- a. Add the following to note 18, 'Provide heating water valving, etc. as per detail. Provide BAS controls'
- b. Add note 21 to read, 'Provide BAS controls for ex force flow heater complete with wall-mounted temperature sensor.'

10. Reference 1/M3.1

- a. Add note 20 at fan coil FC-5 outdoor air louvre to read, "Provide two side-by-side 44"x16" (1100mm x 400mm) louvres & adjust ductwork to suit. Coordinate with architectural & structural drawings as well as site conditions."
- b. In 513 Physics and 514 Computer Room, replace note 4 at relief caps with note 5.
- c. In 515 Construction/Wood, add UH-1 to FC-5 temperature / CO2 sensor.
- d. Add note 21 at force flow heater in Stair 908.

11. Reference 2/M3.1

- a. Revise weld booth exhaust air system in 517 Manufacturing/Machine as per attached sketch SK-M02.
- b. Add note 21 at force flow heater in Stair 909.

12. Reference 3/M3.1

a. For exhaust fans EF-13 and EF-16, provide BAS controls (status only) and adjust fan coil FC-5 outdoor air flow to suit.

13. Reference 2/M3.2


Replace note 3 at rooftop units HVAC-10,11 with note 28 to read, 'Install rooftop unit on structural framing above roof. Location to be confirmed on site & coordinated with Structural Engineer. Confirm all clearances with ex rooftop unit flue gas / outdoor air intakes (1.8m) & ex plumbing vents (3m) are satisfied. Provide exterior supply & return air ductwork between bottom of rooftop unit to roof penetrations (as per detail). Provide flexible ductwork connections inside building.'

Electrical


- 1. Reference 1/E2.1 & 1/E2.2.
 - a. Delete exhaust fan identified by SD6,8,10 within Manufacturing/Machine 517.
 - i Remove associated starter and controls.
 - ii Remove branch wiring back to source and make safe.
 - iii Update directory for panel LP-SD.
- 2. Reference 1/E3.1, E4.1 & SK-E01.
 - a. Revise lighting controls within Exterior Storage 511B.
 - i Delete provision of two three-way light switches.
 - ii Provide new wall mounted occupancy sensor type '\$0'.
 - b. To accommodate the newly created Electrical Room 511F:
 - i Rework existing ceiling mounted conduits to accommodate new wall installation. Wall by others. Seal all rated penetrations.
 - ii Relocate new distribution equipment. Coordinate installations with existing compressor and existing mechanical equipment.
 - iii Relocate horn/strobe to 511F.
 - iv Relocate two of the new type 'HA' luminaire in 511F.
 - v Relocate one of the new type 'HA' luminaire in 511A.
 - vi Provide one additional type 'HA' luminaire in 511A.
 - vii Delete provision of two three-way light switches.
 - viii Provide one wall mounted occupancy sensor type '\$O' in 511A.
 - ix Provide one light switch in 511F.
 - x Delete provision of one type 'EBA' emergency luminaire.
 - xi Provide one type 'EBB' emergency luminaire in 511F.
 - xii Relocate the one heat detector labeled 'RELD' to 511F.
 - xiii Provide one new heat detector in 511A.
 - xiv Provide the following for new exhaust fan EF-3 (120V-1PH, 1.6A). Coordinate with mechanical.
 - Provide 15A-1P breaker and branch wiring from TWB25.
 - Install new reverse acting thermostat for controls. Thermostat supplied by mechanical trade.
 - Provide electrical connections from TWB21 for two additional fire-smoke dampers between the wall of 511F & 813.
 - Provide a fire alarm relay for shutdown of EF-3.

- Provide one new ceiling mounted smoke detector in 511F & one new ceiling mounted smoke detector in 813. Smoke detectors shall be mounted within 1.5m of new fire-smoke dampers.
- Interlock new smoke detectors with smoke dampers. Refer to 6/E4.3 for fire smoke damper wiring schematic.
- Revise key plan note 'K1' to include an additional initiating zone: Exhaust Fan EF-3.
- 3. Reference 1/E2.1 & 1/E3.1.
 - a. Relabel DECORATING ROOM 515A to STORAGE ROOM 515A.
 - b. Relabel DECORATING ROOM 515B to STORAGE ROOM 515B.
- 4. Reference 1/E3.2, Wiring for Equipment Schedule, Panel 'TWB' Schedule, and Panel 'TWA' Schedule.
 - a. Revise EF-1 requirements as follows:
 - i 600V, 3PH, 3.9FLA.
 - ii Delete provision of new 15A-3P breaker and branch wiring from TWB15,13,17.
 - iii Provide 15A-3P breaker and branch wiring from TWA19,21,23 for EF-1.

End of Addendum

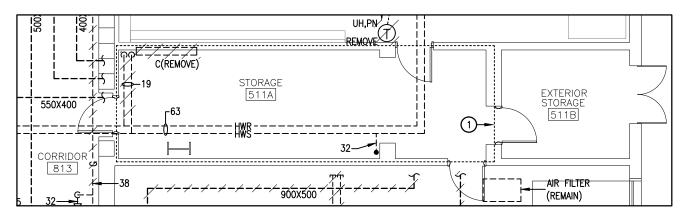

PARTIAL GROUND FLOOR DEMOLITION PLAN SCALE: 1:100

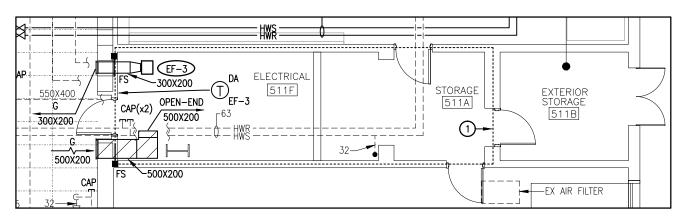

PARTIAL GROUND FLOOR RENOVATION PLAN SCALE: 1:100


EXHAUST FAN SCHEDULE							
SYMBOL	SYMBOL DESCRIPTION SUPPLIER & MODEL REMARKS						
EF-3	ELECTRICAL ROOM EXHAUST FAN 240 CFM (115 L/S) AT 0.3" WC (0.06 KPA) ESP	PENNBARRY ZEPHYR Z8H	120-1-60, 1.6 AMPS. PROVIDE PLUG TYPE DISCONNECT, THERMAL OVERLOAD PROTECTION, BACKDRAFT DAMPER, SPEED CONTROLLER, TYPE 'RA' DISCHARGE (CEILING MOUNTED) C/W CEILING GRILLE, WALL-MOUNTED 120V DIRECT ACTING THERMOSTAT, NEOPRENE ISOLATORS AT ALL SUPPORT POINTS.				





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PROJECT: WODSS FASHION STU	DIES & HVAC UPGRADES	03	
DRAWING: 511A STORAGE REVIS	IONS	02	
DWG NO: SK-M01	JOB NO: 24008	01	ADDENDUM 01
SCALE: AS NOTED	DRAWING BY: J.S.S.	REV#	REVISION
DATE: APRIL 2024	CHECKED BY: K.K.	CLIENT	: CORNERSTONE ARCHITECT INC.

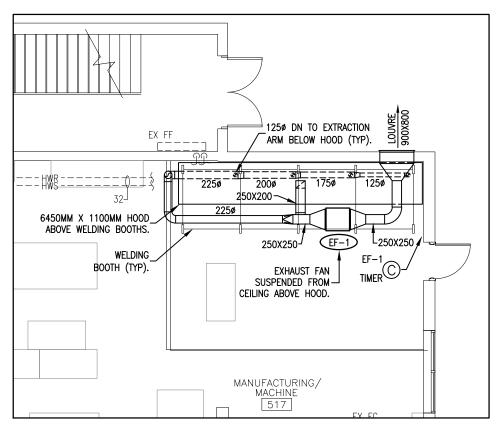

PARTIAL GROUND FLOOR RENOVATION PLAN SCALE: 1:100

EXHAUST	FAN	SCHEDULE


SYMBOL	DESCRIPTION	SUPPLIER & MODEL	REMARKS
EF-1	WELDING EXHAUST FAN 1500 CFM (710 L/S) AT 4.4" WC (1.09 KPA) ESP	COOK 165SQN-HP	575—3—60, FLA=3.9 AMPS, 3 HP. PROVIDE PREMIUM EFFICIENCY BELT—DRIVE MOTOR, THERMAL OVERLOAD PROTECTION, PERMANENTLY LUBRICATED BALL BEARING MOTOR, GRAVITY BACKDRAFT DAMPER, BELT GUARD, FLANGED INLET/OUTLET, SPEED CONTROLLER, NEOPRENE ISOLATORS AT ALL SUPPORT POINTS.





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PROJECT: WODSS FASHION STUI	DIES & HVAC UPG	GRADES	03	
DRAWING: 517 WELD BOOTH RE	VISIONS		02	
DWG NO: SK-M02	JOB NO: 24	4008	01	ADDENDUM 01
SCALE: AS NOTED	DRAWING BY: J.	S.S.	REV#	REVISION
DATE: APRIL 2024	CHECKED BY: K.	.K.	CLIENT	: CORNERSTONE ARCHITECT INC.

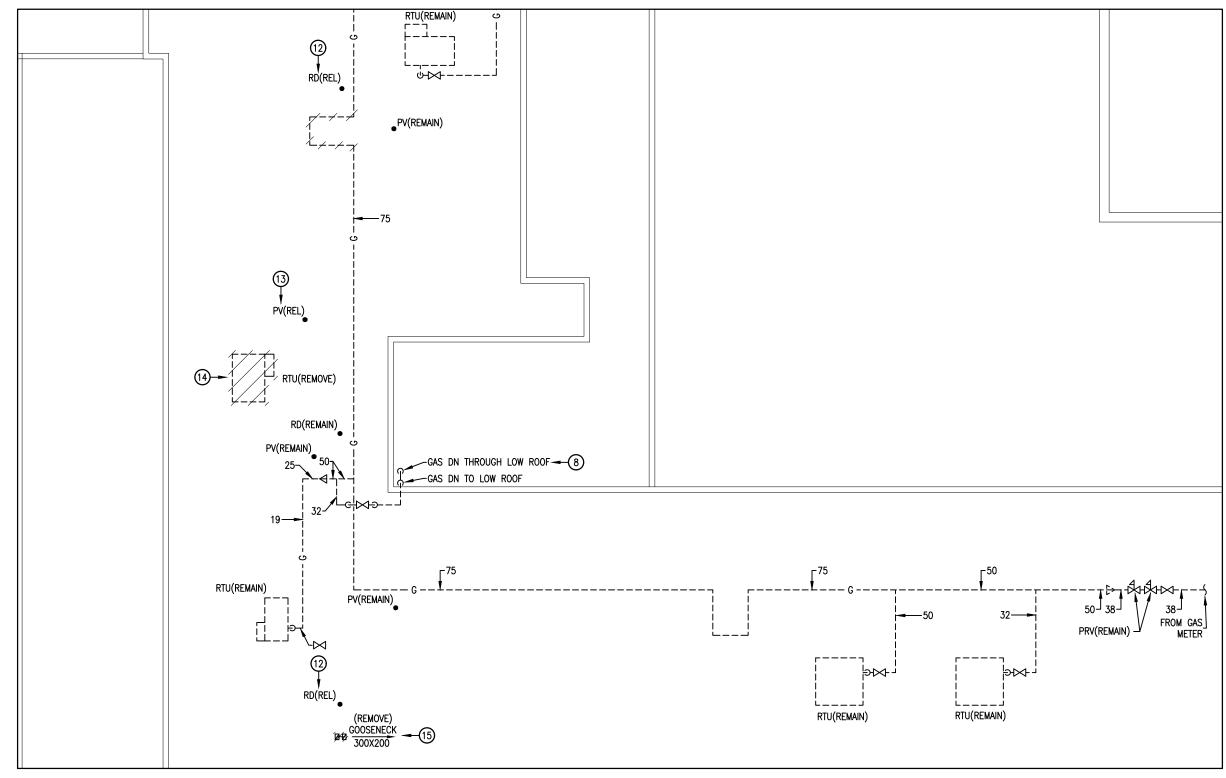


PARTIAL ROOF DEMOLITION PLAN SCALE: 1:200




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PROJECT:	WODSS FASHION STUD	IES & HVAC UP	03		
DRAWING:	GAS PIPING REVISIONS		02		
DWG NO:	SK-M03	JOB NO:	24008	01	ADDENDUM 01
SCALE:	AS NOTED	DRAWING BY:	J.S.S.	REV#	REVISION
DATE:	APRIL 2024	CHECKED BY:	K.K.	CLIENT:	CORNERSTONE ARCHITECT INC.

PROJECT NORTH

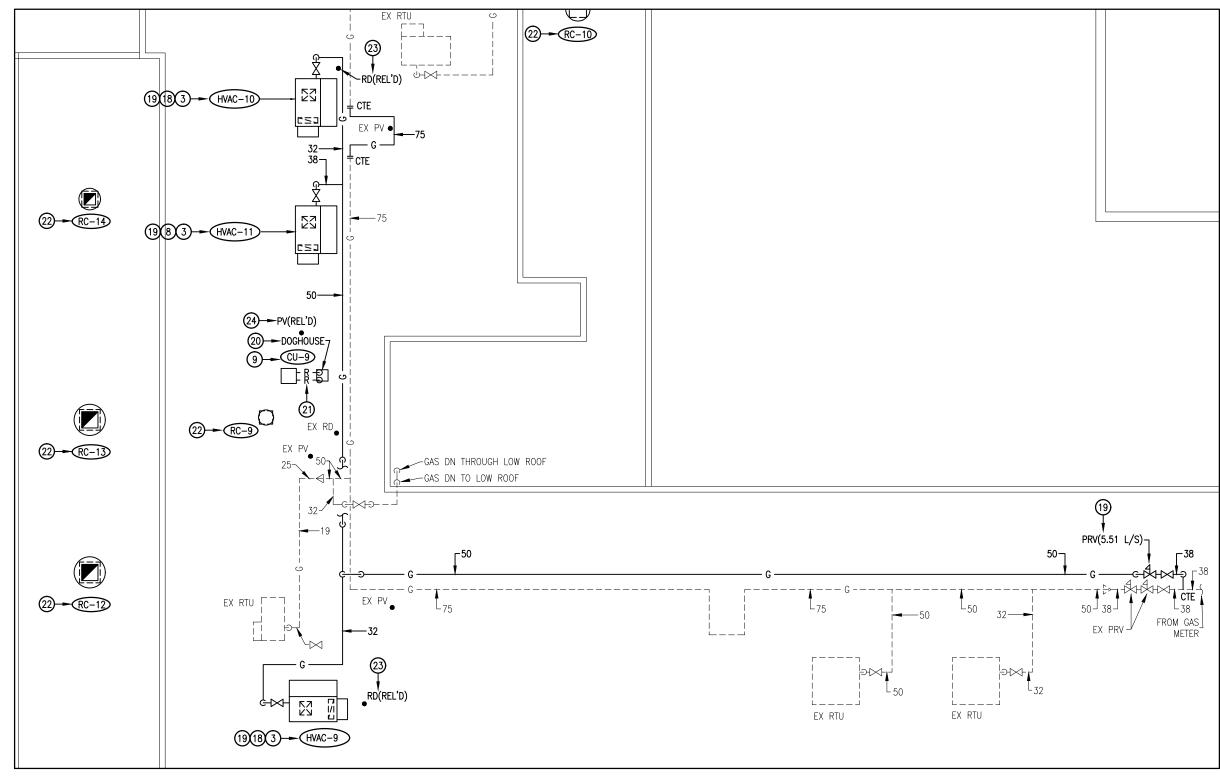


PARTIAL ROOF RENOVATION PLAN SCALE: 1:200

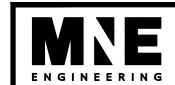

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PROJECT:	WODSS FASHION STUD	IES & HVAC UP	03		
DRAWING:	GAS PIPING REVISIONS		02		
DWG NO:	SK-M04	JOB NO:	24008	01	ADDENDUM 01
SCALE:	AS NOTED	DRAWING BY:	J.S.S.	REV#	REVISION
DATE:	APRIL 2024	CHECKED BY:	K.K.	CLIENT:	CORNERSTONE ARCHITECT INC.

PROJECT NORTH



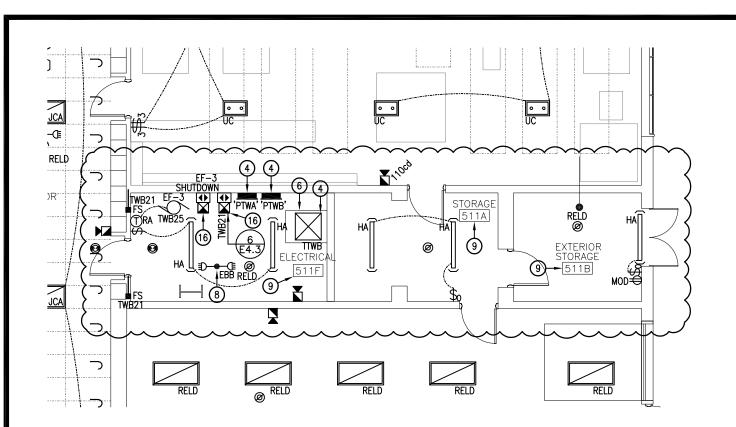

	PROJECT: WODSS FASHION STUI	03		
MNE Engineering Inc. 22 Kevco Place — Box A	DRAWING: REVISED ELECTRICAL	PLAN	02	
Kitchener, Ontario N2C 2G5	DWG NO: SK-E01	JOB NO: 24008	01	ADDENDUM 01
(519) 894-9408 www.mneengineering.ca	SCALE: N.T.S.	DRAWING BY: A.T.	REV#	REVISION
**************************************	DATE: APRIL 2024	CHECKED BY: C.W.	CLIENT	: CORNERSTONE ARCHITECT INC.