

2 FIRST FLOOR PLAN
A0.2 1:150

FIRM NAME: CGS CURRAN GACESA SLOTE ARCHITECTS INC.
118 JAMES ST. N., SUITE 301, HAMILTON, ONTARIO, L8R 2K7
TEL: (905) 297-0863 FAX: (905) 297-0864

NAME OF PROJECT:
Cladding Replacement to HDSB Frontenac Public School

LOCATION:
5135 Pinedale Ave, Hamilton, ON

ONTARIO BUILDING CODE DATA MATRIX – PART 11 – RENOVATION OF EXISTING BUILDING

11.1 EXISTING BUILDING CLASSIFICATION	DESCRIBE EXISTING USE: ELEMENTARY SCHOOL CONSTRUCTION INDEX: - HAZARD INDEX: - ■ NOT APPLICABLE (NO CHANGE OF MAJOR OCCUPANCY)	11.2.1 11.2.1.1A 11.2.1.1J
11.2 ALTERATION TO EXISTING BUILDING IS:	BASIC RENOVATION ■ EXTENSIVE RENOVATION □	11.3.3.1 11.3.3.2
11.3 REDUCTION IN PERFORMANCE LEVEL	STRUCTURAL: □ YES ■ NO BY INCREASE IN OCCUPANT LOAD: □ YES ■ NO BY CHANGE IN MAJOR OCCUPANCY: □ YES ■ NO PLUMBING: □ YES ■ NO SEWERAGE - SYSTEM: □ YES ■ NO	11.4.2 11.4.2.1 11.4.2.2 11.4.2.3 11.4.2.4 11.4.2.5
11.4 COMPENSATING CONSTRUCTION	STRUCTURAL: ■ NO □ YES (EXPLAIN) INCREASE IN OCCUPANT LOAD: ■ NO □ YES (EXPLAIN) CHANGE OF MAJOR OCCUPANCY: ■ NO □ YES (EXPLAIN) PLUMBING: ■ NO □ YES (EXPLAIN) SEWERAGE - SYSTEM: ■ NO □ YES (EXPLAIN)	11.4.3 11.4.3.2 11.4.3.3 11.4.3.4 11.4.3.5 11.4.3.6
11.5 COMPLIANCE ALTERNATIVES PROPOSED	■ NO □ YES (GIVE NUMBERS)	11.5.1
11.6 ALTERNATIVE MEASURES PROPOSED	■ NO □ YES (EXPLAIN)	11.5.2

ONTARIO BUILDING CODE DATA MATRIX – PART 3, RELEVANT ITEMS

Item	Ontario's 2012 Building Code Data Matrix Part 3 or 9	OBC Reference																																																																																																																																				
1	Building Area (m ²) Existing: 6,178.4 sm New: 0 sqft Total: 6,178.4 sm Area of Work:	1.4.1.2. [A] 1.4.1.2. [A]																																																																																																																																				
2	Number of Storeys Above grade 2 Below grade	1.4.1.2. [A] & 3.2.1.1 1.4.1.2. [A] & 9.10.4																																																																																																																																				
3	Number of Streets/Fire Fighter Access 2	3.2.2.10 & 3.2.5. 9.10.20																																																																																																																																				
4	Sprinkler System Proposed <input type="checkbox"/> entire building <input type="checkbox"/> selected compartments <input type="checkbox"/> selected floor areas <input type="checkbox"/> basement <input type="checkbox"/> in lieu of roof rating <input checked="" type="checkbox"/> not required (none existing)	3.2.2.20-83 3.2.1.5, 3.2.2.17, INDEX 9.10.8. 2.																																																																																																																																				
5	Standpipe required <input type="checkbox"/> Yes <input checked="" type="checkbox"/> No	3.2.9. N/A																																																																																																																																				
6	Fire Alarm required <input type="checkbox"/> Yes <input checked="" type="checkbox"/> No	3.2.4. 9.10. 18.																																																																																																																																				
7	Water Service/Supply is Adequate <input type="checkbox"/> Yes <input checked="" type="checkbox"/> No	3.2.5.7. N/A																																																																																																																																				
8	High Building <input type="checkbox"/> Yes <input checked="" type="checkbox"/> No	3.2.6. N/A																																																																																																																																				
9	Barrier - Free Design <input checked="" type="checkbox"/> Yes <input type="checkbox"/> No (Explain) N/A	3.8 6.5.2																																																																																																																																				
10	Hazardous Substances <input type="checkbox"/> Yes <input checked="" type="checkbox"/> No	3.3.1.2 & 3.3.1.19 9.10.1.5. (4)																																																																																																																																				
11	Required Fire Resistance Rating (FRR) Horizontal Assemblies FRR (Hours) Exist. Corridor N/A Exist. Tech. Room N/A Roof N/A	Listed Design No. or Description (SB-3) ULC U905 ULC U905 3.2.2.20-83 & 3.2.1.4 9.10.8. 9.10.9.																																																																																																																																				
12	Travel Distance:	actual: see plan 3.4.2.4																																																																																																																																				
19	Spatial Separation [3.1.4.8.(1) requires noncomb. cladding]	3.2.3.1.D & E 9.10.14.																																																																																																																																				
	<table border="1"> <thead> <tr> <th></th> <th>Wall</th> <th>Area of EBF (m²)</th> <th>L.D. (m)</th> <th>L/H or H/L</th> <th>Permitted Max. % of Openings</th> <th>Proposed % of Openings</th> <th>FRR (Hours)</th> <th>Listed Design or Description</th> <th>Comb Const.</th> <th>Comb. Constr. Nonc. Cladding</th> <th>Non-comb. Constr.</th> </tr> </thead> <tbody> <tr> <td>North</td> <td></td> <td>202.4</td> <td>56</td> <td>EXIST.</td> <td>100%</td> <td><100%</td> <td>EXIST.</td> <td>EXIST.</td> <td>EXIST.</td> <td>EXIST.</td> <td>EXIST.</td> </tr> <tr> <td>South</td> <td></td> <td>204.7</td> <td>77</td> <td>EXIST.</td> <td>100%</td> <td><100%</td> <td>EXIST.</td> <td>EXIST.</td> <td>EXIST.</td> <td>EXIST.</td> <td>EXIST.</td> </tr> <tr> <td>East</td> <td></td> <td>705.8</td> <td>402</td> <td>EXIST.</td> <td>100%</td> <td><100%</td> <td>EXIST.</td> <td>EXIST.</td> <td>EXIST.</td> <td>EXIST.</td> <td>EXIST.</td> </tr> <tr> <td>West</td> <td></td> <td>693.9</td> <td>47</td> <td>EXIST.</td> <td>100%</td> <td><100%</td> <td>EXIST.</td> <td>EXIST.</td> <td>EXIST.</td> <td>EXIST.</td> <td>EXIST.</td> </tr> <tr> <td>North Admin</td> <td></td> <td>172.5</td> <td>95</td> <td>EXIST.</td> <td>100%</td> <td><100%</td> <td>EXIST.</td> <td>EXIST.</td> <td>EXIST.</td> <td>EXIST.</td> <td>EXIST.</td> </tr> <tr> <td>South Admin</td> <td></td> <td>112.75</td> <td>45</td> <td>EXIST.</td> <td>100%</td> <td><100%</td> <td>EXIST.</td> <td>EXIST.</td> <td>EXIST.</td> <td>EXIST.</td> <td>EXIST.</td> </tr> <tr> <td>West Admin</td> <td></td> <td>91.5</td> <td>22.8</td> <td>EXIST.</td> <td>100%</td> <td><100%</td> <td>EXIST.</td> <td>EXIST.</td> <td>EXIST.</td> <td>EXIST.</td> <td>EXIST.</td> </tr> <tr> <td>North Gym</td> <td></td> <td>112.7</td> <td>91</td> <td>EXIST.</td> <td>100%</td> <td><100%</td> <td>EXIST.</td> <td>EXIST.</td> <td>EXIST.</td> <td>EXIST.</td> <td>EXIST.</td> </tr> <tr> <td>South Gym</td> <td></td> <td>154.4</td> <td>138</td> <td>EXIST.</td> <td>100%</td> <td><100%</td> <td>EXIST.</td> <td>EXIST.</td> <td>EXIST.</td> <td>EXIST.</td> <td>EXIST.</td> </tr> <tr> <td>East Gym</td> <td></td> <td>215.4</td> <td>362</td> <td>EXIST.</td> <td>100%</td> <td><100%</td> <td>EXIST.</td> <td>EXIST.</td> <td>EXIST.</td> <td>EXIST.</td> <td>EXIST.</td> </tr> </tbody> </table>		Wall	Area of EBF (m ²)	L.D. (m)	L/H or H/L	Permitted Max. % of Openings	Proposed % of Openings	FRR (Hours)	Listed Design or Description	Comb Const.	Comb. Constr. Nonc. Cladding	Non-comb. Constr.	North		202.4	56	EXIST.	100%	<100%	EXIST.	EXIST.	EXIST.	EXIST.	EXIST.	South		204.7	77	EXIST.	100%	<100%	EXIST.	EXIST.	EXIST.	EXIST.	EXIST.	East		705.8	402	EXIST.	100%	<100%	EXIST.	EXIST.	EXIST.	EXIST.	EXIST.	West		693.9	47	EXIST.	100%	<100%	EXIST.	EXIST.	EXIST.	EXIST.	EXIST.	North Admin		172.5	95	EXIST.	100%	<100%	EXIST.	EXIST.	EXIST.	EXIST.	EXIST.	South Admin		112.75	45	EXIST.	100%	<100%	EXIST.	EXIST.	EXIST.	EXIST.	EXIST.	West Admin		91.5	22.8	EXIST.	100%	<100%	EXIST.	EXIST.	EXIST.	EXIST.	EXIST.	North Gym		112.7	91	EXIST.	100%	<100%	EXIST.	EXIST.	EXIST.	EXIST.	EXIST.	South Gym		154.4	138	EXIST.	100%	<100%	EXIST.	EXIST.	EXIST.	EXIST.	EXIST.	East Gym		215.4	362	EXIST.	100%	<100%	EXIST.	EXIST.	EXIST.	EXIST.	EXIST.	
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1 OBC MATRIX
A0.2

PLAN LEGEND

- EXISTING
- DEMOLITION
- NEW CONSTRUCTION
- EXISTING DOOR TO REMAIN
- NEW DOOR

CURRAN | GACESA | SLOTE
ARCHITECTS

CGS

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NOTE: DRAWINGS ARE NOT TO BE SCALED.

No.	Date	Remarks
04	2024.02.20	Issued for Tender
03	2023.06.21	Issued for Tender
02	2023.04.17	Issued for BLDG Permit
01	2023.02.28	Issued for Review

Cladding Replacement at
HDSB Frontenac Public School
5140 Pinedale Ave,
Burlington, ON

Dwg. Title:
OBC Matrix & Floor Plan

Drwn: Chkd:
Proj. No.: 23001
Scale: As noted
Date: 06/21/23

Drawing No.:
A0.2

Material Specifications:

Galvanized Furring Channel subgrits:

16-gauge hat-bar galvanized steel subgrits to CAN/CSA-S136. Contractor to arrange for pull-out testing on existing masonry to determine final spacing of subgrits and fastener layout. Include subgrit and fastener layout as part of prefinished metal cladding stamped engineered submittal drawings.

HM Doors & Frames:

Exterior Hollow Metal Frames:

Sheet steel, 1.60 mm nominal coated thickness, with paintable galvanneal finish; two-piece construction with continuous thermal break; sizes and configurations as indicated on Drawings; eg. Therna-Series Frame by Fleming Door Products Ltd.

Exterior Hollow Metal Doors: 45 mm thick, constructed as follows:

Door Faces: Sheet steel panels, 1.30 mm nominal coated thickness, flush design, paintable galvanneal finish.

Vertical Steel Stiffeners: Sheet steel profiles, 0.76 mm nominal coated thickness, 22 mm deep, interlocking design, regular galvanneal finish.

Door Edges: Mechanically interlocked.

Glazing Stops: Rolled steel channel shape, butted corners; prepared for countersunk tamper-proof screws.

Door Core: Foamed-in-place insulation.

Manufacturer and Product Name: eg. Trio-E by Fleming Door Products Ltd.

Joint Sealants:

General Purpose, Acoustical Sealant: To CAN/CGSB-19.17-M; one-part, siliconized acrylic latex, mildew-resistant, accommodating joint movement of plus or minus 12-1/2 percent, colours as selected by Consultant; Tremflex 834 by Tremco or similar by Dow, General Electric or Master Builders Solutions Canada, Inc.

Mildew-Resistant Sealant: To ASTM C920, Type S, Grade NS, Class 25, Use NT, G, A, and O; one-part, acetoxy silicone sealant, complete with integral fungicide; colours as selected by Consultant; Tremsil 200 by Tremco or similar by Dow, General Electric or Master Builders Solutions Canada, Inc.

Install joint sealants to ASTM C1193.

Install acoustical sealants to ASTM C919.

Inspect completed sealant joints for adhesion and cohesion to ASTM C1521.

Exterior Weatherseal Sealant: To ASTM C920, Type S, Grade NS, Class 35, Use NT, M, A and O; one-part, moisture curing, low modulus polyurethane sealant; accommodating joint movement of plus or minus 35 percent, with a 30- to 90-minute skin time; eg. Dymonic FC by Tremco.

Colour: To be selected from full standard range by consultants.

Acceptable manufacturers: Tremco, GE, Dow, or 3M.

Glazing Sealant: To CAN/CGSB-19.13-M, Type MG-2-25-A-L; one-part, moisture curing, acetoxy silicone sealant; eg. Proglaze by Tremco, Clear colour.

Colour: To be selected from full standard range by consultants.

Acceptable manufacturers: Tremco, GE, Dow, or 3M.

Glazing Sealant: To CAN/CGSB-19.13-M, Type MG-2-25-A-L; one-part, moisture curing, acetoxy silicone sealant; eg. Proglaze by Tremco, Clear colour.

Light Fixtures

Architect to approve outdoor light fixtures.

Exterior Downlight:

Round canopy general purpose fixture. Surface mounted. RCL15-LED70A45 colour selectable fixture and lumen adjustable unit by RAB Design Lighting Inc.

Exterior Wall mounted:

Wall light with adjustable head to direct light. AWLS-LED 120A100 colour selectable fixture and lumen adjustable unit by RAB Design Lighting Inc.

Paint:

Conform to MPI Architectural Painting Specification Manual, using only Products from the following manufacturers as listed in MPI Approved Products List for each scheduled paint system. Provide primers and undercoats produced by same manufacturer as finish coats.

1. Manufacturers: Benjamin Moore & Co. Ltd., ICI (Dulux) Paints, MF Paints Inc. (Innovation Plus), Para Paints Canada Inc., PPG Canada Inc. (Pittsburgh Paints), Pratt & Lambert Co., Sherwin-Williams Canada, and Sico Coatings, Inc.

Conform to MPI Maintenance Repainting Manual for refinishing existing previously finished surfaces.

Paint System Schedule

1. Concrete - Opaque Painted Finish: INT. 3.1M - Institutional low odor/voc, Premium Grade; Gloss Level G5 - Semi-Gloss.

2. Concrete Masonry Units - Opaque Painted Finish: INT. 4.2E - Institutional low odor/voc (over latex block filler), Premium Grade; Gloss Level G5 - Semi-Gloss. Provide block filler primer on all new concrete block masonry before applying paint finish.

3. Brick - Opaque Painted Finish: INT. 4.1M - Institutional low odor/voc (over w.b. primer), Premium Grade; Gloss Level G5 - Semi-Gloss.

4. Gypsum Board Walls - Opaque Painted Finish: INT. 9.2M - Institutional low odor/voc (over latex primer/sealer), Premium Grade; Gloss Level G4 - Satin.

5. Gypsum Board Ceilings - Opaque Painted Finish: INT. 9.2M - Institutional low odor/voc (over latex primer/sealer), Premium Grade; Gloss Level G1 - Flat.

6. Galvanized and Galvannealed Metal - INT. 5.3N - Institutional low odor/voc (over w.b. galvanized primer), Premium Grade; Gloss Level G5.

Colours: Up to 4 colours as selected by Consultant.

Prefinished Metal Cladding

Prefinished metal wall cladding with concealed fasteners. Any exposed fasteners to be colour matched. Architect to select cladding colour and pattern. Provide stamped engineered submittal drawings for review by Architect and by City of Burlington plans examiner.

Contractor to be bound by manufacturer's warranty (2 year panel warranty, minimum 30 year finish warranty).

Cladding Panel Option 'A' (Aluminum):

Siding: Rigid extruded aluminum board. Horizontal. Aluminum grade 6065-T5, 1.8mm thickness, 150mm wide; with CLOSED JOINT smooth plank profile and hidden fasteners.

Aluplank, Longboard or approved equivalent.

Soffit: Rigid extruded board. Aluminum grade 6065-T5, 1.8mm thickness, 150mm wide; with V-JOINT / V-GROOVE profile and hidden fasteners.

Cladding Panel Option 'B' (Steel):

Siding: Prefinished steel cladding with hidden fasteners cladding system. Horizontal. 20 gauge thickness. 38mm profile depth. 300mm wide flat panel.

Vicwest AD300, Agway or approved equivalent.

Soffit: Prefinished steel cladding with hidden fasteners cladding system. Horizontal. 20 gauge thickness. 38mm profile depth. 300mm V-GROOVE panel.

Vicwest AD 300R, Agway or approved equivalent.

Prefinished Metal Flashing

0.61 mm (24 gauge minimum thickness) prefinished metal flashing.

Colour to match adjacent material.

Prefinished Metal Roofing

Prefinished standing seam metal roofing. Agway AR-50. 18.5" wide panel Profile. 24-gauge thickness. Provide zinc-plated fasteners as required. Perspectra plus Series finish. Architect to choose colour. Provide stamped engineered submittal drawings for review by Architect.

Caulking: Mulco supra expert sealant or equal (colour to match adjacent sheet). 'Tremco' JS-773 butyl elastomer caulking / 'Tremco' 440 butyl tape (3mm thick and 13mm wide).

Touch-up: Remove Burrs and filings from field cut sheets. Touch-up marred areas with air dry paint.

Subgrits: 18-gauge. Z275 galvanized steel Finish.

Flashing: Exterior flashing. 22-gauge thickness. Pre-painted steel finish. Colour to match adjacent sheet.

Self-Adhered Wall Air Barrier:


Vapour permeable, self-adhered sheet air barrier membrane with manufacturer's recommended primer. Henry Blueskin VP160, Delta-Vent SA, SRP AirOutshield SA280, Vaproshield WrapShield SA, or approved equivalent.

Spray foam insulation


Closed cell, sprayed polyurethane foam insulation, tested in accordance with CAN/ULC S705.1-01 and CAN/ULC S770-15 with minimum core density of 28.34 kg/m³ (1.77 lb/ft³). Max. water vapour permeance to 60 ng/Pa.m²s (1 perm).

Wall Flashing


Flash all window, door, screen, louver, mechanical or electrical penetrations or openings in exterior walls to adjacent sheathing with Henry AirBloc LF Liquid Applied Window and Door Flashing membrane. Extend flashing minimum 8" onto wall face at all opening and penetrations.

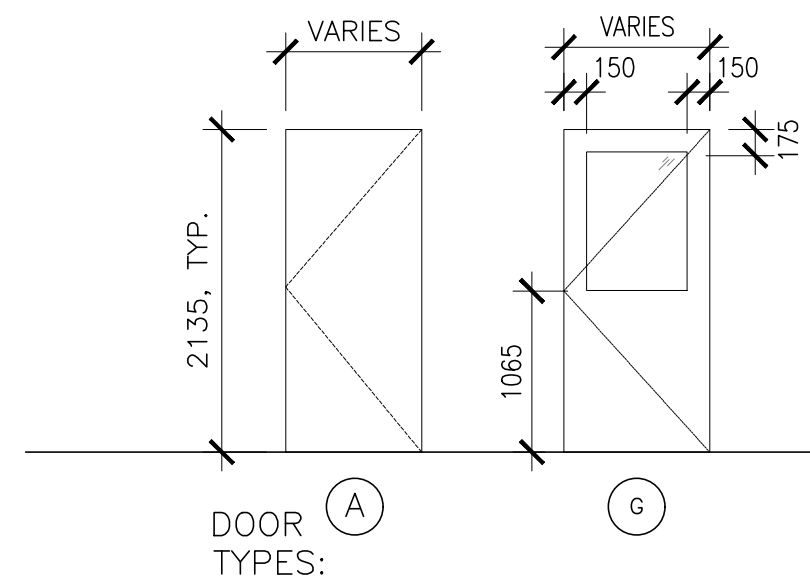

4 DOOR TYPES
A0.3 1:50

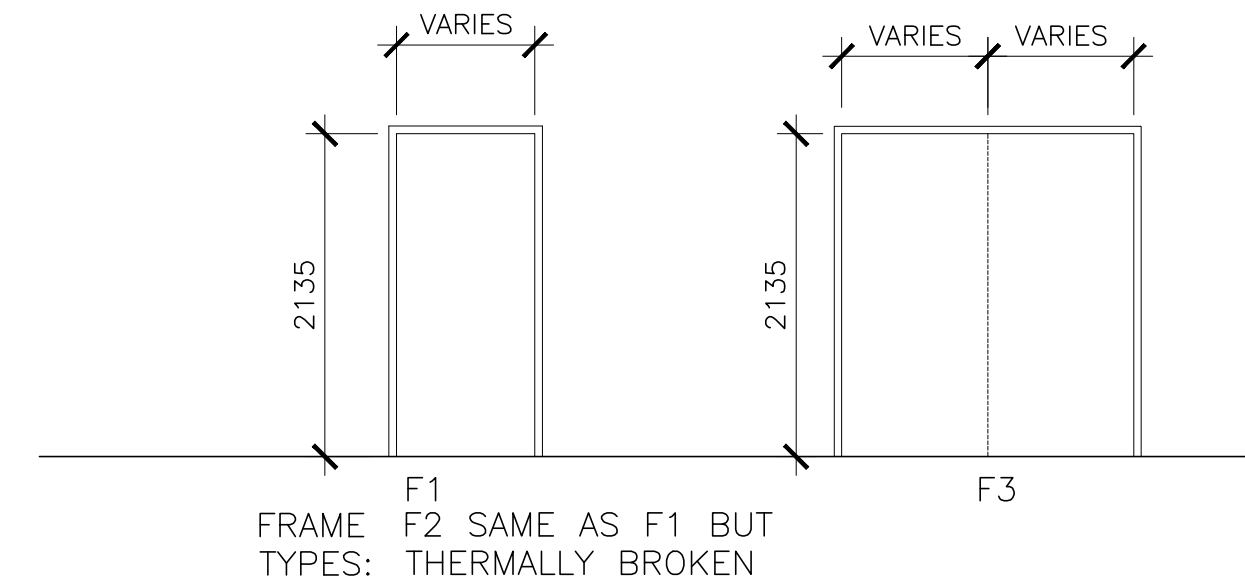

3 FRAME TYPES
A0.3 1:50

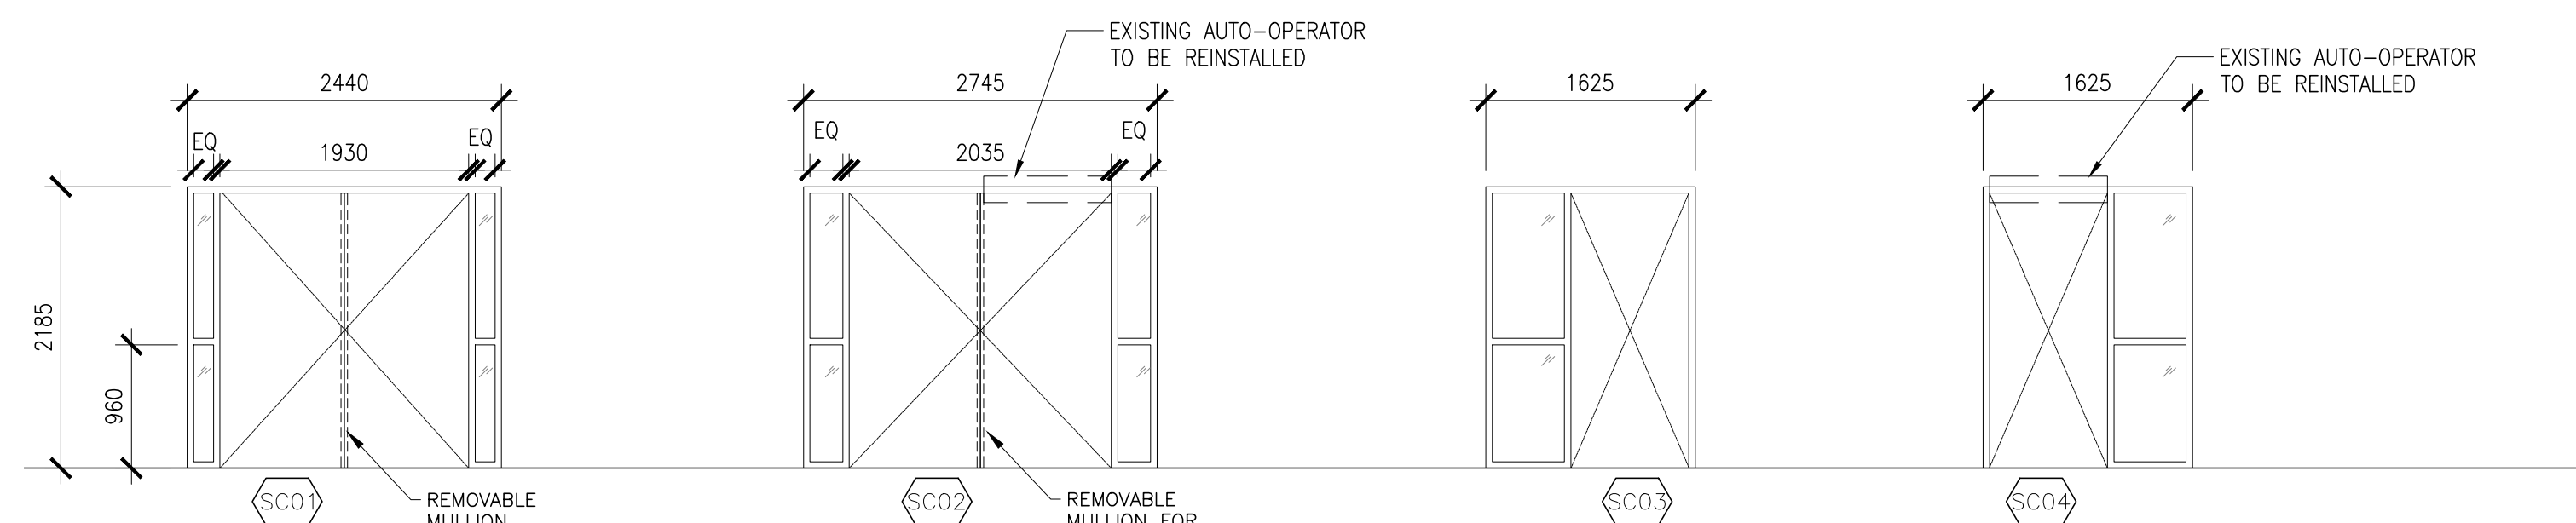

2 SCREEN TYPES
A0.3 1:50

ROOM NAME	DOOR NUMBER	SIZE	TYPE	MAT'L	FINISH	GLASS	FRAME TYPE	MAT'L	FINISH	GLASS	FIRE RATING	REMARKS
STAIR A	D02	2-965 X 2135 X 45	G	HM	PT	G2	SC01	HM	PT	G2	-	EXTERIOR THERMALLY BROKEN FRAME & DOOR. PANIC BAR
GYM HALLWAY	D15a	915 X 2135 X 45	G	HM	PT	G2	F2	HM	PT	-	-	EXTERIOR THERMALLY BROKEN FRAME & DOOR. PANIC BAR
GYM HALLWAY	D15b	915 X 2135 X 45	G	HM	PT	G2	F2	HM	PT	-	-	EXTERIOR THERMALLY BROKEN FRAME & DOOR. PANIC BAR
GYM HALLWAY	D15c	915 X 2135 X 45	G	HM	PT	G2	F2	HM	PT	-	-	EXTERIOR THERMALLY BROKEN FRAME & DOOR. PANIC BAR
STAIR B	D17	2-1016 X 2135 X 45	G	HM	PT	G2	SC02	HM	PT	G2	-	EXTERIOR THERMALLY BROKEN FRAME & DOOR. PANIC BAR. EXISTING AUTO-OPERATOR
STAIR B	D17a	2-1016 X 2135 X 45	G	HM	PT	G1	SC02	HM	PT	G2	-	INTERIOR. EXISTING AUTO-OPERATOR
MECH. ROOM	D18	2-965 X 2135 X 45	A	HM	PT	-	F3	HM	PT	-	-	EXTERIOR THERMALLY BROKEN FRAME & DOOR. PANIC BAR. LOCK LATCH
MAIN ENTRANCE HALLWAY	D19	965 X 2135 X 45	G	HM	PT	G2	SC03	HM	PT	G2	-	EXTERIOR THERMALLY BROKEN FRAME & DOOR. PANIC BAR
MAIN ENTRANCE HALLWAY	D20	965 X 2135 X 45	G	HM	PT	G2	SC04	HM	PT	G2	-	EXTERIOR THERMALLY BROKEN FRAME & DOOR. PANIC BAR. EXISTING AUTO-OPERATOR
KINDERGARTEN CLASSROOM	D23	965 X 2135 X 45	G	HM	PT	G2	SC03	HM	PT	G2	-	EXTERIOR THERMALLY BROKEN FRAME & DOOR. PANIC BAR
KINDERGARTEN CLASSROOM	D24	965 X 2135 X 45	G	HM	PT	G2	SC03	HM	PT	G2	-	EXTERIOR THERMALLY BROKEN FRAME & DOOR. PANIC BAR

LEGEND: ALUM - ALUMINUM SCWD - SOLID CORE WOOD DOOR HC - HOLLOW CORE WOOD PT - PAINTED MDf - MEDIUM DENSITY FIBREBOARD EXTERIOR = INSUL. & THERMALLY BROKEN HM - HOLLOW METAL PREFIN - PREFINISHED T RISE = TEMPERATURE RISE RATING C1 - 6mm LAMINATED GLASS KDHM - KNOCKDOWN HOLLOW METAL G2 - DUAL INSULATING GLASS G3 - WIRED GLASS

1 DOOR SCHEDULE
A0.3

CURRAN | GACEA | SLOTE ARCHITECTS
CGS
118 JAMES ST. NORTH, SUITE 301, HAMILTON, ONTARIO L8R 9R3

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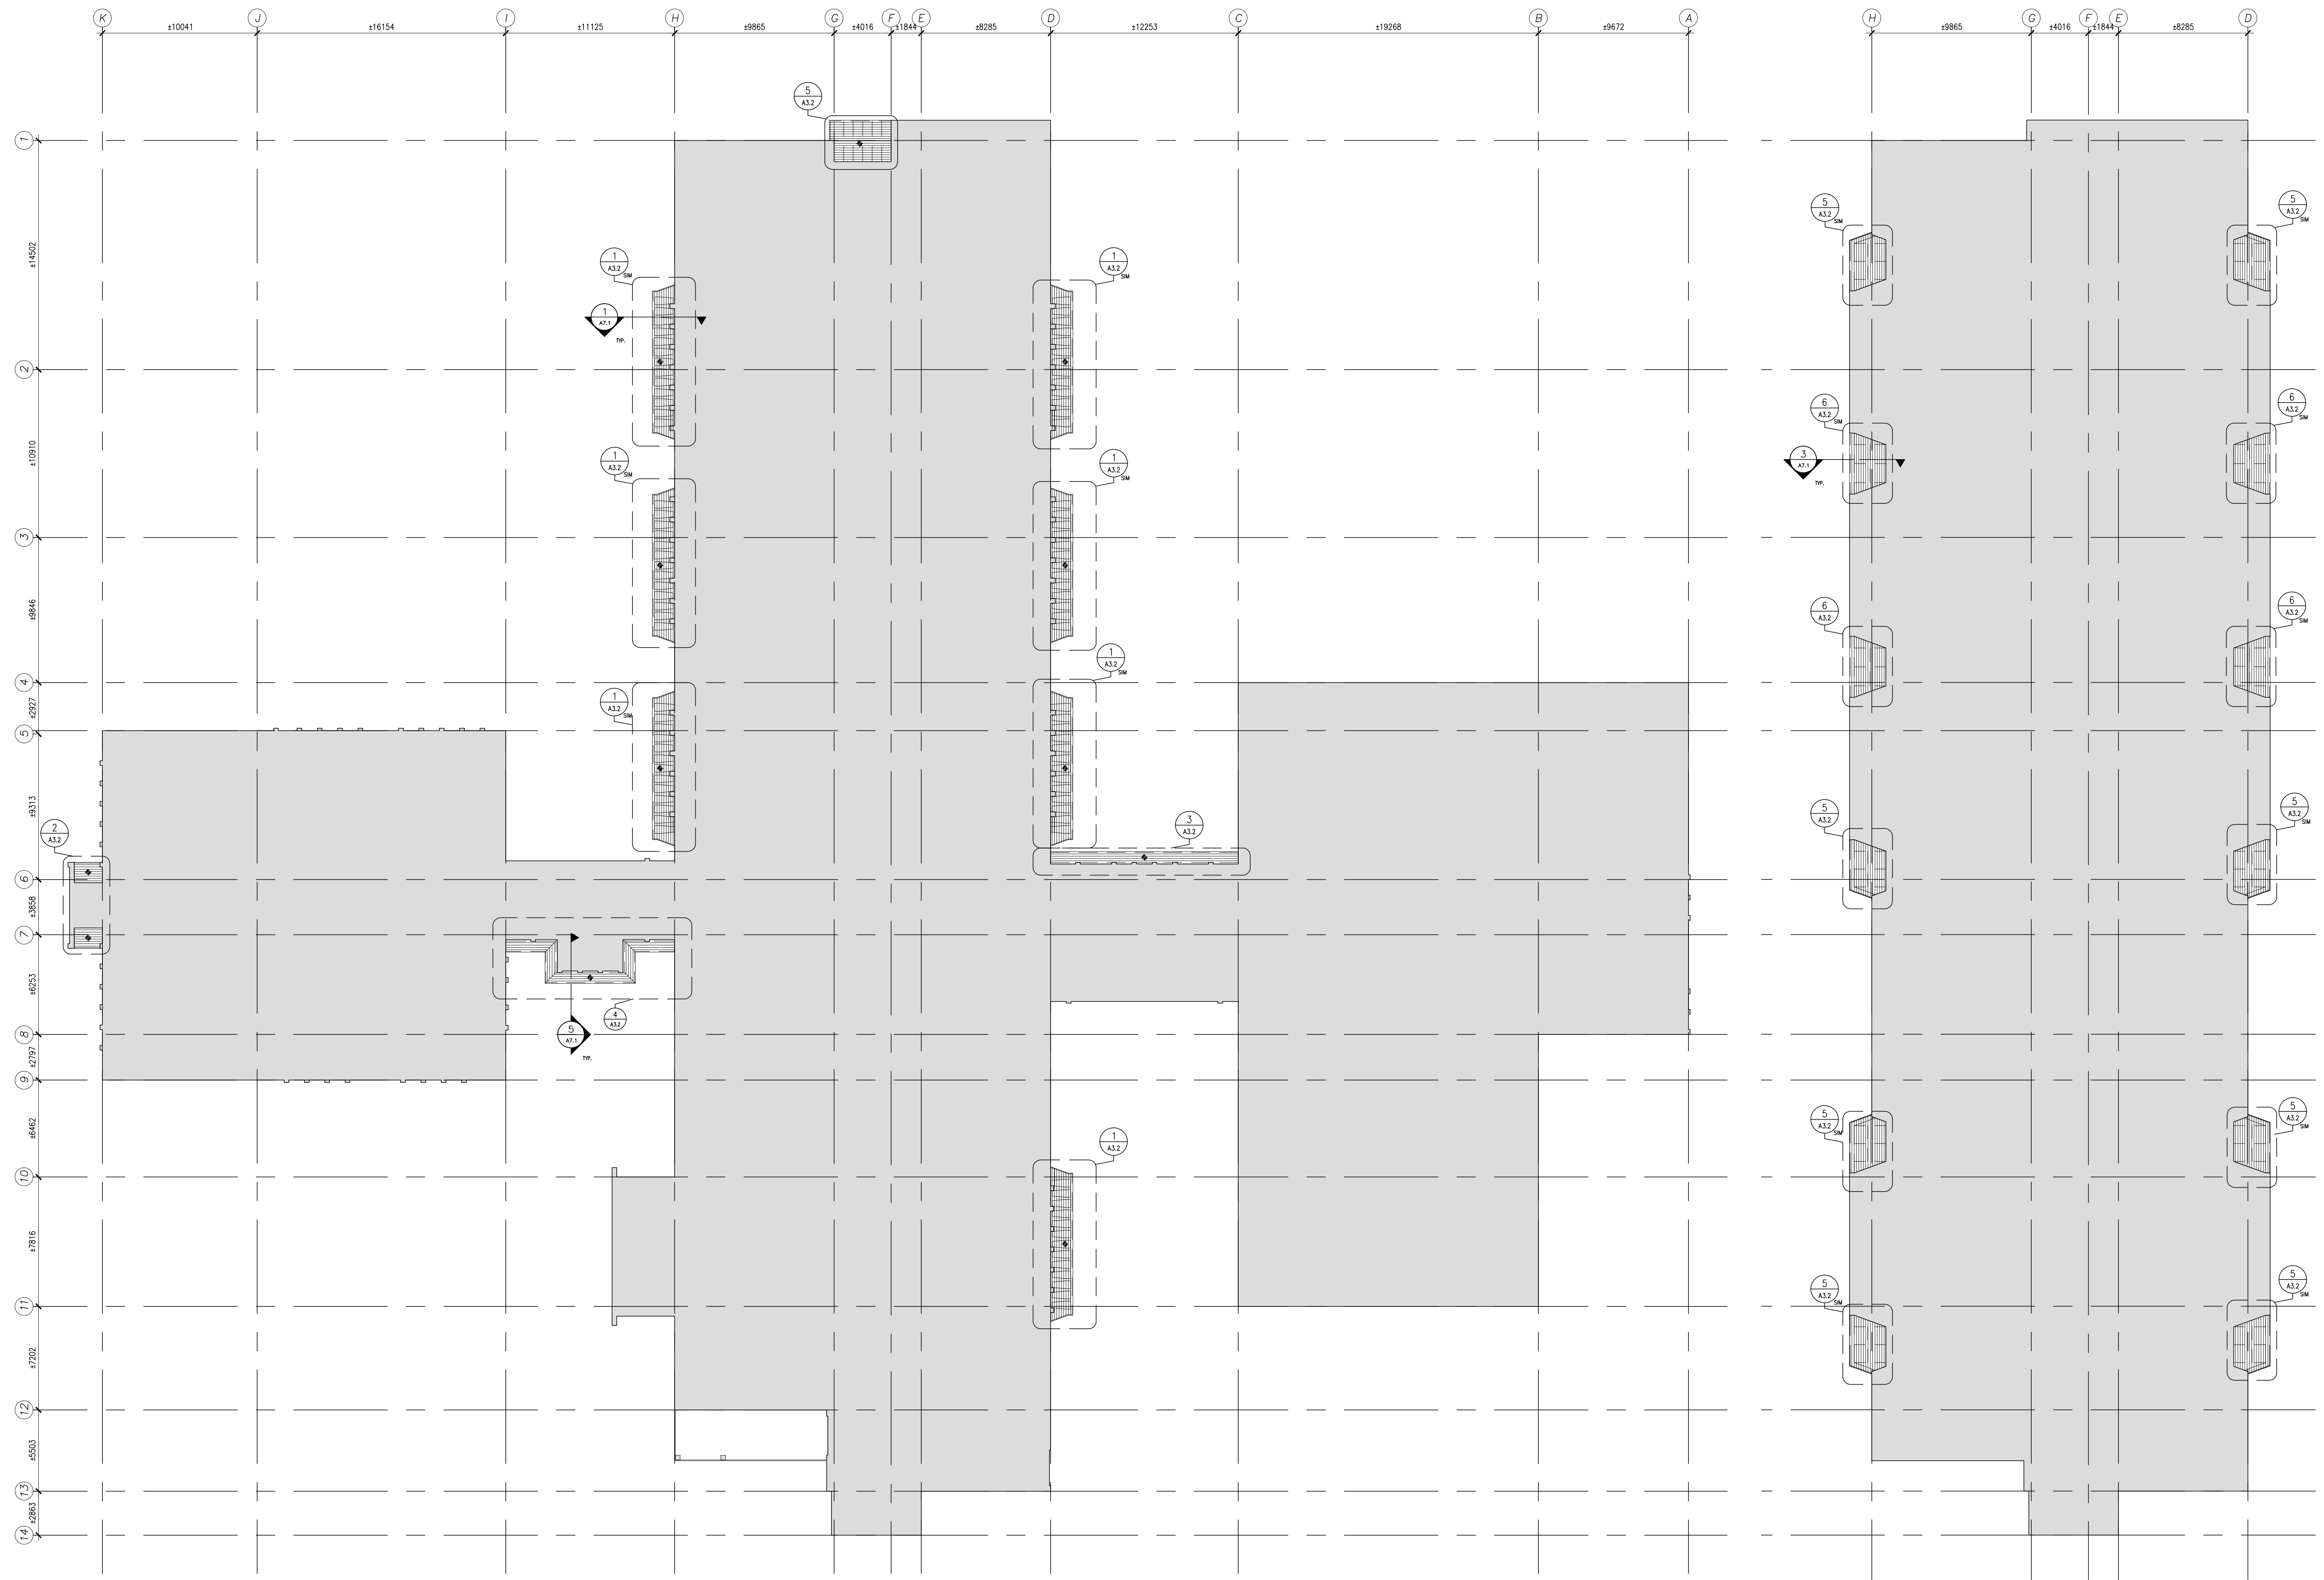
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Cladding Replacement at
HDSB Frontenac
Public School
5140 Pinedale Ave,
Burlington, ON

Dwg. Title:
Door and
Screen
Schedule

Drawn: Chkd:
Proj. No.: 23001
Scale: As noted
Date: 06/21/23

Drawing No.:
A0.3



2 FIRST FLOOR REFLECTED CEILING PLAN
A3.1 1:150

1 SECOND FLOOR REFLECTED CEILING PLAN
A3.1 1:150

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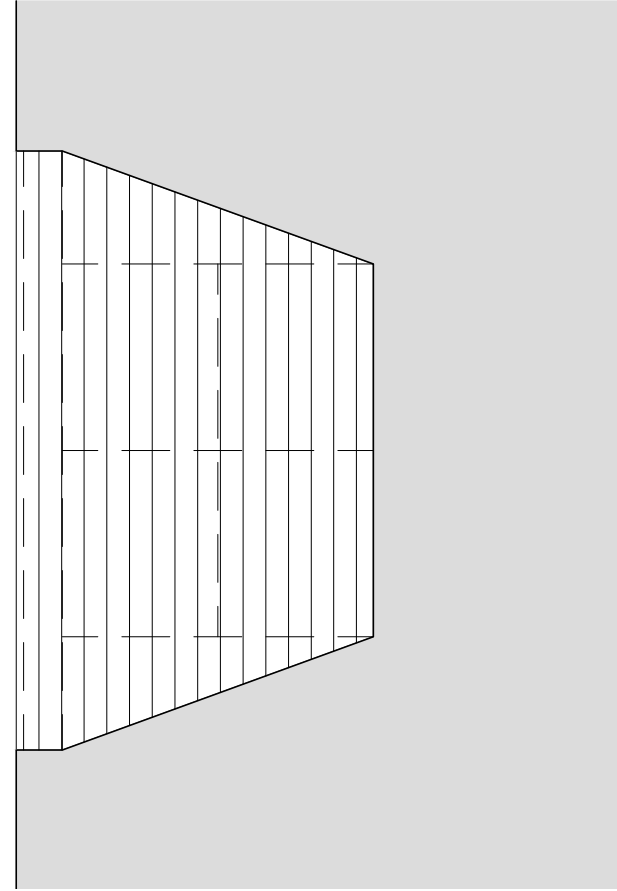
No.	Date	Remarks
04	2024.02.20	Issued for Tender
03	2023.06.21	Issued for Tender
02	2023.04.17	Issued for BLDG Permit
01	2023.02.28	Issued for Review

**Cladding Replacement at
 HDSB Frontenac
 Public School**
 5140 Pinedale Ave,
 Burlington, ON


Dwg. Title:
**Exterior Soffit
 Key Plans**

Drwn: Chkd:
 Proj. No.: 23001
 Scale: As noted
 Date: 06/21/23


Drawing No.:
A3.1




7 TYP. SECOND FLOOR SOFFIT REFLECTED CEILING PLAN
A3.2 1:50

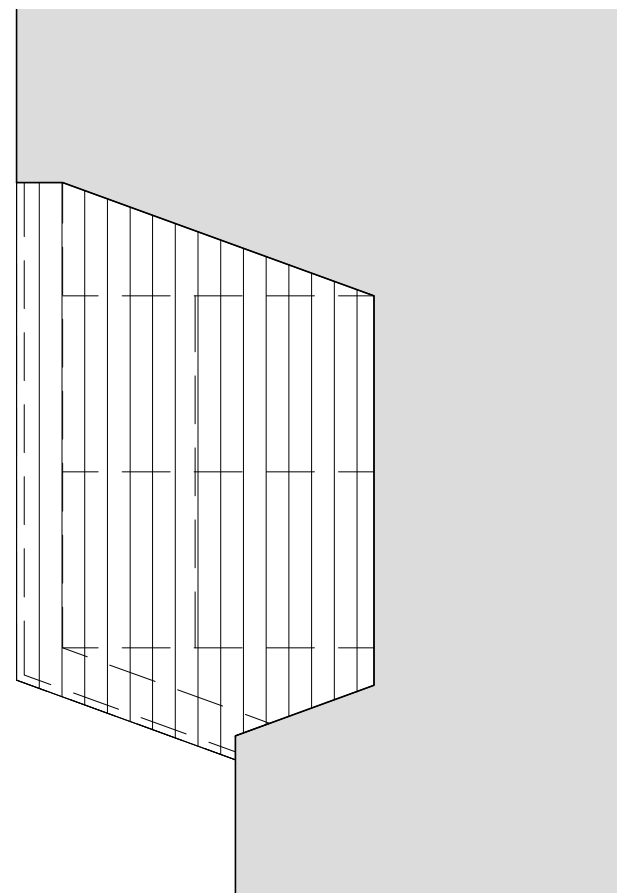


6 TYP. SECOND FLOOR SOFFIT REFLECTED CEILING PLAN
A3.2 1:50

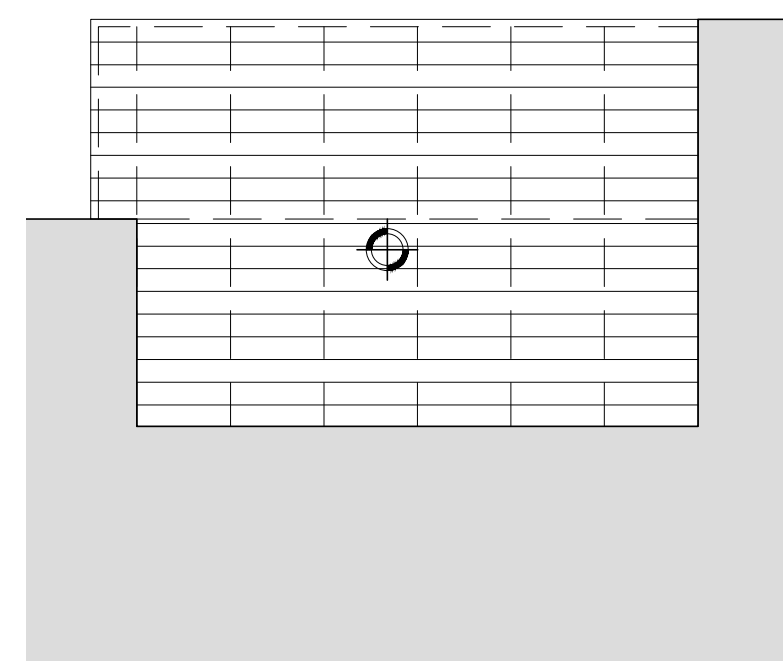


5 DOOR 17 SOFFIT REFLECTED CEILING PLAN
A3.2 1:50

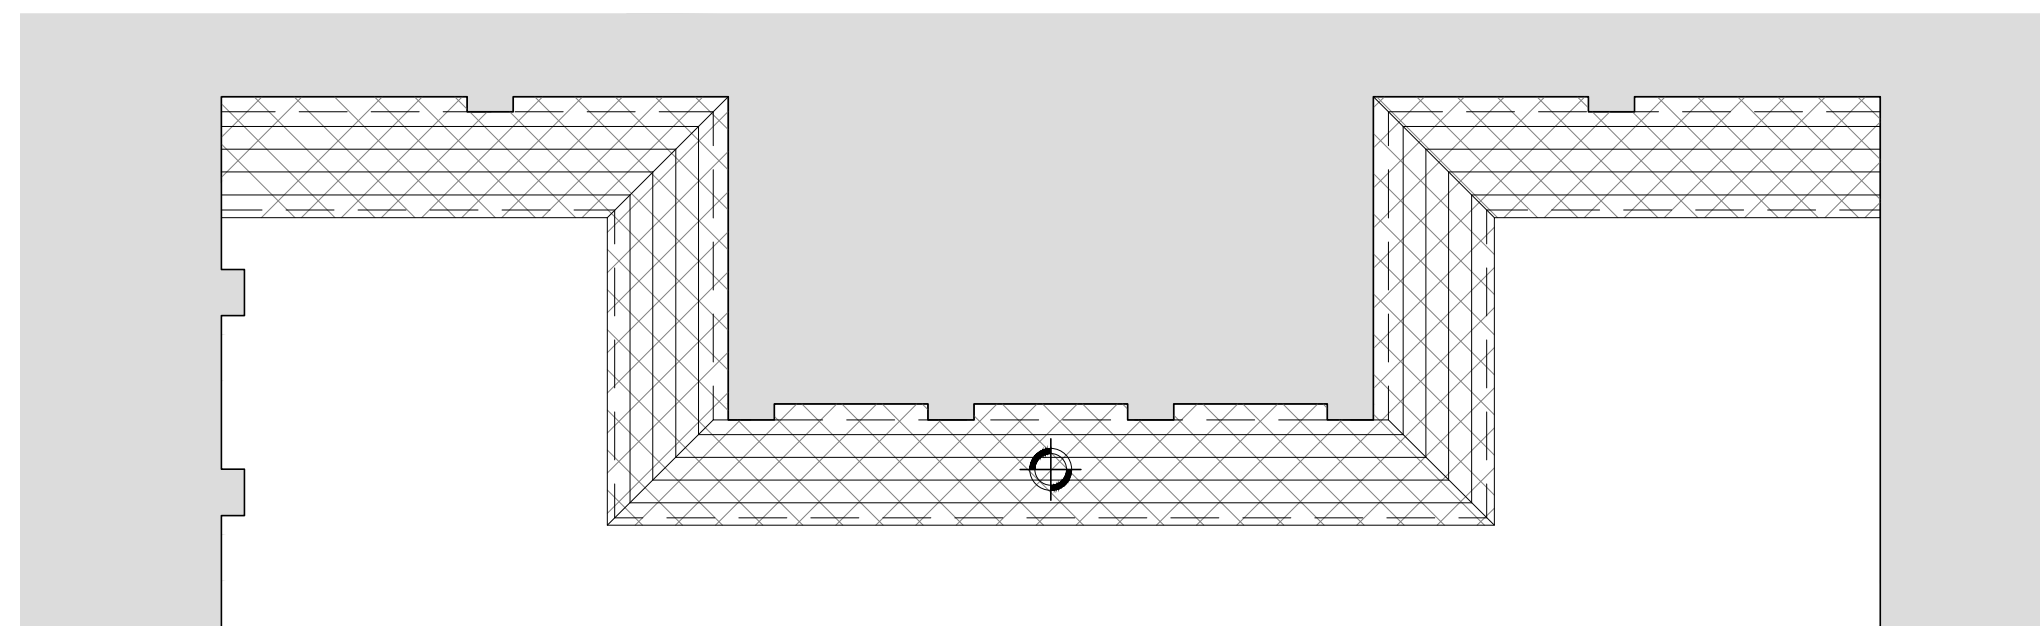


4 DOOR 1 SOFFIT REFLECTED CEILING PLAN
A3.2 1:50

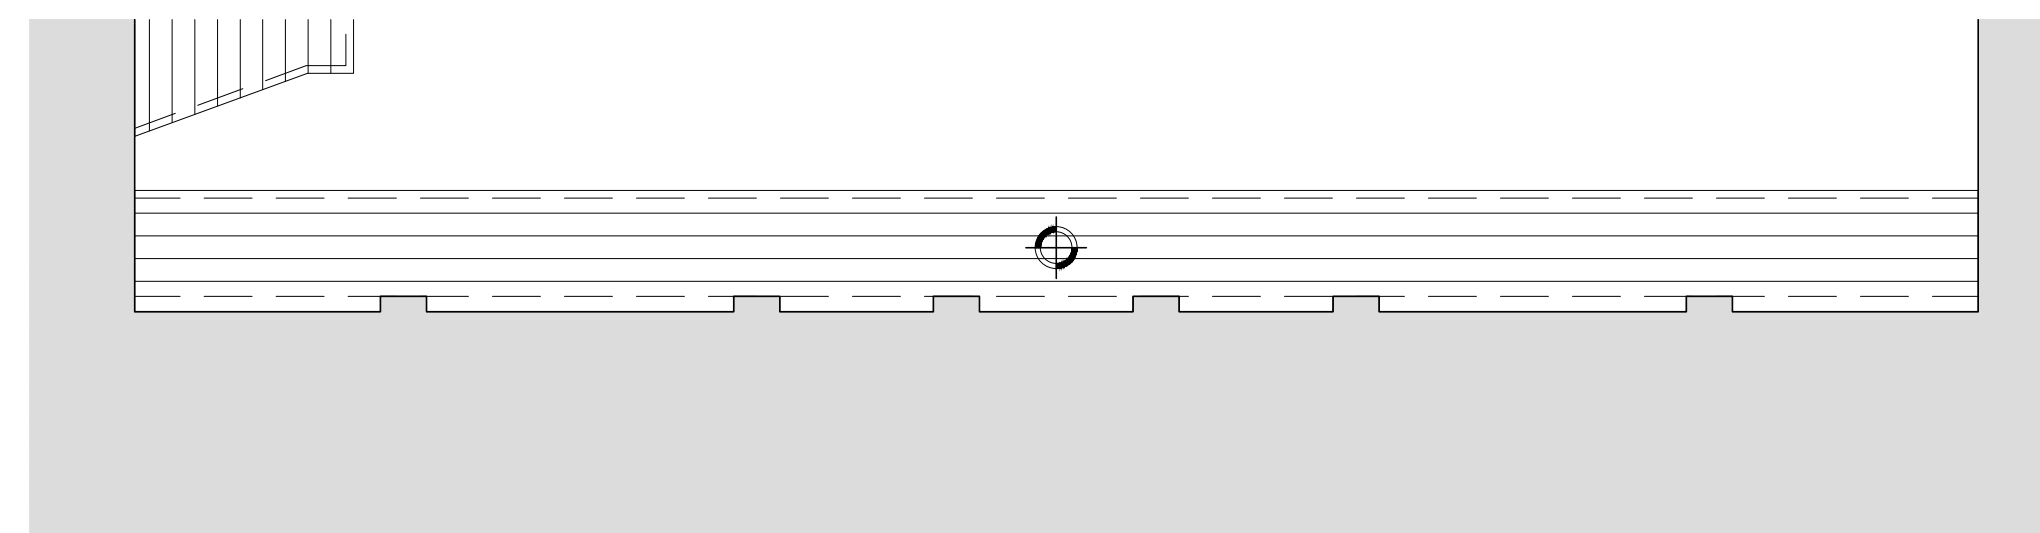

3 DOOR 15 SOFFIT REFLECTED CEILING PLAN
A3.2 1:50

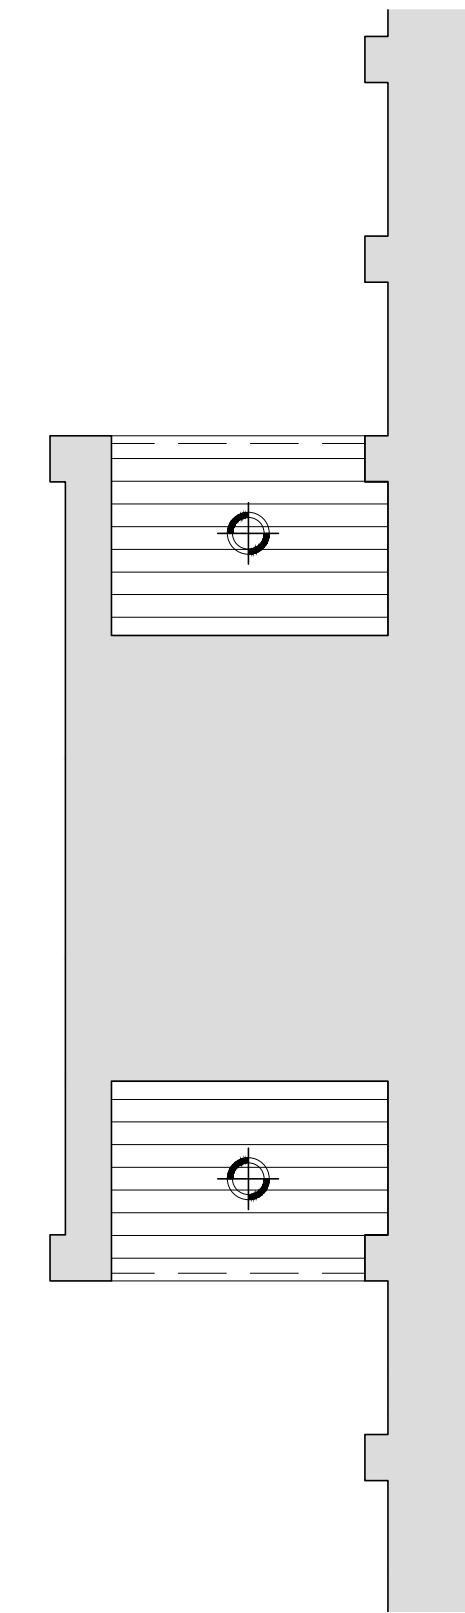

2 DOOR 23-24 SOFFIT REFLECTED CEILING PLAN
A3.2 1:50

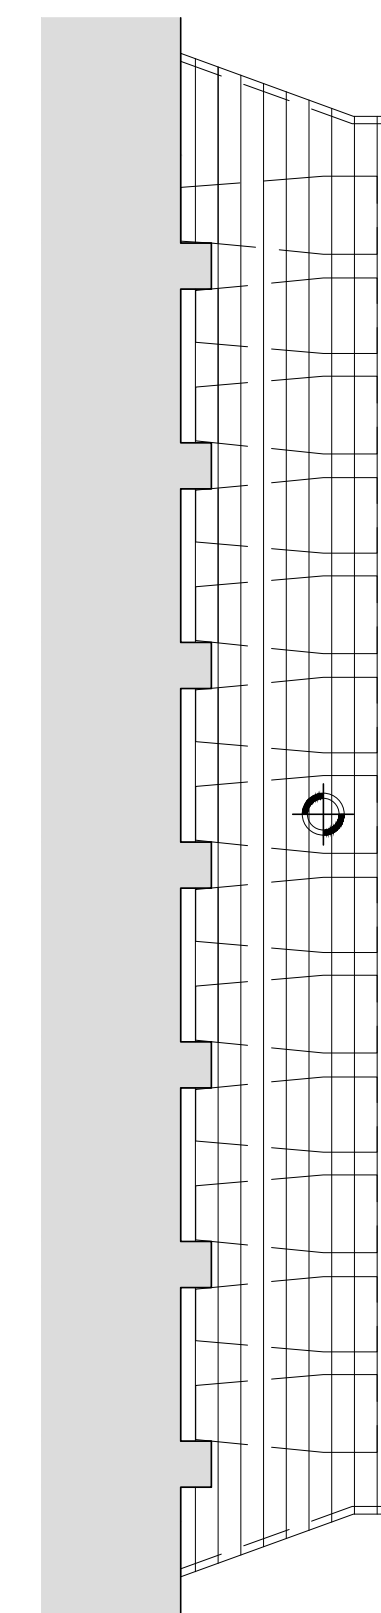

1 TYP. FIRST FLOOR SOFFIT REFLECTED CEILING PLAN
A3.2 1:50

PLAN NOTES

- ALL EXTERIOR LIGHT FIXTURES ARE TO BE REPLACED.
U.N.O
- ALL EXISTING SOFFIT CLADDING TO BE REMOVED IN ALL AREAS RECEIVING NEW SOFFIT CLADDING

PLAN LEGEND

- EXISTING
- DEMOLITION
- NEW CONSTRUCTION
- PROPOSED PREFINISHED METAL SOFFIT CLADDING - SOLID COLOUR
- PROPOSED PREFINISHED METAL SOFFIT CLADDING - WOOD GRAIN

LIGHTING LEGEND

- SURFACE MOUNTED LIGHT FIXTURE

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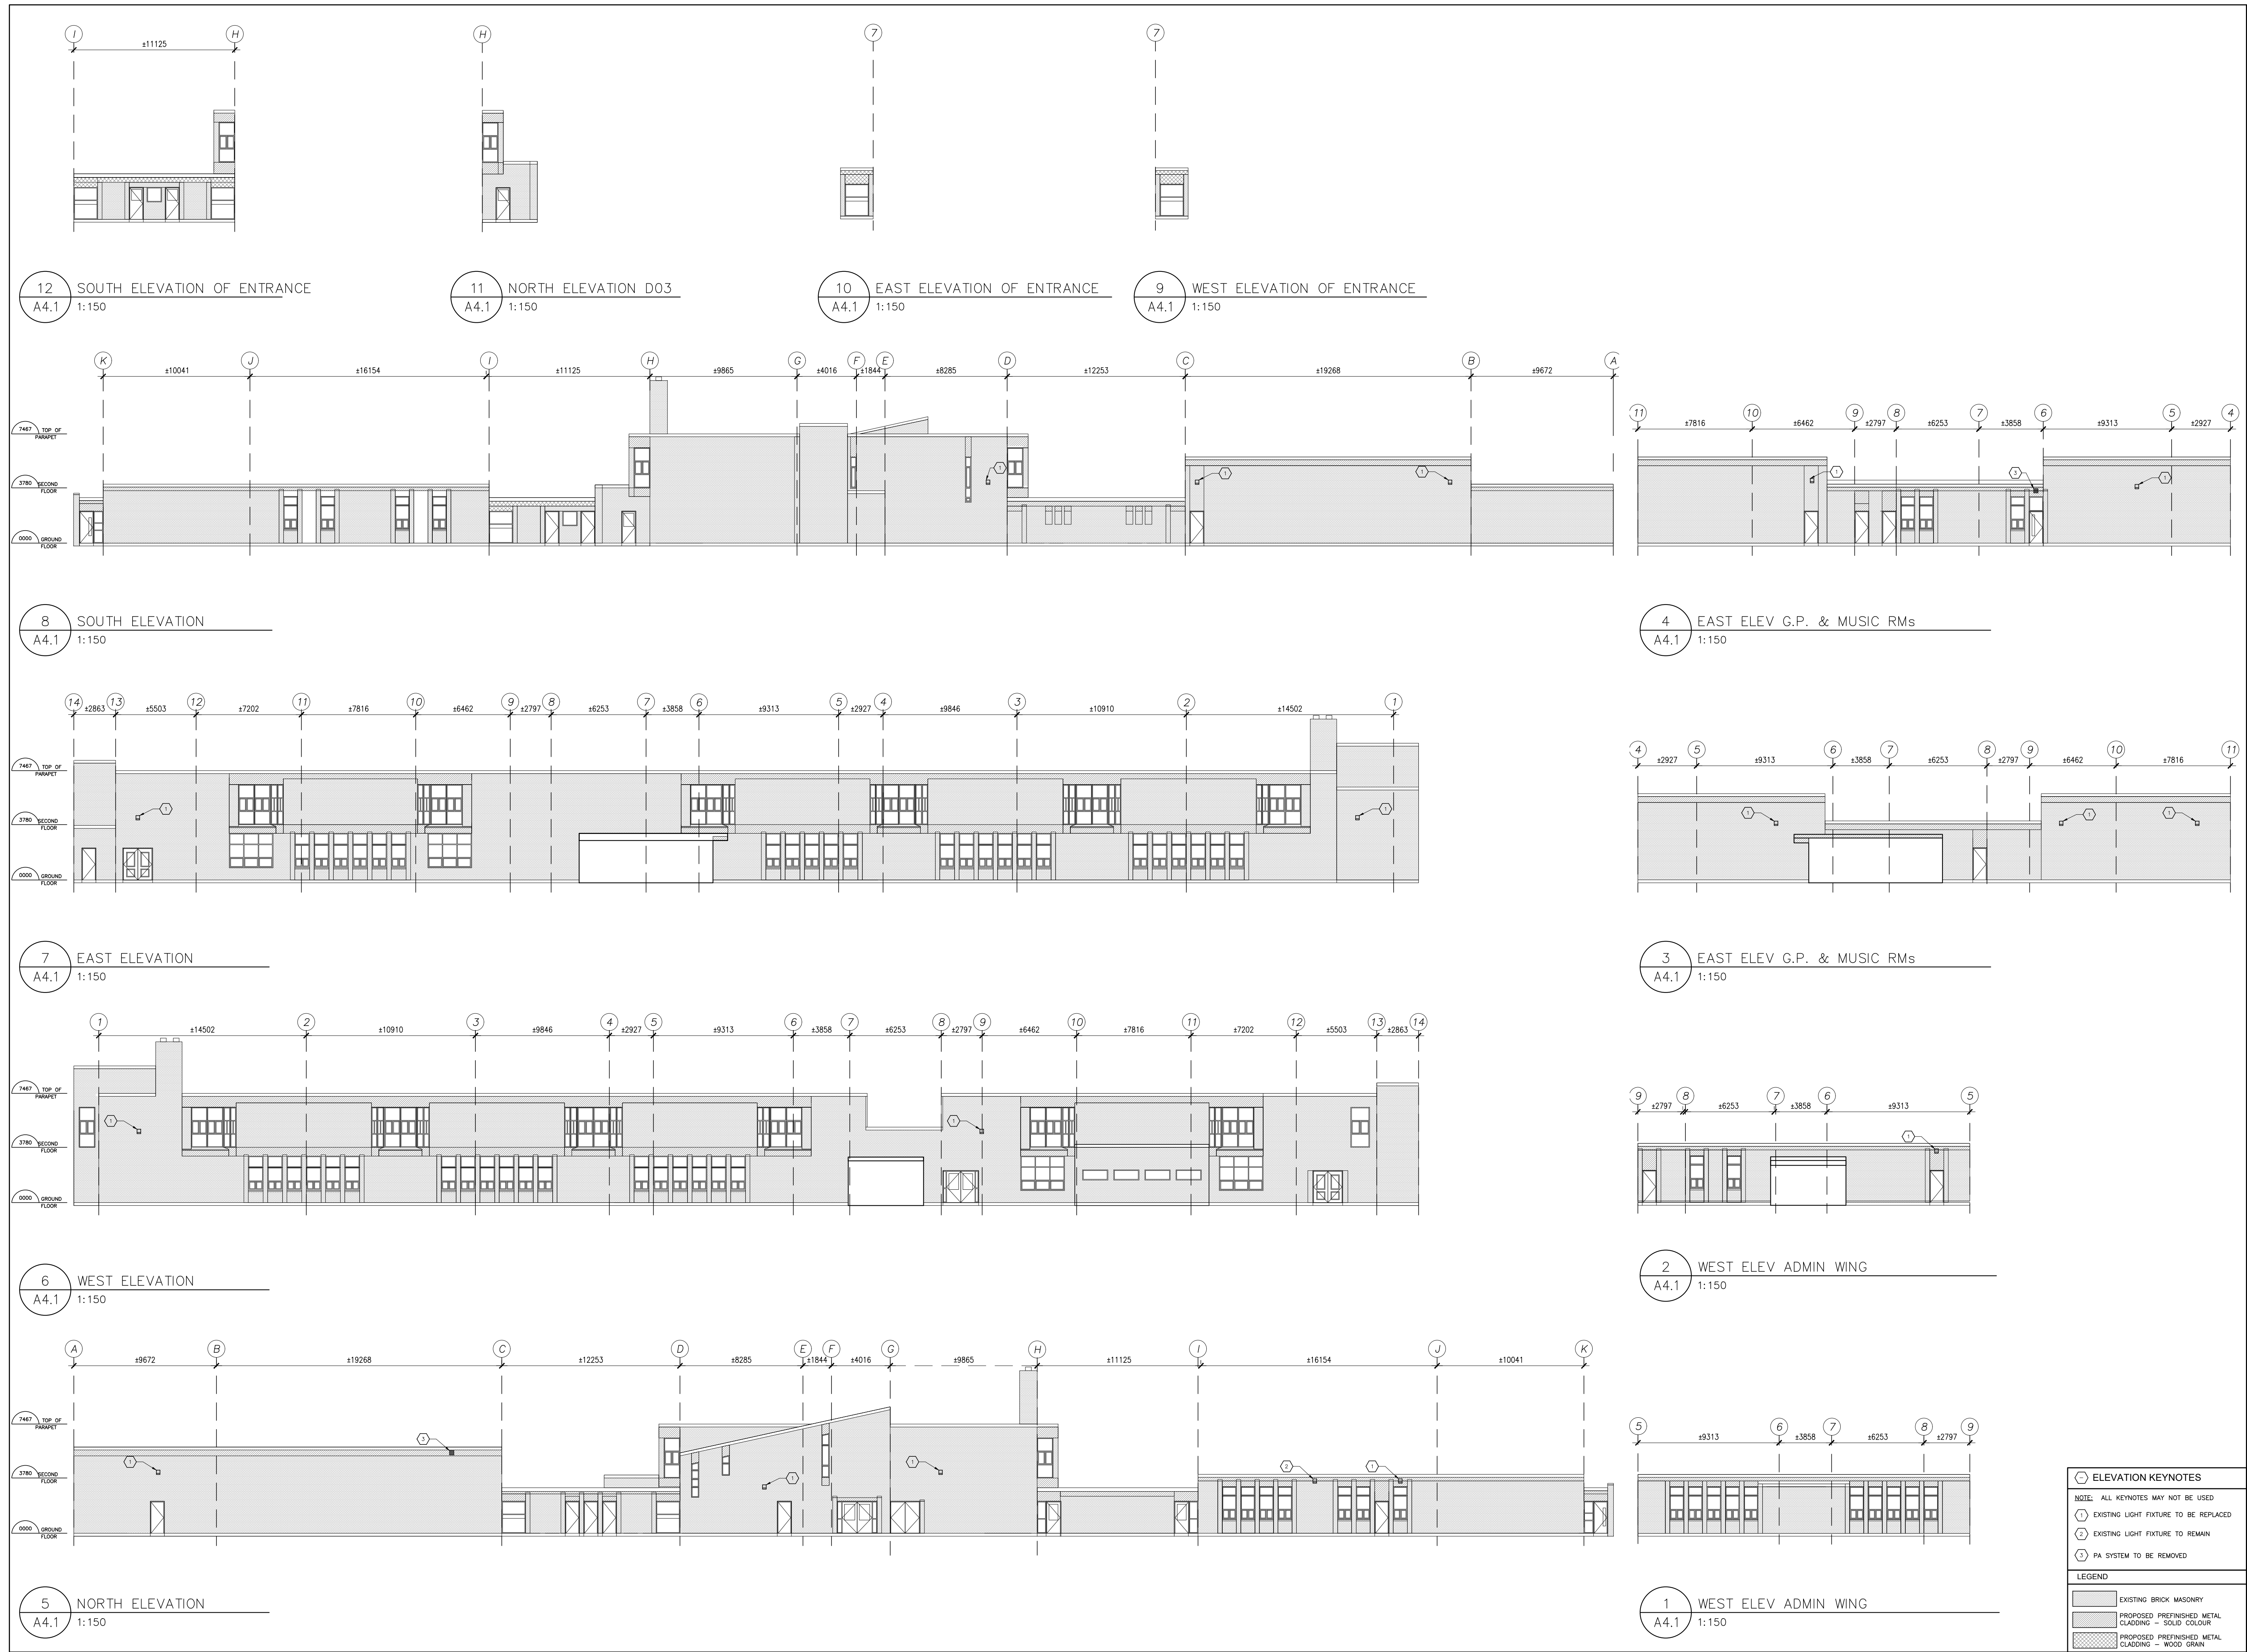
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Public School**
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Burlington, ON

Dwg. Title:
**Exterior Soffit
Plans**

Drwn: Chkd:
Proj. No.: 23001
Scale: As noted
Date: 06/21/23

Drawing No.:
A3.2



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 HDSB Frontenac
 Public School**
 5140 Pinedale Ave,
 Burlington, ON

Dwg. Title:

Existing Building Elevations

Drawn:	Chkd:
Proj. No.: 23001	
Scale: As noted	
Date: 06/21/23	

Drawing No.:
A4.1


ELEVATION KEYNOTES

NOTE: ALL KEYNOTES MAY NOT BE USED


- ① EXISTING LIGHT FIXTURE TO BE REPLACED
- ② EXISTING LIGHT FIXTURE TO REMAIN
- ③ PA SYSTEM TO BE REMOVED

LEGEND


- EXISTING BRICK MASONRY
- PROPOSED PREFINISHED METAL CLADDING - SOLID COLOUR
- PROPOSED PREFINISHED METAL CLADDING - WOOD GRAIN

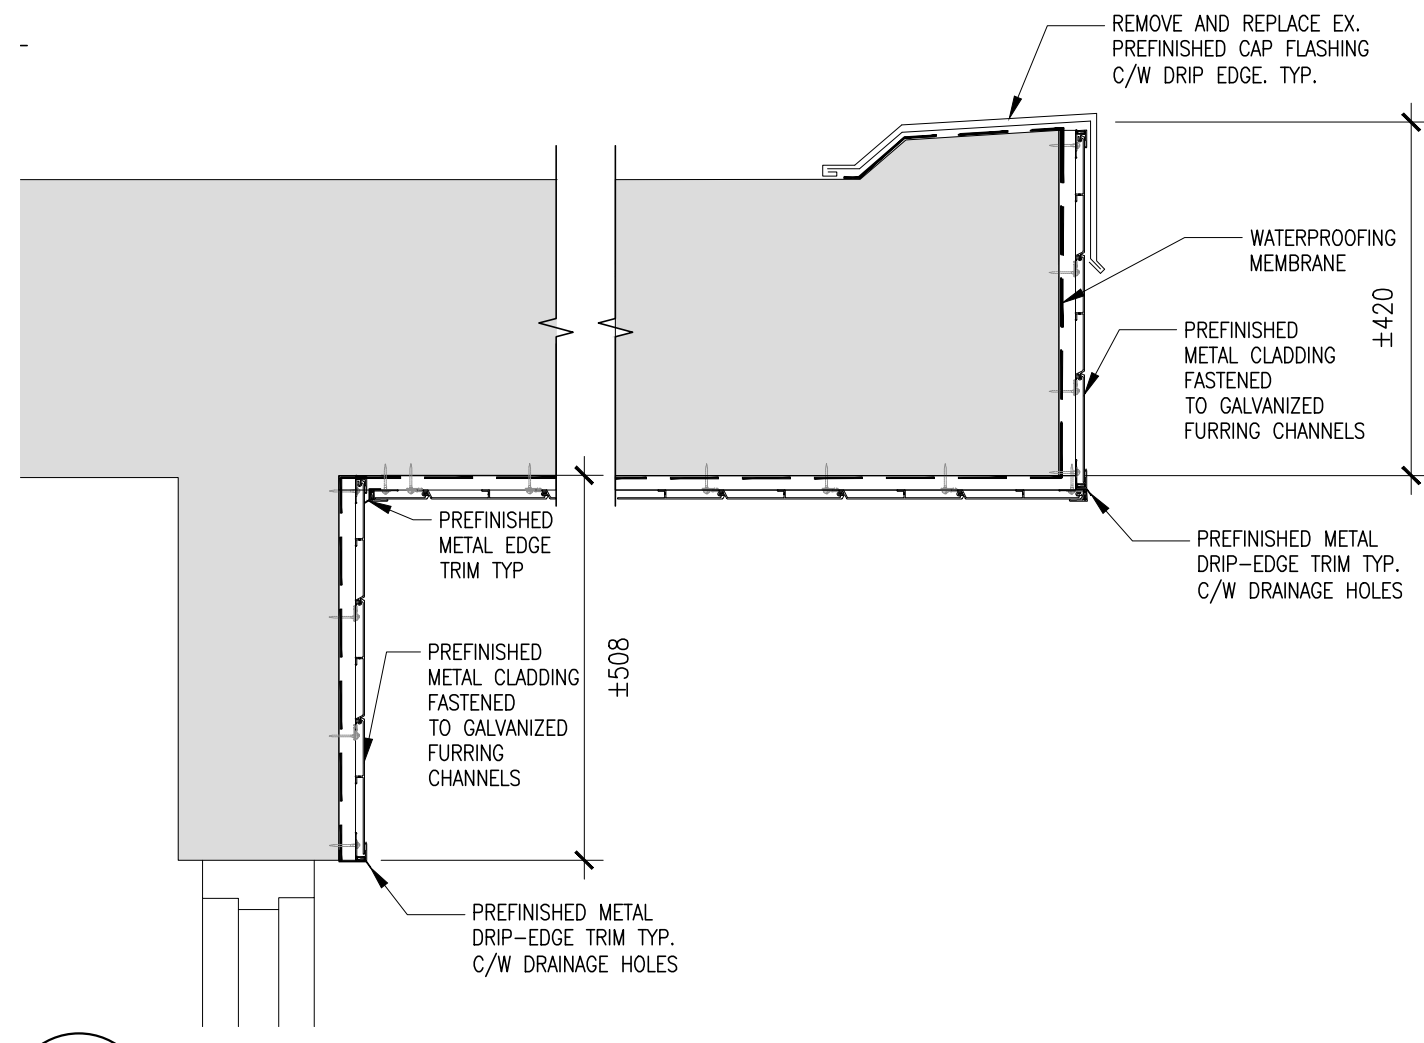


5 TYP JOINING CORRIDOR DETAIL
A7.1 1:10

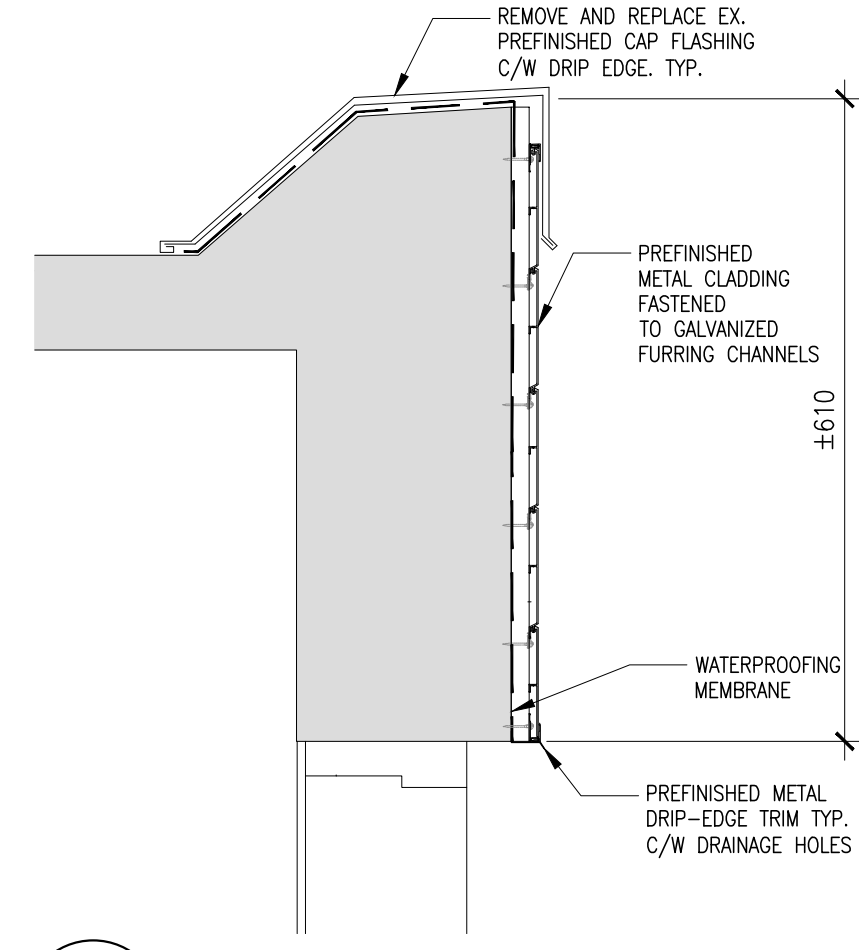


4 DETAIL OVER WINDOW ADMIN WING
A7.1 1:10

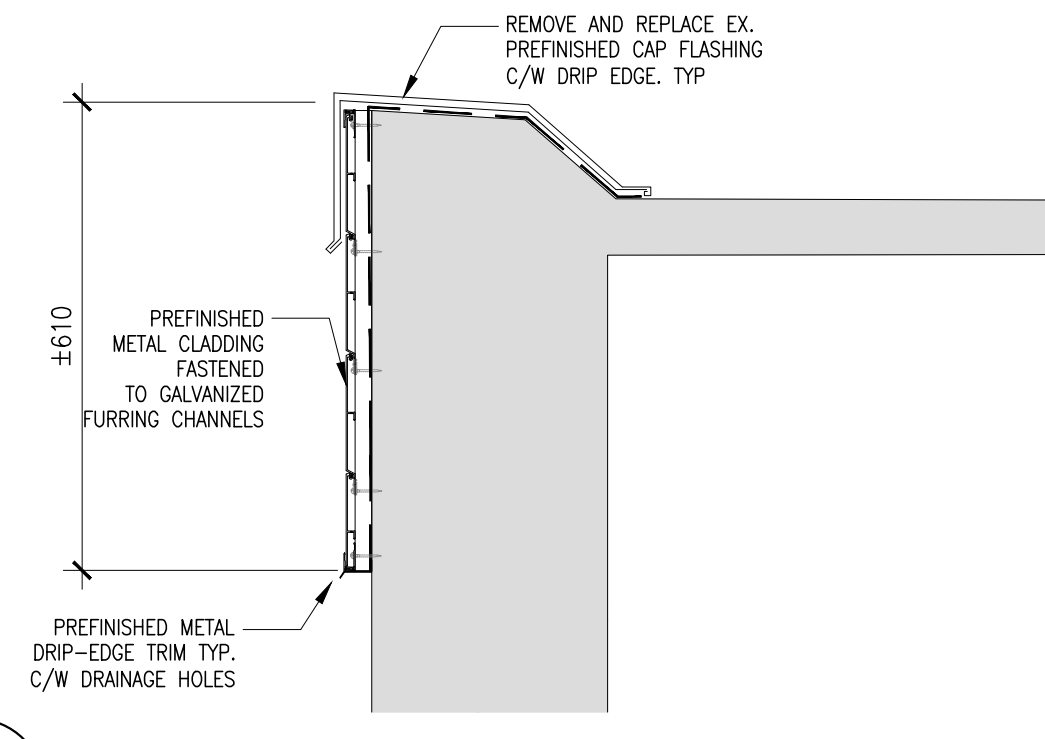


2 TYP GYM AND MUSIC ROOMS FASCIA DETAIL
A7.1 1:10

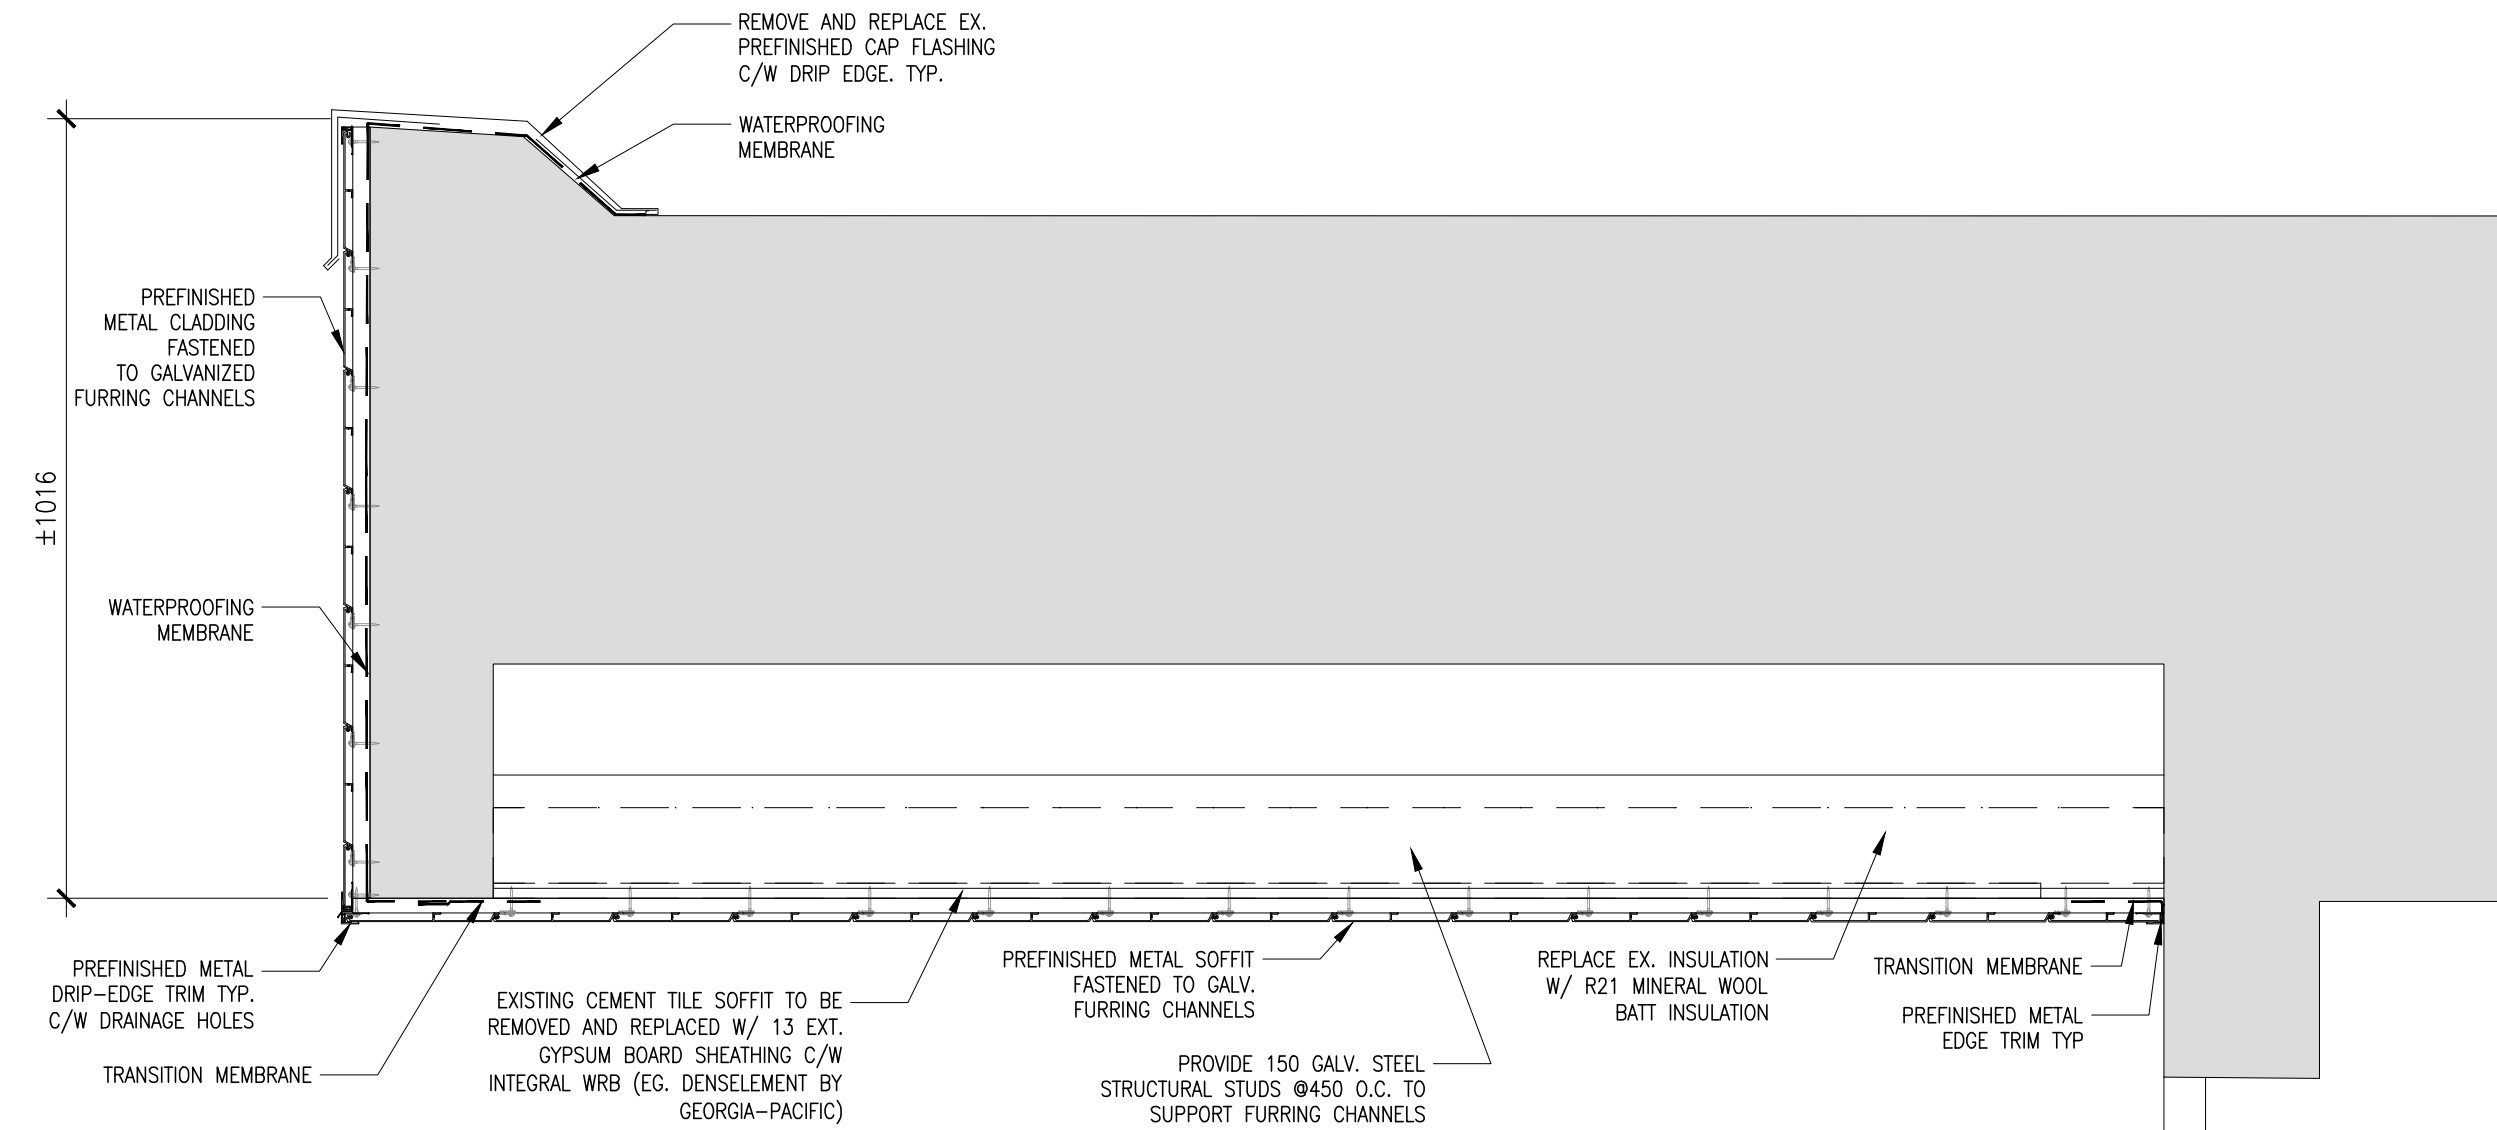

3 TYP WALL DETAIL
A7.1 1:10

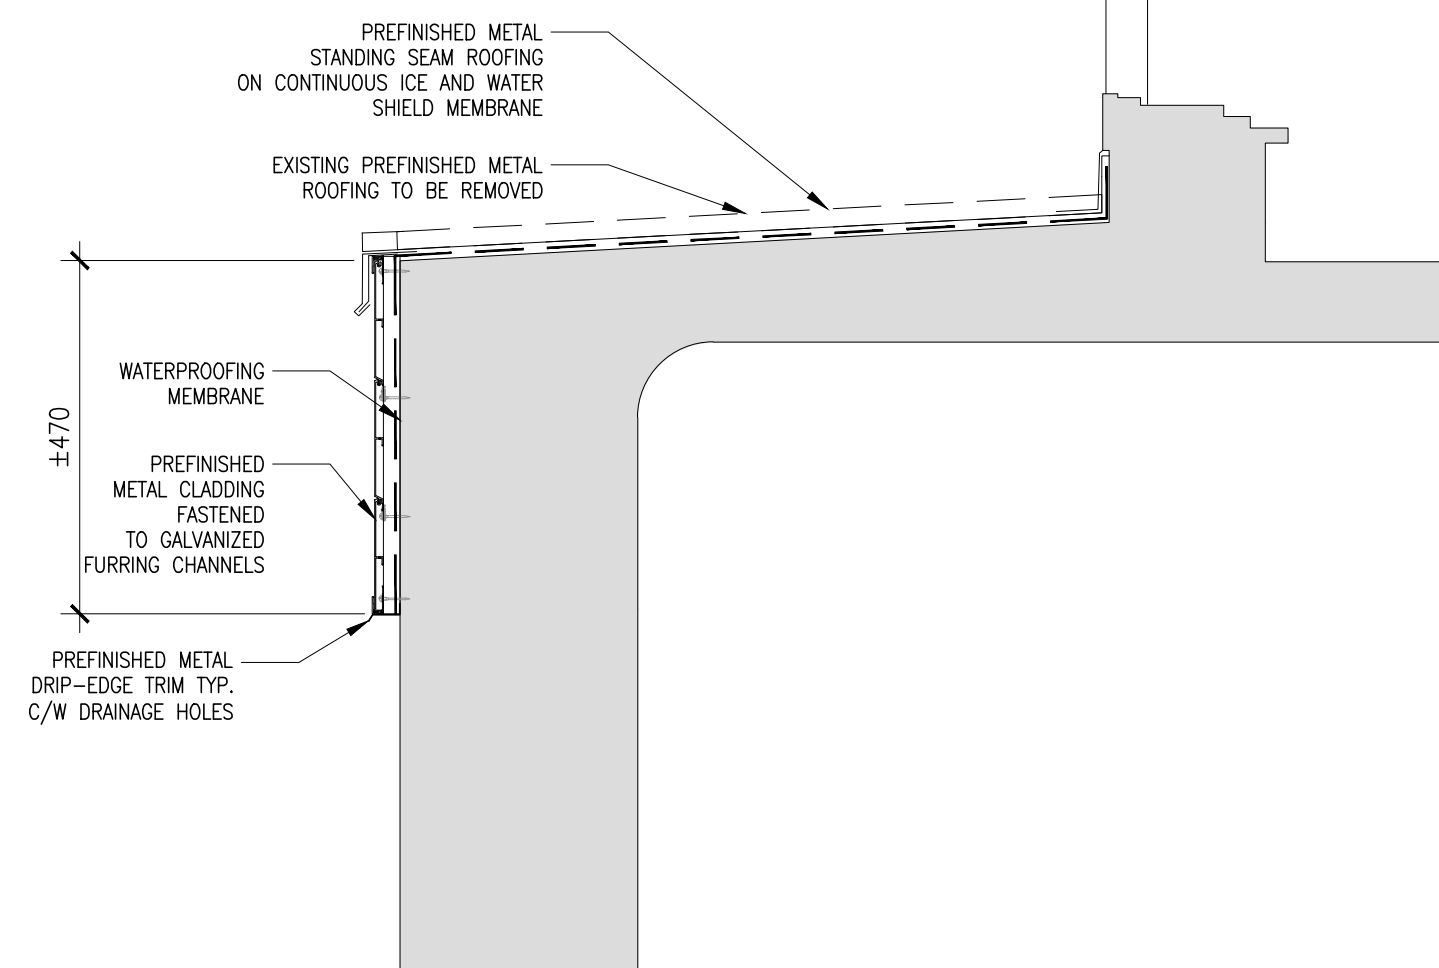

1 TYP WALL DETAIL
A7.1 1:10

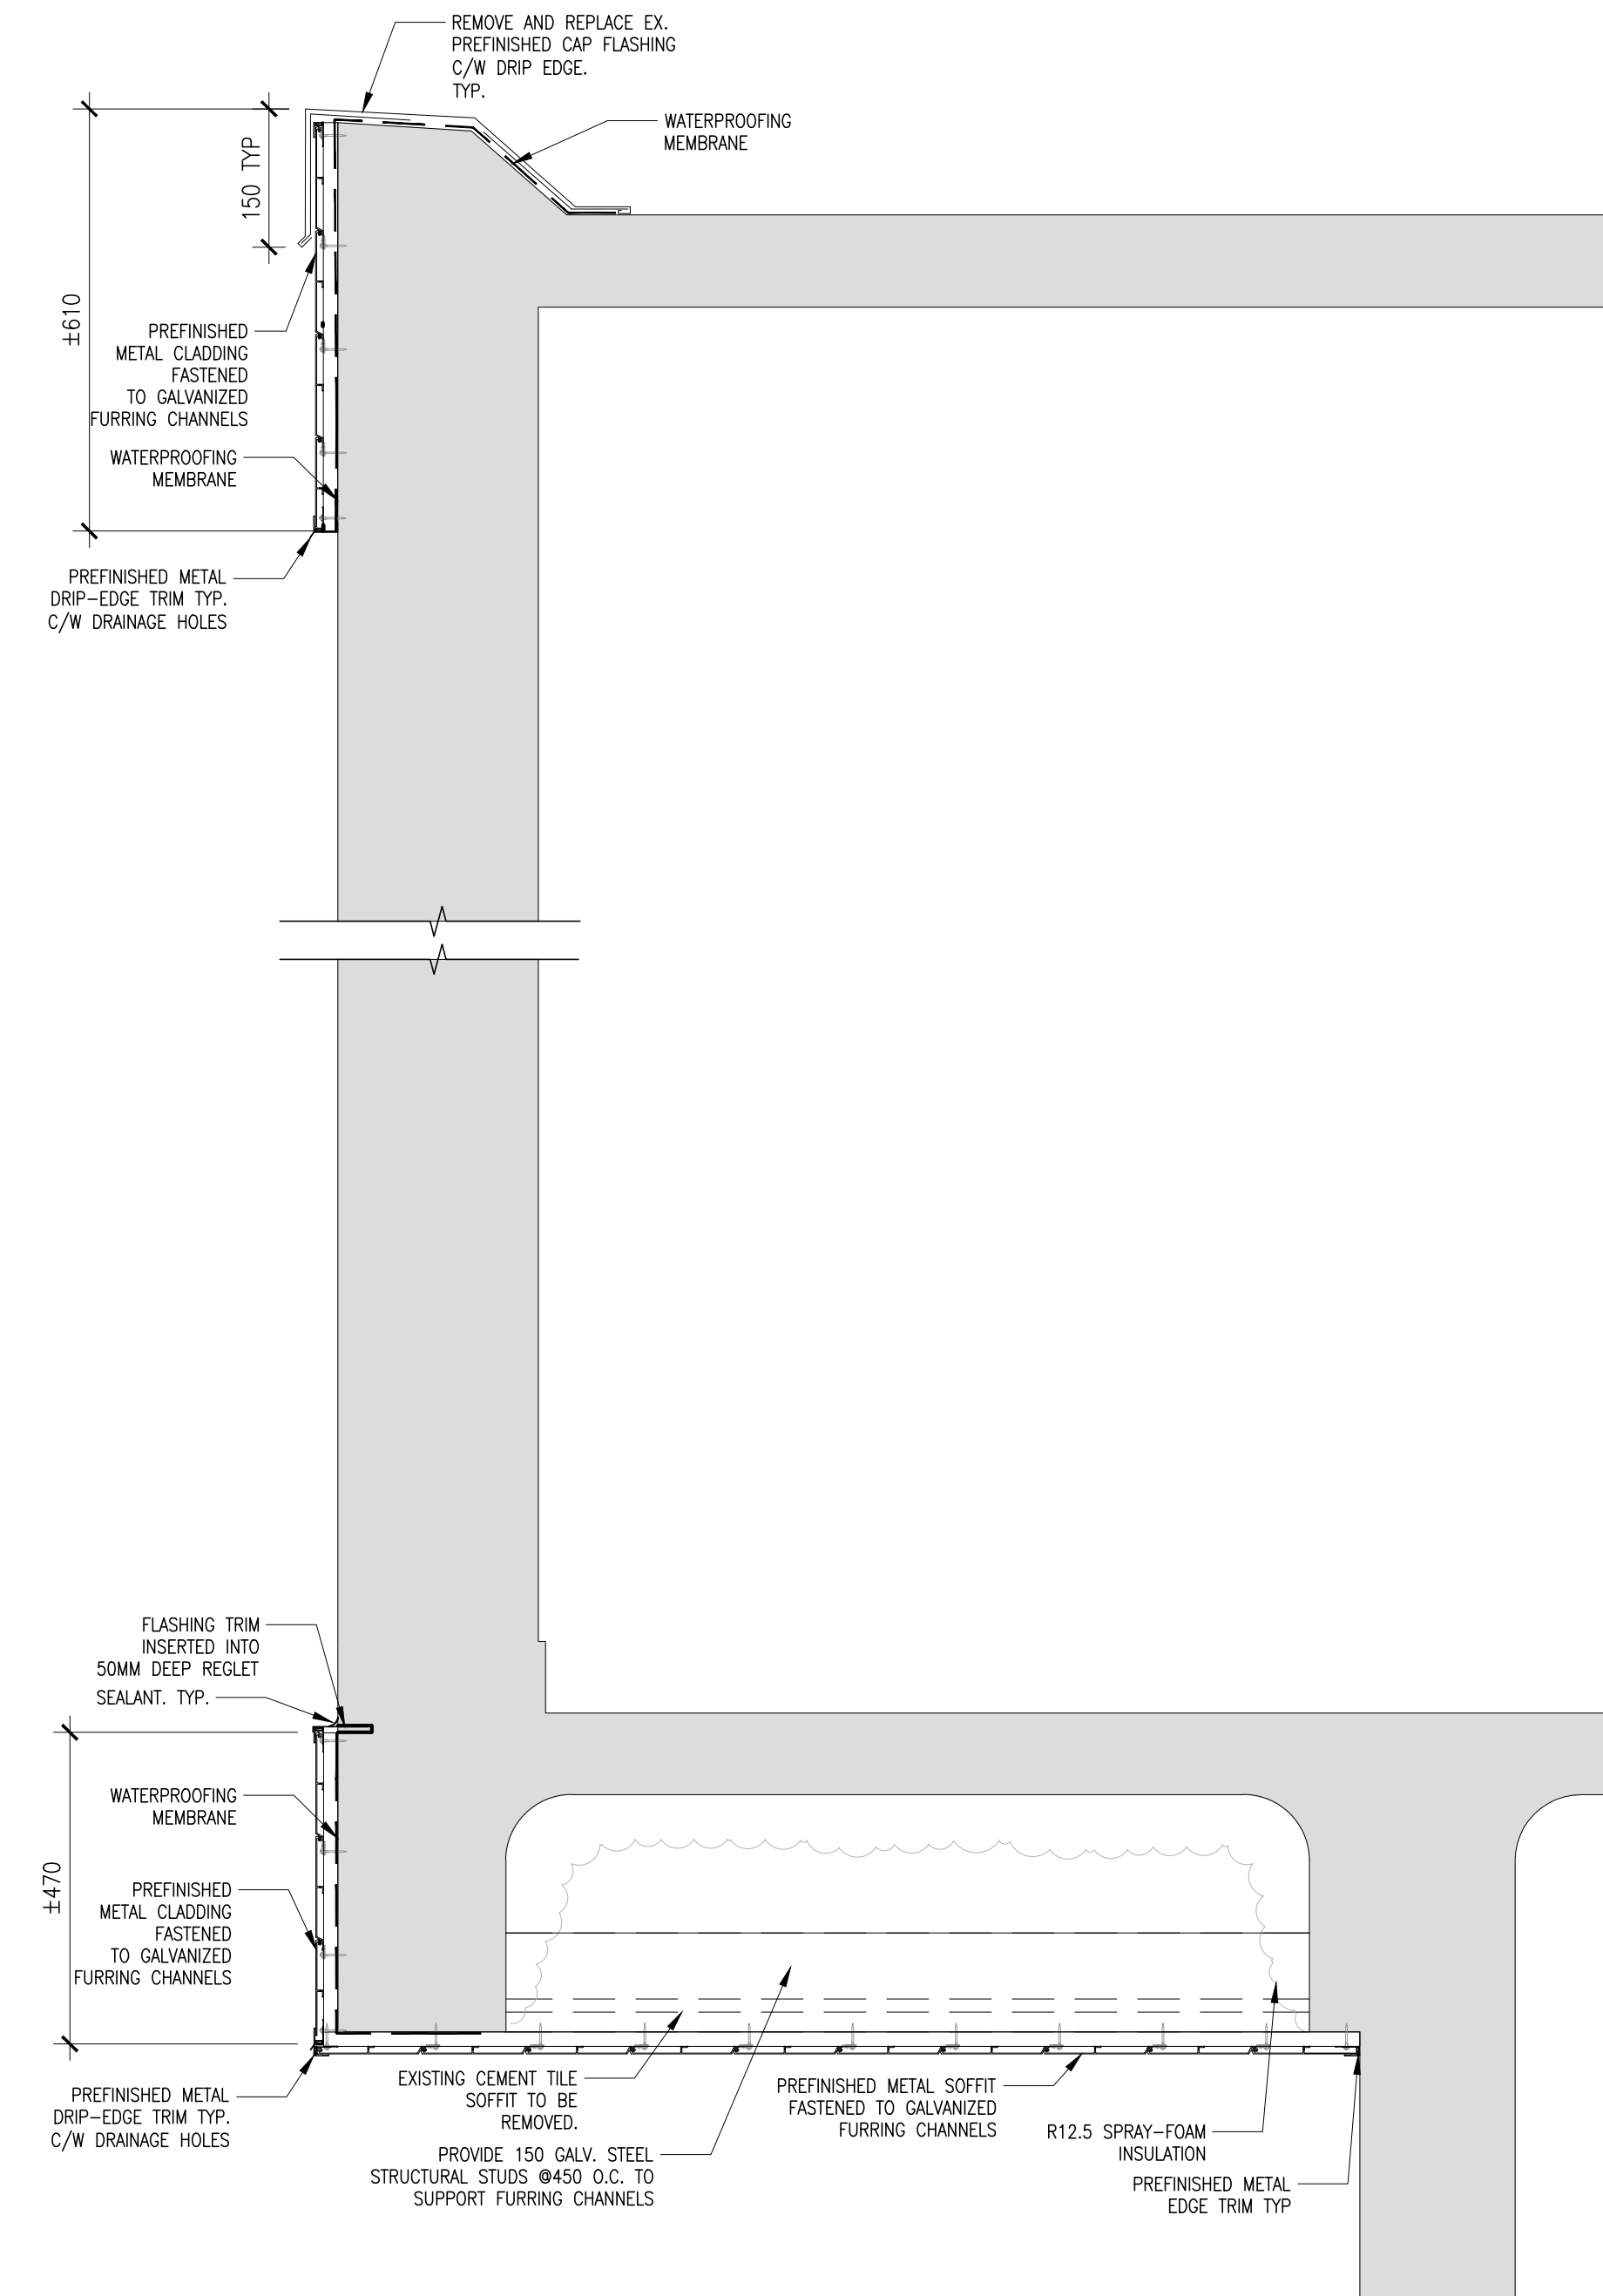

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Cladding Replacement at
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Burlington, ON

Dwg. Title:
Wall Fascia, Soffit Detail Sections

Drwn: Chkd:
Proj. No.: 23001
Scale: As noted
Date: 06/21/23

Drawing No.:
A7.1