


MONSIGNOR DOYLE CSS

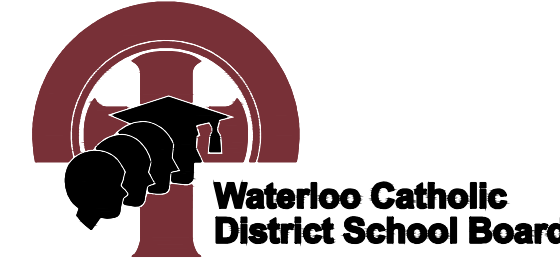

185 MYERS Rd, CAMBRIDGE, ON N1R 7H2

WCDSB PROJECT No. RfT # 2024-01

17|21 PROJECT No. 2330

ARCHITECTS

17|21 ARCHITECTS
1065 VALETTA STREET, SUITE A,
LONDON, ONTARIO
N6H 2Z9
T: 519.439.0611
INFO@1721ARCHITECTS.CA
WWW.1721ARCHITECTS.CA

MECHANICAL AND ELECTRICAL CONSULTANTS

CALLIDUS ENGINEERING
1385 N ROUTLEDGE PARK, UNIT 9
LONDON, ONTARIO N6H5N5
T: (519) 472 7640



DRAWING LIST

ARCHITECTURAL DRAWINGS

A001	KEY PLAN, DRAWING LIST
A011	MOUNTING HEIGHTS, ACCESSORY SCHEDULE
A050	SITE PLAN
D100	DEMOLITION FIRST FLOOR PLAN - BLOCK A,
D101	DEMOLITION FIRST FLOOR PLAN - BLOCK B,
D102	DEMOLITION FIRST FLOOR PLAN - BLOCK C,
D103	DEMOLITION FIRST FLOOR PLAN - BLOCK D,
D104	DEMOLITION SECOND FLOOR PLAN - BLOCK B,
A100	FIRST FLOOR PLAN - BLOCK A,
A101	FIRST FLOOR PLAN - BLOCK B,
A102	FIRST FLOOR PLAN - BLOCK C,
A103	FIRST FLOOR PLAN - BLOCK D,
A104	SECOND FLOOR PLAN - BLOCK B,
A105	ROOF PLAN, DETAILS
A200	ENLARGED FLOOR PLAN, INTERIOR ELEVATIONS, MILLWORK DETAILS WALL SECTION, DETAILS
A900	MILLWORK PLANS, SECTIONS & DETAILS
A1000	JAMB DETAILS, DOOR TYPES, OPENING SCHEDULES

ELECTRICAL

E1	ELECTRICAL LEGEND AND SCHEDULE
E2	PARTIAL OFFICE, CORRIDOR & GYM - LIGHTING DEMO
E3	PARTIAL OFFICE, CORRIDOR & GYM - LIGHTING DEMO
E4	PARTIAL CLASSROOM ELECTRICAL PLAN - LIGHTING DEMO
E5	PARTIAL CLASSROOM ELECTRICAL PLAN - LIGHTING DEMO
E6	PARTIAL OFFICE, CORRIDOR & GYM - NEW LIGHTING
E7	PARTIAL OFFICE, CORRIDOR & GYM - NEW LIGHTING
E8	PARTIAL CLASSROOM PLAN - NEW LIGHTING
E9	PARTIAL CLASSROOM PLAN - NEW LIGHTING
E10	ELECTRICAL SPECIFICATIONS


MECHANICAL

M1	SCHEDULES, LEGENDS & DETAILS - MECHANICAL
M2	GROUND FLOOR-REMOVALS & REVISIONS
M3	MECH, ROOM - REMOVALS & REVISIONS
M4	ENLARGED PLANS - MECHANICAL
M5	ENLARGED PLANS - MECHANICAL
M6	MECHANICAL SPECIFICATIONS
M6	MECHANICAL SPECIFICATIONS CONT'D



KEY PLAN

KEY PLAN

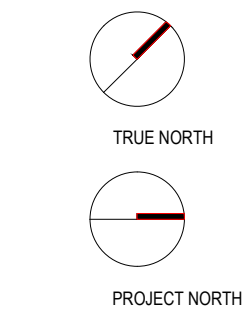


LEGEND

ISSUED

DATE	DESCRIPTION	No.
2024-02-15	ISSUE FOR TENDER	1

SYMBOL LEGENDS


DRAWING NUMBER

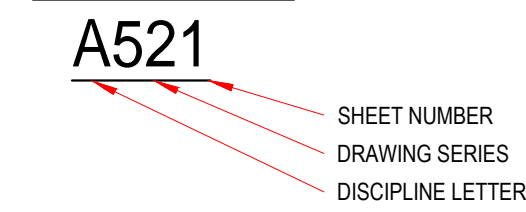


DRAWING TITLE




WALL / BUILDING SECTION MARKER

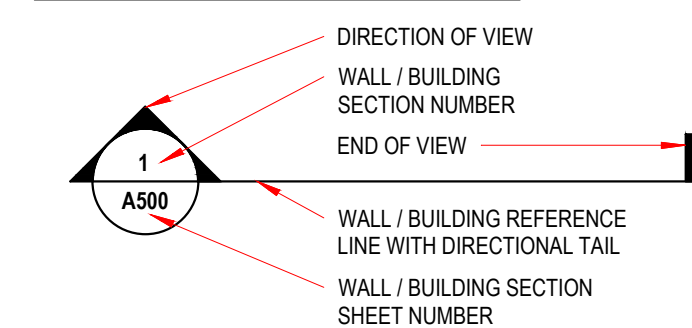


DETAIL / ENLARGED PLAN MARKER

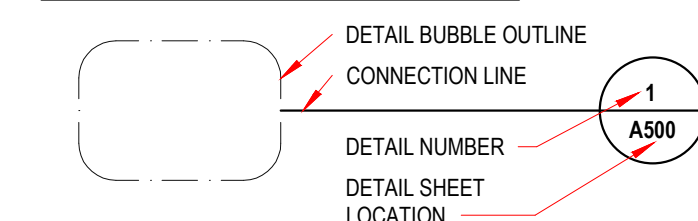


EXTERIOR ELEVATION TAG

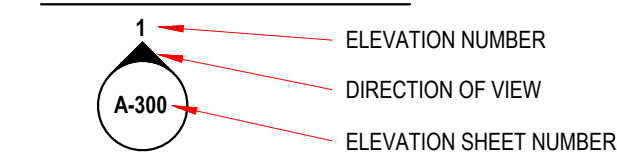


INTERIOR ELEVATION TAG

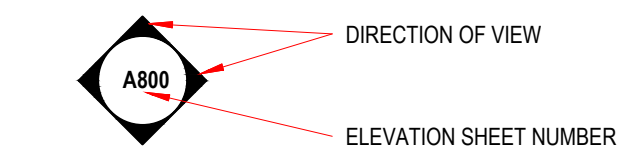


GRID BUBBLE AND LINE

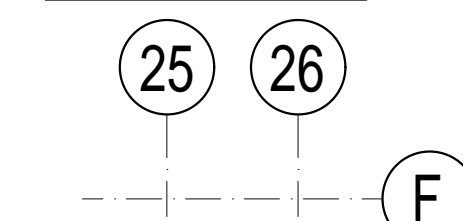


VERTICAL ELEVATION MARKER

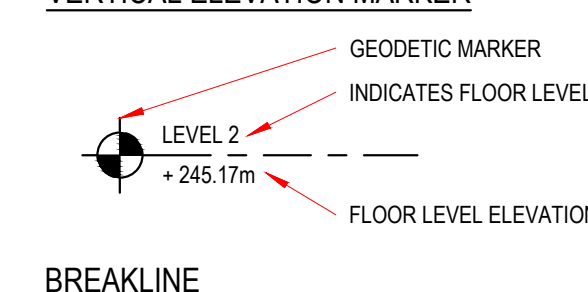


DIMENSIONS

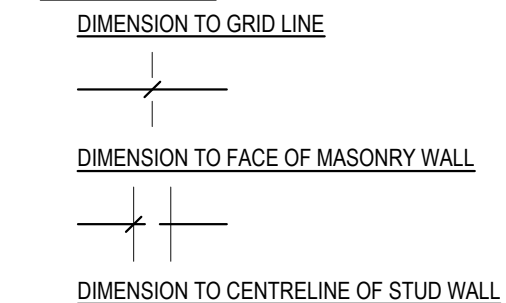


ROOM NAME AND NUMBER TAG

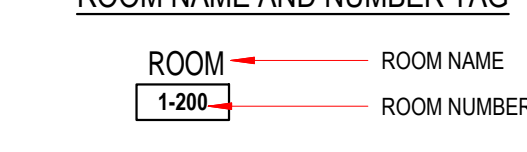


DRAWING REVISIONS

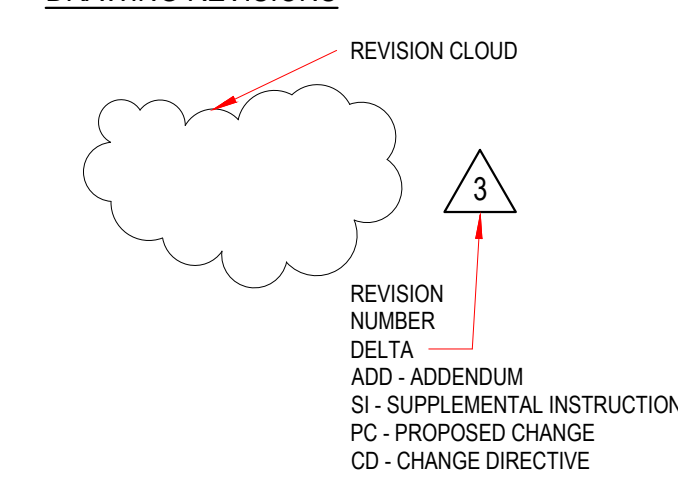


PARTITION TAG

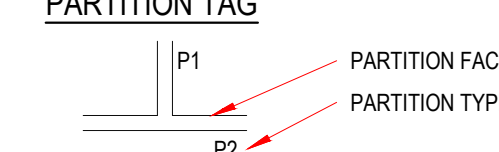


DOOR NUMBER TAG

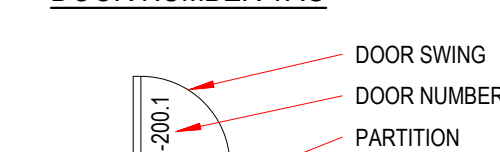

WINDOW TYPE TAG

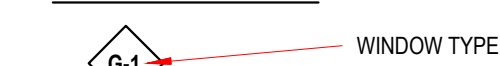


BARRIER FREE TURNING CIRCLE (1500mm DIA.) (1800mm DIA.)

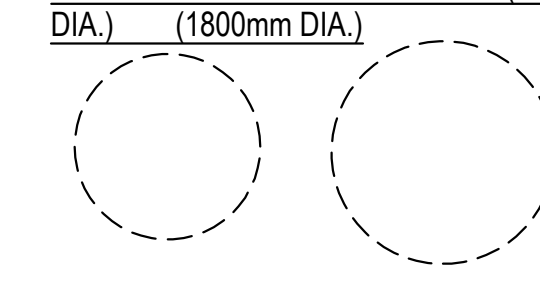


MILLWORK - PLAN DESIGNATION




MILLWORK - SECTION TAG

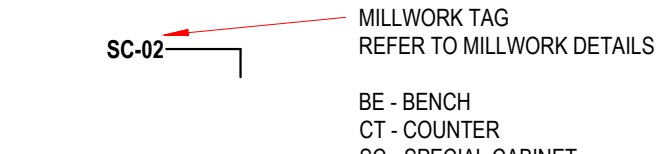


FURNITURE (N.I.C.)

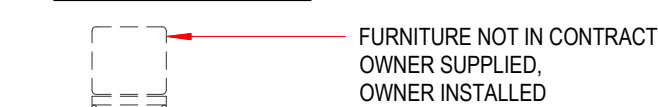

NORTH ARROW

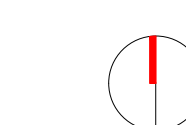

MOP SINK

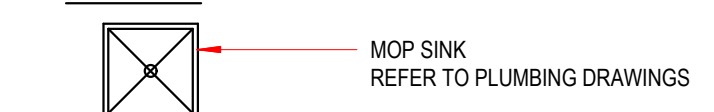


FLOOR DRAIN



ROOF DRAIN




FIRE HOSE + EXTINGUISHER CABINET

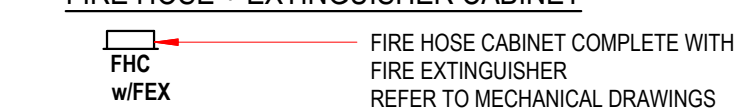

FIRE HOSE + EXTINGUISHER CABINET



ELECTRICAL PANEL

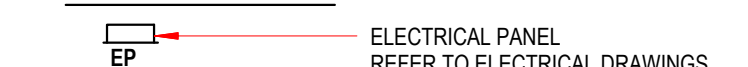

ALL DRAWINGS, SPECIFICATIONS AND RELATED DOCUMENTATION ARE COPYRIGHT PROPERTY OF 1721 ARCHITECTS INC. AND MUST BE RETURNED UPON REQUEST. REPRODUCTION OF DRAWINGS, SPECIFICATIONS AND RELATED DOCUMENTATION IN PART OR IN WHOLE IS WRITTEN FORBIDDEN WITHOUT THE WRITTEN PERMISSION OF 1721 ARCHITECTS INC.
DO NOT SCALE DRAWINGS
CONTRACTOR MUST CHECK AND VERIFY ALL DIMENSION OF THE JOB.
THIS DRAWING IS NOT TO BE USED FOR CONSTRUCTION UNTIL SIGNED BY THE ARCHITECT

Monsignor Doyle CSS

185 Myers Rd, Cambridge, ON N1R 7H2


KEY PLAN, DRAWING LIST

CHECKED: SD
DRAWN: RN
PROJECT No. 2330

SCALE: AS NOTED



A001

MOUNTING HEIGHTS

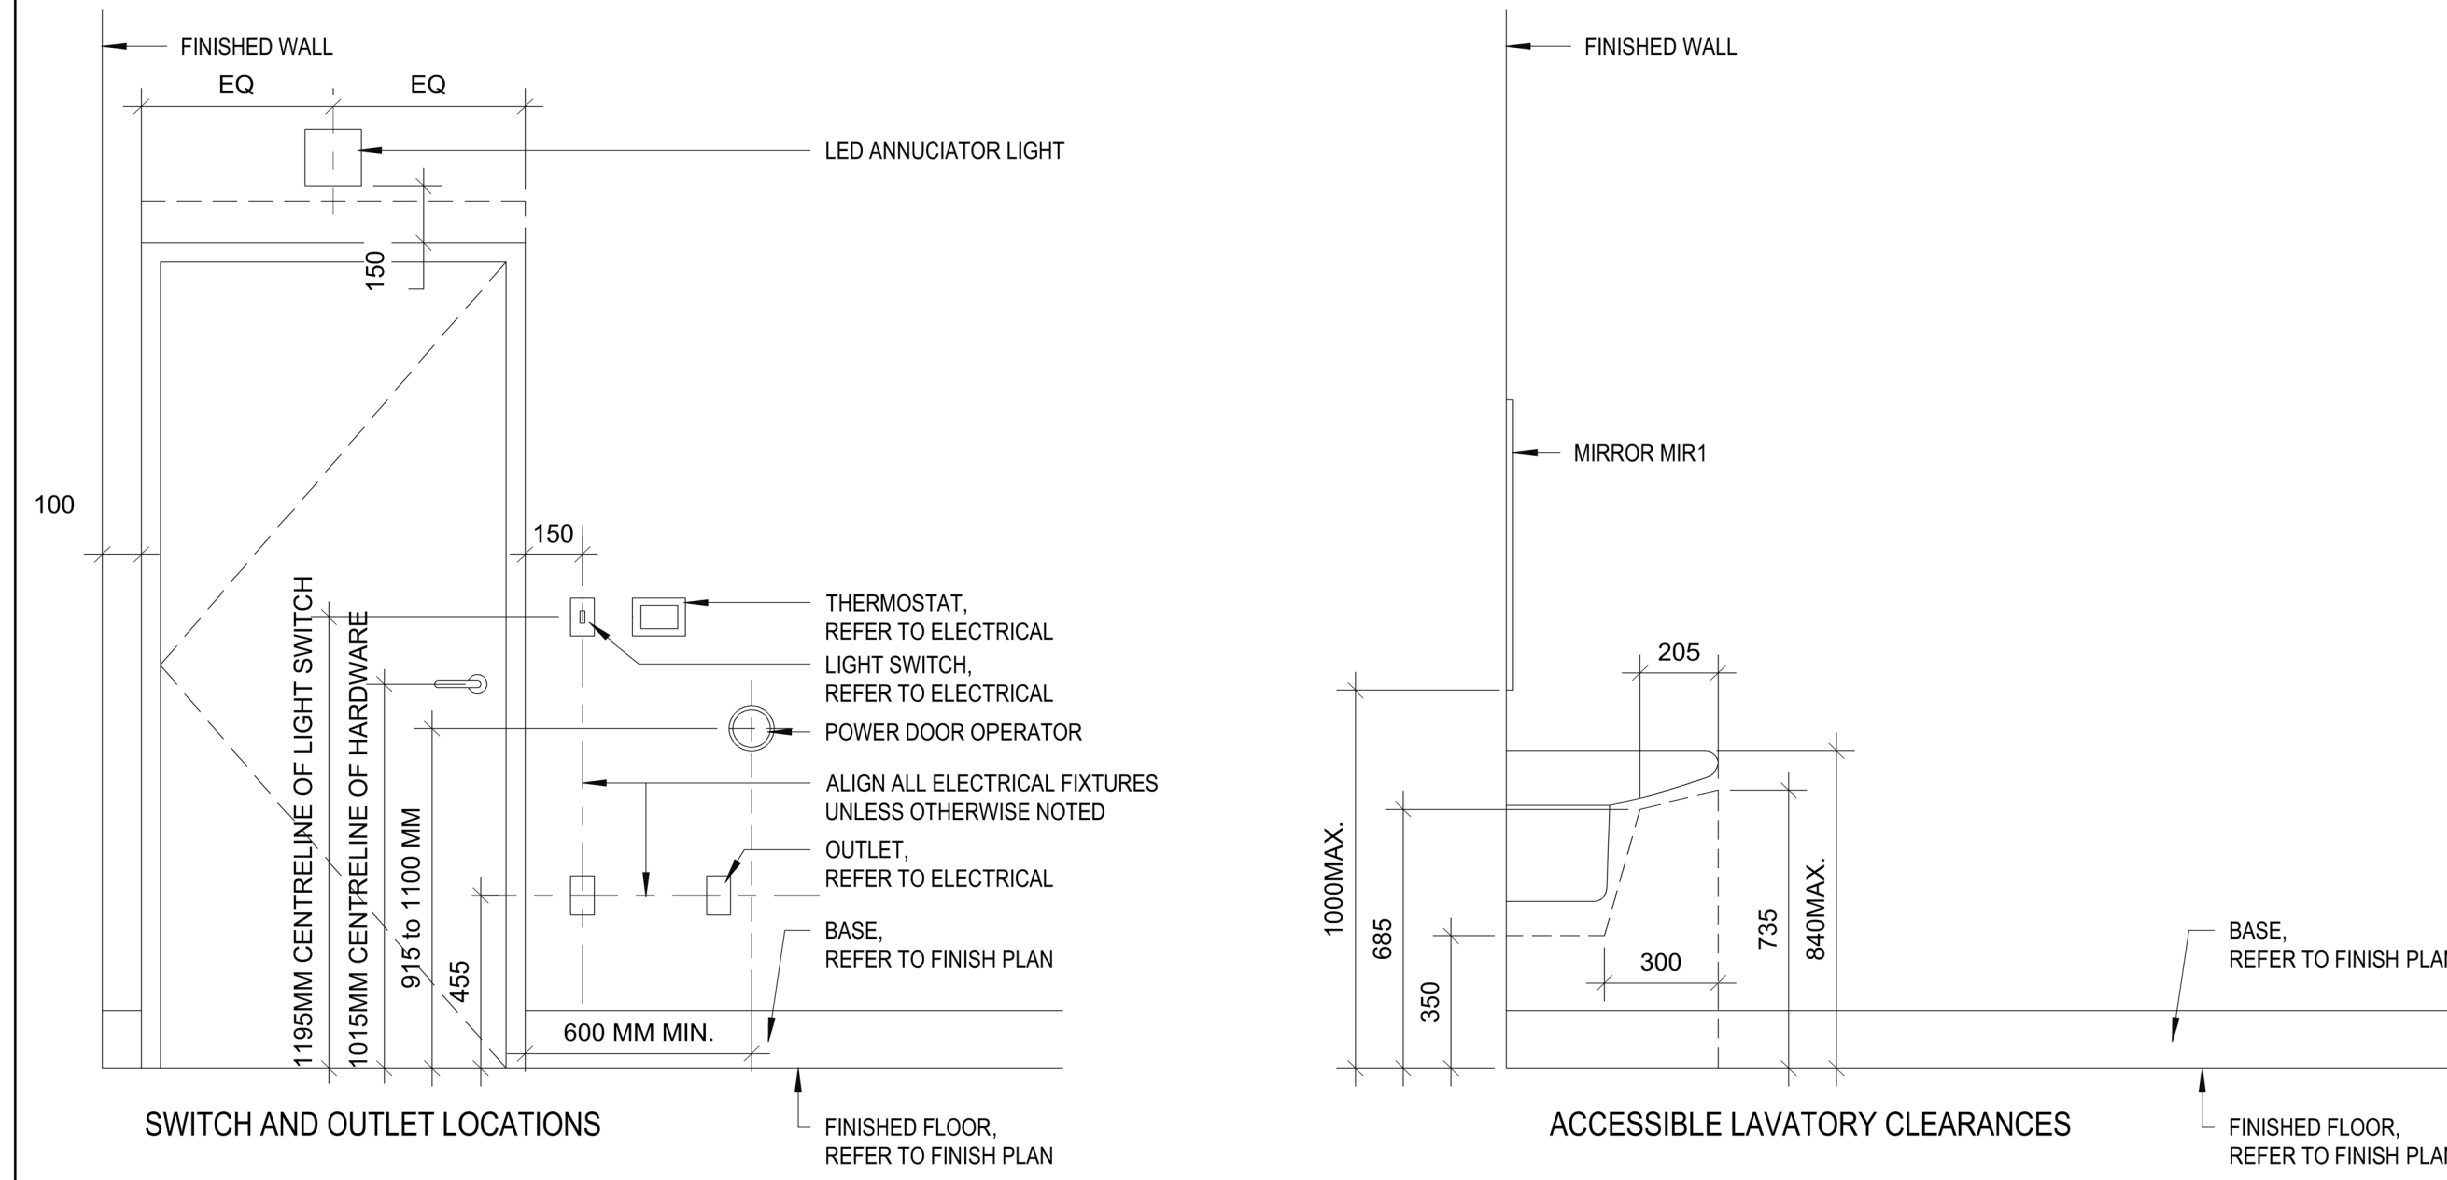

INTERNATIONAL SYMBOL OF ACCESS SIGN NOTES

- LETTER AND NUMERALS SHALL BE ACCORDING WITH THE ADA STANDARDS:
 - TACTILE AND RAISED AT LEAST 0.8mm (703.2.1), NOT SHARPLY EDGED (703.2).
 - SANS SERIF (703.2.3).
 - BE ACCOMPANIED BY UNCONTRACTED BRAILLED (GRADE 1) IN SIGNS WITH LIMITED AMOUNTS OF TEXT (UP TO 15 WORDS), AND ON ALL SIGNS RELATED TO SAFETY.
 - BE ACCOMPANIED BY CONTRACTED BRAILLE (GRADE 2) IN ALL APPLICATION (703.3).
- PICTOGRAMS SHALL BE ACCOMPANIED BY AN EQUIVALENT VISUAL AND TACTILE VERBAL DESCRIPTION, PLACED DIRECTLY BELOW THE PICTOGRAM (703.3.2).
- WHERE PERMANENT IDENTIFICATION IS PROVIDED FOR ROOMS AND SPACES, SIGNS SHALL BE INSTALLED ON THE WALL ADJACENT TO THE LATCH SIDE OF THE DOOR, WHERE THERE IS NOT WALL SPACE THE LATCH SIDE OF THE DOOR, INCLUDING DOUBLE LEAF DOORS, SIGNS SHALL BE PLACED ON THE NEAREST ADJACENT WALL (703.4.2).

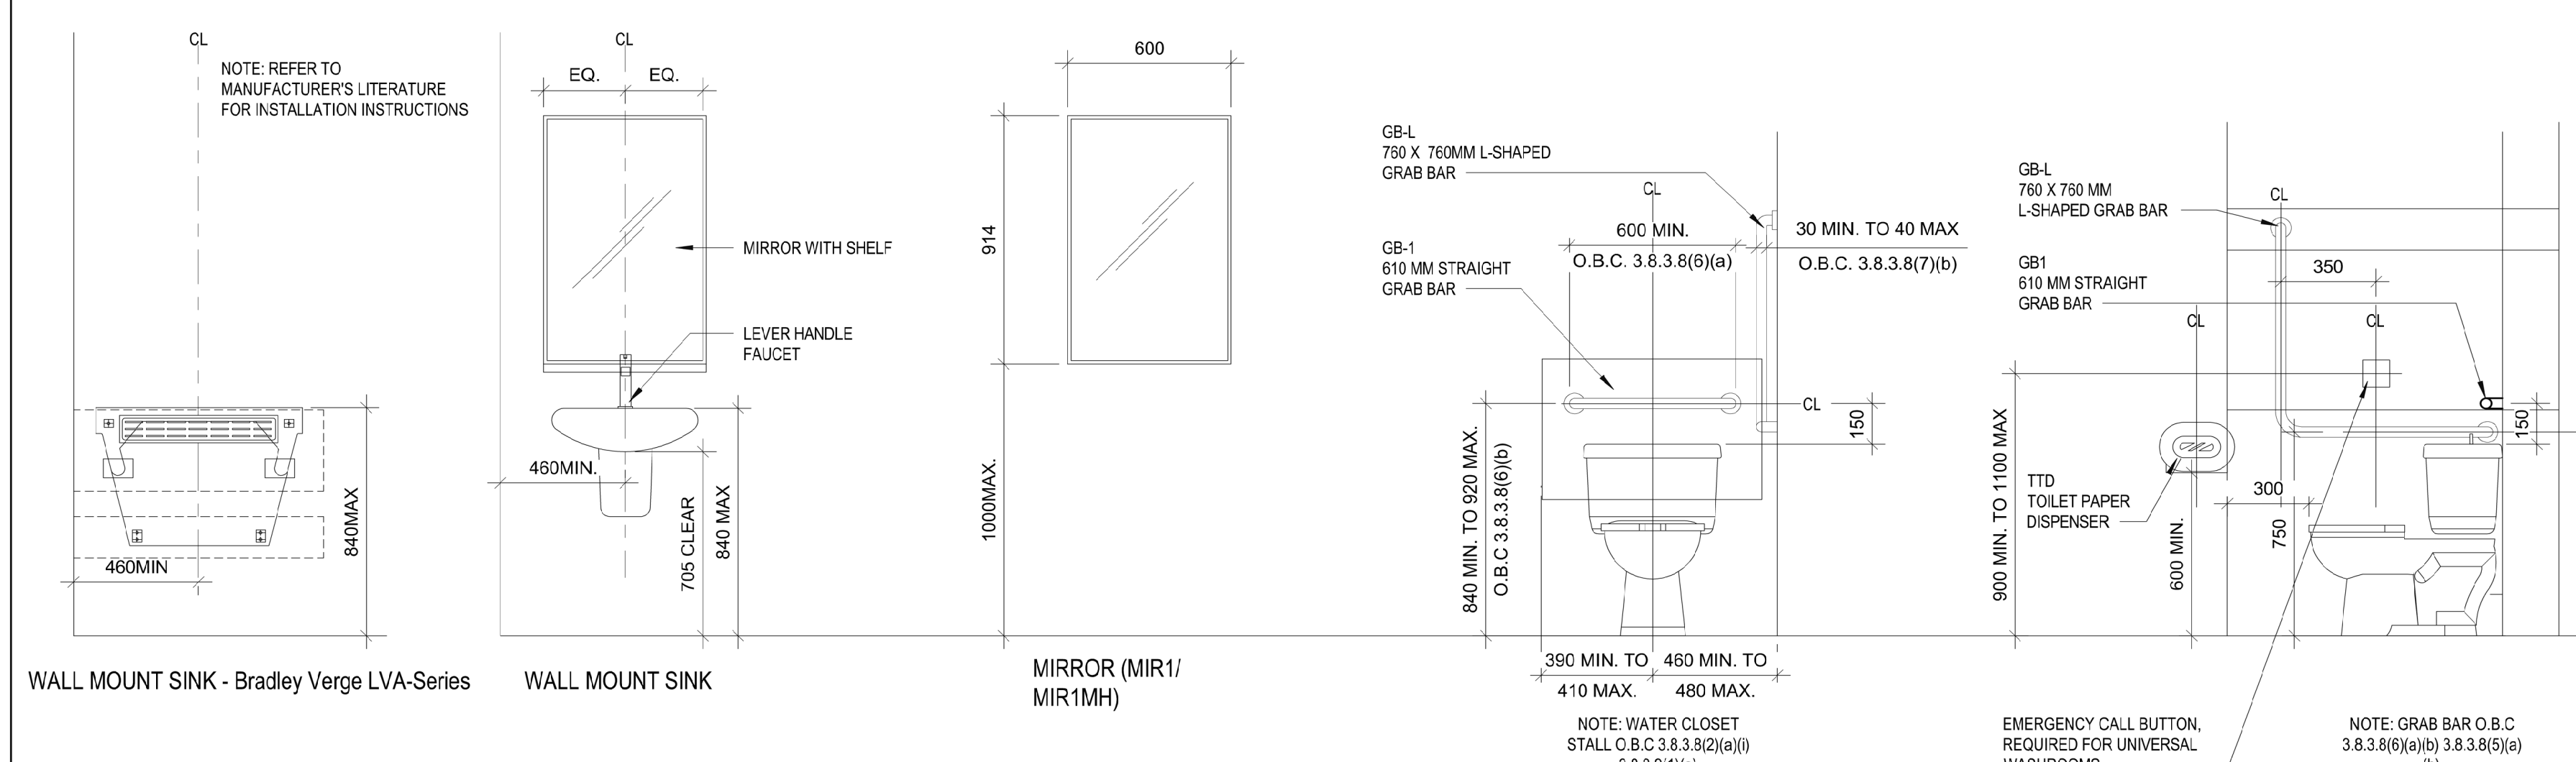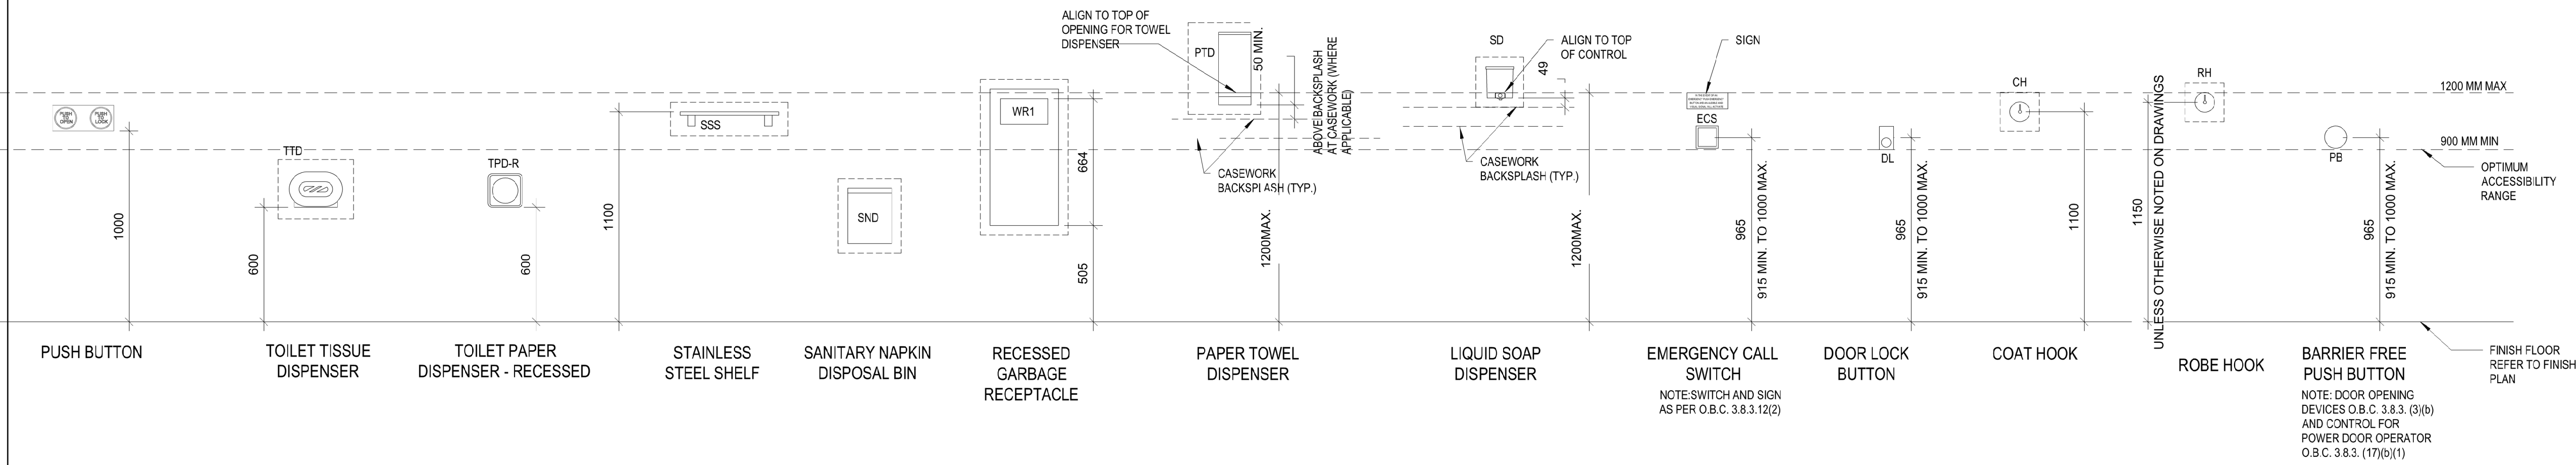

- NOTE:
- ACCESSORIES ARE SCHEMATIC ONLY. REFER TO SPECIFICATIONS FOR SPECIFIED ACCESSORY.
 - CONTRACTOR TO COORDINATE LOCATION OF ACCESSORIES WITH CONSULTANTS PRIOR TO WORK PROCEEDING.
 - GENERAL CONTRACTOR TO PROVIDE ADEQUATE BLOCKING FOR ALL WALL MOUNTED ACCESSORIES.

MIN. 18 GAUGE SHEET METAL BACKING TO SPAN BETWEEN STUDS IN STUD WALLS.

KEY PLAN

LEGEND

ISSUED

DATE	DESCRIPTION	No.
2024-02-15	ISSUE FOR TENDER	1

ALL DRAWINGS, SPECIFICATIONS AND RELATED DOCUMENTATION ARE COPYRIGHT PROPERTY OF 1721 ARCHITECTS INC. AND MUST BE RETURNED UPON REQUEST. REPRODUCTION OF DRAWINGS, SPECIFICATIONS AND RELATED DOCUMENTATION IN PART OR IN WHOLE IS WRITTEN FORBIDDEN WITHOUT THE WRITTEN PERMISSION OF 1721 ARCHITECTS INC.
DO NOT SCALE DRAWINGS
CONTRACTOR MUST CHECK AND VERIFY ALL DIMENSION OF THE JOB.
THIS DRAWING IS NOT TO BE USED FOR CONSTRUCTION UNTIL SIGNED BY THE ARCHITECT

Monsignor Doyle CSS Renovation

185 Myers Rd, Cambridge, ON N1R 7H2

ACCESSORY SCHEDULE MOUNTING HEIGHTS

CHECKED: SD
DRAWN: RN
PROJECT No. 2330

SCALE: AS NOTED

GENERAL NOTES:

- 1- GENERAL CONTRACTOR TO VERIFY LOCATION OF EXISTING PIPES
- 2- GENERAL CONTRACTOR WILL BE RESPONSIBLE TO MAINTAIN THE PIPES AND EXISTING SIDE WALK AND CONCRETE CURB IN GOOD CONDITIONS WHILE THE NEW ASPHALT IS INSTALLED.
- 3- GENERAL CONTRACTOR SHALL CONSTRUCT TEMPORARY MEASURES TO CONTROL SILT ENTERING THE STORM DRAINAGE SYSTEM TO THE SPECIFICATIONS OUTLINED IN THE GUIDELINES ON THE EROSION AND SEDIMENT CONTROL FOR URBAN CONSTRUCTION SITES PREPARED BY THE MINISTRY OF NATURAL RESOURCES.
- 4- MAINTAIN EXISTING GRADES AS INDICATED IN THE DRAWING.
- 5- MAINTAIN EXISTING CATCH BASIN, SIDEWALK, ELECTRIC POST, TO REMAIN.

CONSTRUCTION NOTES:

1. THE CONTRACTOR SHALL TAKE ALL PRECAUTIONARY MEASURES UNDER THE OCCUPATIONAL HEALTH AND SAFETY ACT AS REQUIRED BY THE MINISTRY OF LABOUR.
2. ALL WORK SHALL BE DONE IN ACCORDANCE WITH THE MINIMUM STANDARDS AND SPECIFICATIONS OF THE CITY OF KITCHENER ENGINEER'S DEPARTMENT AND 2012 ONTARIO BUILDING CODE.
3. ALL EXCAVATIONS FOR PROPOSED SERVICES SHALL BE SUPPORTED ON GRANULAR FILL. ALL TOPSOIL, SOFT AND OTHERWISE UNSUITABLE MATERIAL SHALL BE REMOVED AND THE SUBGRADE SHOULD BE PROOF-ROLLED AND INSPECTED BY THE GEOTECHNICAL ENGINEER. ANY LOOSE OR SOFT ZONES NOTED IN THE INSPECTION SHOULD BE EXCAVATED AND REPLACED WITH APPROVED INORGANIC ON-SITE OR IMPORTED FILL. ALL FILL MATERIAL SHOULD BE INSPECTED AND APPROVED BY THE GEOTECHNICAL ENGINEER AND SHOULD BE PLACED IN LIFTS NOT EXCEEDING 200mm THAT ARE COMPACTED TO 95% SPMD (98% FOR PAVED AREAS). THE FILL MATERIAL SHOULD COMPRISE OF CLEAN COMPACTIBLE FILL WITHIN 3% OF THE OPTIMUM MOISTURE CONTENT.
4. PRIOR TO COMMENCING ANY WORK ON THE INSTALLATION OF SERVICES & GRADING, AN APPROVED SET OF PLANS AND SPECIFICATIONS MUST BE AVAILABLE ON THE JOB AND SHALL REMAIN THERE WHILE WORK IS BEING DONE.
5. THE CONTRACTOR SHALL CONSTRUCT TEMPORARY MEASURES TO CONTROL SILT ENTERING THE STORM DRAINAGE SYSTEM TO THE SPECIFICATIONS OUTLINED IN THE GUIDELINES ON EROSION AND SEDIMENT CONTROL FOR URBAN CONSTRUCTION SITES PREPARED BY THE MINISTRY OF NATURAL RESOURCES. THESE MEASURES ARE TO BE INSTALLED PRIOR TO COMMENCING ANY CONSTRUCTION FOR THIS PROJECT AND ARE TO REMAIN IN PLACE UNTIL CONSTRUCTION HAS BEEN COMPLETED TO THE SPECIFICATIONS OF THE CITY ENGINEER.
6. ALL SURFACES WHICH ARE DISTURBED DURING CONSTRUCTION SHALL BE RESTORED TO A CONDITION AT LEAST AS GOOD AS ORIGINAL OR AS PER BELOW (WHICHEVER IS GREATER) OR IF WITHIN THE CITY RIGHT OF WAY TO THE SATISFACTION OF THE CLIENT, ALL AT NO COST TO THE CLIENT.
 - 6.1. GRASSED AREAS TO BE RESTORED w/ 100mm TOPSOIL + SOD
 - 6.2. CONCRETE SIDEWALK TO C&I STANDARD SR-1.0.
 - 6.3. CONCRETE CURB AND GUTTER AS SPECIFIED.
 - 6.4. ANY ASPHALT AREA DISTURBED DURING CONSTRUCTION SHALL BE RESTORED AS FOLLOWS:
 - 6.4.1. PROOF ROLL SUBGRADE (TO THE SATISFACTION OF THE GEOTECHNICAL ENGINEER) PRIOR TO PLACEMENT OF GRANULARS (98% SPMD MIN.).
 - 6.4.2. MILL ADJACENT ASPHALT TO BE TIED INTO 50mm DEEP x 500mm WIDE PRIOR TO RESTORATION SEE DETAIL ON SHEET C1.
 - 6.4.3. MIN. RECOMMENDED HEAVY DUTY PAVEMENT STRUCTURE (CLIENT TO PROVIDE GEOTECHNICAL REPORT)
 - 50mm HL3 SURFACE ASPHALT COMPACTED TO 92% MAXIMUM RELATIVE DENSITY
 - 60mm HL8 BINDER ASPHALT COMPACTED TO 92% MAXIMUM RELATIVE DENSITY
 - ASPHALT TO BE SUPPLIED AND PLACED IN ACCORDANCE WITH OPSS 310 & 1150
7. SEPARATION BETWEEN BURIED W&C & P&C AS PER M.O.E. GUIDELINES AND SECTION 7.3.5.7. OF THE O.B.C.
8. WHEN CROSSING ABOVE A SANITARY/STORM SEWER THE CONTRACTOR IS TO ENSURE A MINIMUM 0.5m VERTICAL SEPARATION FROM THE UNDERSIDE OF THE WATER SERVICE TO THE TOP OF THE SEWER AS OUTLINED IN THE LATEST EDITION OF THE M.O.E. "DESIGN GUIDELINES FOR DRINKING-WATER SYSTEMS" AND INSULATE WATER SERVICE AS PER DETAIL ON THIS SHEET, WHERE REQUIRED.
9. ALL ORGANIC, UNSTABLE OR UNSUITABLE MATERIALS BENEATH THE ROAD ALLOWANCE OR FOUNDATIONS MUST BE REMOVED AND THESE AREAS BACK FILLED WITH AN APPROVED FILL MATERIAL, ALL TO THE SATISFACTION OF A GEOTECHNICAL ENGINEER.
10. ALL LINE PAINTING TO BE COMPLETED IN ACCORDANCE WITH OPSS 710 'CONSTRUCTION SPECIFICATION FOR PAVEMENT MARKING'.
11. REFER TO THE SITE PLAN FOR LAYOUT DIMENSIONING AND SIGN/POST DETAILS.
12. ALL CATCH BASINS TO REMAIN.
13. SLOPE ASPHALT PAVING TO ALL EXISTING CATCH BASIN.
14. SLOPE ALL TO MATCH EXISTING GRADES.

EROSION AND SEDIMENT CONTROL


- 1.1. CONTRACTOR TO INSTALL EROSION CONTROL MEASURES AS SHOWN PRIOR TO CONSTRUCTION AND MAINTAIN IN GOOD CONDITION UNTIL CONSTRUCTION IS COMPLETED AND VEGETATIVE COVER IS ESTABLISHED.
- 1.2. ALL SILT FENCING TO BE INSTALLED PRIOR TO ANY AREA GRADING, EXCAVATING OR DEMOLITION COMMENCING.
- 1.3. EROSION CONTROL FENCING TO BE INSTALLED AROUND BASE OF ALL STOCKPILES.
- 1.4. EROSION PROTECTION TO BE PROVIDED AROUND ALL STORM AND SANITARY MHS AND CBS.
- 1.5. ADDITIONAL EROSION CONTROL MEASURES MAY BE REQUIRED AS SITE DEVELOPMENT PROGRESSES. CONTRACTOR TO PROVIDE ALL ADDITIONAL EROSION CONTROL STRUCTURES.
- 1.6. EROSION CONTROL STRUCTURES TO REMAIN IN PLACE UNTIL ALL DISTURBED GROUND SURFACES HAVE BEEN RE-STABILIZED.
- 1.7. NO ALTERNATE METHODS OF EROSION PROTECTION SHALL BE PERMITTED UNLESS APPROVED BY THE ENGINEER AND THE DEPARTMENT OF PUBLIC WORKS.
- 1.8. CONTRACTOR TO CLEAN ROADWAY AND SIDEWALKS OF SEDIMENTS RESULTING FROM CONSTRUCTION TRAFFIC FROM THE SITE EACH DAY.
- 1.9. CONTRACTOR MUST REMOVE EROSION AND SEDIMENTATION FENCING PRIOR TO COMPLETION OF PROJECT. CONTRACTOR TO HAVE EROSION AND SEDIMENTATION FENCE INSPECTED WHEN VEGETATION HAS ESTABLISHED, BUT PRIOR TO FENCE BECOMING OVERGROWN. ENGINEER'S REPRESENTATIVE TO DETERMINE IF VEGETATION HAS REACHED THE CRITICAL POINT AND WILL THEN INSTRUCT CONTRACTOR TO REMOVE FENCE.

LEGENDS:

- NEW HEAVY DUTY ASPHALT TO BE APPLIED ON TOP OF EXISTING GRANULAR 'A'. APPROX. AREA = 10,236 SQ.M
- INSTALL NEW ASPHALT SPEED BREAKER. MINIMUM 50mm HIGH. ALL ASPHALT SPEED BREAKERS TO BE PAINTED WITH DURABLE YELLOW PAINT.

PAVEMENT STRUCTURE:


MATERIAL	RECOMMENDED THICKNESS
ASPHALTIC CONCRETE	HEAVY TRAFFIC
HL3	50mm
HLB	60mm

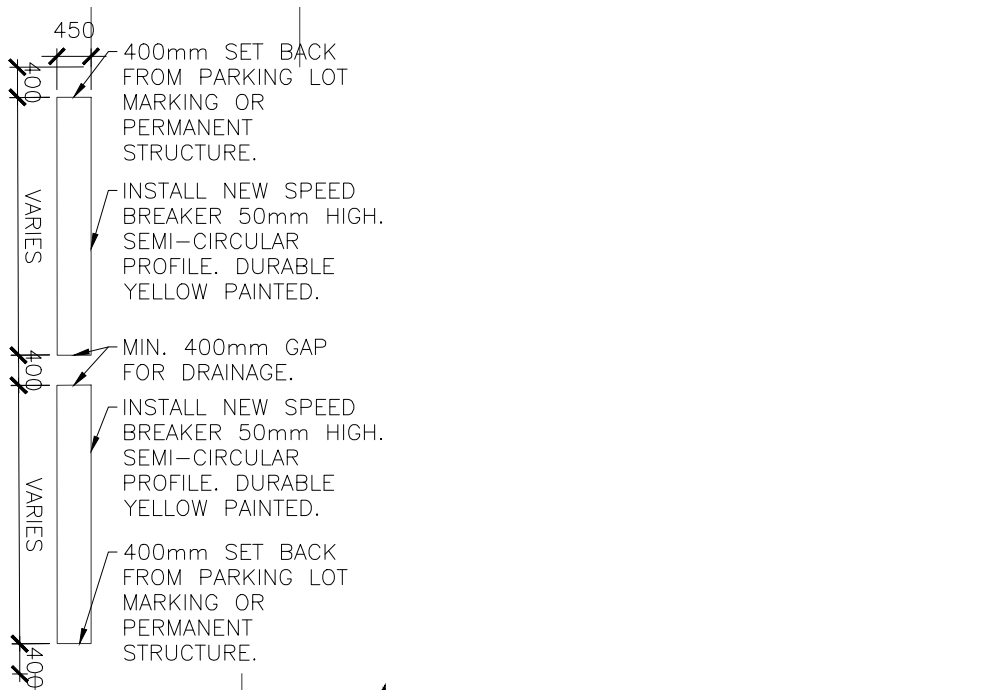


02 ASPHALT SPEED BREAKER DETAIL TYPICAL 1:100

CHRISTOPHER DRIVE

01 SITE PLAN 1:500

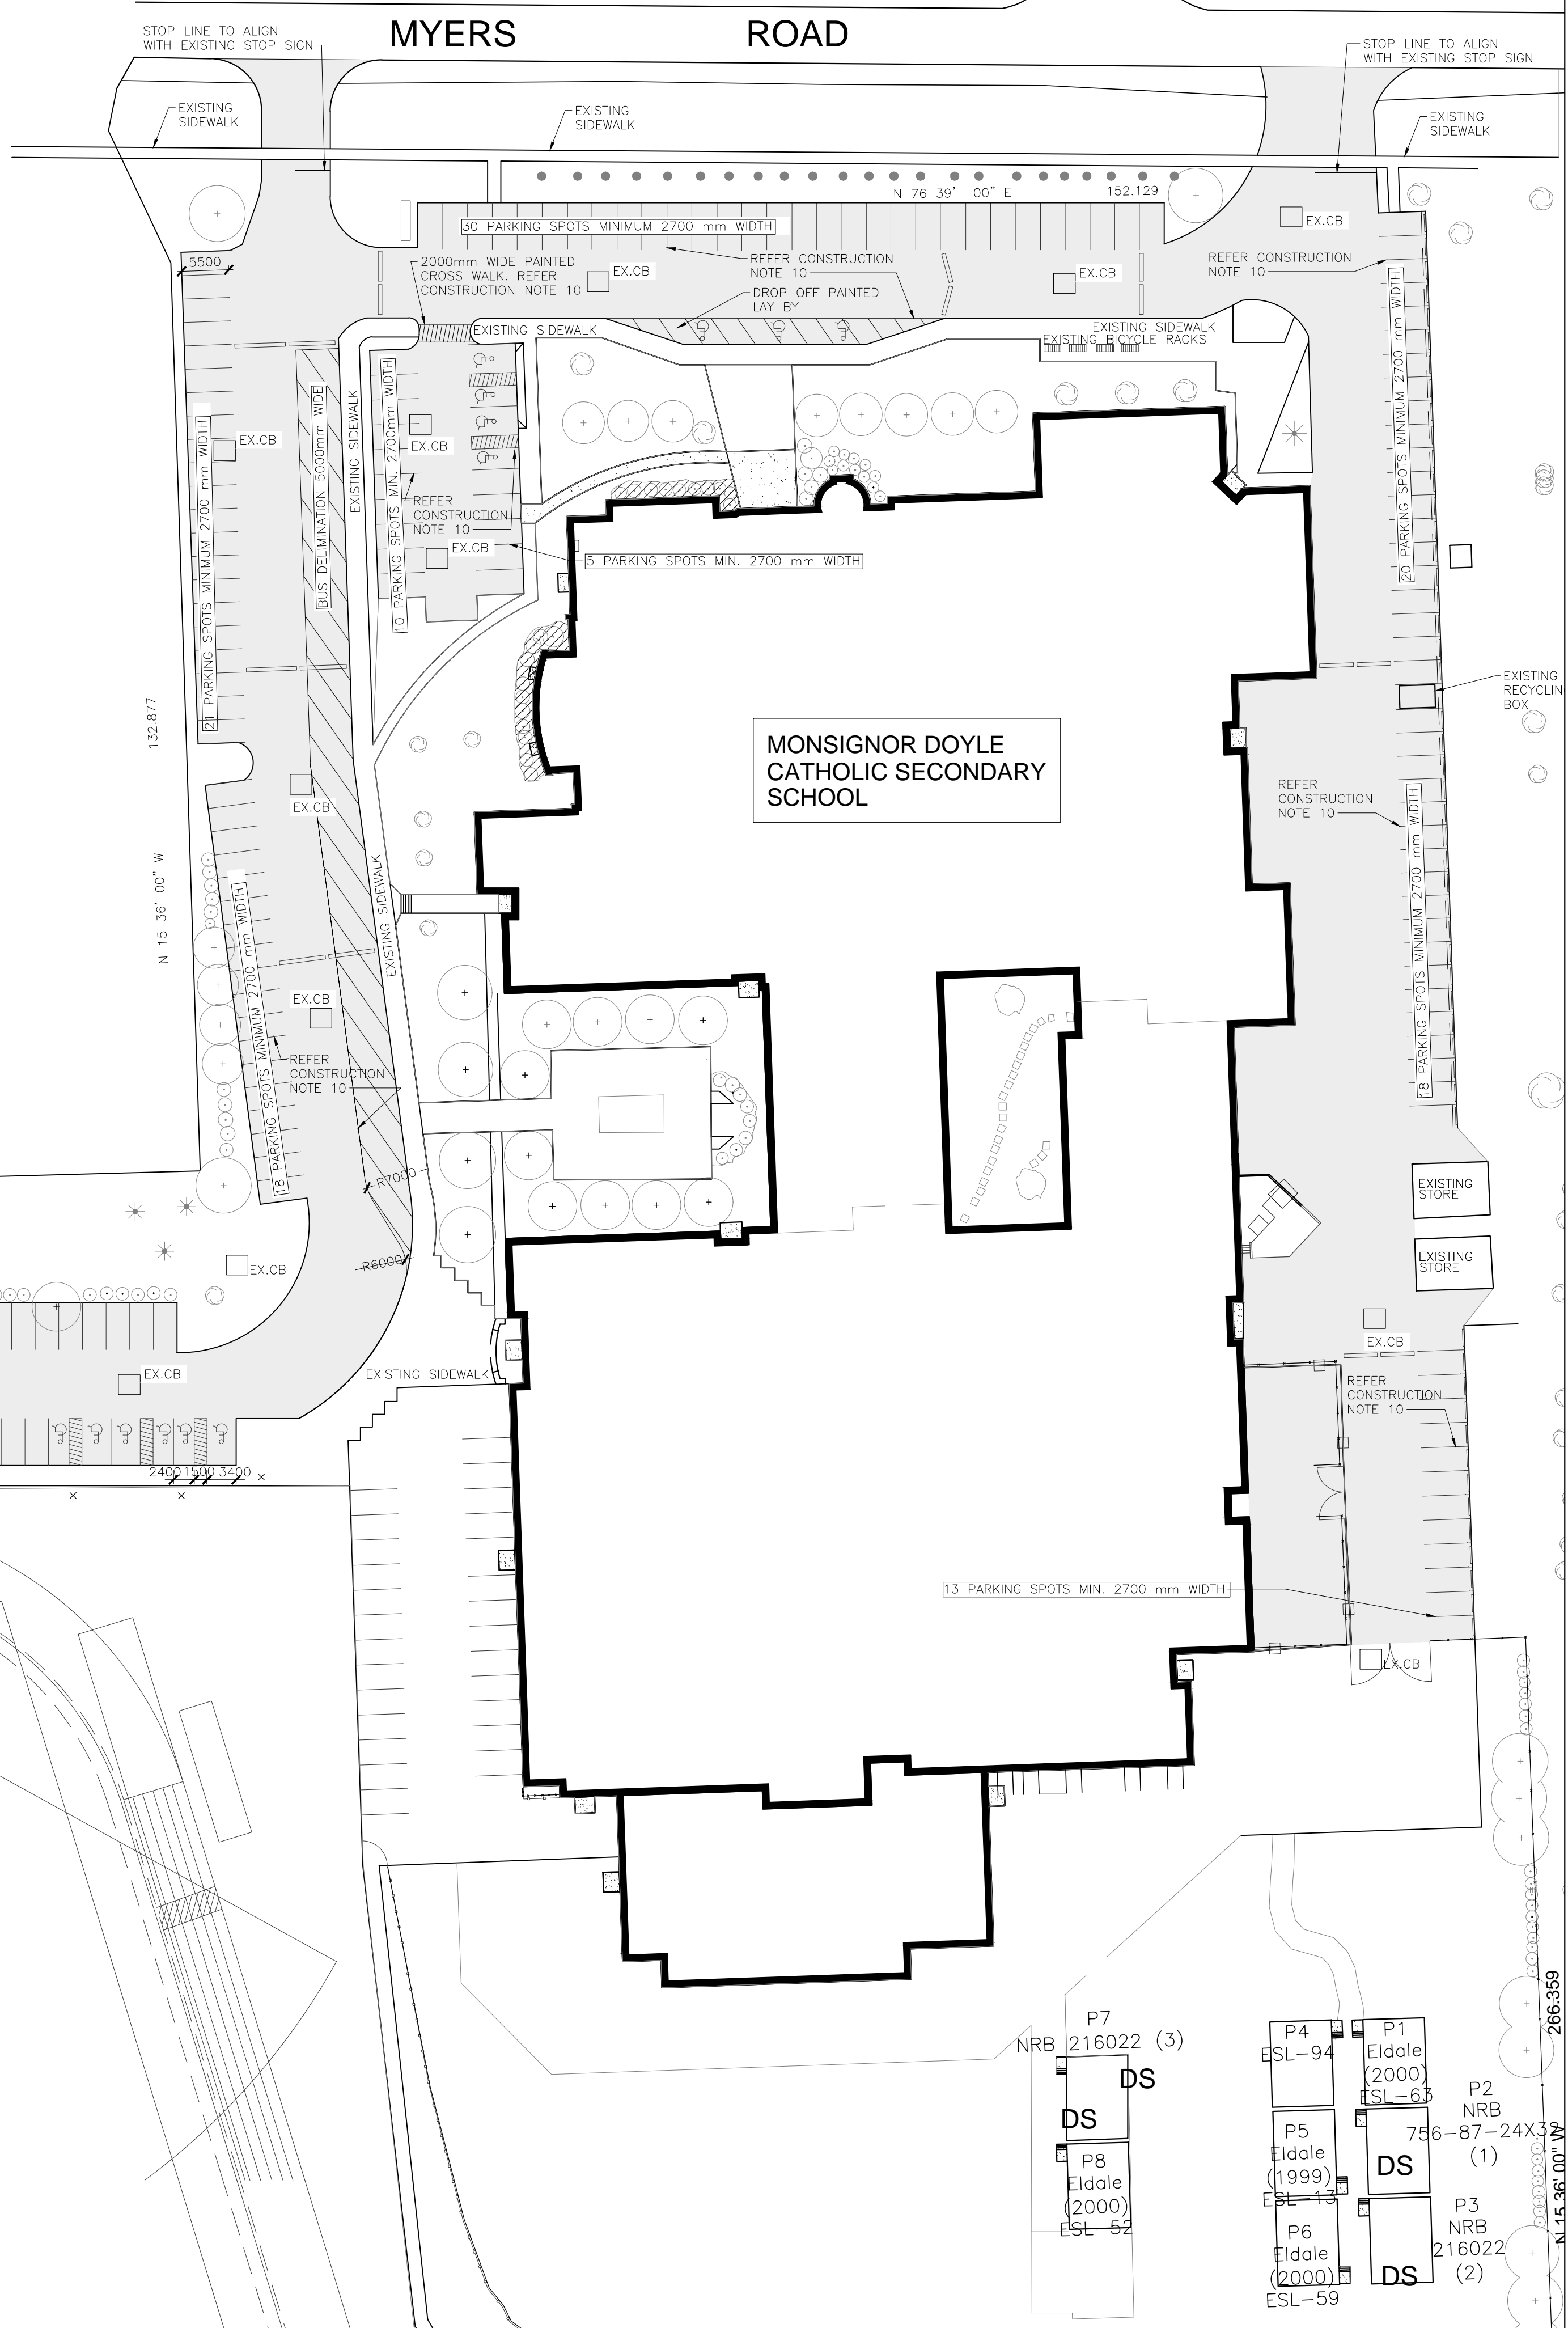

KEY PLAN

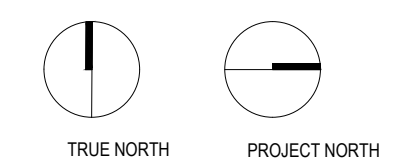

LEGEND

ISSUED

DATE	DESCRIPTION	No.
2024-02-15	ISSUE FOR TENDER	1

ALL DRAWINGS, SPECIFICATIONS AND RELATED DOCUMENTATION ARE COPYRIGHT PROPERTY OF 1721 ARCHITECTS INC. AND MUST BE RETURNED UPON REQUEST. REPRODUCTION OF DRAWINGS, SPECIFICATIONS AND RELATED DOCUMENTATION IN PART OR IN WHOLE IS WRITTEN FORBIDDEN WITHOUT THE WRITTEN PERMISSION OF 1721 ARCHITECTS INC.
 DO NOT SCALE DRAWINGS
 CONTRACTOR MUST CHECK AND VERIFY ALL DIMENSION OF THE JOB.
 THIS DRAWING IS NOT TO BE USED FOR CONSTRUCTION UNTIL SIGNED BY THE ARCHITECT

Monsignor Doyle CSS

185 Myers Rd, Cambridge, ON N1R 7H2

SITE PLAN

CHECKED: SD
 DRAWN: RN
 PROJECT No. 2330

SCALE: AS NOTED

A050

GENERAL NOTES:

- A. REMOVE ALL WIRING FROM ELECTRICAL ITEMS THAT WILL BE REMOVED AND ALL REDUNDANT CONDUIT BACK TO NEAREST JUNCTION BOX THAT WILL REMAIN, AND MAKE SAFE. INSTALL METAL COVER PLATES OVER EXPOSED OPENINGS AND ELECTRICAL BOXES. REFER TO ELECTRICAL FOR ADDITIONAL REQUIREMENTS.
- B. MAKE GOOD ALL AREAS AFFECTED BY REMOVALS - FLUSH TO ADJACENT SURFACE AND MATCH EXISTING FINISH.
- C. DISPOSE OF ALL DESIGNATED SUBSTANCES TO THE REQUIREMENTS OF AUTHORITIES HAVING JURISDICTION.
- D. ALL PIPING THAT IS TO BE REMOVED OR ABANDONED IS TO BE REMOVED BACK TO THE NEAREST JUNCTION AND CAPPED. REFER TO MECHANICAL FOR ADDITIONAL REQUIREMENTS.
- E. NOTE ALL EXISTING ITEMS MAY NOT BE SHOWN ON THESE DRAWINGS. A CAREFUL REVIEW OF THE SITE IS REQUIRED TO DETERMINE THE FULL EXTENT OF THE WORK SHOWN.
- F. THE ARCHITECTURAL DRAWINGS ARE TO BE READ IN CONJUNCTION WITH ALL PROJECT MANUALS, STRUCTURAL, CIVIL, MECHANICAL AND ELECTRICAL DRAWINGS. IN CASE OF DIFFERENCES BETWEEN CONSULTANTS' DOCUMENTS WITH RESPECT TO QUANTITY, SIZES OR SCOPE, THE GREATER SHALL APPLY.
- G. PROVIDE PROTECTION FOR ALL FINISHES OR SERVICES TO REMAIN.
- H. ALL WINDOWS FALLING WITHIN THE DEMOLITION AREA ARE TO HAVE COVERINGS, THEIR FITTINGS, MOUNTING HARDWARE REMOVED & RETURNED TO THE OWNER, OR DISPOSE AS DIRECTED BY THE OWNER.
- I. DEMOLITION NOTE REFERENCE NUMBERS, WHERE LOCATED ADJACENT TO A ROOM NAME/NUMBER APPLY TO THE ENTIRETY OF THE ROOM.
- J. GENERAL CONTRACTOR IS TO ALLOW FOR THE SUPPLY AND INSTALLATION OF LOOSE LINTELS AS REQUIRED WHERE NEW OPENINGS ARE BEING CREATED OR WIDENED. REFER TO THE LOOSE LINTEL SCHEDULE PROVIDED ON THE DRAWINGS, OR PROVIDE ENGINEERING WHERE THERE ARE NO STRUCTURAL DRAWINGS / SCHEDULE.
- K. GC IS REQUIRED TO REMOVE ALL REMAINING ADHESIVES ON WALLS WHERE COMMUNICATION BOARDS WERE REMOVED UNLESS BEING COVERED WITH NEW BOARDS. TYPICAL FOR ALL ROOMS AFFECTED BY WORK.
- L. EXISTING LED BALLASTS AND BULBS TO BE TURNED OVER TO OWNER (COORDINATE WITH M&E).
- M. ALL WORK TO BE COORDINATED WITH THE ASBESTOS CONSULTANT'S DESIGNATED SUBSTANCES REPORT AND SCOPE OF WORK HOLDER ASSOCIATES LTD. IS THE BOARD'S ASBESTOS CONSULTANT.
- N. REFER TO OTHER NOTES ON SHEET A-100, A-101, A-102, A-103, A105

LEGENDS:

- DEMOLITION NOTE REFERENCE NUMBER
- ▬ LOCATION OF HOARDING
- PORTION OF EXISTING MASONRY/DRYWALL PARTITION TO BE REMOVED.
- PORTION OF EXISTING FLOOR FINISH TO BE REMOVED.
- APPROXIMATE EXTENT OF EXISTING WALLS AND STRUCTURE TO REMAIN.
- APPROXIMATE EXTENT OF AREAS WHERE NO WORK IS REQUIRED.
- ⤵ EXISTING DOOR & FRAME TO BE REMOVED
- ⤵ EXISTING DOOR & FRAME


DEMOLITION NOTES:

- 1 EXISTING FLOOR FINISHES AND WALL BASE TO BE REMOVED INCLUDING ALL ADHESIVES AND MORTAR DOWN TO EXISTING FLOOR BASE AND WALL BACKING BY MEANS OF GRINDING. PREPARE FLOOR AND MAKE READY TO RECEIVE NEW FINISHES. PROVIDE ANY AND ALL REMEDIAL WORK TO WALL.
- 2 EXISTING MILLWORK TO BE REMOVED, WHERE MILLWORK IS REMOVED, CLEAN AND PATCH THE WALL, FLOOR TO RECEIVE NEW FINISH.
- 3 EXISTING PLUMBING FIXTURES TO BE REMOVED. (REFER MECHANICAL DRAWINGS.)
- 4 EXISTING URINAL TO BE REMOVED, CLEAN AND PATCH THE WALL TO RECEIVE NEW FINISH. (REFER MECHANICAL DRAWINGS.)
- 5 EXISTING MIRROR, HAND DRYER, SOAP DISPENSER, PAPER TOWEL DISPENSER, WASTE RECEPTACLE, NOTES, GRAB BARS, EMERGENCY CALL SWITCH AND CURTAIN RODS TO BE REMOVED, CLEAN AND PATCH WALL TO RECEIVE NEW FINISH. (REFER M&E DRAWINGS.)
- 6 EXISTING DOOR AND SCREEN TO BE REMOVED, WHERE DOOR AND SCREEN IS REMOVED, CLEAN AND PATCH OPENING TO RECEIVE NEW DOOR AND SCREEN. REFER TO NEW CONSTRUCTION PLANS AND ELEVATIONS. (REFER ELECTRICAL DRAWINGS.)
- 7 MAKE NEW OPENING (1000mm X 2135mm) ON THE EXISTING WALL, CLEAN AND PATCH WALL OPENING SURFACE TO RECEIVE NEW FINISH.
- 8 EXISTING LIFT TRACK AND MOTOR TO REMAIN. (REFER ELECTRICAL DRAWINGS)
- 9 EXISTING DOOR TO BE REMOVED, WHERE DOOR IS REMOVED PREPARE DOOR FRAME TO RECEIVE NEW PAINT AND NEW DOOR. (REFER OPENING SCHEDULES).
- 10 EXISTING DOOR AND FRAME TO BE REMOVED, WHERE DOOR AND FRAME IS REMOVED, CLEAN AND PATCH THE EXISTING WALL TO RECEIVE NEW WORK. (REFER FLOOR PLAN A103).
- 11 EXISTING WALL TO BE DEMOLISHED AS SHOWN, PATCH, REPAIR AND MAKE GOOD EXISTING WALL, FLOOR TO RECEIVE NEW FINISH. PROVIDE ANY REMEDIAL WORK TO EXISTING CEILING TO RECEIVE NEW CEILING TILE. (REFER FLOOR PLAN A101).
- 12 G.C TO CAREFULLY REMOVE ANY WALL HANGING ITEMS AND STORE IT FOR RE-INSTALLATION, PATCH, REPAIR AND MAKE GOOD WALL SURFACE TO RECEIVE NEW FINISH.
- 13 EXISTING COUNTER TOP TO BE REMOVED, WHERE COUNTER TOP IS REMOVED, CLEAN AND PATCH THE WALL, FLOOR TO RECEIVE NEW FINISH.
- 14 EXISTING ACOUSTIC CEILING TO BE CUT AND REMOVED AS SHOWN.
- 15 EXISTING LOCATION OF THE CEILING MOUNTED LIGHT TO BE REMOVED AND RELOCATED. (REFER ELECTRICAL DRAWINGS).
- 16 EXISTING ROUGH OPENING TO BE WIDENED TO 1065mm, ALSO REFER INSTRUCTIONS AT DETAIL 01/A-200



01 DEMO. FIRST FLOOR PLAN - BLOCK A
1:150

KEY PLAN

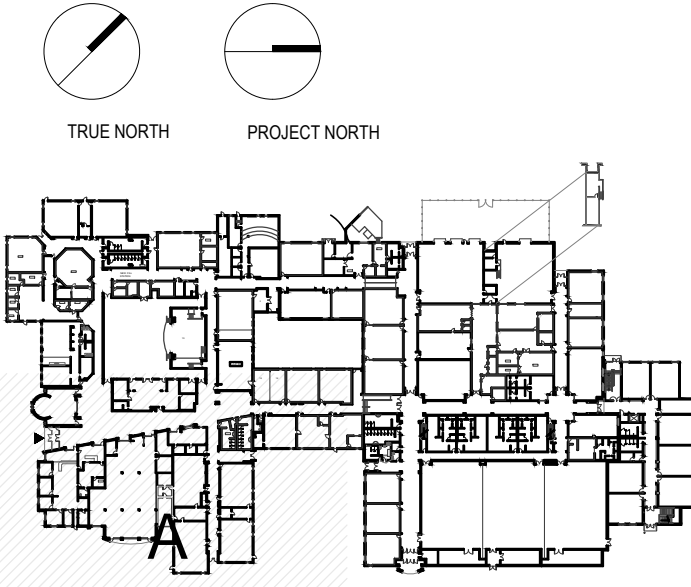

LEGEND

ISSUED

DATE	DESCRIPTION	No.
2024-02-15	ISSUE FOR TENDER	1

ALL DRAWINGS, SPECIFICATIONS AND RELATED DOCUMENTATION ARE COPYRIGHT PROPERTY OF 1721 ARCHITECTS INC. AND MUST BE RETURNED UPON REQUEST. REPRODUCTION OF DRAWINGS, SPECIFICATIONS AND RELATED DOCUMENTATION IN PART OR IN WHOLE IS WRITTEN FORBIDDEN WITHOUT THE WRITTEN PERMISSION OF 1721 ARCHITECTS INC.
DO NOT SCALE DRAWINGS
CONTRACTOR MUST CHECK AND VERIFY ALL DIMENSION OF THE JOB.
THIS DRAWING IS NOT TO BE USED FOR CONSTRUCTION UNTIL SIGNED BY THE ARCHITECT

Monsignor Doyle CSS

185 Myers Rd, Cambridge, ON N1R 7H2

DRAWING TITLE:
DEMO. FIRST FLOOR PLAN - BLOCK A

CHECKED: SD
DRAWN: RN
PROJECT No. 2330

SCALE: AS NOTED

D100

DATE PLOTTED: YYYY.MM.DD

GENERAL NOTES:


- A. REMOVE ALL WIRING FROM ELECTRICAL ITEMS THAT WILL BE REMOVED AND ALL REDUNDANT CONDUIT BACK TO NEAREST JUNCTION BOX THAT WILL REMAIN, AND MAKE SAFE. INSTALL METAL COVER PLATES OVER EXPOSED OPENINGS AND ELECTRICAL BOXES. REFER TO ELECTRICAL FOR ADDITIONAL REQUIREMENTS.
- B. MAKE GOOD ALL AREAS AFFECTED BY REMOVALS - FLUSH TO ADJACENT SURFACE AND MATCH EXISTING FINISH.
- C. DISPOSE OF ALL DESIGNATED SUBSTANCES TO THE REQUIREMENTS OF AUTHORITIES HAVING JURISDICTION.
- D. ALL PIPING THAT IS TO BE REMOVED OR ABANDONED IS TO BE REMOVED BACK TO THE NEAREST JUNCTION AND CAPPED. REFER TO MECHANICAL FOR ADDITIONAL REQUIREMENTS.
- E. NOTE ALL EXISTING ITEMS MAY NOT BE SHOWN ON THESE DRAWINGS. A CAREFUL REVIEW OF THE SITE IS REQUIRED TO DETERMINE THE FULL EXTENT OF THE WORK SHOWN.
- F. THE ARCHITECTURAL DRAWINGS ARE TO BE READ IN CONJUNCTION WITH ALL PROJECT MANUALS, STRUCTURAL, CIVIL, MECHANICAL AND ELECTRICAL DRAWINGS. IN CASE OF DIFFERENCES BETWEEN CONSULTANTS' DOCUMENTS WITH RESPECT TO QUANTITY, SIZES OR SCOPE, THE GREATER SHALL APPLY.
- G. PROVIDE PROTECTION FOR ALL FINISHES OR SERVICES TO REMAIN.
- H. ALL WINDOWS FALLING WITHIN THE DEMOLITION AREA ARE TO HAVE COVERINGS, THEIR FITTINGS, MOUNTING HARDWARE REMOVED & RETURNED TO THE OWNER, OR DISPOSE AS DIRECTED BY THE OWNER.
- I. DEMOLITION NOTE REFERENCE NUMBERS, WHERE LOCATED ADJACENT TO A ROOM NAME/NUMBER APPLY TO THE ENTIRETY OF THE ROOM.
- J. GENERAL CONTRACTOR IS TO ALLOW FOR THE SUPPLY AND INSTALLATION OF LOOSE LINTELS AS REQUIRED WHERE NEW OPENINGS ARE BEING CREATED OR WIDENED. REFER TO THE LOOSE LINTEL SCHEDULE PROVIDED ON THE DRAWINGS, OR PROVIDE ENGINEERING WHERE THERE ARE NO STRUCTURAL DRAWINGS / SCHEDULE.
- K. GC IS REQUIRED TO REMOVE ALL REMAINING ADHESIVES ON WALLS WHERE COMMUNICATION BOARDS WERE REMOVED UNLESS BEING COVERED WITH NEW BOARDS. TYPICAL FOR ALL ROOMS AFFECTED BY WORK.
- L. EXISTING LED BALLASTS AND BULBS TO BE TURNED OVER TO OWNER (COORDINATE WITH M&E).
- M. ALL WORK TO BE COORDINATED WITH THE ASBESTOS CONSULTANT'S DESIGNATED SUBSTANCES REPORT AND SCOPE OF WORK HOLDER ASSOCIATES LTD. IS THE BOARD'S ASBESTOS CONSULTANT.
- N. REFER TO OTHER NOTES ON SHEET A-100, A-101, A-102, A-103, A105

LEGENDS:

- DEMOLITION NOTE REFERENCE NUMBER
- ▬ LOCATION OF HOARDING
- PORTION OF EXISTING MASONRY/DRYWALL PARTITION TO BE REMOVED.
- PORTION OF EXISTING FLOOR FINISH TO BE REMOVED.
- ▨ APPROXIMATE EXTENT OF EXISTING WALLS AND STRUCTURE TO REMAIN.
- ▨ APPROXIMATE EXTENT OF AREAS WHERE NO WORK IS REQUIRED.
- ⤵ EXISTING DOOR & FRAME TO BE REMOVED
- ⤵ EXISTING DOOR & FRAME


DEMOLITION NOTES:

- 1 EXISTING FLOOR FINISHES AND WALL BASE TO BE REMOVED INCLUDING ALL ADHESIVES AND MORTAR DOWN TO EXISTING FLOOR BASE AND WALL BACKING BY MEANS OF GRINDING. PREPARE FLOOR AND MAKE READY TO RECEIVE NEW FINISHES. PROVIDE ANY AND ALL REMEDIAL WORK TO WALL.
- 2 EXISTING MILLWORK TO BE REMOVED. WHERE MILLWORK IS REMOVED, CLEAN AND PATCH THE WALL, FLOOR TO RECEIVE NEW FINISH.
- 3 EXISTING PLUMBING FIXTURES TO BE REMOVED. (REFER MECHANICAL DRAWINGS.)
- 4 EXISTING URINAL TO BE REMOVED. CLEAN AND PATCH THE WALL TO RECEIVE NEW FINISH. (REFER MECHANICAL DRAWINGS.)
- 5 EXISTING MIRROR, HAND DRYER, SOAP DISPENSER, PAPER TOWEL DISPENSER, WASTE RECEPTACLE, NOTES, GRAB BARS, EMERGENCY CALL SWITCH AND CURTAIN RODS TO BE REMOVED. CLEAN AND PATCH WALL TO RECEIVE NEW FINISH. (REFER M&E DRAWINGS.)
- 6 EXISTING DOOR AND SCREEN TO BE REMOVED. WHERE DOOR AND SCREEN IS REMOVED, CLEAN AND PATCH OPENING TO RECEIVE NEW DOOR AND SCREEN. REFER TO NEW CONSTRUCTION PLANS AND ELEVATIONS. (REFER ELECTRICAL DRAWINGS.)
- 7 MAKE NEW OPENING (1000mm X 2135mm) ON THE EXISTING WALL. CLEAN AND PATCH WALL OPENING SURFACE TO RECEIVE NEW FINISH.
- 8 EXISTING LIFT TRACK AND MOTOR TO REMAIN. (REFER ELECTRICAL DRAWINGS)
- 9 EXISTING DOOR TO BE REMOVED. WHERE DOOR IS REMOVED PREPARE DOOR FRAME TO RECEIVE NEW PAINT AND NEW DOOR. (REFER OPENING SCHEDULES).
- 10 EXISTING DOOR AND FRAME TO BE REMOVED. WHERE DOOR AND FRAME IS REMOVED, CLEAN AND PATCH THE EXISTING WALL TO RECEIVE NEW WORK. (REFER FLOOR PLAN A103).
- 11 EXISTING WALL TO BE DEMOLISHED AS SHOWN. PATCH, REPAIR AND MAKE GOOD EXISTING WALL, FLOOR TO RECEIVE NEW FINISH. PROVIDE ANY REMEDIAL WORK TO EXISTING CEILING TO RECEIVE NEW CEILING TILE. (REFER FLOOR PLAN A101).
- 12 G.C. TO CAREFULLY REMOVE ANY WALL HANGING ITEMS AND STORE IT FOR RE-INSTALLATION. PATCH, REPAIR AND MAKE GOOD WALL SURFACE TO RECEIVE NEW FINISH.
- 13 EXISTING COUNTER TOP TO BE REMOVED. WHERE COUNTER TOP IS REMOVED, CLEAN AND PATCH THE WALL, FLOOR TO RECEIVE NEW FINISH.
- 14 EXISTING ACOUSTIC CEILING TO BE CUT AND REMOVED AS SHOWN.
- 15 EXISTING LOCATION OF THE CEILING MOUNTED LIGHT TO BE REMOVED AND RELOCATED. (REFER ELECTRICAL DRAWINGS).
- 16 EXISTING ROUGH OPENING TO BE WIDENED TO 1065mm. ALSO REFER INSTRUCTIONS AT DETAIL 01/A-200

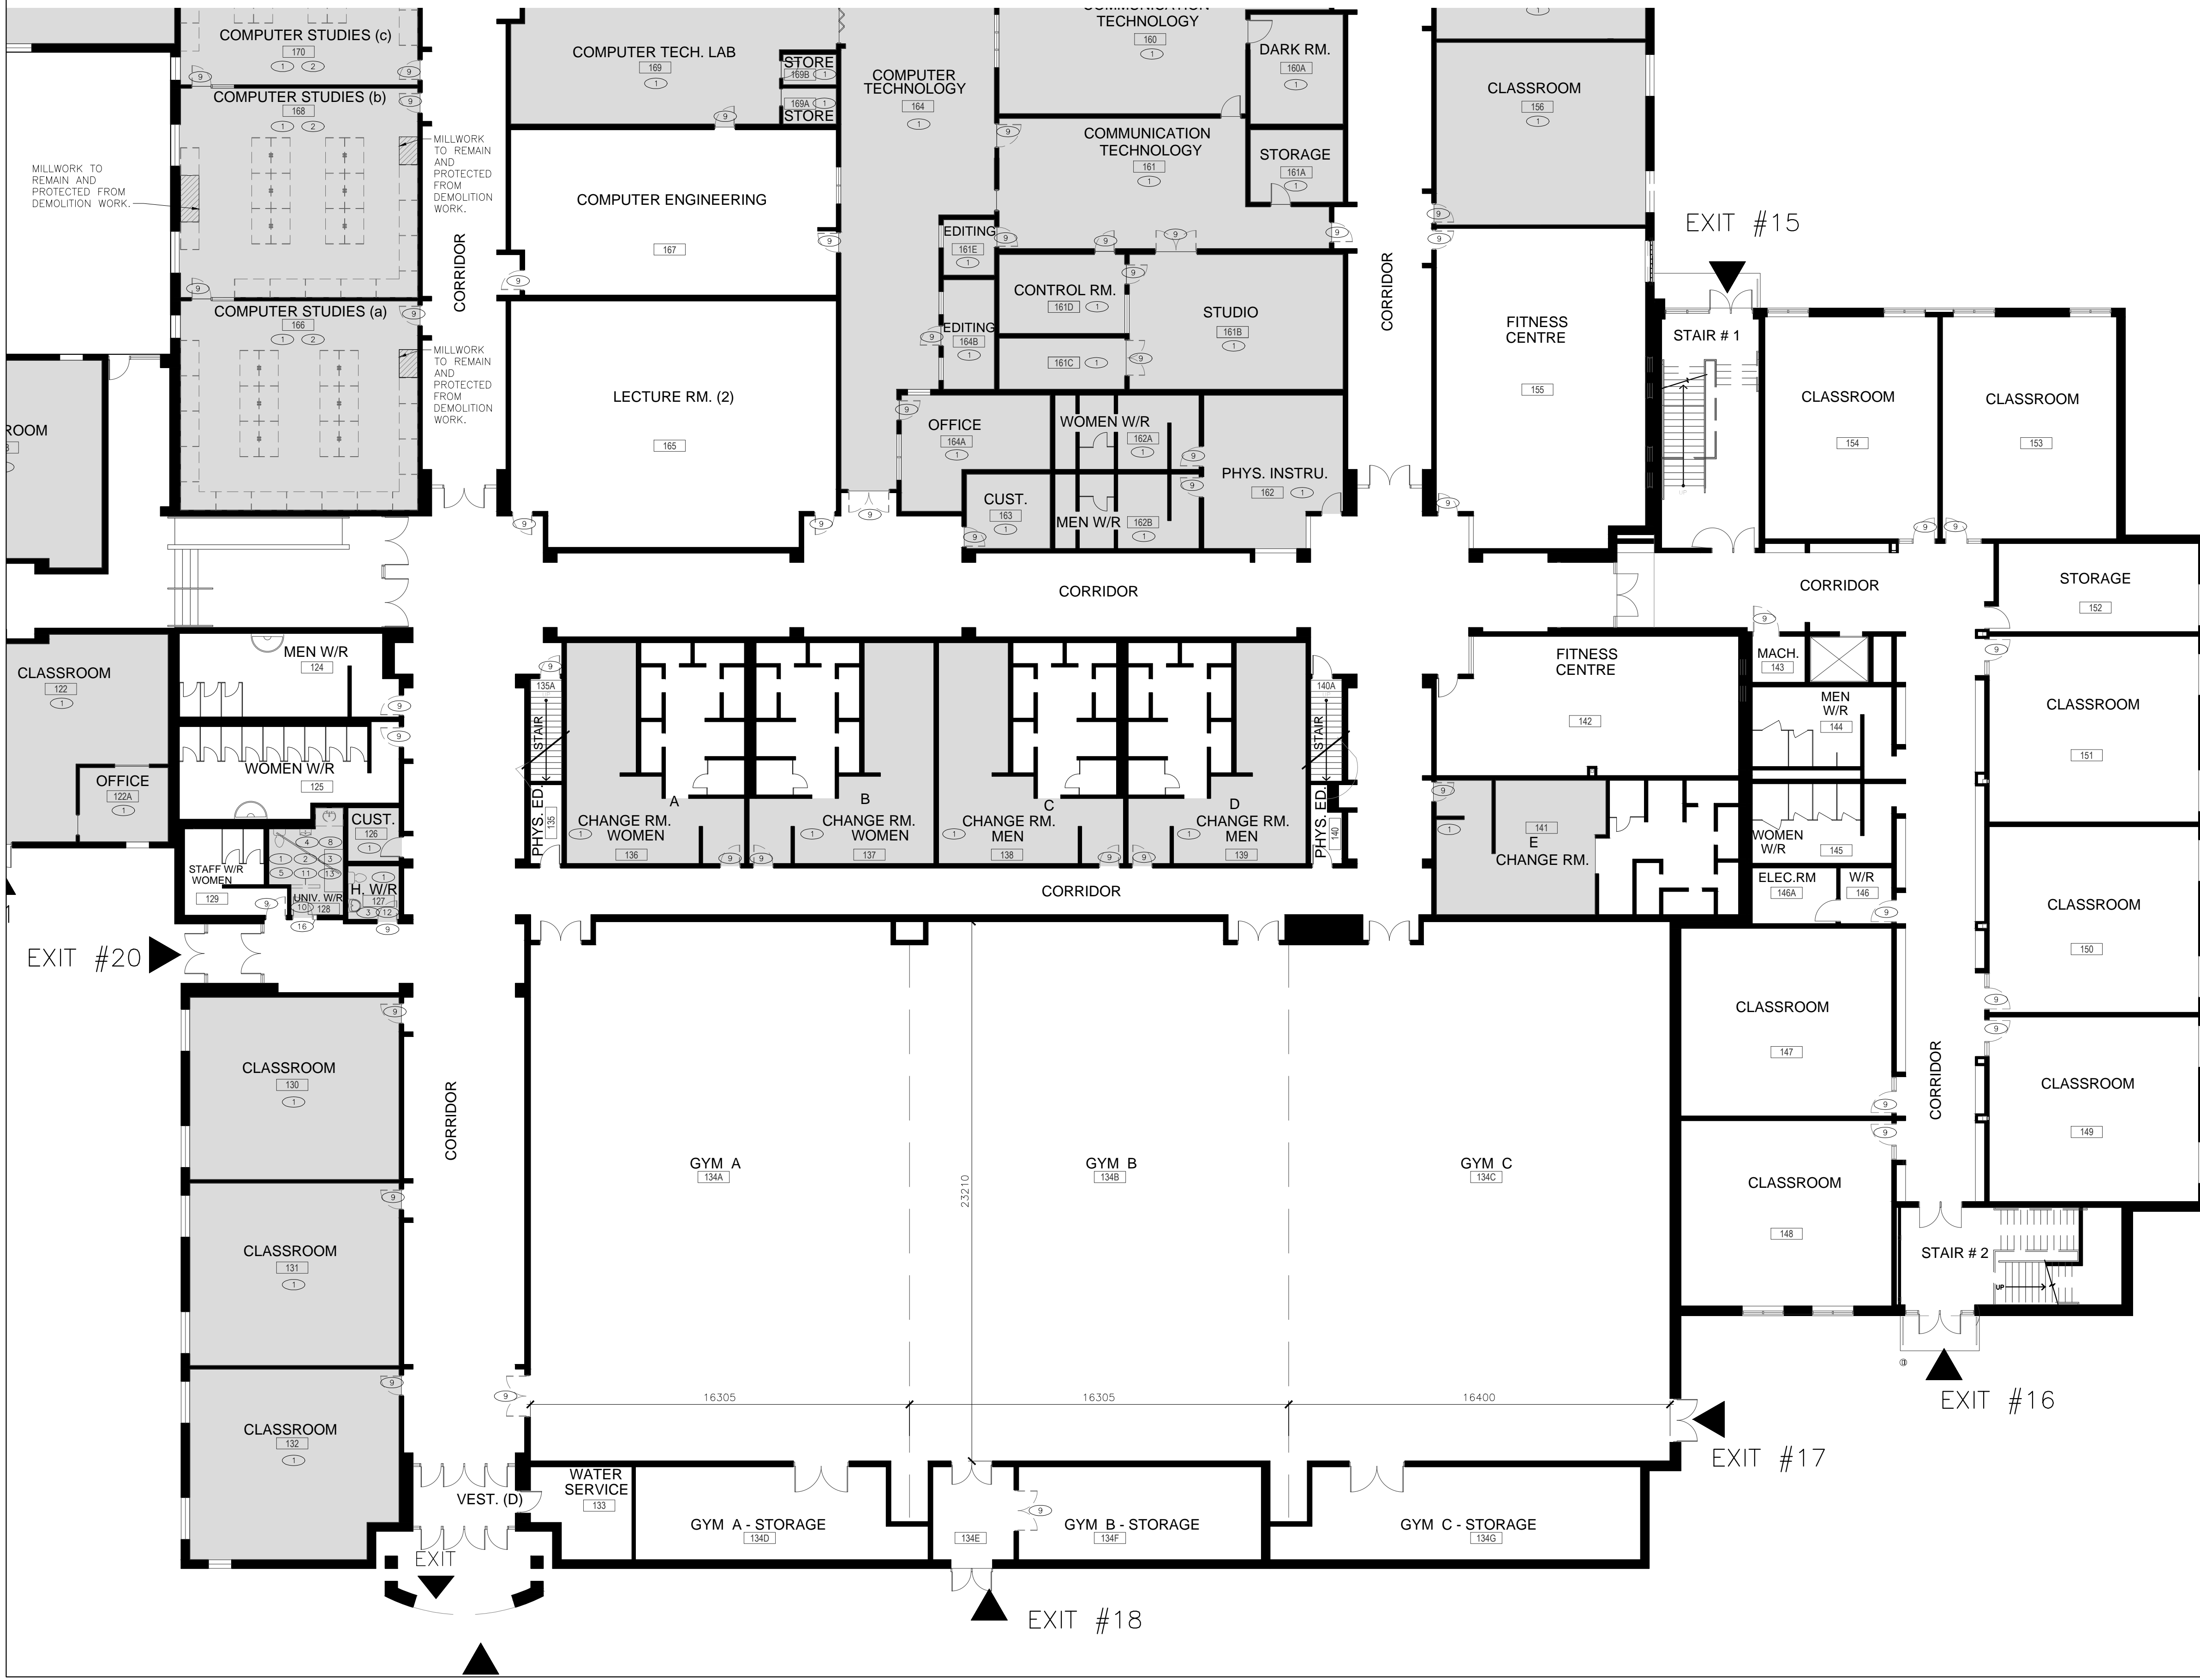

01 DEMOLITION FIRST FLOOR PLAN - BLOCK B
1:150

KEY PLAN

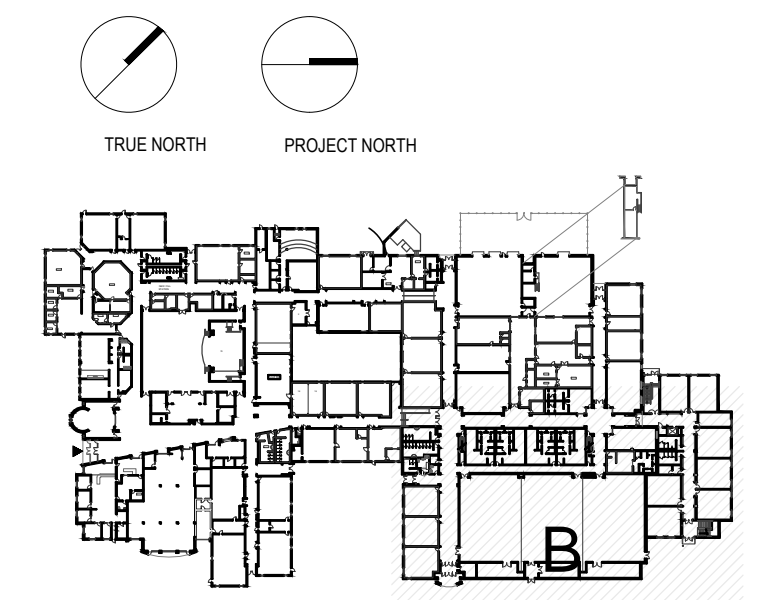

LEGEND

ISSUED

DATE	DESCRIPTION	No.
2024-02-15	ISSUE FOR TENDER	1

ALL DRAWINGS, SPECIFICATIONS AND RELATED DOCUMENTATION ARE COPYRIGHT PROPERTY OF 1721 ARCHITECTS INC. AND MUST BE RETURNED UPON REQUEST. REPRODUCTION OF DRAWINGS, SPECIFICATIONS AND RELATED DOCUMENTATION IN PART OR IN WHOLE IS WRITTEN FORBIDDEN WITHOUT THE WRITTEN PERMISSION OF 1721 ARCHITECTS INC.
DO NOT SCALE DRAWINGS
CONTRACTOR MUST CHECK AND VERIFY ALL DIMENSION OF THE JOB.
THIS DRAWING IS NOT TO BE USED FOR CONSTRUCTION UNTIL SIGNED BY THE ARCHITECT

Monsignor Doyle CSS

185 Myers Rd, Cambridge, ON N1R 7H2
DRAWING TITLE:
DEMO. FIRST FLOOR PLAN - BLOCK B

CHECKED: SD
DRAWN: RN
PROJECT No. 2330

SCALE: AS NOTED

D101

DATE PLOTTED: YYYY.MM.DD

GENERAL NOTES:

- A. REMOVE ALL WIRING FROM ELECTRICAL ITEMS THAT WILL BE REMOVED AND ALL REDUNDANT CONDUIT BACK TO NEAREST JUNCTION BOX THAT WILL REMAIN, AND MAKE SAFE. INSTALL METAL COVER PLATES OVER EXPOSED OPENINGS AND ELECTRICAL BOXES. REFER TO ELECTRICAL FOR ADDITIONAL REQUIREMENTS.
- B. MAKE GOOD ALL AREAS AFFECTED BY REMOVALS - FLUSH TO ADJACENT SURFACE AND MATCH EXISTING FINISH.
- C. DISPOSE OF ALL DESIGNATED SUBSTANCES TO THE REQUIREMENTS OF AUTHORITIES HAVING JURISDICTION.
- D. ALL PIPING THAT IS TO BE REMOVED OR ABANDONED IS TO BE REMOVED BACK TO THE NEAREST JUNCTION AND CAPPED. REFER TO MECHANICAL FOR ADDITIONAL REQUIREMENTS.
- E. NOTE ALL EXISTING ITEMS MAY NOT BE SHOWN ON THESE DRAWINGS. A CAREFUL REVIEW OF THE SITE IS REQUIRED TO DETERMINE THE FULL EXTENT OF THE WORK SHOWN.
- F. THE ARCHITECTURAL DRAWINGS ARE TO BE READ IN CONJUNCTION WITH ALL PROJECT MANUALS, STRUCTURAL, CIVIL, MECHANICAL AND ELECTRICAL DRAWINGS. IN CASE OF DIFFERENCES BETWEEN CONSULTANTS' DOCUMENTS WITH RESPECT TO QUANTITY, SIZES OR SCOPE, THE GREATER SHALL APPLY.
- G. PROVIDE PROTECTION FOR ALL FINISHES OR SERVICES TO REMAIN.
- H. ALL WINDOWS FALLING WITHIN THE DEMOLITION AREA ARE TO HAVE COVERINGS, THEIR FITTINGS, MOUNTING HARDWARE REMOVED & RETURNED TO THE OWNER, OR DISPOSE AS DIRECTED BY THE OWNER.
- I. DEMOLITION NOTE REFERENCE NUMBERS, WHERE LOCATED ADJACENT TO A ROOM NAME/NUMBER APPLY TO THE ENTIRETY OF THE ROOM.
- J. GENERAL CONTRACTOR IS TO ALLOW FOR THE SUPPLY AND INSTALLATION OF LOOSE LINTELS AS REQUIRED WHERE NEW OPENINGS ARE BEING CREATED OR WIDENED. REFER TO THE LOOSE LINTEL SCHEDULE PROVIDED ON THE DRAWINGS, OR PROVIDE ENGINEERING WHERE THERE ARE NO STRUCTURAL DRAWINGS / SCHEDULE.
- K. GC IS REQUIRED TO REMOVE ALL REMAINING ADHESIVES ON WALLS WHERE COMMUNICATION BOARDS WERE REMOVED UNLESS BEING COVERED WITH NEW BOARDS. TYPICAL FOR ALL ROOMS AFFECTED BY WORK.
- L. EXISTING LED BALLASTS AND BULBS TO BE TURNED OVER TO OWNER (COORDINATE WITH M&E).
- M. ALL WORK TO BE COORDINATED WITH THE ASBESTOS CONSULTANT'S DESIGNATED SUBSTANCES REPORT AND SCOPE OF WORK HOLDER ASSOCIATES LTD. IS THE BOARD'S ASBESTOS CONSULTANT.
- N. REFER TO OTHER NOTES ON SHEET A-100, A-101, A-102, A-103, A105

LEGENDS:

- DEMOLITION NOTE REFERENCE NUMBER
- LOCATION OF HOARDING
- PORTION OF EXISTING MASONRY/DRYWALL PARTITION TO BE REMOVED.
- PORTION OF EXISTING FLOOR FINISH TO BE REMOVED.
- APPROXIMATE EXTENT OF EXISTING WALLS AND STRUCTURE TO REMAIN.
- APPROXIMATE EXTENT OF AREAS WHERE NO WORK IS REQUIRED.
- ⤵ EXISTING DOOR & FRAME TO BE REMOVED
- ⤵ EXISTING DOOR & FRAME



DEMOLITION NOTES:

- 1 EXISTING FLOOR FINISHES AND WALL BASE TO BE REMOVED INCLUDING ALL ADHESIVES AND MORTAR DOWN TO EXISTING FLOOR BASE AND WALL BACKING BY MEANS OF GRINDING. PREPARE FLOOR AND MAKE READY TO RECEIVE NEW FINISHES. PROVIDE ANY AND ALL REMEDIAL WORK TO WALL.
- 2 EXISTING MILLWORK TO BE REMOVED. WHERE MILLWORK IS REMOVED, CLEAN AND PATCH THE WALL, FLOOR TO RECEIVE NEW FINISH.
- 3 EXISTING PLUMBING FIXTURES TO BE REMOVED. (REFER MECHANICAL DRAWINGS.)
- 4 EXISTING URINAL TO BE REMOVED. CLEAN AND PATCH THE WALL TO RECEIVE NEW FINISH. (REFER MECHANICAL DRAWINGS.)
- 5 EXISTING MIRROR, HAND DRYER, SOAP DISPENSER, PAPER TOWEL DISPENSER, WASTE RECEPTACLE, NOTES, GRAB BARS, EMERGENCY CALL SWITCH AND CURTAIN RODS TO BE REMOVED. CLEAN AND PATCH WALL TO RECEIVE NEW FINISH. (REFER M&E DRAWINGS.)
- 6 EXISTING DOOR AND SCREEN TO BE REMOVED. WHERE DOOR AND SCREEN IS REMOVED, CLEAN AND PATCH OPENING TO RECEIVE NEW DOOR AND SCREEN. REFER TO NEW CONSTRUCTION PLANS AND ELEVATIONS. (REFER ELECTRICAL DRAWINGS.)
- 7 MAKE NEW OPENING (1000mm X 2135mm) ON THE EXISTING WALL. CLEAN AND PATCH WALL OPENING SURFACE TO RECEIVE NEW FINISH.
- 8 EXISTING LIFT TRACK AND MOTOR TO REMAIN. (REFER ELECTRICAL DRAWINGS)
- 9 EXISTING DOOR TO BE REMOVED. WHERE DOOR IS REMOVED PREPARE DOOR FRAME TO RECEIVE NEW PAINT AND NEW DOOR. (REFER OPENING SCHEDULES).
- 10 EXISTING DOOR AND FRAME TO BE REMOVED. WHERE DOOR AND FRAME IS REMOVED, CLEAN AND PATCH THE EXISTING WALL TO RECEIVE NEW WORK. (REFER FLOOR PLAN A103).
- 11 EXISTING WALL TO BE DEMOLISHED AS SHOWN. PATCH, REPAIR AND MAKE GOOD EXISTING WALL, FLOOR TO RECEIVE NEW FINISH. PROVIDE ANY REMEDIAL WORK TO EXISTING CEILING TO RECEIVE NEW CEILING TILE. (REFER FLOOR PLAN A101).
- 12 G.C TO CAREFULLY REMOVE ANY WALL HANGING ITEMS AND STORE IT FOR RE-INSTALLATION. PATCH, REPAIR AND MAKE GOOD WALL SURFACE TO RECEIVE NEW FINISH.
- 13 EXISTING COUNTER TOP TO BE REMOVED. WHERE COUNTER TOP IS REMOVED, CLEAN AND PATCH THE WALL, FLOOR TO RECEIVE NEW FINISH.
- 14 EXISTING ACOUSTIC CEILING TO BE CUT AND REMOVED AS SHOWN.
- 15 EXISTING LOCATION OF THE CEILING MOUNTED LIGHT TO BE REMOVED AND RELOCATED. (REFER ELECTRICAL DRAWINGS).
- 16 EXISTING ROUGH OPENING TO BE WIDENED TO 1065mm. ALSO REFER INSTRUCTIONS AT DETAIL 01/A-200



01 DEMOLITION FIRST FLOOR PLAN - BLOCK C
1:150

KEY PLAN

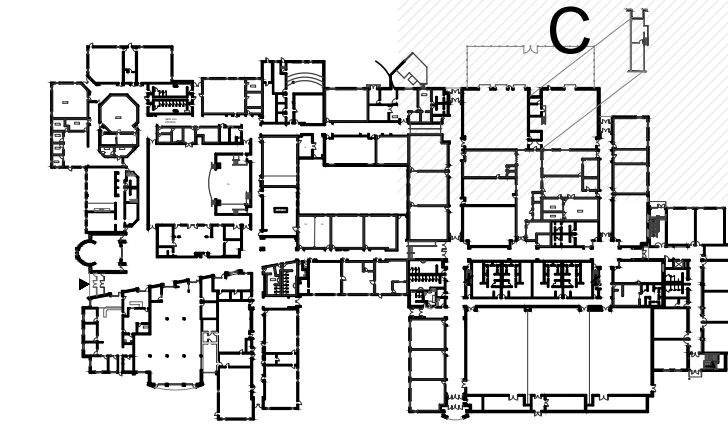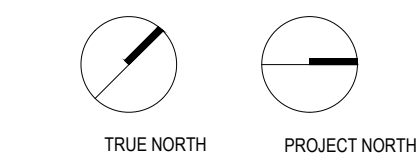

LEGEND

ISSUED

DATE	DESCRIPTION	No.
2024-02-15	ISSUE FOR TENDER	1

ALL DRAWINGS, SPECIFICATIONS AND RELATED DOCUMENTATION ARE COPYRIGHT PROPERTY OF 1721 ARCHITECTS INC. AND MUST BE RETURNED UPON REQUEST. REPRODUCTION OF DRAWINGS, SPECIFICATIONS AND RELATED DOCUMENTATION IN PART OR IN WHOLE IS WRITTEN FORBIDDEN WITHOUT THE WRITTEN PERMISSION OF 1721 ARCHITECTS INC.
DO NOT SCALE DRAWINGS
CONTRACTOR MUST CHECK AND VERIFY ALL DIMENSION OF THE JOB.
THIS DRAWING IS NOT TO BE USED FOR CONSTRUCTION UNTIL SIGNED BY THE ARCHITECT

Monsignor Doyle CSS

185 Myers Rd, Cambridge, ON N1R 7H2

DRAWING TITLE:
DEMO. FIRST FLOOR PLAN - BLOCK C

CHECKED: SD
DRAWN: RN
PROJECT No. 2330

SCALE: AS NOTED

D102

GENERAL NOTES:


- REMOVE ALL WIRING FROM ELECTRICAL ITEMS THAT WILL BE REMOVED AND ALL REDUNDANT CONDUIT BACK TO NEAREST JUNCTION BOX THAT WILL REMAIN, AND MAKE SAFE. INSTALL METAL COVER PLATES OVER EXPOSED OPENINGS AND ELECTRICAL BOXES. REFER TO ELECTRICAL FOR ADDITIONAL REQUIREMENTS.
- MAKE GOOD ALL AREAS AFFECTED BY REMOVALS - FLUSH TO ADJACENT SURFACE AND MATCH EXISTING FINISH.
- DISPOSE OF ALL DESIGNATED SUBSTANCES TO THE REQUIREMENTS OF AUTHORITIES HAVING JURISDICTION.
- ALL PIPING THAT IS TO BE REMOVED OR ABANDONED IS TO BE REMOVED BACK TO THE NEAREST JUNCTION AND CAPPED, REFER TO MECHANICAL FOR ADDITIONAL REQUIREMENTS.
- NOTE ALL EXISTING ITEMS MAY NOT BE SHOWN ON THESE DRAWINGS. A CAREFUL REVIEW OF THE SITE IS REQUIRED TO DETERMINE THE FULL EXTENT OF THE WORK SHOWN.
- THE ARCHITECTURAL DRAWINGS ARE TO BE READ IN CONJUNCTION WITH ALL PROJECT MANUALS, STRUCTURAL, CIVIL, MECHANICAL AND ELECTRICAL DRAWINGS. IN CASE OF DIFFERENCES BETWEEN CONSULTANTS' DOCUMENTS WITH RESPECT TO QUANTITY, SIZES OR SCOPE, THE GREATER SHALL APPLY.
- PROVIDE PROTECTION FOR ALL FINISHES OR SERVICES TO REMAIN.
- ALL WINDOWS FALLING WITHIN THE DEMOLITION AREA ARE TO HAVE COVERINGS, THEIR FITTINGS, MOUNTING HARDWARE REMOVED & RETURNED TO THE OWNER, OR DISPOSE AS DIRECTED BY THE OWNER.
- DEMOLITION NOTE REFERENCE NUMBERS, WHERE LOCATED ADJACENT TO A ROOM NAME/NUMBER APPLY TO THE ENTIRETY OF THE ROOM.
- GENERAL CONTRACTOR IS TO ALLOW FOR THE SUPPLY AND INSTALLATION OF LOOSE LINTELS AS REQUIRED WHERE NEW OPENINGS ARE BEING CREATED OR WIDENED. REFER TO THE LOOSE LINTEL SCHEDULE PROVIDED ON THE DRAWINGS, OR PROVIDE ENGINEERING WHERE THERE ARE NO STRUCTURAL DRAWINGS / SCHEDULE.
- GC IS REQUIRED TO REMOVE ALL REMAINING ADHESIVES ON WALLS WHERE COMMUNICATION BOARDS WERE REMOVED UNLESS BEING COVERED WITH NEW BOARDS. TYPICAL FOR ALL ROOMS AFFECTED BY WORK.
- EXISTING LED BALLASTS AND BULBS TO BE TURNED OVER TO OWNER (COORDINATE WITH M&E).
- ALL WORK TO BE COORDINATED WITH THE ASBESTOS CONSULTANT'S DESIGNATED SUBSTANCES REPORT AND SCOPE OF WORK HOLDER ASSOCIATES LTD. IS THE BOARD'S ASBESTOS CONSULTANT.
- REFER TO OTHER NOTES ON SHEET A-100, A-101, A-102, A-103, A105

LEGENDS:

- DEMOLITION NOTE REFERENCE NUMBER
- LOCATION OF HOARDING
- PORTION OF EXISTING MASONRY/DRYWALL PARTITION TO BE REMOVED.
- PORTION OF EXISTING FLOOR FINISH TO BE REMOVED.
- APPROXIMATE EXTENT OF EXISTING WALLS AND STRUCTURE TO REMAIN.
- APPROXIMATE EXTENT OF AREAS WHERE NO WORK IS REQUIRED.
- EXISTING DOOR & FRAME TO BE REMOVED
- EXISTING DOOR & FRAME


DEMOLITION NOTES:

- EXISTING FLOOR FINISHES AND WALL BASE TO BE REMOVED INCLUDING ALL ADHESIVES AND MORTAR DOWN TO EXISTING FLOOR BASE AND WALL BACKING BY MEANS OF GRINDING. PREPARE FLOOR AND MAKE READY TO RECEIVE NEW FINISHES. PROVIDE ANY AND ALL REMEDIAL WORK TO WALL.
- EXISTING MILLWORK TO BE REMOVED, WHERE MILLWORK IS REMOVED, CLEAN AND PATCH THE WALL, FLOOR TO RECEIVE NEW FINISH.
- EXISTING PLUMBING FIXTURES TO BE REMOVED. (REFER MECHANICAL DRAWINGS.)
- EXISTING URINAL TO BE REMOVED, CLEAN AND PATCH THE WALL TO RECEIVE NEW FINISH. (REFER MECHANICAL DRAWINGS.)
- EXISTING MIRROR, HAND DRYER, SOAP DISPENSER, PAPER TOWEL DISPENSER, WASTE RECEPTACLE, NOTES, CRAB BARS, EMERGENCY CALL SWITCH AND CURTAIN RODS TO BE REMOVED, CLEAN AND PATCH WALL TO RECEIVE NEW FINISH. (REFER M&E DRAWINGS.)
- EXISTING DOOR AND SCREEN TO BE REMOVED, WHERE DOOR AND SCREEN IS REMOVED, CLEAN AND PATCH OPENING TO RECEIVE NEW DOOR AND SCREEN. REFER TO NEW CONSTRUCTION PLANS AND ELEVATIONS. (REFER ELECTRICAL DRAWINGS.)
- MAKE NEW OPENING (1000mm X 2135mm) ON THE EXISTING WALL, CLEAN AND PATCH WALL OPENING SURFACE TO RECEIVE NEW FINISH.
- EXISTING LIFT TRACK AND MOTOR TO REMAIN. (REFER ELECTRICAL DRAWINGS)
- EXISTING DOOR TO BE REMOVED, WHERE DOOR IS REMOVED PREPARE DOOR FRAME TO RECEIVE NEW PAINT AND NEW DOOR. (REFER OPENING SCHEDULES).
- EXISTING DOOR AND FRAME TO BE REMOVED, WHERE DOOR AND FRAME IS REMOVED, CLEAN AND PATCH THE EXISTING WALL TO RECEIVE NEW WORK. (REFER FLOOR PLAN A103).
- EXISTING WALL TO BE DEMOLISHED AS SHOWN, PATCH, REPAIR AND MAKE GOOD EXISTING WALL, FLOOR TO RECEIVE NEW FINISH. PROVIDE ANY REMEDIAL WORK TO EXISTING CEILING TO RECEIVE NEW CEILING TILE. (REFER FLOOR PLAN A101).
- G.C. TO CAREFULLY REMOVE ANY WALL HANGING ITEMS AND STORE IT FOR RE-INSTALLATION, PATCH, REPAIR AND MAKE GOOD WALL SURFACE TO RECEIVE NEW FINISH.
- EXISTING COUNTER TOP TO BE REMOVED, WHERE COUNTER TOP IS REMOVED, CLEAN AND PATCH THE WALL, FLOOR TO RECEIVE NEW FINISH.
- EXISTING ACOUSTIC CEILING TO BE CUT AND REMOVED AS SHOWN.
- EXISTING LOCATION OF THE CEILING MOUNTED LIGHT TO BE REMOVED AND RELOCATED. (REFER ELECTRICAL DRAWINGS).
- EXISTING ROUGH OPENING TO BE WIDENED TO 1065mm, ALSO REFER INSTRUCTIONS AT DETAIL 01/A-200

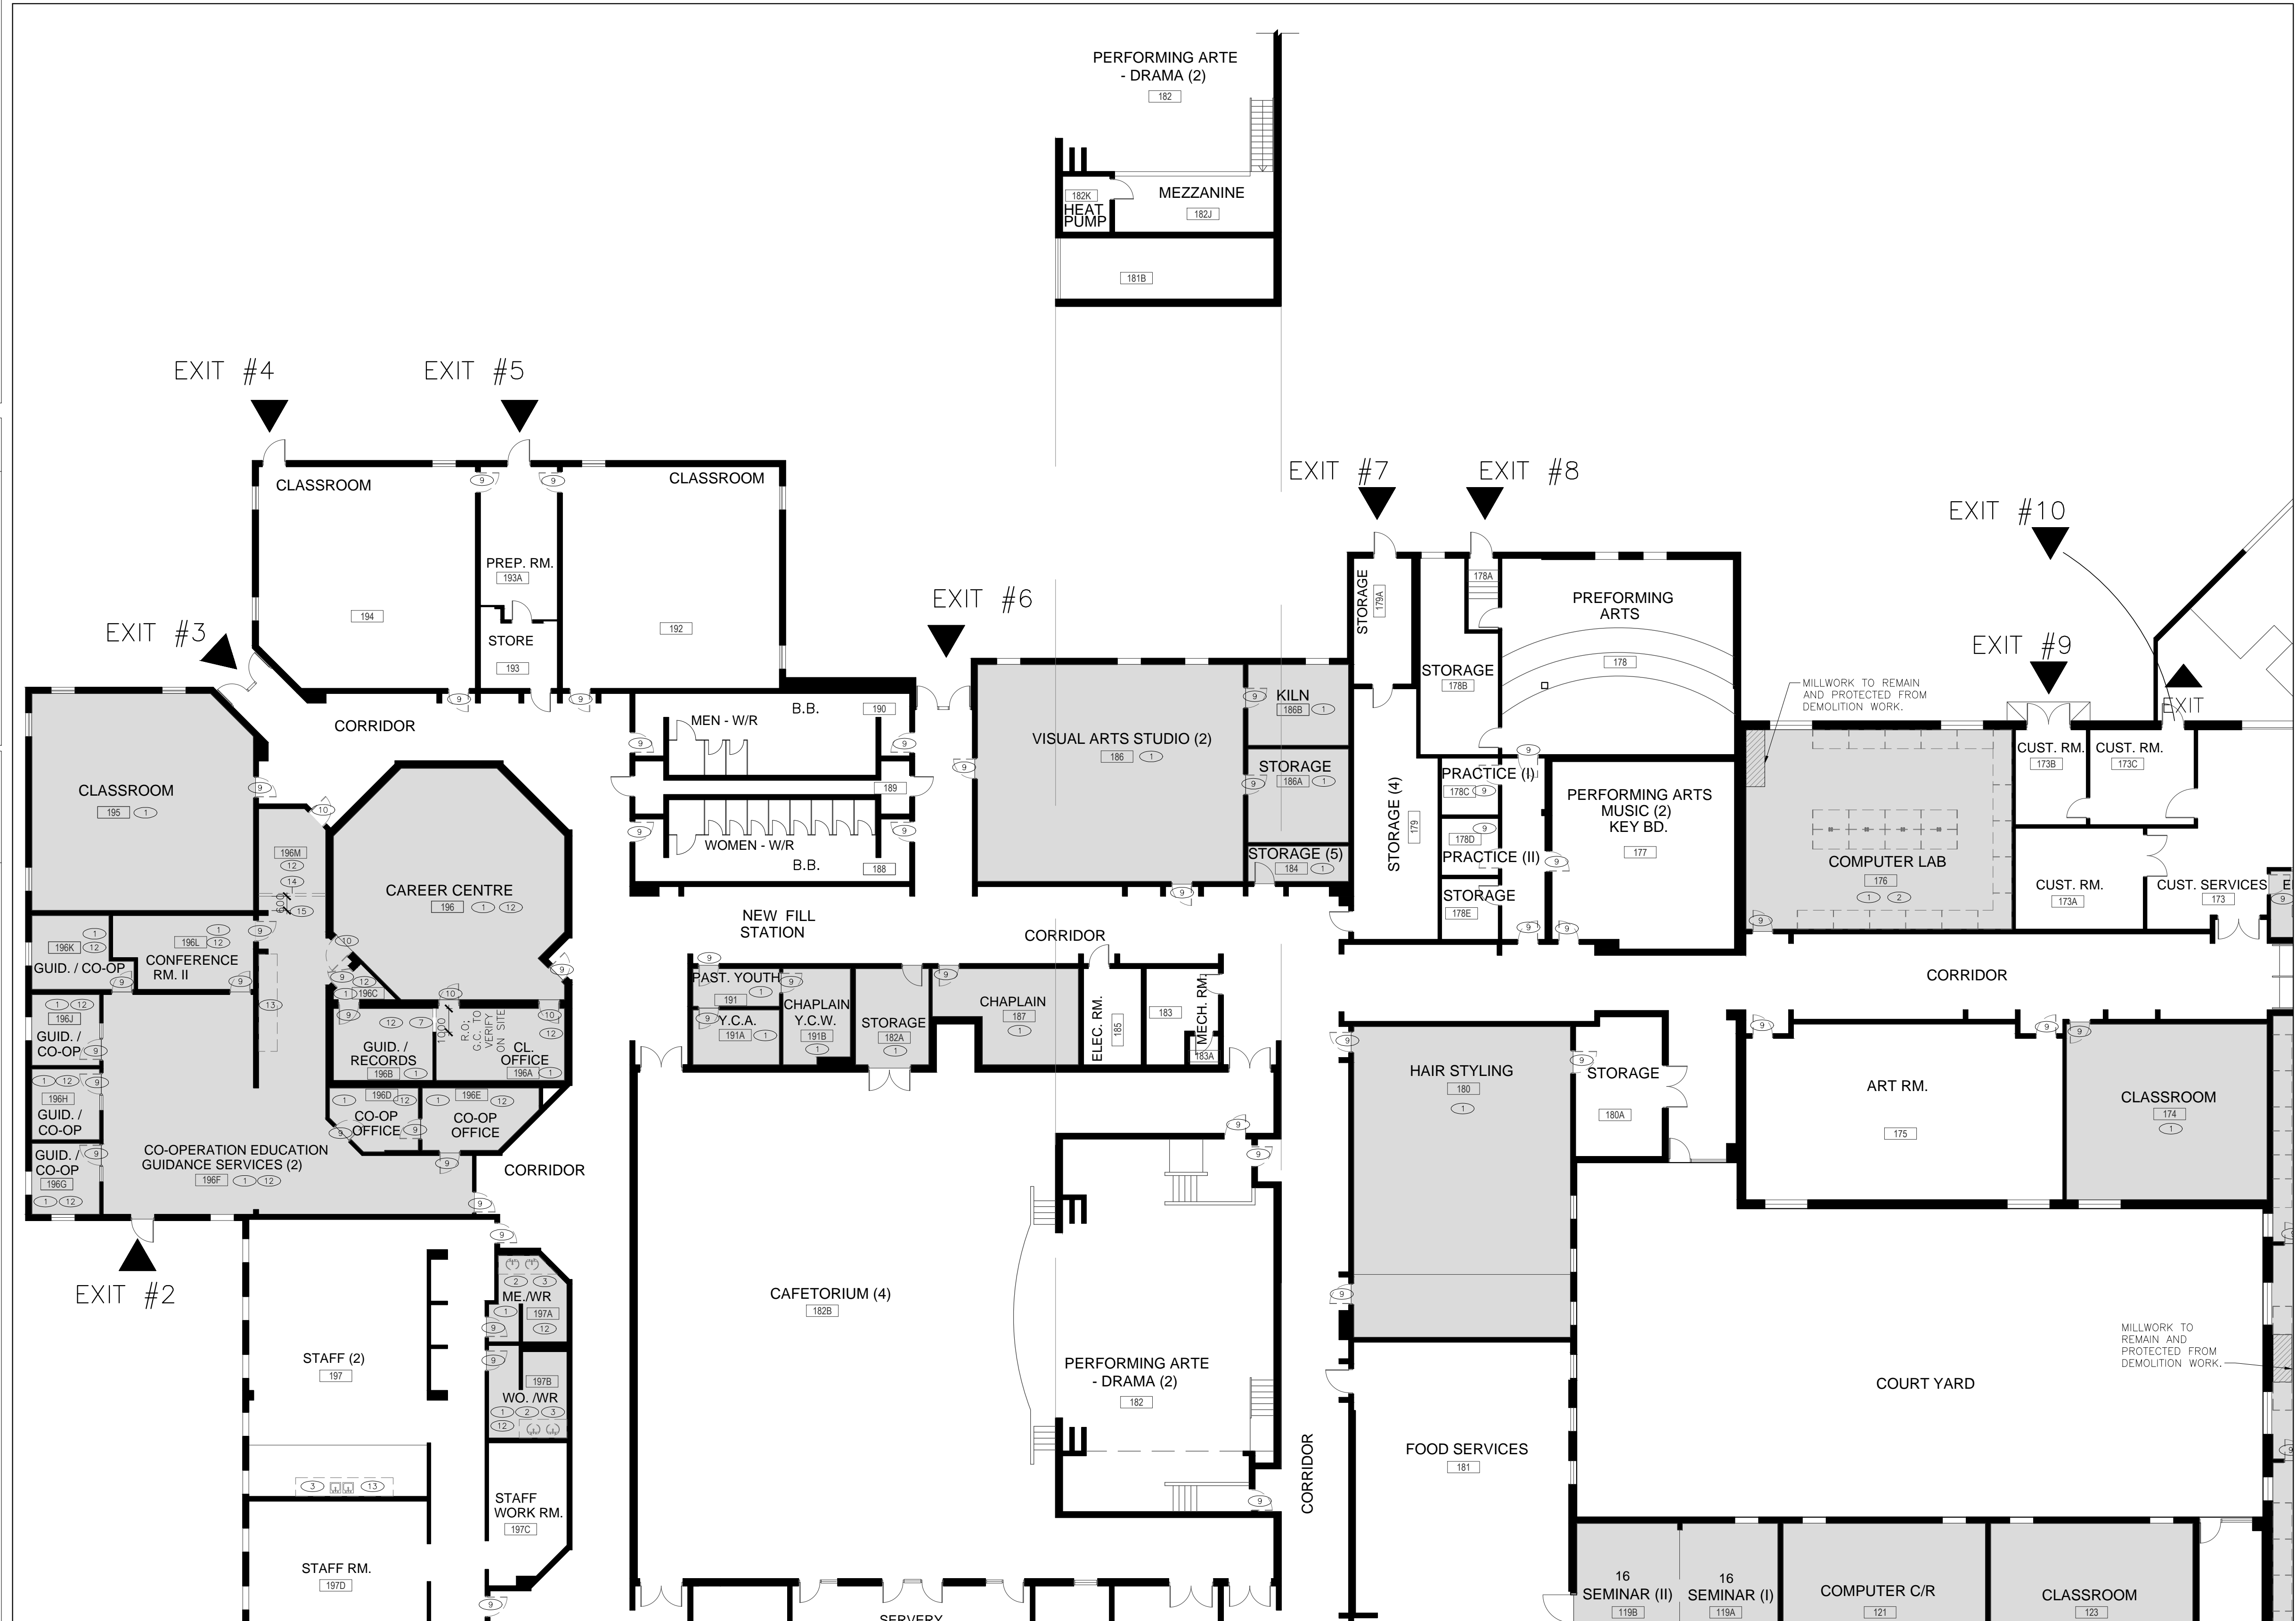

01 DEMOLITION FIRST FLOOR PLAN - BLOCK D
1:150

KEY PLAN

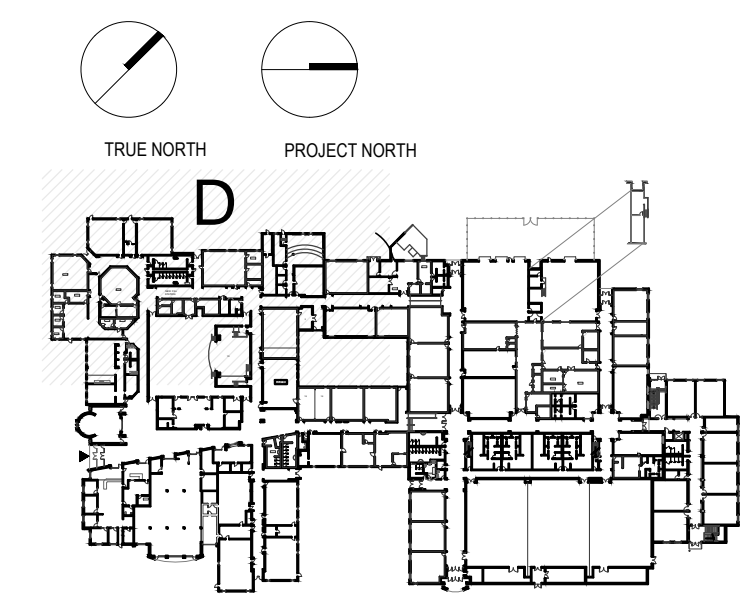

LEGEND

ISSUED

DATE	DESCRIPTION	No.
2024-02-15	ISSUE FOR TENDER	1

ALL DRAWINGS, SPECIFICATIONS AND RELATED DOCUMENTATION ARE COPYRIGHT PROPERTY OF 17|21 ARCHITECTS INC. AND MUST BE RETURNED UPON REQUEST. REPRODUCTION OF DRAWINGS, SPECIFICATIONS AND RELATED DOCUMENTATION IN PART OR IN WHOLE IS WRITTEN FORBIDDEN WITHOUT THE WRITTEN PERMISSION OF 17|21 ARCHITECTS INC.
DO NOT SCALE DRAWINGS
CONTRACTOR MUST CHECK AND VERIFY ALL DIMENSION OF THE JOB.
THIS DRAWING IS NOT TO BE USED FOR CONSTRUCTION UNTIL SIGNED BY THE ARCHITECT

Monsignor Doyle CSS

185 Myers Rd, Cambridge, ON N1R 7H2

DRAWING TITLE:
DEMO. FIRST FLOOR PLAN - BLOCK D

CHECKED: SD
DRAWN: RN
PROJECT No. 2330

SCALE: AS NOTED

GENERAL NOTES:


- A. REMOVE ALL WIRING FROM ELECTRICAL ITEMS THAT WILL BE REMOVED AND ALL REDUNDANT CONDUIT BACK TO NEAREST JUNCTION BOX THAT WILL REMAIN, AND MAKE SAFE. INSTALL METAL COVER PLATES OVER EXPOSED OPENINGS AND ELECTRICAL BOXES. REFER TO ELECTRICAL FOR ADDITIONAL REQUIREMENTS.
- B. MAKE GOOD ALL AREAS AFFECTED BY REMOVALS - FLUSH TO ADJACENT SURFACE AND MATCH EXISTING FINISH.
- C. DISPOSE OF ALL DESIGNATED SUBSTANCES TO THE REQUIREMENTS OF AUTHORITIES HAVING JURISDICTION.
- D. ALL PIPING THAT IS TO BE REMOVED OR ABANDONED IS TO BE REMOVED BACK TO THE NEAREST JUNCTION AND CAPPED, REFER TO MECHANICAL FOR ADDITIONAL REQUIREMENTS.
- E. NOTE ALL EXISTING ITEMS MAY NOT BE SHOWN ON THESE DRAWINGS. A CAREFUL REVIEW OF THE SITE IS REQUIRED TO DETERMINE THE FULL EXTENT OF THE WORK SHOWN.
- F. THE ARCHITECTURAL DRAWINGS ARE TO BE READ IN CONJUNCTION WITH ALL PROJECT MANUALS, STRUCTURAL, CIVIL, MECHANICAL AND ELECTRICAL DRAWINGS. IN CASE OF DIFFERENCES BETWEEN CONSULTANTS' DOCUMENTS WITH RESPECT TO QUANTITY, SIZES OR SCOPE, THE GREATER SHALL APPLY.
- G. PROVIDE PROTECTION FOR ALL FINISHES OR SERVICES TO REMAIN.
- H. ALL WINDOWS FALLING WITHIN THE DEMOLITION AREA ARE TO HAVE COVERINGS, THEIR FITTINGS, MOUNTING HARDWARE REMOVED & RETURNED TO THE OWNER, OR DISPOSE AS DIRECTED BY THE OWNER.
- I. DEMOLITION NOTE REFERENCE NUMBERS, WHERE LOCATED ADJACENT TO A ROOM NAME/NUMBER APPLY TO THE ENTIRETY OF THE ROOM.
- J. GENERAL CONTRACTOR IS TO ALLOW FOR THE SUPPLY AND INSTALLATION OF LOOSE LINTELS AS REQUIRED WHERE NEW OPENINGS ARE BEING CREATED OR WIDENED. REFER TO THE LOOSE LINTEL SCHEDULE PROVIDED ON THE DRAWINGS, OR PROVIDE ENGINEERING WHERE THERE ARE NO STRUCTURAL DRAWINGS / SCHEDULE.
- K. GC IS REQUIRED TO REMOVE ALL REMAINING ADHESIVES ON WALLS WHERE COMMUNICATION BOARDS WERE REMOVED UNLESS BEING COVERED WITH NEW BOARDS. TYPICAL FOR ALL ROOMS AFFECTED BY WORK.
- L. EXISTING LED BALLASTS AND BULBS TO BE TURNED OVER TO OWNER (COORDINATE WITH M&E).
- M. ALL WORK TO BE COORDINATED WITH THE ASBESTOS CONSULTANT'S DESIGNATED SUBSTANCES REPORT AND SCOPE OF WORK HOLDER ASSOCIATES LTD. IS THE BOARD'S ASBESTOS CONSULTANT.
- N. REFER TO OTHER NOTES ON SHEET A-100, A-101, A-102, A-103, A105

LEGENDS:

- ① DEMOLITION NOTE REFERENCE NUMBER
- LOCATION OF HOARDING
- PORTION OF EXISTING MASONRY/DRYWALL PARTITION TO BE REMOVED.
- PORTION OF EXISTING FLOOR FINISH TO BE REMOVED.
- APPROXIMATE EXTENT OF EXISTING WALLS AND STRUCTURE TO REMAIN.
- APPROXIMATE EXTENT OF AREAS WHERE NO WORK IS REQUIRED.
- ⌋ EXISTING DOOR & FRAME TO BE REMOVED
- ⌋ EXISTING DOOR & FRAME


DEMOLITION NOTES:

- ① EXISTING FLOOR FINISHES AND WALL BASE TO BE REMOVED INCLUDING ALL ADHESIVES AND MORTAR DOWN TO EXISTING FLOOR BASE AND WALL BACKING BY MEANS OF GRINDING. PREPARE FLOOR AND MAKE READY TO RECEIVE NEW FINISHES. PROVIDE ANY AND ALL REMEDIAL WORK TO WALL.
- ② EXISTING MILLWORK TO BE REMOVED, WHERE MILLWORK IS REMOVED, CLEAN AND PATCH THE WALL, FLOOR TO RECEIVE NEW FINISH.
- ③ EXISTING PLUMBING FIXTURES TO BE REMOVED. (REFER MECHANICAL DRAWINGS.)
- ④ EXISTING URINAL TO BE REMOVED, CLEAN AND PATCH THE WALL, TO RECEIVE NEW FINISH. (REFER MECHANICAL DRAWINGS.)
- ⑤ EXISTING MIRROR, HAND DRYER, SOAP DISPENSER, PAPER TOWEL DISPENSER, WASTE RECEPTACLE, NOTES, GRAB BARS, EMERGENCY CALL SWITCH AND CURTAIN RODS TO BE REMOVED, CLEAN AND PATCH WALL TO RECEIVE NEW FINISH. (REFER M&E DRAWINGS.)
- ⑥ EXISTING DOOR AND SCREEN TO BE REMOVED, WHERE DOOR AND SCREEN IS REMOVED, CLEAN AND PATCH OPENING TO RECEIVE NEW DOOR AND SCREEN. REFER TO NEW CONSTRUCTION PLANS AND ELEVATIONS. (REFER ELECTRICAL DRAWINGS.)
- ⑦ MAKE NEW OPENING (1000mm X 2135mm) ON THE EXISTING WALL, CLEAN AND PATCH WALL OPENING SURFACE TO RECEIVE NEW FINISH.
- ⑧ EXISTING LIFT TRACK AND MOTOR TO REMAIN. (REFER ELECTRICAL DRAWINGS)
- ⑨ EXISTING DOOR TO BE REMOVED, WHERE DOOR IS REMOVED PREPARE DOOR FRAME TO RECEIVE NEW PAINT AND NEW DOOR. (REFER OPENING SCHEDULES).
- ⑩ EXISTING DOOR AND FRAME TO BE REMOVED, WHERE DOOR AND FRAME IS REMOVED, CLEAN AND PATCH THE EXISTING WALL TO RECEIVE NEW WORK. (REFER FLOOR PLAN A103).
- ⑪ EXISTING WALL TO BE DEMOLISHED AS SHOWN, PATCH, REPAIR AND MAKE GOOD EXISTING WALL, FLOOR TO RECEIVE NEW FINISH. PROVIDE ANY REMEDIAL WORK TO EXISTING CEILING TO RECEIVE NEW CEILING TILE. (REFER FLOOR PLAN A101).
- ⑫ G.C TO CAREFULLY REMOVE ANY WALL HANGING ITEMS AND STORE IT FOR RE-INSTALLATION, PATCH, REPAIR AND MAKE GOOD WALL SURFACE TO RECEIVE NEW FINISH.
- ⑬ EXISTING COUNTER TOP TO BE REMOVED, WHERE COUNTER TOP IS REMOVED, CLEAN AND PATCH THE WALL, FLOOR TO RECEIVE NEW FINISH.
- ⑭ EXISTING ACOUSTIC CEILING TO BE CUT AND REMOVED AS SHOWN.
- ⑮ EXISTING LOCATION OF THE CEILING MOUNTED LIGHT TO BE REMOVED AND RELOCATED. (REFER ELECTRICAL DRAWINGS).
- ⑯ EXISTING ROUGH OPENING TO BE WIDENED TO 1065mm, ALSO REFER INSTRUCTIONS AT DETAIL 01/A-200

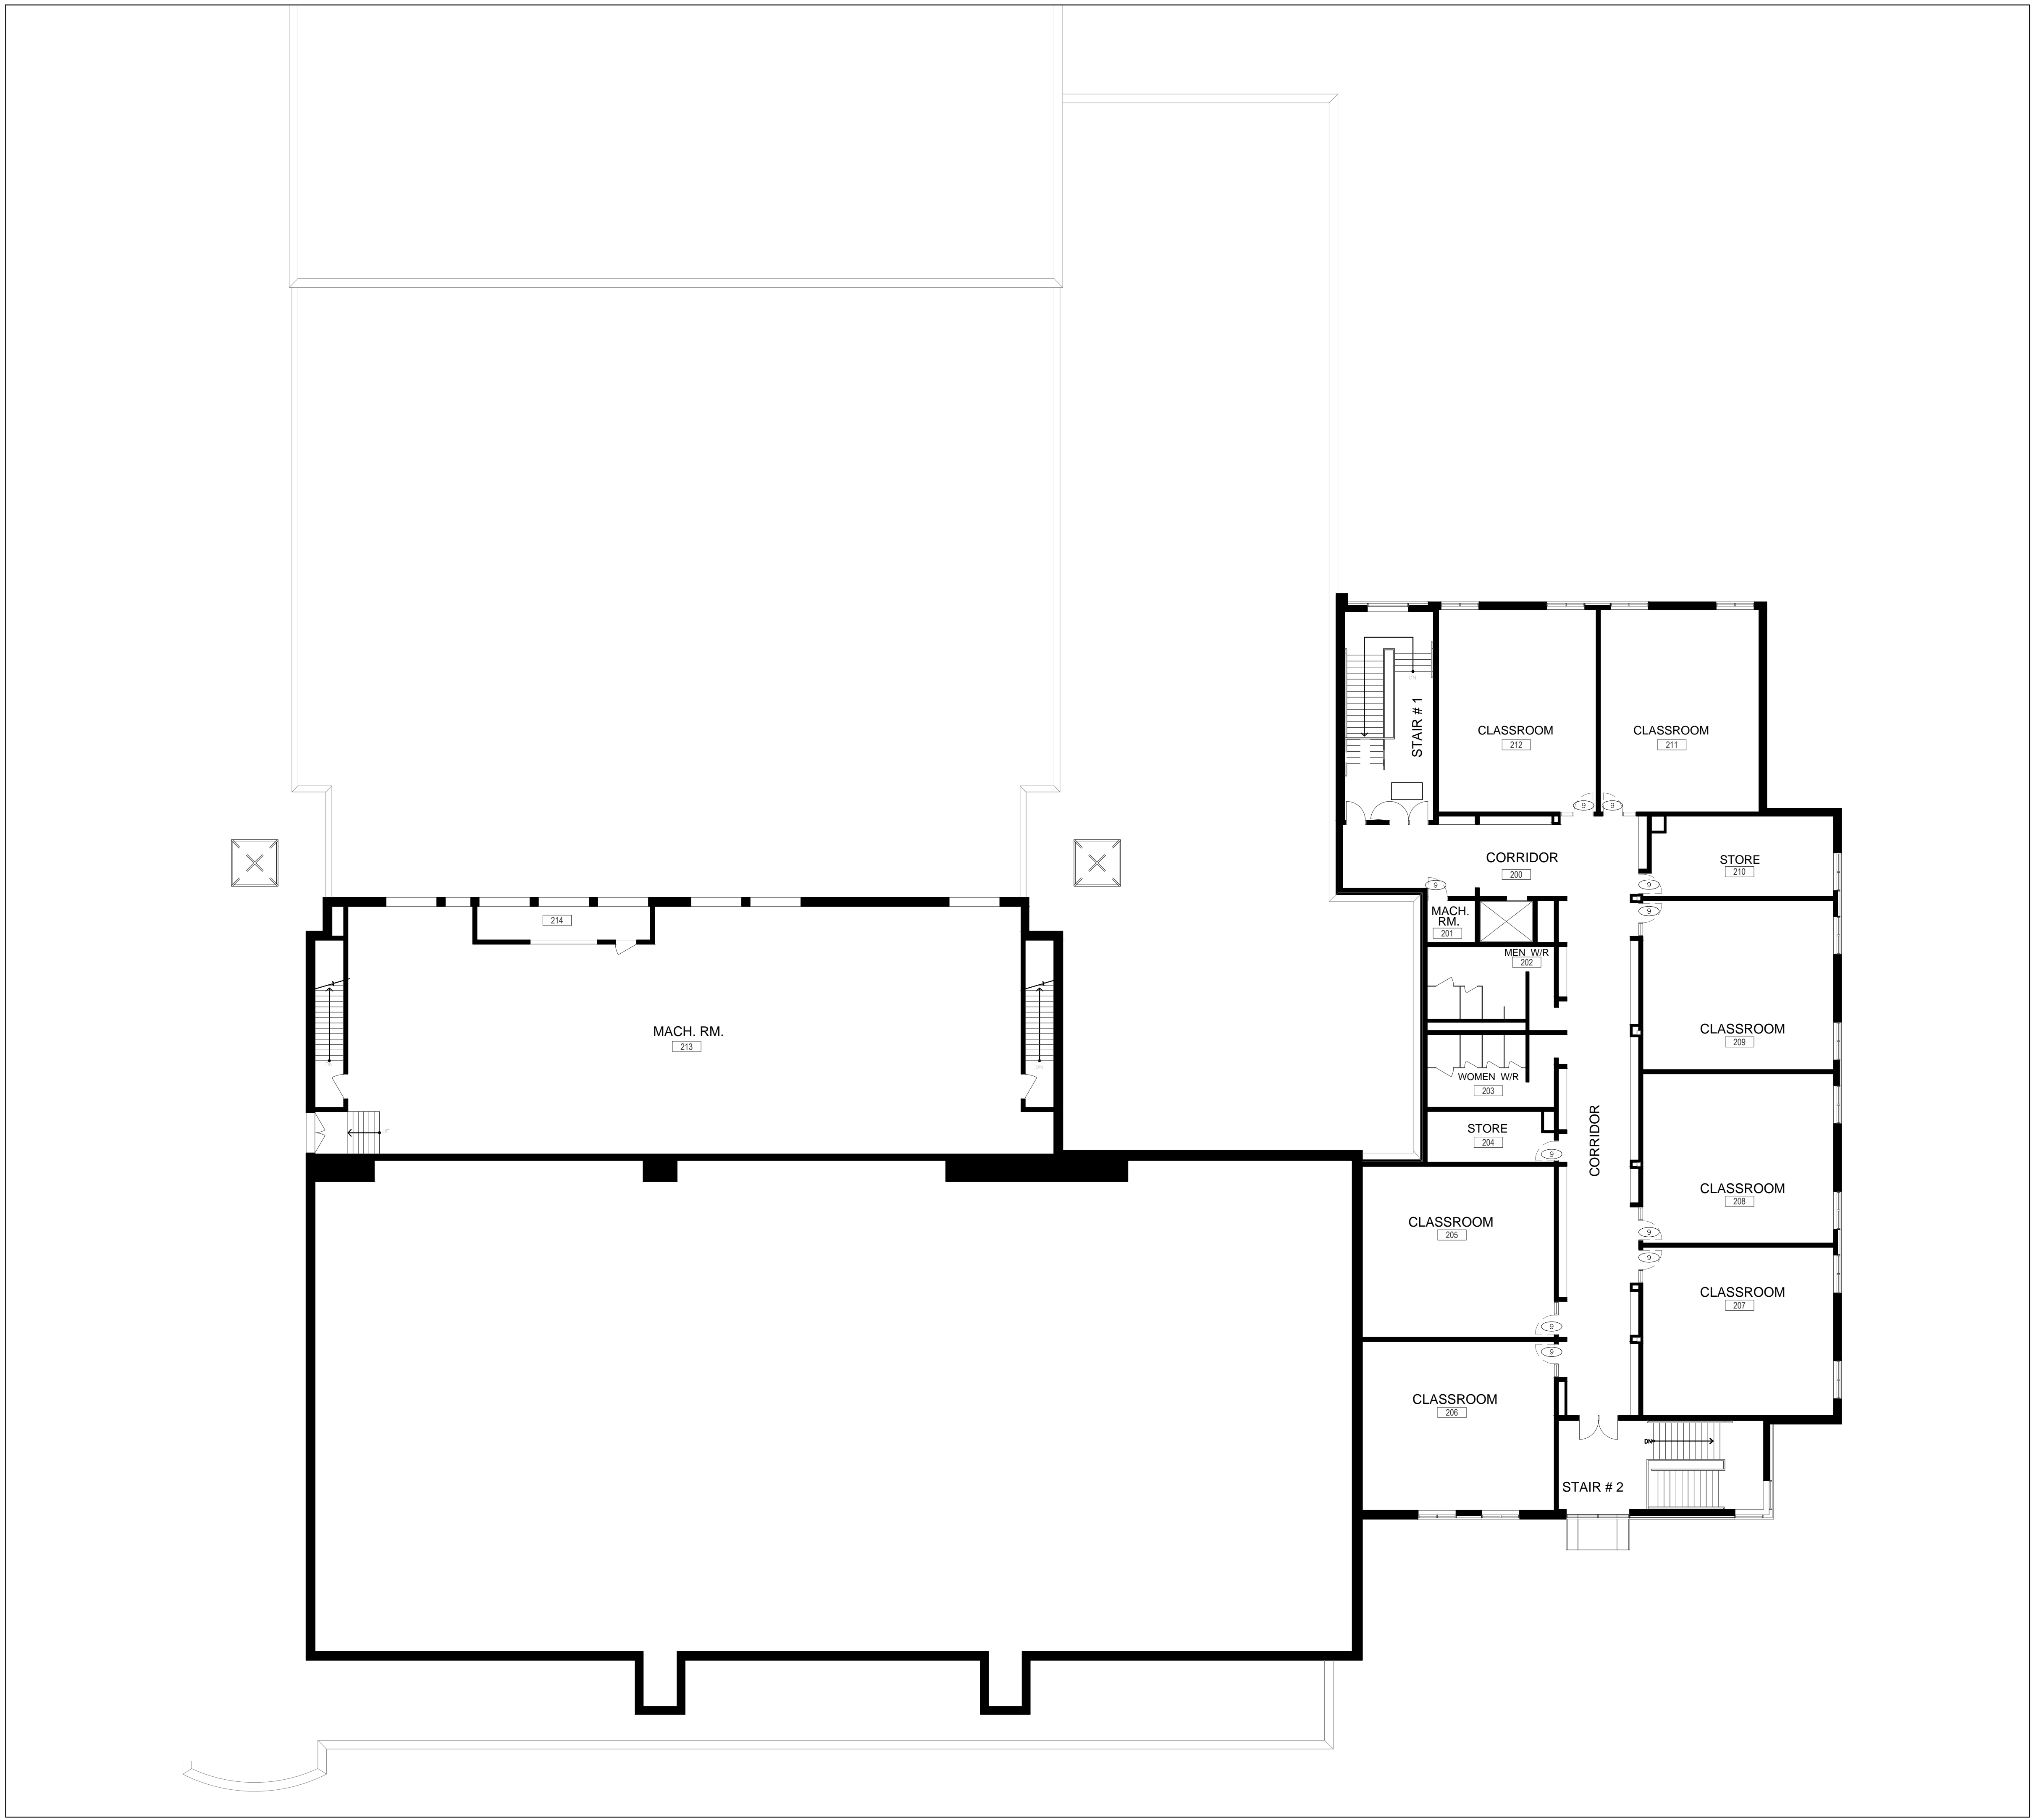

01 DEMOLITION SECOND FLOOR PLAN - BLOCK B
1:150

KEY PLAN

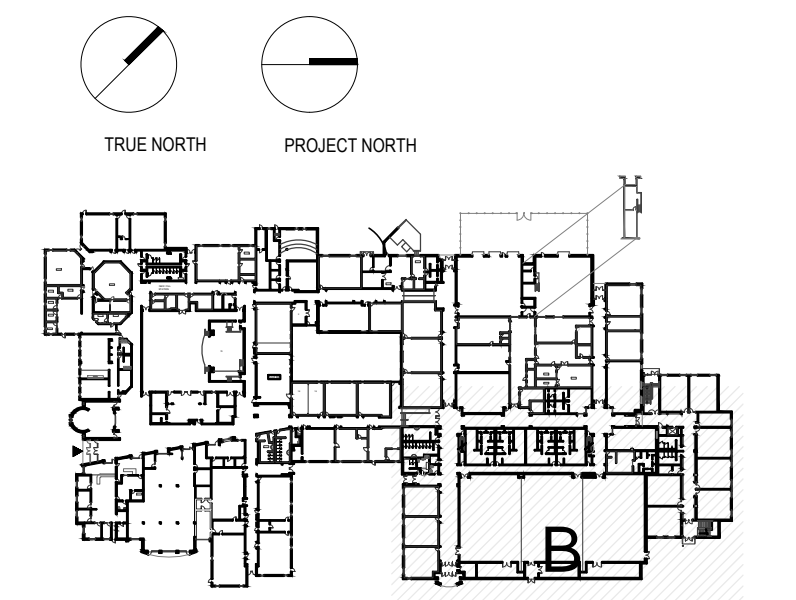

LEGEND

ISSUED

DATE	DESCRIPTION	No.
2024-02-15	ISSUE FOR TENDER	1

ALL DRAWINGS, SPECIFICATIONS AND RELATED DOCUMENTATION ARE COPYRIGHT PROPERTY OF 1721 ARCHITECTS INC. AND MUST BE RETURNED UPON REQUEST. REPRODUCTION OF DRAWINGS, SPECIFICATIONS AND RELATED DOCUMENTATION IN PART OR IN WHOLE IS WRITTEN FORBIDDEN WITHOUT THE WRITTEN PERMISSION OF 1721 ARCHITECTS INC.
DO NOT SCALE DRAWINGS
CONTRACTOR MUST CHECK AND VERIFY ALL DIMENSION OF THE JOB.
THIS DRAWING IS NOT TO BE USED FOR CONSTRUCTION UNTIL SIGNED BY THE ARCHITECT

Monsignor Doyle CSS

185 Myers Rd, Cambridge, ON N1R 7H2

DRAWING TITLE:
DEMO. SECOND FLOOR PLAN - BLOCK B

CHECKED: SD
DRAWN: RN
PROJECT No. 2330

SCALE: AS NOTED

D104

GENERAL NOTES:

- A. REMOVE ALL WIRING FROM ELECTRICAL ITEMS THAT WILL BE REMOVED AND ALL REDUNDANT CONDUIT BACK TO NEAREST JUNCTION BOX THAT WILL REMAIN, AND MAKE SAFE. INSTALL METAL COVER PLATES OVER EXPOSED OPENINGS AND ELECTRICAL BOXES. REFER TO ELECTRICAL FOR ADDITIONAL REQUIREMENTS.
- B. MAKE GOOD ALL AREAS AFFECTED BY REMOVALS - FLUSH TO ADJACENT SURFACE AND MATCH EXISTING FINISH.
- C. DISPOSE OF ALL DESIGNATED SUBSTANCES TO THE REQUIREMENTS OF AUTHORITIES HAVING JURISDICTION.
- D. ALL PIPING THAT IS TO BE REMOVED OR ABANDONED IS TO BE REMOVED BACK TO THE NEAREST JUNCTION AND CAPPED. REFER TO MECHANICAL FOR ADDITIONAL REQUIREMENTS.
- E. NOTE ALL EXISTING ITEMS MAY NOT BE SHOWN ON THESE DRAWINGS. A CAREFUL REVIEW OF THE SITE IS REQUIRED TO DETERMINE THE FULL EXTENT OF THE WORK SHOWN.
- F. THE ARCHITECTURAL DRAWINGS ARE TO BE READ IN CONJUNCTION WITH ALL PROJECT MANUALS, STRUCTURAL, CIVIL, MECHANICAL AND ELECTRICAL DRAWINGS. IN CASE OF DIFFERENCES BETWEEN CONSULTANTS' DOCUMENTS WITH RESPECT TO QUANTITY, SIZES OR SCOPE, THE GREATER SHALL APPLY.
- G. PROVIDE PROTECTION FOR ALL FINISHES OR SERVICES TO REMAIN.
- H. ALL WINDOWS FALLING WITHIN THE DEMOLITION AREA ARE TO HAVE COVERINGS, THEIR FITTINGS, MOUNTING HARDWARE REMOVED & RETURNED TO THE OWNER, OR DISPOSE AS DIRECTED BY THE OWNER.
- I. DEMOLITION NOTE REFERENCE NUMBERS, WHERE LOCATED ADJACENT TO A ROOM NAME/NUMBER APPLY TO THE ENTIRETY OF THE ROOM.
- J. GENERAL CONTRACTOR IS TO ALLOW FOR THE SUPPLY AND INSTALLATION OF LOOSE LINTELS AS REQUIRED WHERE NEW OPENINGS ARE BEING CREATED OR WIDENED. REFER TO THE LOOSE LINTEL SCHEDULE PROVIDED ON THE DRAWINGS, OR PROVIDE ENGINEERING WHERE THERE ARE NO STRUCTURAL DRAWINGS / SCHEDULE.
- K. GC IS REQUIRED TO REMOVE ALL REMAINING ADHESIVES ON WALLS WHERE COMMUNICATION BOARDS WERE REMOVED UNLESS BEING COVERED WITH NEW BOARDS. TYPICAL FOR ALL ROOMS AFFECTED BY WORK.
- L. EXISTING LED BALLASTS AND BULBS TO BE TURNED OVER TO OWNER (COORDINATE WITH M&E)
- M. ALL WORK TO BE COORDINATED WITH THE ASBESTOS CONSULTANT'S DESIGNATED SUBSTANCES REPORT AND SCOPE OF WORK HOLDER ASSOCIATES LTD. IS THE BOARD'S ASBESTOS CONSULTANT.
- N. REFER TO OTHER NOTES ON SHEET A-100, A-101, A-102, A-103

LEGENDS:


- CONSTRUCTION NOTE REFERENCE NUMBER
- CARPET TILE
- CERAMIC TILE FLOORING
- IQ TILE W/ PATTERN

CONSTRUCTION NOTES:


- 1 ALL WALLS TO BE PAINTED. (PATCH AND MAKE GOOD ALL FINISHES).
 - 2 INSTALL NEW FLOORING & BASE BOARD.
 - 3 INSTALL NEW ACOUSTIC CEILING TILE AND SUPPORTS, WHERE CONCRETE MASONRY BLOCK REMOVED.
 - 4 INSTALL NEW COUNTERTOP ON EXISTING MILLWORK.
 - 5 INSTALL NEW TOILET. (REFER MECHANICAL DRAWINGS).
 - 6 INSTALL NEW WALL HUNG SINKS. (REFER MECHANICAL DRAWINGS). G.C TO PROVIDE WOOD BLOCKING WHERE REQUIRED FOR SUPPORT OF WALL HUNG SINK.
 - 7 INSTALL NEW KITCHEN SINK. (REFER MECHANICAL DRAWINGS).
 - 8 INFILL EXISTING WALL OPENING, WALL TYPE TO MATCH EXISTING WALL. REFER DETAIL 3 IN DRAWING A-200.
 - 9 INSTALL NEW DATA AND OUTLETS (REFER ELECTRICAL DRAWINGS).
 - 10 INSTALL NEW SCREEN. REFER DRAWING A1000.
 - 11 REPLACE AND REPAIR BROKEN MASONRY BLOCK WALL WITH NEW CONCRETE BLOCK.
- INSTALL NEW FLOOR STRIP BETWEEN OLD-NEW AND TWO DIFFERENT FLOORING.
- G.C TO REMOVE AND STORE ANY EQUIPMENT AND MOVE ABLE FURNITURE/MILLWORK WHILE INSTALLATION OF NEW FLOOR. REINSTALL AFTER WORK IS DONE.

ABBREVIATIONS

- AL ALUMINUM
- AND. ANODIZED
- WD WOOD
- HM HOLLOW METAL
- EX. HM EXISTING HOLLOW METAL
- STN STAIN
- PT PAINT

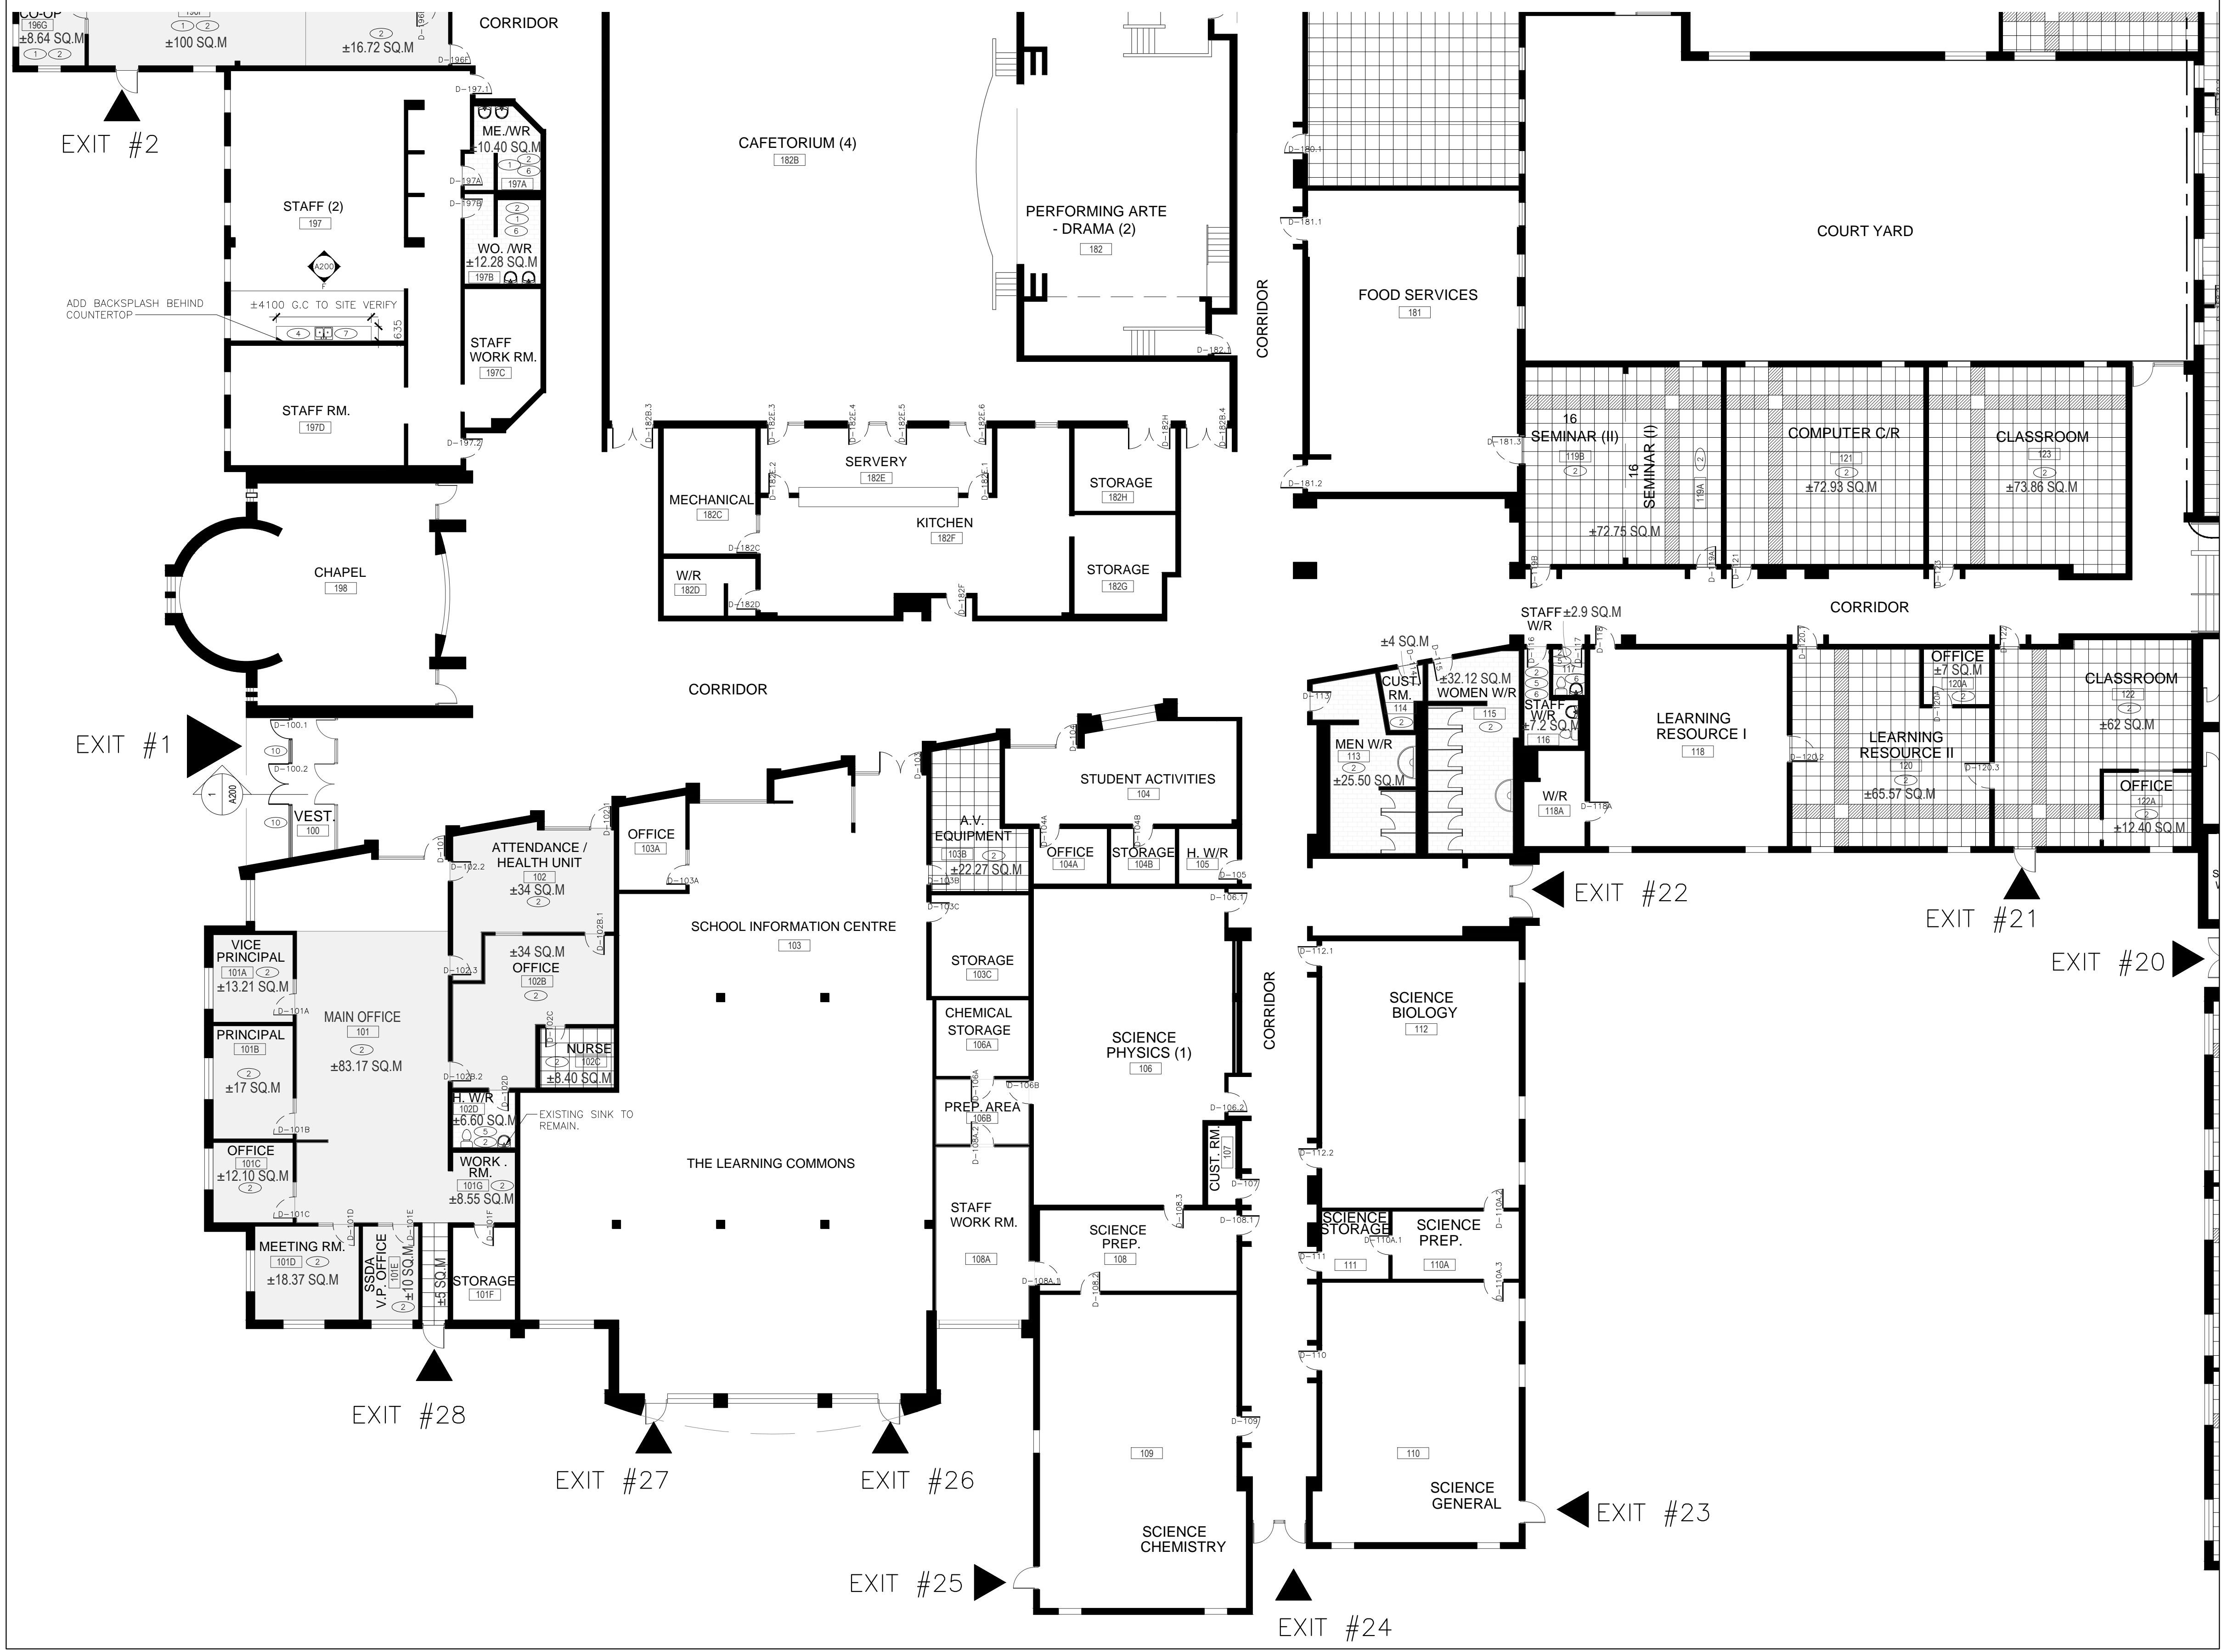

01 FIRST FLOOR PLAN - BLOCK A
1:150

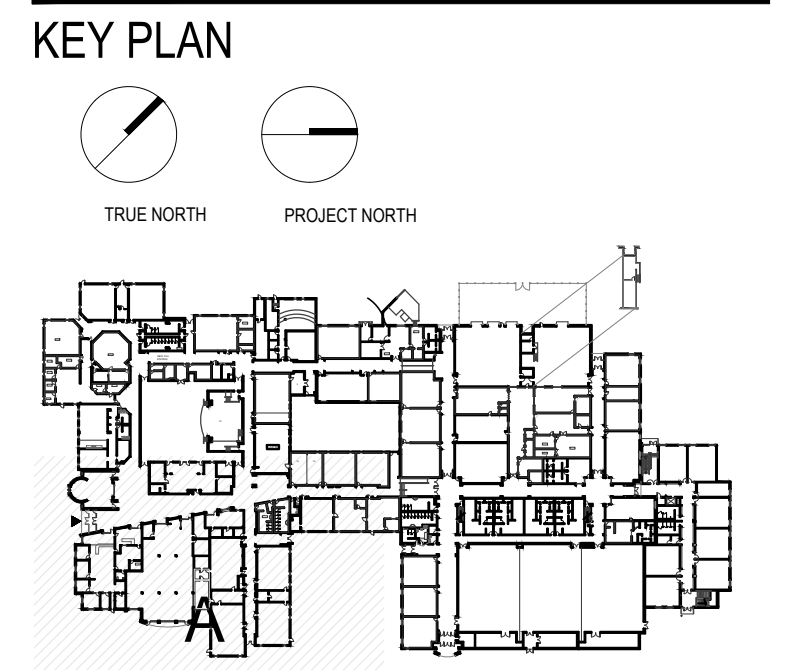

DATE	DESCRIPTION	No.
2024-02-15	ISSUE FOR TENDER	1

ALL DRAWINGS, SPECIFICATIONS AND RELATED DOCUMENTATION ARE COPYRIGHT PROPERTY OF 1721 ARCHITECTS INC. AND MUST BE RETURNED UPON REQUEST. REPRODUCTION OF DRAWINGS, SPECIFICATIONS AND RELATED DOCUMENTATION IN PART OR IN WHOLE IS WRITTEN FORBIDDEN WITHOUT THE WRITTEN PERMISSION OF 1721 ARCHITECTS INC.

DO NOT SCALE DRAWINGS
 CONTRACTOR MUST CHECK AND VERIFY ALL DIMENSION OF THE JOB.
 THIS DRAWING IS NOT TO BE USED FOR CONSTRUCTION UNTIL SIGNED BY THE ARCHITECT

Monsignor Doyle CSS

185 Myers Rd, Cambridge, ON N1R 7H2

DRAWING TITLE:
FIRST FLOOR PLAN - BLOCK A

CHECKED: SD
 DRAWN: RN
 PROJECT No. 2330

SCALE: AS NOTED

A100

GENERAL NOTES:

- A. REMOVE ALL WIRING FROM ELECTRICAL ITEMS THAT WILL BE REMOVED AND ALL REDUNDANT CONDUIT BACK TO NEAREST JUNCTION BOX THAT WILL REMAIN, AND MAKE SAFE. INSTALL METAL COVER PLATES OVER EXPOSED OPENINGS AND ELECTRICAL BOXES. REFER TO ELECTRICAL FOR ADDITIONAL REQUIREMENTS.
- B. MAKE GOOD ALL AREAS AFFECTED BY REMOVALS - FLUSH TO ADJACENT SURFACE AND MATCH EXISTING FINISH.
- C. DISPOSE OF ALL DESIGNATED SUBSTANCES TO THE REQUIREMENTS OF AUTHORITIES HAVING JURISDICTION.
- D. ALL PIPING THAT IS TO BE REMOVED OR ABANDONED IS TO BE REMOVED BACK TO THE NEAREST JUNCTION AND CAPPED. REFER TO MECHANICAL FOR ADDITIONAL REQUIREMENTS.
- E. NOTE ALL EXISTING ITEMS MAY NOT BE SHOWN ON THESE DRAWINGS. A CAREFUL REVIEW OF THE SITE IS REQUIRED TO DETERMINE THE FULL EXTENT OF THE WORK SHOWN.
- F. THE ARCHITECTURAL DRAWINGS ARE TO BE READ IN CONJUNCTION WITH ALL PROJECT MANUALS, STRUCTURAL, CIVIL, MECHANICAL AND ELECTRICAL DRAWINGS. IN CASE OF DIFFERENCES BETWEEN CONSULTANTS' DOCUMENTS WITH RESPECT TO QUANTITY, SIZES OR SCOPE, THE GREATER SHALL APPLY.
- G. PROVIDE PROTECTION FOR ALL FINISHES OR SERVICES TO REMAIN.
- H. ALL WINDOWS FALLING WITHIN THE DEMOLITION AREA ARE TO HAVE COVERINGS, THEIR FITTINGS, MOUNTING HARDWARE REMOVED & RETURNED TO THE OWNER, OR DISPOSE AS DIRECTED BY THE OWNER.
- I. DEMOLITION NOTE REFERENCE NUMBERS, WHERE LOCATED ADJACENT TO A ROOM NAME/NUMBER APPLY TO THE ENTIRETY OF THE ROOM.
- J. GENERAL CONTRACTOR IS TO ALLOW FOR THE SUPPLY AND INSTALLATION OF LOOSE LINTELS AS REQUIRED WHERE NEW OPENINGS ARE BEING CREATED OR WIDENED. REFER TO THE LOOSE LINTEL SCHEDULE PROVIDED ON THE DRAWINGS, OR PROVIDE ENGINEERING WHERE THERE ARE NO STRUCTURAL DRAWINGS / SCHEDULE.
- K. GC IS REQUIRED TO REMOVE ALL REMAINING ADHESIVES ON WALLS WHERE COMMUNICATION BOARDS WERE REMOVED UNLESS BEING COVERED WITH NEW BOARDS. TYPICAL FOR ALL ROOMS AFFECTED BY WORK.
- L. EXISTING LED BALLASTS AND BULBS TO BE TURNED OVER TO OWNER (COORDINATE WITH M&E)
- M. ALL WORK TO BE COORDINATED WITH THE ASBESTOS CONSULTANT'S DESIGNATED SUBSTANCES REPORT AND SCOPE OF WORK HOLDER ASSOCIATES LTD. IS THE BOARD'S ASBESTOS CONSULTANT.
- N. REFER TO OTHER NOTES ON SHEET A-100, A-101, A-102, A-103

LEGENDS:


- CONSTRUCTION NOTE REFERENCE NUMBER
- CARPET TILE
- CERAMIC TILE FLOORING
- IQ TILE W/ PATTERN

CONSTRUCTION NOTES:

- 1 ALL WALLS TO BE PAINTED. (PATCH AND MAKE GOOD ALL FINISHES).
 - 2 INSTALL NEW FLOORING & BASE BOARD.
 - 3 INSTALL NEW ACOUSTIC CEILING TILE AND SUPPORTS, WHERE CONCRETE MASONRY BLOCK REMOVED.
 - 4 INSTALL NEW COUNTERTOP ON EXISTING MILLWORK.
 - 5 INSTALL NEW TOILET. (REFER MECHANICAL DRAWINGS).
 - 6 INSTALL NEW WALL HUNG SINKS. (REFER MECHANICAL DRAWINGS). G.C TO PROVIDE WOOD BLOCKING WHERE REQUIRED FOR SUPPORT OF WALL HUNG SINK.
 - 7 INSTALL NEW KITCHEN SINK. (REFER MECHANICAL DRAWINGS).
 - 8 INFILL EXISTING WALL OPENING, WALL TYPE TO MATCH EXISTING WALL. REFER DETAIL 3 IN DRAWING A-200.
 - 9 INSTALL NEW DATA AND OUTLETS (REFER ELECTRICAL DRAWINGS).
 - 10 INSTALL NEW SCREEN. REFER DRAWING A1000.
 - 11 REPLACE AND REPAIR BROKEN MASONRY BLOCK WALL WITH NEW CONCRETE BLOCK.
- INSTALL NEW FLOOR STRIP BETWEEN OLD-NEW AND TWO DIFFERENT FLOORING.
- G.C TO REMOVE AND STORE ANY EQUIPMENT AND MOVE ABLE FURNITURE/MILLWORK WHILE INSTALLATION OF NEW FLOOR. REINSTALL AFTER WORK IS DONE.



ABBREVIATIONS

- AL ALUMINUM
- AND. ANODIZED
- WD WOOD
- HM HOLLOW METAL
- EX. HM EXISTING HOLLOW METAL
- STN STAIN
- PT PAINT

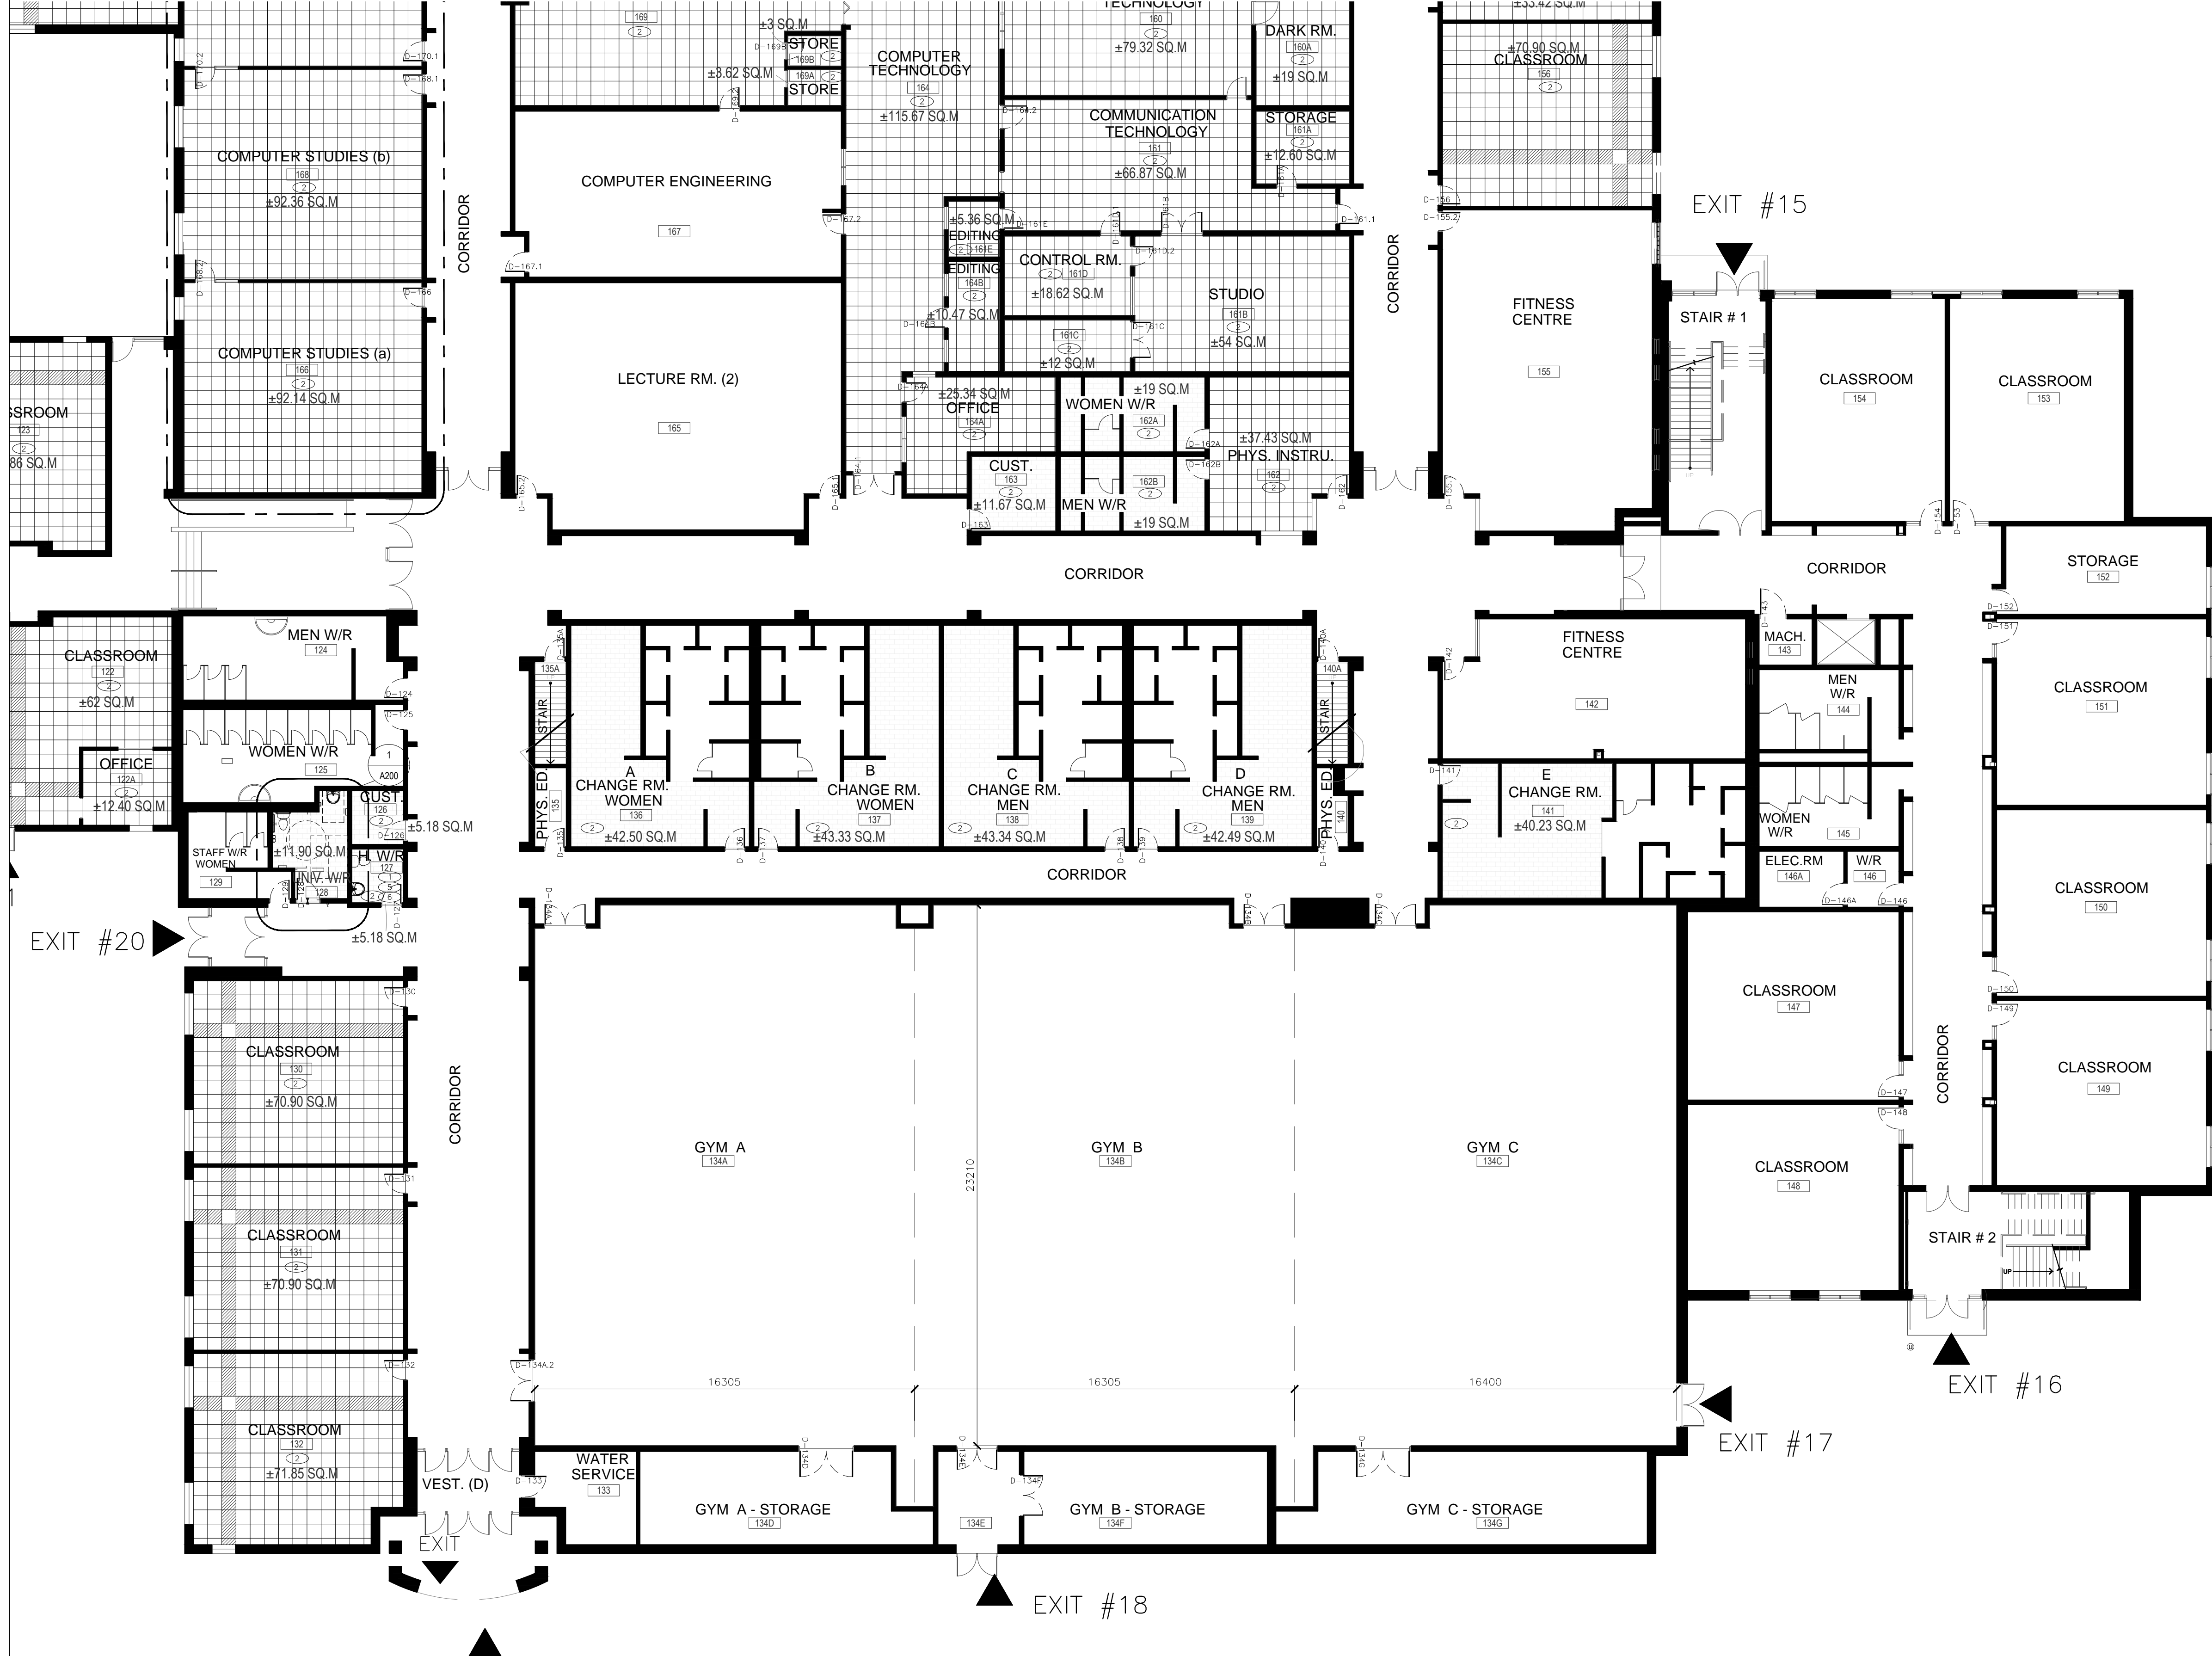

01 FIRST FLOOR PLAN - BLOCK B
1:150

KEY PLAN

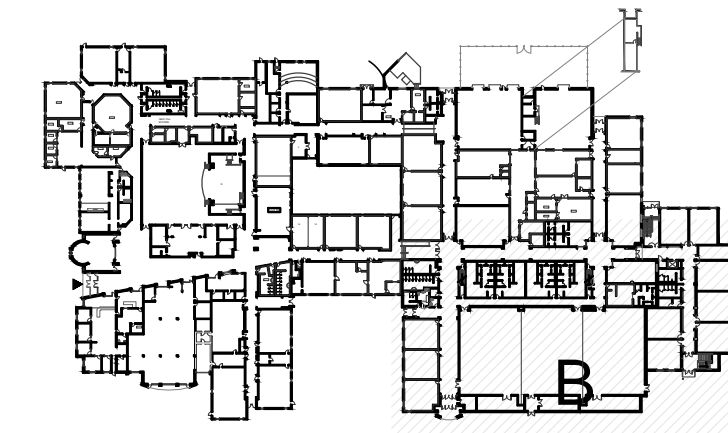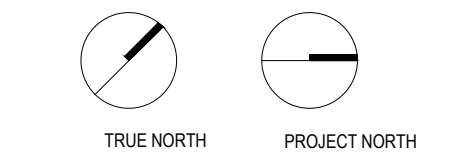

LEGEND

ISSUED

DATE	DESCRIPTION	No.
2024-02-15	ISSUE FOR TENDER	1

ALL DRAWINGS, SPECIFICATIONS AND RELATED DOCUMENTATION ARE COPYRIGHT PROPERTY OF 17|21 ARCHITECTS INC. AND MUST BE RETURNED UPON REQUEST. REPRODUCTION OF DRAWINGS, SPECIFICATIONS AND RELATED DOCUMENTATION IN PART OR IN WHOLE IS WRITTEN FORBIDDEN WITHOUT THE WRITTEN PERMISSION OF 17|21 ARCHITECTS INC.
DO NOT SCALE DRAWINGS
CONTRACTOR MUST CHECK AND VERIFY ALL DIMENSION OF THE JOB.
THIS DRAWING IS NOT TO BE USED FOR CONSTRUCTION UNTIL SIGNED BY THE ARCHITECT

Monsignor Doyle CSS

185 Myers Rd, Cambridge, ON N1R 7H2

DRAWING TITLE:
FIRST FLOOR PLAN - BLOCK B

CHECKED: SD
DRAWN: RN
PROJECT No. 2330

SCALE: AS NOTED

A101

GENERAL NOTES:

- A. REMOVE ALL WIRING FROM ELECTRICAL ITEMS THAT WILL BE REMOVED AND ALL REDUNDANT CONDUIT BACK TO NEAREST JUNCTION BOX THAT WILL REMAIN, AND MAKE SAFE. INSTALL METAL COVER PLATES OVER EXPOSED OPENINGS AND ELECTRICAL BOXES. REFER TO ELECTRICAL FOR ADDITIONAL REQUIREMENTS.
- B. MAKE GOOD ALL AREAS AFFECTED BY REMOVALS - FLUSH TO ADJACENT SURFACE AND MATCH EXISTING FINISH.
- C. DISPOSE OF ALL DESIGNATED SUBSTANCES TO THE REQUIREMENTS OF AUTHORITIES HAVING JURISDICTION.
- D. ALL PIPING THAT IS TO BE REMOVED OR ABANDONED IS TO BE REMOVED BACK TO THE NEAREST JUNCTION AND CAPPED. REFER TO MECHANICAL FOR ADDITIONAL REQUIREMENTS.
- E. NOTE ALL EXISTING ITEMS MAY NOT BE SHOWN ON THESE DRAWINGS. A CAREFUL REVIEW OF THE SITE IS REQUIRED TO DETERMINE THE FULL EXTENT OF THE WORK SHOWN.
- F. THE ARCHITECTURAL DRAWINGS ARE TO BE READ IN CONJUNCTION WITH ALL PROJECT MANUALS, STRUCTURAL, CIVIL, MECHANICAL AND ELECTRICAL DRAWINGS. IN CASE OF DIFFERENCES BETWEEN CONSULTANTS' DOCUMENTS WITH RESPECT TO QUANTITY, SIZES OR SCOPE, THE GREATER SHALL APPLY.
- G. PROVIDE PROTECTION FOR ALL FINISHES OR SERVICES TO REMAIN.
- H. ALL WINDOWS FALLING WITHIN THE DEMOLITION AREA ARE TO HAVE COVERINGS, THEIR FITTINGS, MOUNTING HARDWARE REMOVED & RETURNED TO THE OWNER, OR DISPOSE AS DIRECTED BY THE OWNER.
- I. DEMOLITION NOTE REFERENCE NUMBERS, WHERE LOCATED ADJACENT TO A ROOM NAME/NUMBER APPLY TO THE ENTIRETY OF THE ROOM.
- J. GENERAL CONTRACTOR IS TO ALLOW FOR THE SUPPLY AND INSTALLATION OF LOOSE LINTELS AS REQUIRED WHERE NEW OPENINGS ARE BEING CREATED OR WIDENED. REFER TO THE LOOSE LINTEL SCHEDULE PROVIDED ON THE DRAWINGS, OR PROVIDE ENGINEERING WHERE THERE ARE NO STRUCTURAL DRAWINGS / SCHEDULE.
- K. GC IS REQUIRED TO REMOVE ALL REMAINING ADHESIVES ON WALLS WHERE COMMUNICATION BOARDS WERE REMOVED UNLESS BEING COVERED WITH NEW BOARDS, TYPICAL FOR ALL ROOMS AFFECTED BY WORK.
- L. EXISTING LED BALLASTS AND BULBS TO BE TURNED OVER TO OWNER (COORDINATE WITH M&E)
- M. ALL WORK TO BE COORDINATED WITH THE ASBESTOS CONSULTANT'S DESIGNATED SUBSTANCES REPORT AND SCOPE OF WORK HOLDER ASSOCIATES LTD. IS THE BOARD'S ASBESTOS CONSULTANT.
- N. REFER TO OTHER NOTES ON SHEET A-100, A-101, A-102, A-103

LEGENDS:

- CONSTRUCTION NOTE REFERENCE NUMBER
- CARPET TILE
- CERAMIC TILE FLOORING
- IQ TILE W/ PATTERN


CONSTRUCTION NOTES:

- 1 ALL WALLS TO BE PAINTED. (PATCH AND MAKE GOOD ALL FINISHES).
- 2 INSTALL NEW FLOORING & BASE BOARD.
- 3 INSTALL NEW ACOUSTIC CEILING TILE AND SUPPORTS, WHERE CONCRETE MASONRY BLOCK REMOVED.
- 4 INSTALL NEW COUNTERTOP ON EXISTING MILLWORK.
- 5 INSTALL NEW TOILET. (REFER MECHANICAL DRAWINGS).
- 6 INSTALL NEW WALL HUNG SINKS. (REFER MECHANICAL DRAWINGS). G.C TO PROVIDE WOOD BLOCKING WHERE REQUIRED FOR SUPPORT OF WALL HUNG SINK.
- 7 INSTALL NEW KITCHEN SINK. (REFER MECHANICAL DRAWINGS).
- 8 INFILL EXISTING WALL OPENING, WALL TYPE TO MATCH EXISTING WALL. REFER DETAIL 3 IN DRAWING A-200.
- 9 INSTALL NEW DATA AND OUTLETS (REFER ELECTRICAL DRAWINGS).
- 10 INSTALL NEW SCREEN. REFER DRAWING A1000.
- 11 REPLACE AND REPAIR BROKEN MASONRY BLOCK WALL WITH NEW CONCRETE BLOCK.
- INSTALL NEW FLOOR STRIP BETWEEN OLD-NEW AND TWO DIFFERENT FLOORING.
- G.C TO REMOVE AND STORE ANY EQUIPMENT AND MOVE ABLE FURNITURE/MILLWORK WHILE INSTALLATION OF NEW FLOOR. REINSTALL AFTER WORK IS DONE.

ABBREVIATIONS

AL	ALUMINUM
AND.	ANODIZED
WD	WOOD
HM	HOLLOW METAL
EX.	HM EXISTING HOLLOW METAL
STN	STAIN
PT	PAINT

KEY PLAN

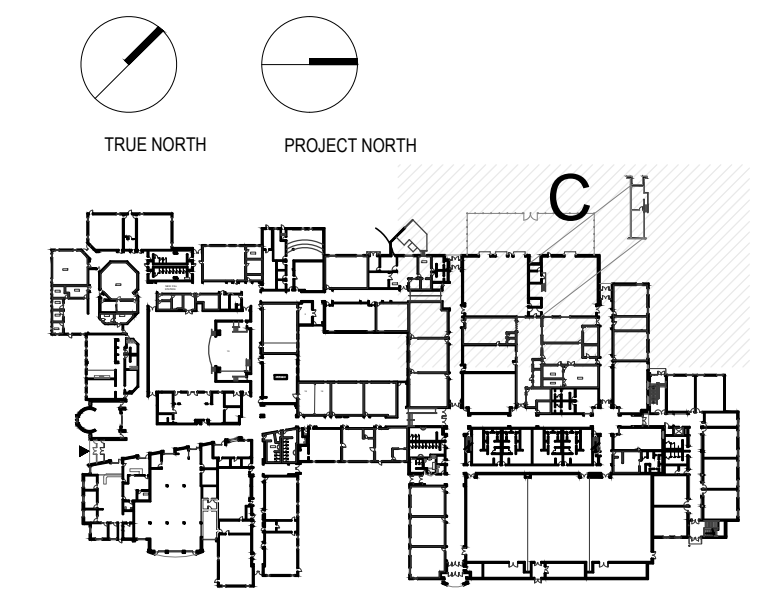

LEGEND

ISSUED

DATE	DESCRIPTION	No.
2024-02-15	ISSUE FOR TENDER	1

ALL DRAWINGS, SPECIFICATIONS AND RELATED DOCUMENTATION ARE COPYRIGHT PROPERTY OF 1721 ARCHITECTS INC. AND MUST BE RETURNED UPON REQUEST. REPRODUCTION OF DRAWINGS, SPECIFICATIONS AND RELATED DOCUMENTATION IN PART OR IN WHOLE IS WRITTEN FORBIDDEN WITHOUT THE WRITTEN PERMISSION OF 1721 ARCHITECTS INC.
DO NOT SCALE DRAWINGS
CONTRACTOR MUST CHECK AND VERIFY ALL DIMENSION OF THE JOB.
THIS DRAWING IS NOT TO BE USED FOR CONSTRUCTION UNTIL SIGNED BY THE ARCHITECT


Monsignor Doyle CSS

185 Myers Rd, Cambridge, ON N1R 7H2

DRAWING TITLE:
FIRST FLOOR PLAN - BLOCK C

CHECKED: SD
DRAWN: RM
PROJECT No. 2330

SCALE: AS NOTED

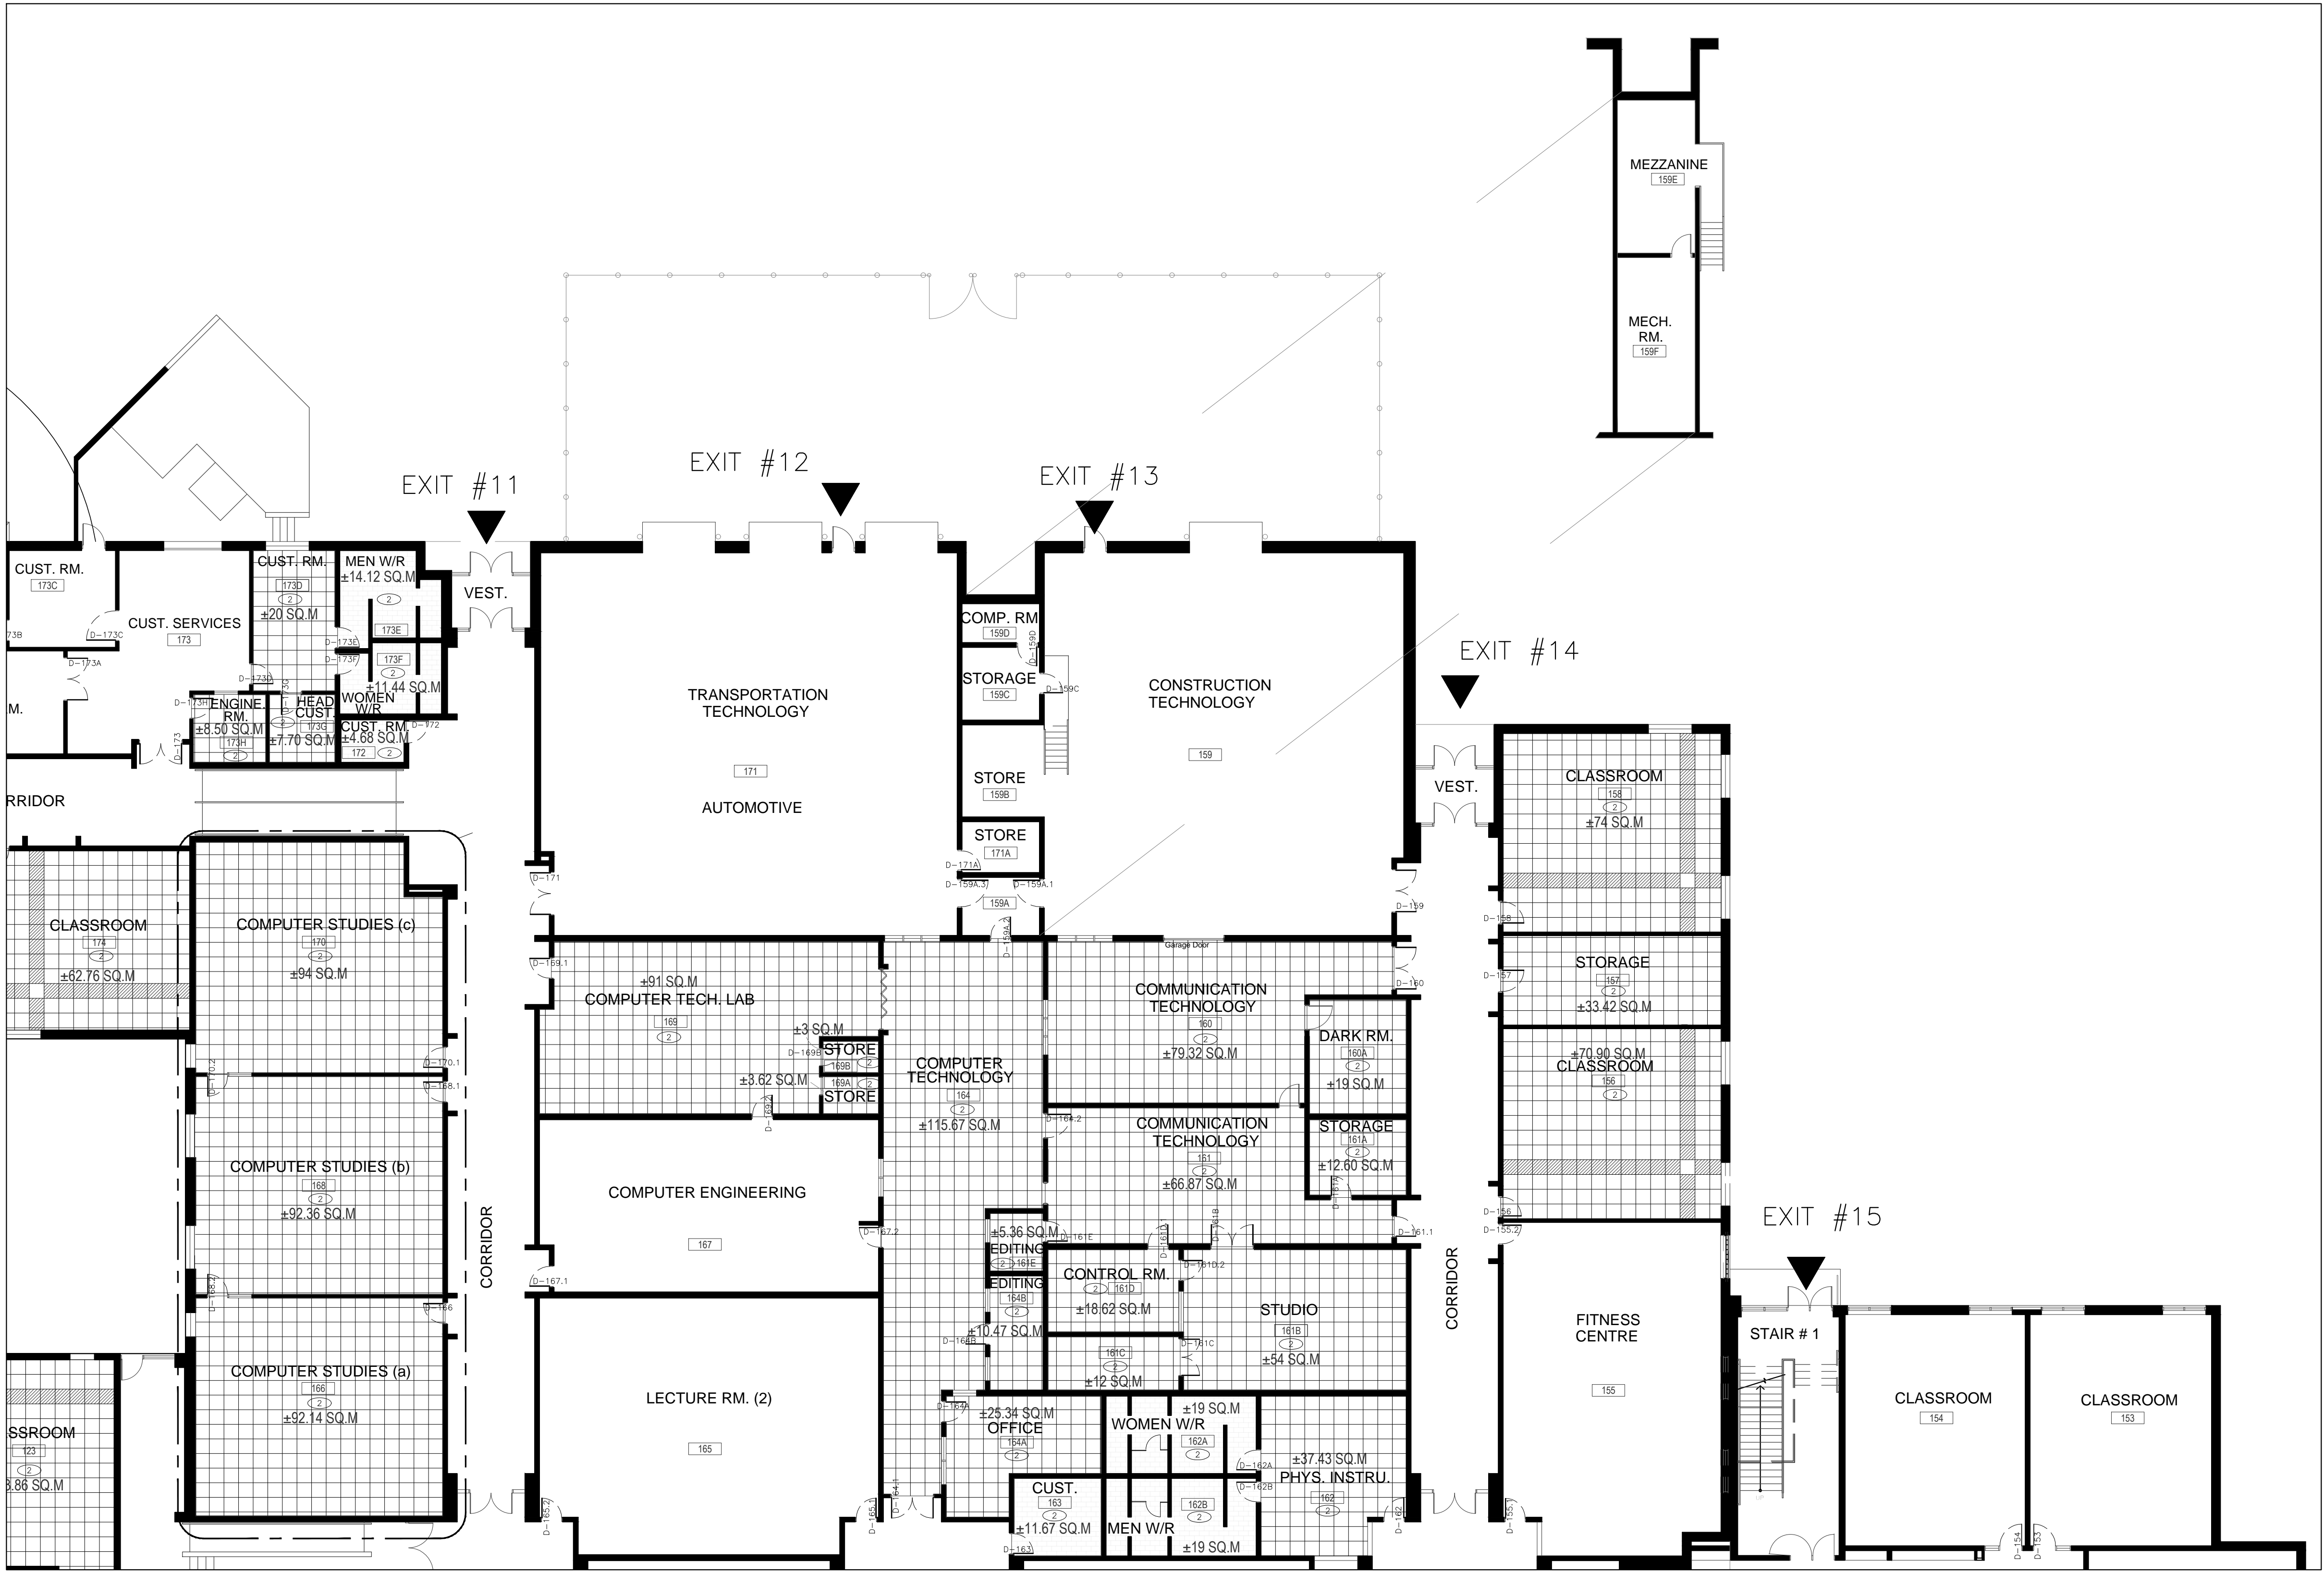

01 FIRST FLOOR PLAN - BLOCK C
1:150

GENERAL NOTES:

- REMOVE ALL WIRING FROM ELECTRICAL ITEMS THAT WILL BE REMOVED AND ALL REDUNDANT CONDUIT BACK TO NEAREST JUNCTION BOX THAT WILL REMAIN, AND MAKE SAFE. INSTALL METAL COVER PLATES OVER EXPOSED OPENINGS AND ELECTRICAL BOXES. REFER TO ELECTRICAL FOR ADDITIONAL REQUIREMENTS.
- MAKE GOOD ALL AREAS AFFECTED BY REMOVALS - FLUSH TO ADJACENT SURFACE AND MATCH EXISTING FINISH.
- DISPOSE OF ALL DESIGNATED SUBSTANCES TO THE REQUIREMENTS OF AUTHORITIES HAVING JURISDICTION.
- ALL PIPING THAT IS TO BE REMOVED OR ABANDONED IS TO BE REMOVED BACK TO THE NEAREST JUNCTION AND CAPPED. REFER TO MECHANICAL FOR ADDITIONAL REQUIREMENTS.
- NOTE ALL EXISTING ITEMS MAY NOT BE SHOWN ON THESE DRAWINGS. A CAREFUL REVIEW OF THE SITE IS REQUIRED TO DETERMINE THE FULL EXTENT OF THE WORK SHOWN.
- THE ARCHITECTURAL DRAWINGS ARE TO BE READ IN CONJUNCTION WITH ALL PROJECT MANUALS, STRUCTURAL, CIVIL, MECHANICAL AND ELECTRICAL DRAWINGS. IN CASE OF DIFFERENCES BETWEEN CONSULTANTS' DOCUMENTS WITH RESPECT TO QUANTITY, SIZES OR SCOPE, THE GREATER SHALL APPLY.
- PROVIDE PROTECTION FOR ALL FINISHES OR SERVICES TO REMAIN.
- ALL WINDOWS FALLING WITHIN THE DEMOLITION AREA ARE TO HAVE COVERINGS, THEIR FITTINGS, MOUNTING HARDWARE REMOVED & RETURNED TO THE OWNER, OR DISPOSE AS DIRECTED BY THE OWNER.
- DEMOLITION NOTE REFERENCE NUMBERS, WHERE LOCATED ADJACENT TO A ROOM NAME/NUMBER APPLY TO THE ENTIRETY OF THE ROOM.
- GENERAL CONTRACTOR IS TO ALLOW FOR THE SUPPLY AND INSTALLATION OF LOOSE LINTELS AS REQUIRED WHERE NEW OPENINGS ARE BEING CREATED OR WIDENED. REFER TO THE LOOSE LINTEL SCHEDULE PROVIDED ON THE DRAWINGS, OR PROVIDE ENGINEERING WHERE THERE ARE NO STRUCTURAL DRAWINGS / SCHEDULE.
- G.C. IS REQUIRED TO REMOVE ALL REMAINING ADHESIVES ON WALLS WHERE COMMUNICATION BOARDS WERE REMOVED UNLESS BEING COVERED WITH NEW BOARDS, TYPICAL FOR ALL ROOMS AFFECTED BY WORK.
- EXISTING LED BALLASTS AND BULBS TO BE TURNED OVER TO OWNER (COORDINATE WITH M&E)
- ALL WORK TO BE COORDINATED WITH THE ASBESTOS CONSULTANT'S DESIGNATED SUBSTANCES REPORT AND SCOPE OF WORK HOLDER ASSOCIATES LTD. IS THE BOARD'S ASBESTOS CONSULTANT.
- REFER TO OTHER NOTES ON SHEET A-100, A-101, A-102, A-103

LEGENDS:


- CONSTRUCTION NOTE REFERENCE NUMBER
- CARPET TILE
- CERAMIC TILE FLOORING
- IQ TILE W/ PATTERN

CONSTRUCTION NOTES:

- ALL WALLS TO BE PAINTED. (PATCH AND MAKE GOOD ALL FINISHES).
- INSTALL NEW FLOORING & BASE BOARD.
- INSTALL NEW ACOUSTIC CEILING TILE AND SUPPORTS, WHERE CONCRETE MASONRY BLOCK REMOVED.
- INSTALL NEW COUNTERTOP ON EXISTING MILLWORK.
- INSTALL NEW TOILET. (REFER MECHANICAL DRAWINGS).
- INSTALL NEW WALL HUNG SINKS. (REFER MECHANICAL DRAWINGS). G.C TO PROVIDE WOOD BLOCKING WHERE REQUIRED FOR SUPPORT OF WALL HUNG SINK.
- INSTALL NEW KITCHEN SINK. (REFER MECHANICAL DRAWINGS).
- INFILL EXISTING WALL OPENING, WALL TYPE TO MATCH EXISTING WALL. REFER DETAIL 3 IN DRAWING A-200.
- INSTALL NEW DATA AND OUTLETS (REFER ELECTRICAL DRAWINGS).
- INSTALL NEW SCREEN. REFER DRAWING A1000.
- REPLACE AND REPAIR BROKEN MASONRY BLOCK WALL WITH NEW CONCRETE BLOCK.
- INSTALL NEW FLOOR STRIP BETWEEN OLD-NEW AND TWO DIFFERENT FLOORING.
- G.C TO REMOVE AND STORE ANY EQUIPMENT AND MOVE ABLE FURNITURE/MILLWORK WHILE INSTALLATION OF NEW FLOOR. REINSTALL AFTER WORK IS DONE.


ABBREVIATIONS

- AL ALUMINUM
- AND. ANODIZED
- WD WOOD
- HM HOLLOW METAL
- EX. HM EXISTING HOLLOW METAL
- STN STAIN
- PT PAINT

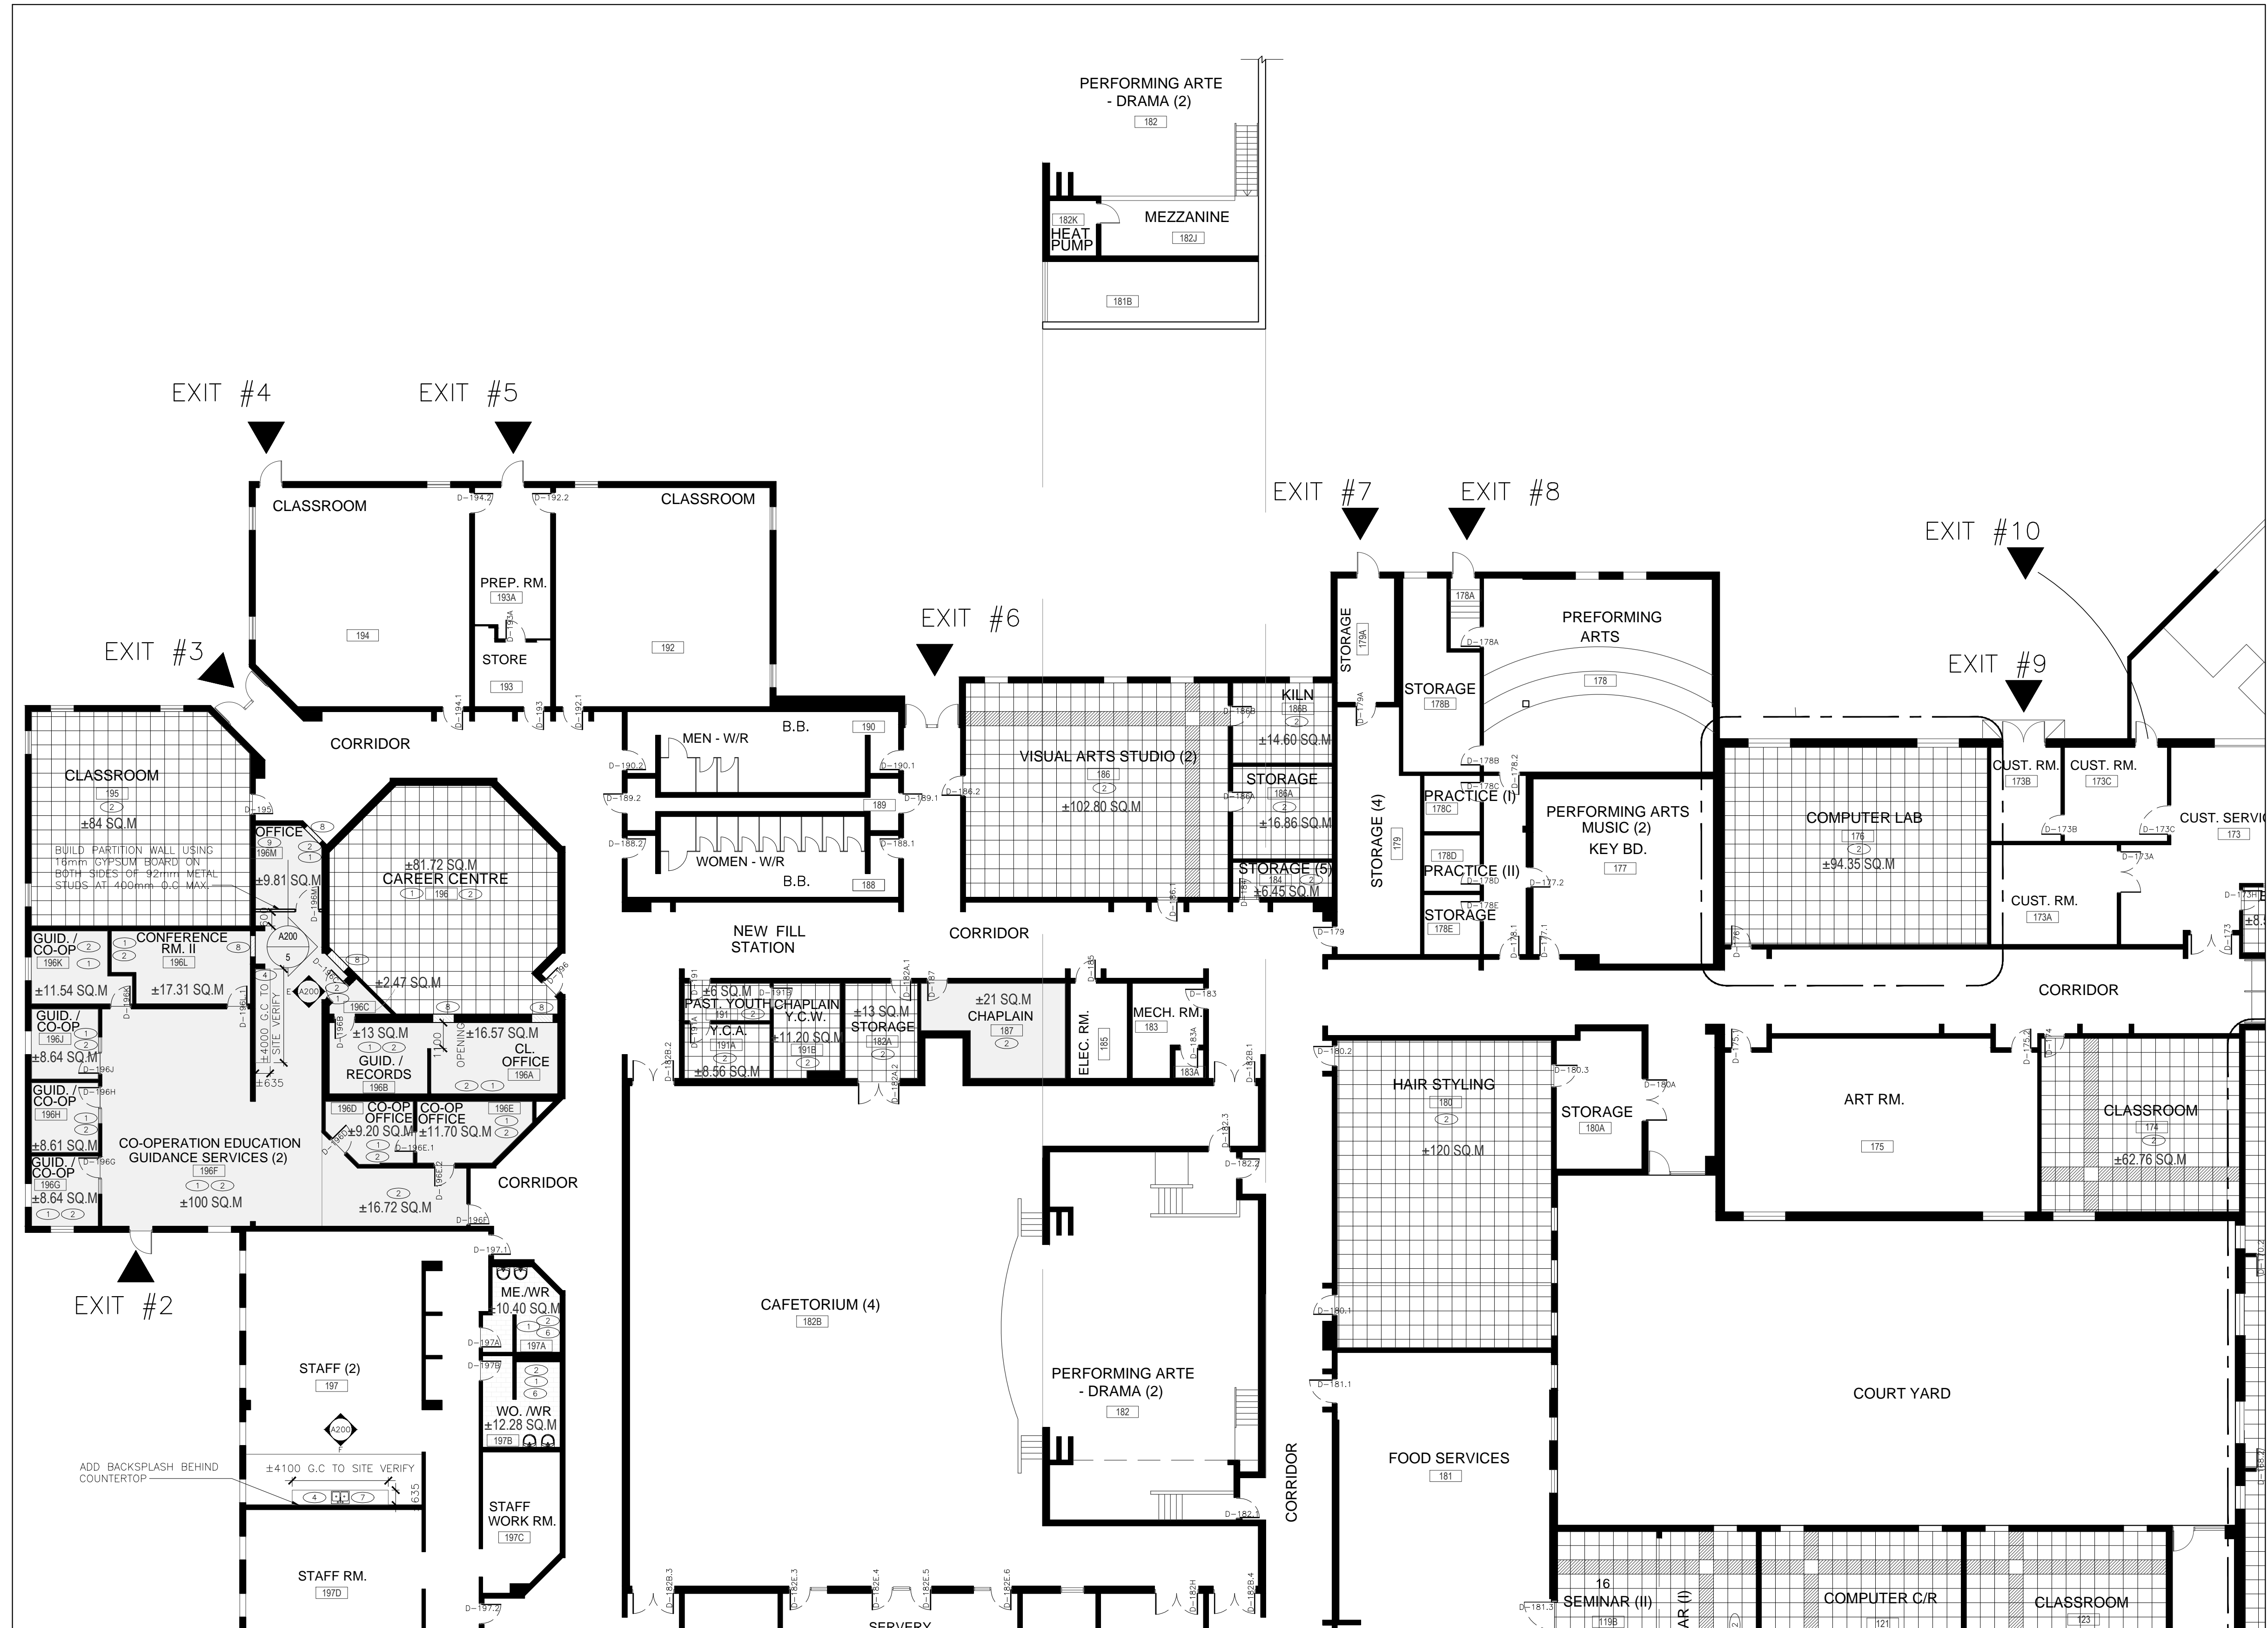

01 FIRST FLOOR PLAN - BLOCK D
1:150

KEY PLAN

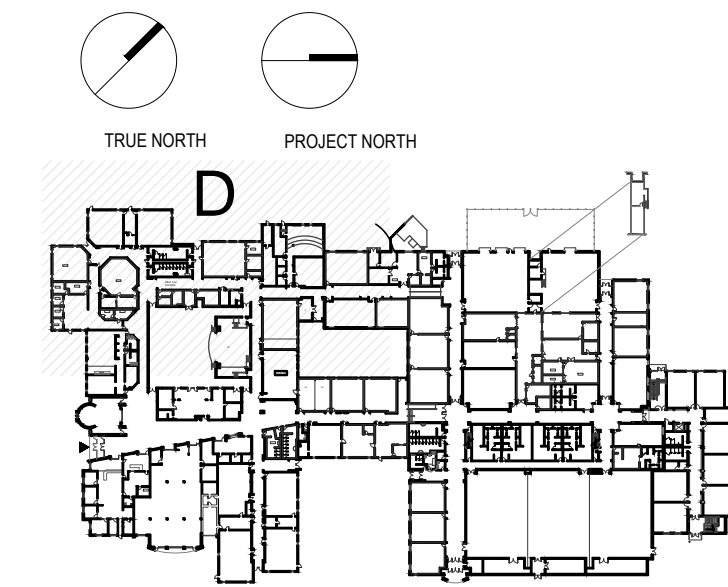

LEGEND

ISSUED

DATE	DESCRIPTION	No.
2024-02-15	ISSUE FOR TENDER	1

ALL DRAWINGS, SPECIFICATIONS AND RELATED DOCUMENTATION ARE COPYRIGHT PROPERTY OF 1721 ARCHITECTS INC. AND MUST BE RETURNED UPON REQUEST. REPRODUCTION OF DRAWINGS, SPECIFICATIONS AND RELATED DOCUMENTATION IN PART OR IN WHOLE IS WRITTEN FORBIDDEN WITHOUT THE WRITTEN PERMISSION OF 1721 ARCHITECTS INC.
DO NOT SCALE DRAWINGS
CONTRACTOR MUST CHECK AND VERIFY ALL DIMENSION OF THE JOB.
THIS DRAWING IS NOT TO BE USED FOR CONSTRUCTION UNTIL SIGNED BY THE ARCHITECT

Monsignor Doyle CSS

185 Myers Rd, Cambridge, ON N1R 7H2

DRAWING TITLE:
FIRST FLOOR PLAN - BLOCK D

CHECKED: SD
DRAWN: RN
PROJECT No. 2330

SCALE: AS NOTED

GENERAL NOTES:

- A. REMOVE ALL WIRING FROM ELECTRICAL ITEMS THAT WILL BE REMOVED AND ALL REDUNDANT CONDUIT BACK TO NEAREST JUNCTION BOX THAT WILL REMAIN, AND MAKE SAFE. INSTALL METAL COVER PLATES OVER EXPOSED OPENINGS AND ELECTRICAL BOXES. REFER TO ELECTRICAL FOR ADDITIONAL REQUIREMENTS.
- B. MAKE GOOD ALL AREAS AFFECTED BY REMOVALS - FLUSH TO ADJACENT SURFACE AND MATCH EXISTING FINISH.
- C. DISPOSE OF ALL DESIGNATED SUBSTANCES TO THE REQUIREMENTS OF AUTHORITIES HAVING JURISDICTION.
- D. ALL PIPING THAT IS TO BE REMOVED OR ABANDONED IS TO BE REMOVED BACK TO THE NEAREST JUNCTION AND CAPPED. REFER TO MECHANICAL FOR ADDITIONAL REQUIREMENTS.
- E. NOTE ALL EXISTING ITEMS MAY NOT BE SHOWN ON THESE DRAWINGS. A CAREFUL REVIEW OF THE SITE IS REQUIRED TO DETERMINE THE FULL EXTENT OF THE WORK SHOWN.
- F. THE ARCHITECTURAL DRAWINGS ARE TO BE READ IN CONJUNCTION WITH ALL PROJECT MANUALS, STRUCTURAL, CIVIL, MECHANICAL AND ELECTRICAL DRAWINGS. IN CASE OF DIFFERENCES BETWEEN CONSULTANTS' DOCUMENTS WITH RESPECT TO QUANTITY, SIZES OR SCOPE, THE GREATER SHALL APPLY.
- G. PROVIDE PROTECTION FOR ALL FINISHES OR SERVICES TO REMAIN.
- H. ALL WINDOWS FALLING WITHIN THE DEMOLITION AREA ARE TO HAVE COVERINGS, THEIR FITTINGS, MOUNTING HARDWARE REMOVED & RETURNED TO THE OWNER, OR DISPOSE AS DIRECTED BY THE OWNER.
- I. DEMOLITION NOTE REFERENCE NUMBERS, WHERE LOCATED ADJACENT TO A ROOM NAME/NUMBER APPLY TO THE ENTIRETY OF THE ROOM.
- J. GENERAL CONTRACTOR IS TO ALLOW FOR THE SUPPLY AND INSTALLATION OF LOOSE LINTELS AS REQUIRED WHERE NEW OPENINGS ARE BEING CREATED OR WIDENED. REFER TO THE LOOSE LINTEL SCHEDULE PROVIDED ON THE DRAWINGS, OR PROVIDE ENGINEERING WHERE THERE ARE NO STRUCTURAL DRAWINGS / SCHEDULE.
- K. GC IS REQUIRED TO REMOVE ALL REMAINING ADHESIVES ON WALLS WHERE COMMUNICATION BOARDS WERE REMOVED UNLESS BEING COVERED WITH NEW BOARDS, TYPICAL FOR ALL ROOMS AFFECTED BY WORK.
- L. EXISTING LED BALLASTS AND BULBS TO BE TURNED OVER TO OWNER (COORDINATE WITH M&E)
- M. ALL WORK TO BE COORDINATED WITH THE ASBESTOS CONSULTANT'S DESIGNATED SUBSTANCES REPORT AND SCOPE OF WORK HOLDER ASSOCIATES LTD. IS THE BOARD'S ASBESTOS CONSULTANT.
- N. REFER TO OTHER NOTES ON SHEET A-100, A-101, A-102, A-103

LEGENDS:


- CONSTRUCTION NOTE REFERENCE NUMBER
- CARPET TILE
- CERAMIC TILE FLOORING
- IQ TILE W/ PATTERN

CONSTRUCTION NOTES:

- 1 ALL WALLS TO BE PAINTED. (PATCH AND MAKE GOOD ALL FINISHES).
 - 2 INSTALL NEW FLOORING & BASE BOARD.
 - 3 INSTALL NEW ACOUSTIC CEILING TILE AND SUPPORTS, WHERE CONCRETE MASONRY BLOCK REMOVED.
 - 4 INSTALL NEW COUNTERTOP ON EXISTING MILLWORK.
 - 5 INSTALL NEW TOILET. (REFER MECHANICAL DRAWINGS).
 - 6 INSTALL NEW WALL HUNG SINKS. (REFER MECHANICAL DRAWINGS). G.C TO PROVIDE WOOD BLOCKING WHERE REQUIRED FOR SUPPORT OF WALL HUNG SINK.
 - 7 INSTALL NEW KITCHEN SINK. (REFER MECHANICAL DRAWINGS).
 - 8 INFILL EXISTING WALL OPENING, WALL TYPE TO MATCH EXISTING WALL. REFER DETAIL 3 IN DRAWING A-200.
 - 9 INSTALL NEW DATA AND OUTLETS (REFER ELECTRICAL DRAWINGS).
 - 10 INSTALL NEW SCREEN. REFER DRAWING A1000.
 - 11 REPLACE AND REPAIR BROKEN MASONRY BLOCK WALL WITH NEW CONCRETE BLOCK.
- INSTALL NEW FLOOR STRIP BETWEEN OLD-NEW AND TWO DIFFERENT FLOORING.
- G.C TO REMOVE AND STORE ANY EQUIPMENT AND MOVE ABLE FURNITURE/MILLWORK WHILE INSTALLATION OF NEW FLOOR. REINSTALL AFTER WORK IS DONE.



ABBREVIATIONS

- AL ALUMINUM
- AND. ANODIZED
- WD WOOD
- HM HOLLOW METAL
- EX. HW EXISTING HOLLOW METAL
- STN STAIN
- PT PAINT

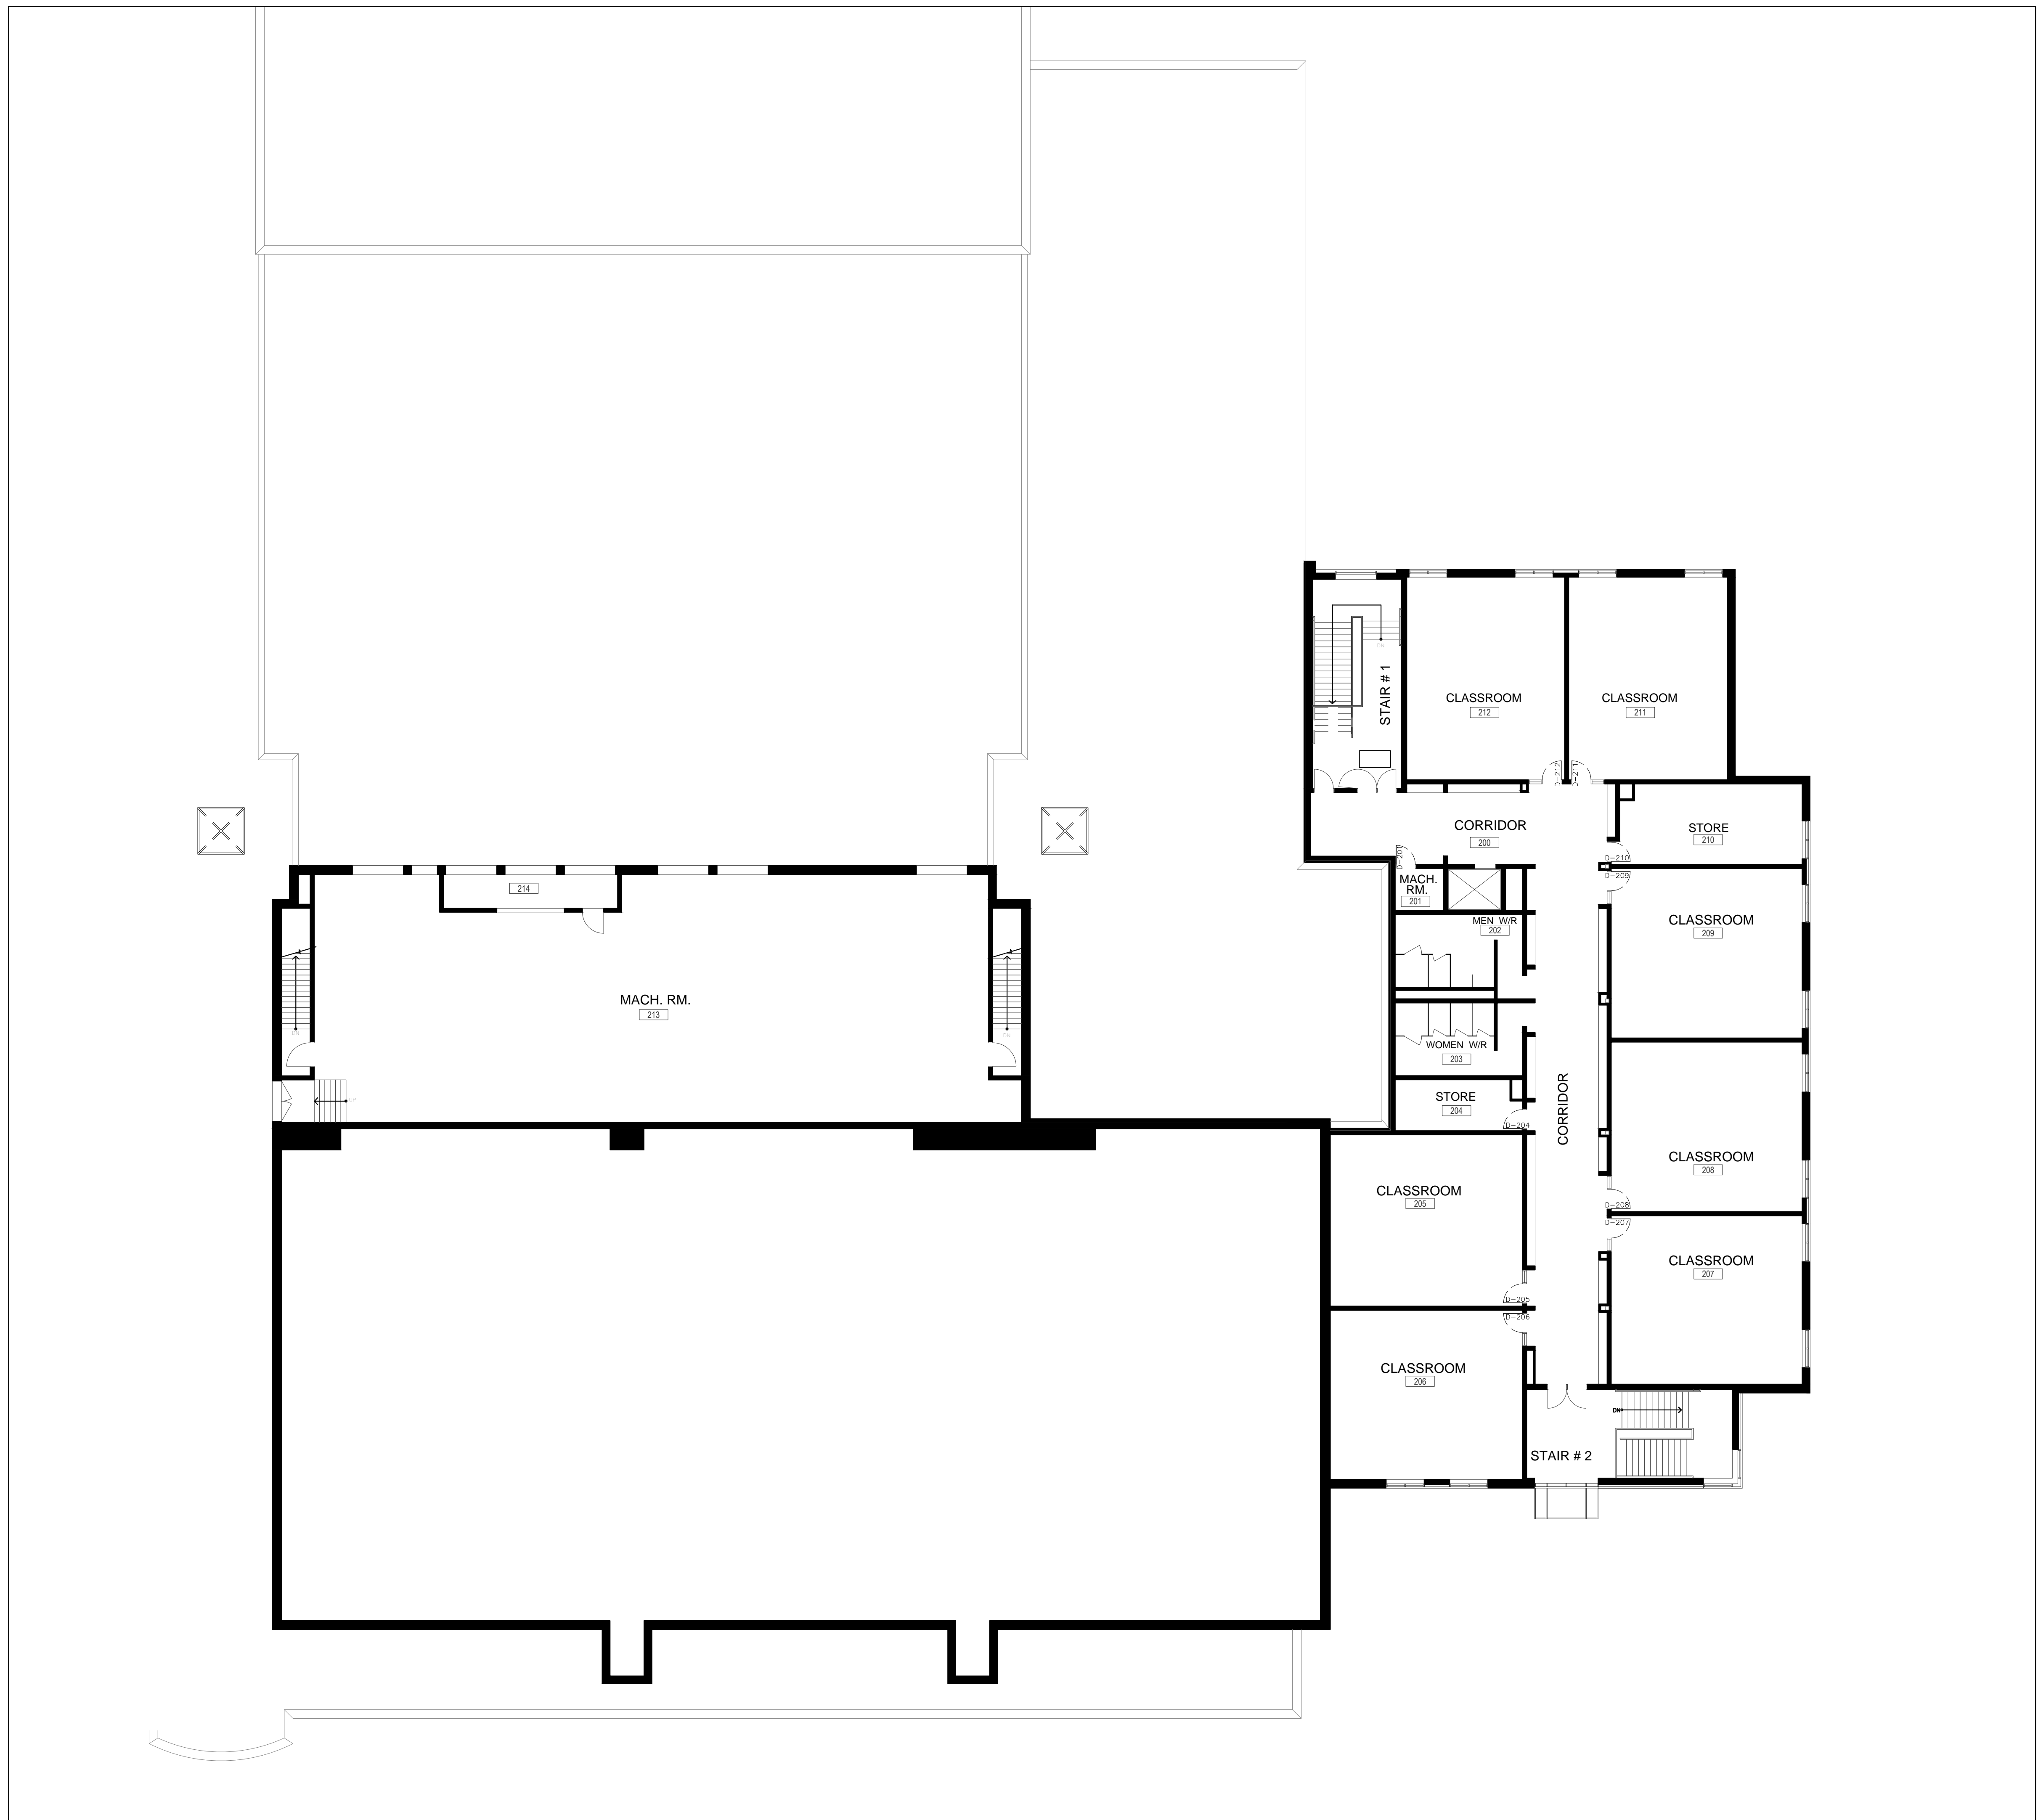

01 SECOND FLOOR PLAN - BLOCK B
1:150

KEY PLAN

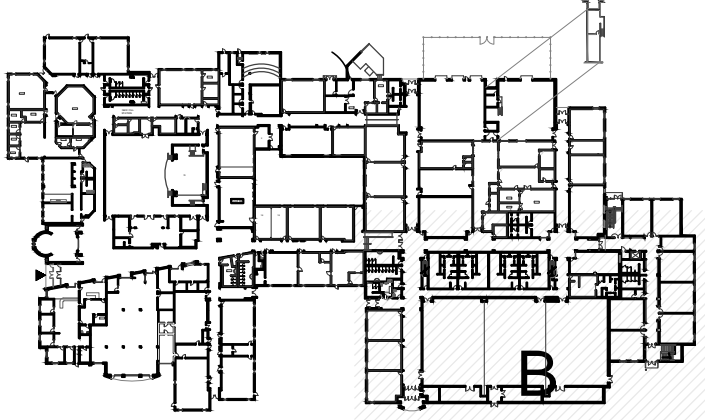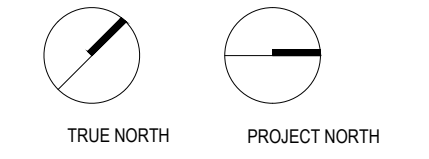

LEGEND

ISSUED

DATE	DESCRIPTION	No.
2024-02-15	ISSUE FOR TENDER	1

ALL DRAWINGS, SPECIFICATIONS AND RELATED DOCUMENTATION ARE COPYRIGHT PROPERTY OF 1721 ARCHITECTS INC. AND MUST BE RETURNED UPON REQUEST. REPRODUCTION OF DRAWINGS, SPECIFICATIONS AND RELATED DOCUMENTATION IN PART OR IN WHOLE IS WRITTEN FORBIDDEN WITHOUT THE WRITTEN PERMISSION OF 1721 ARCHITECTS INC.
DO NOT SCALE DRAWINGS
CONTRACTOR MUST CHECK AND VERIFY ALL DIMENSION OF THE JOB.
THIS DRAWING IS NOT TO BE USED FOR CONSTRUCTION UNTIL SIGNED BY THE ARCHITECT

Monsignor Doyle CSS


185 Myers Rd, Cambridge, ON N1R 7H2

DRAWING TITLE:
SECOND FLOOR PLAN - BLOCK B


CHECKED: SD
DRAWN: RN
PROJECT No. 2330

SCALE: AS NOTED


A104

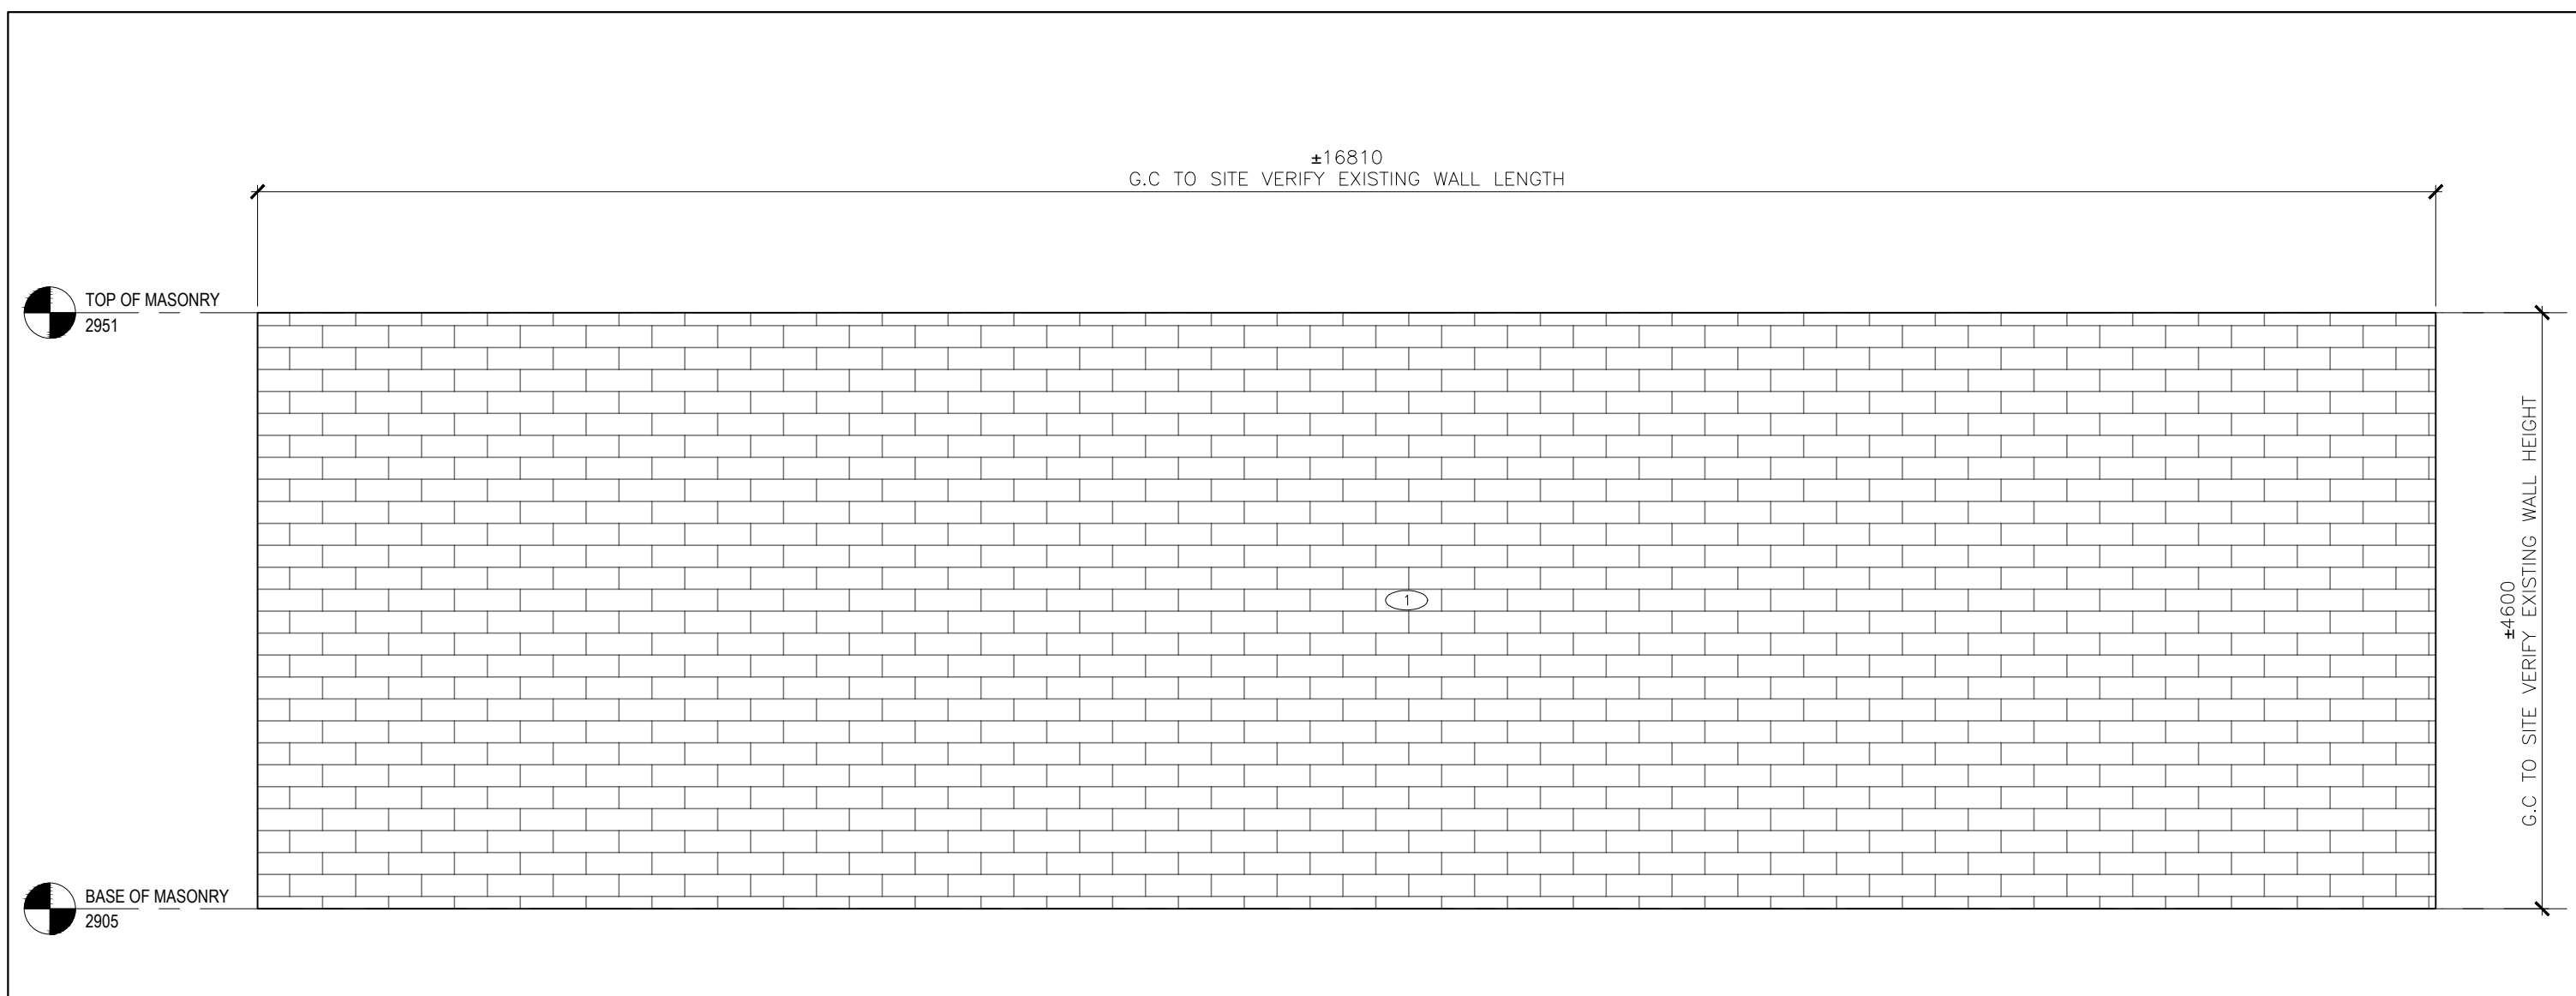


03 ELEVATION A
1:50

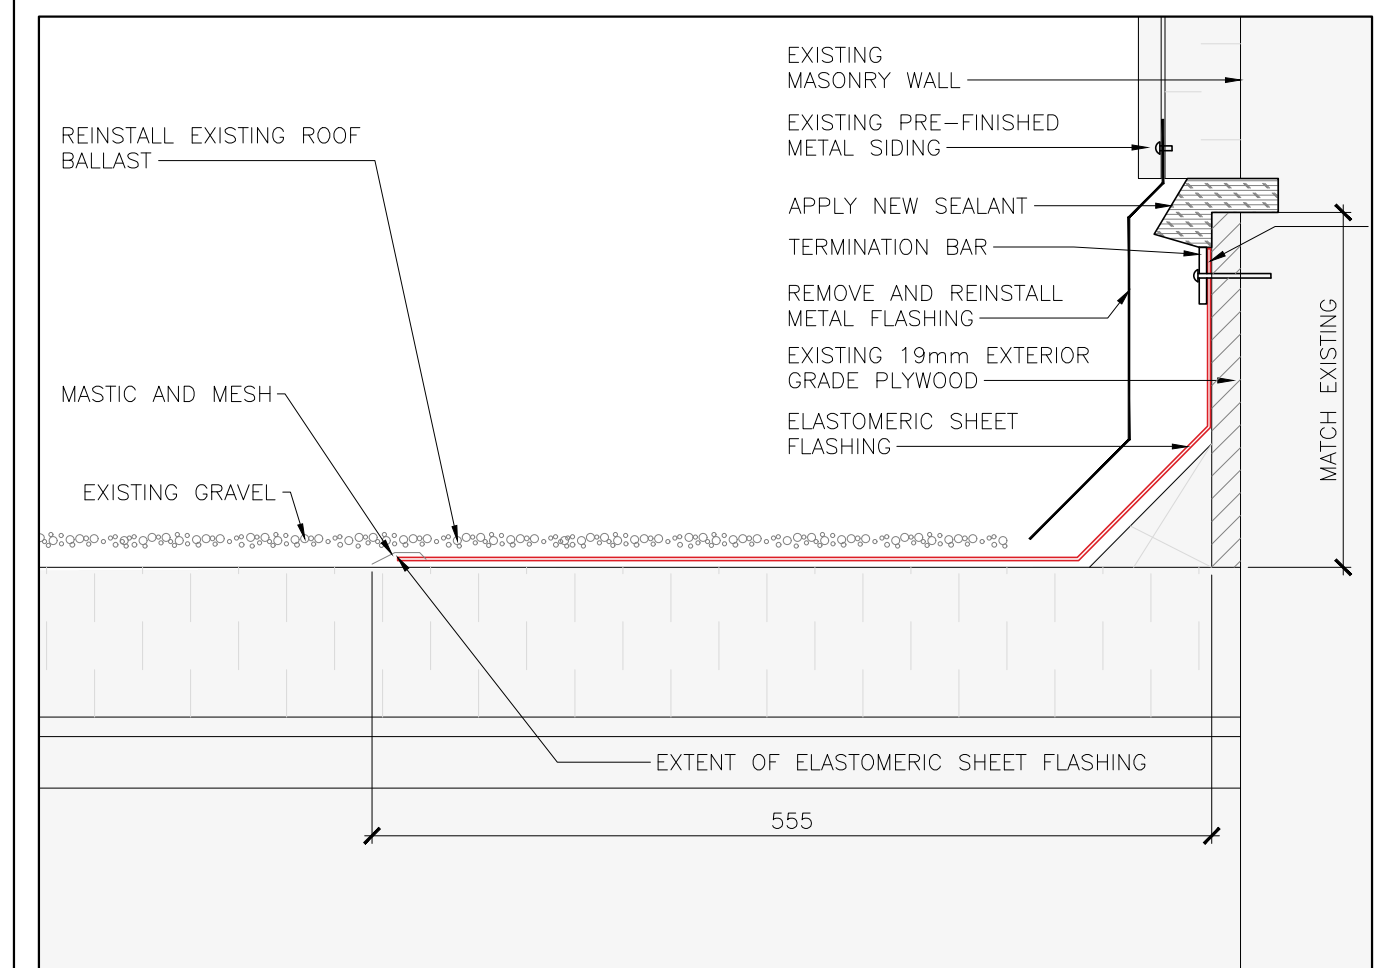

02 ROOF REPAIR DETAIL
1:5

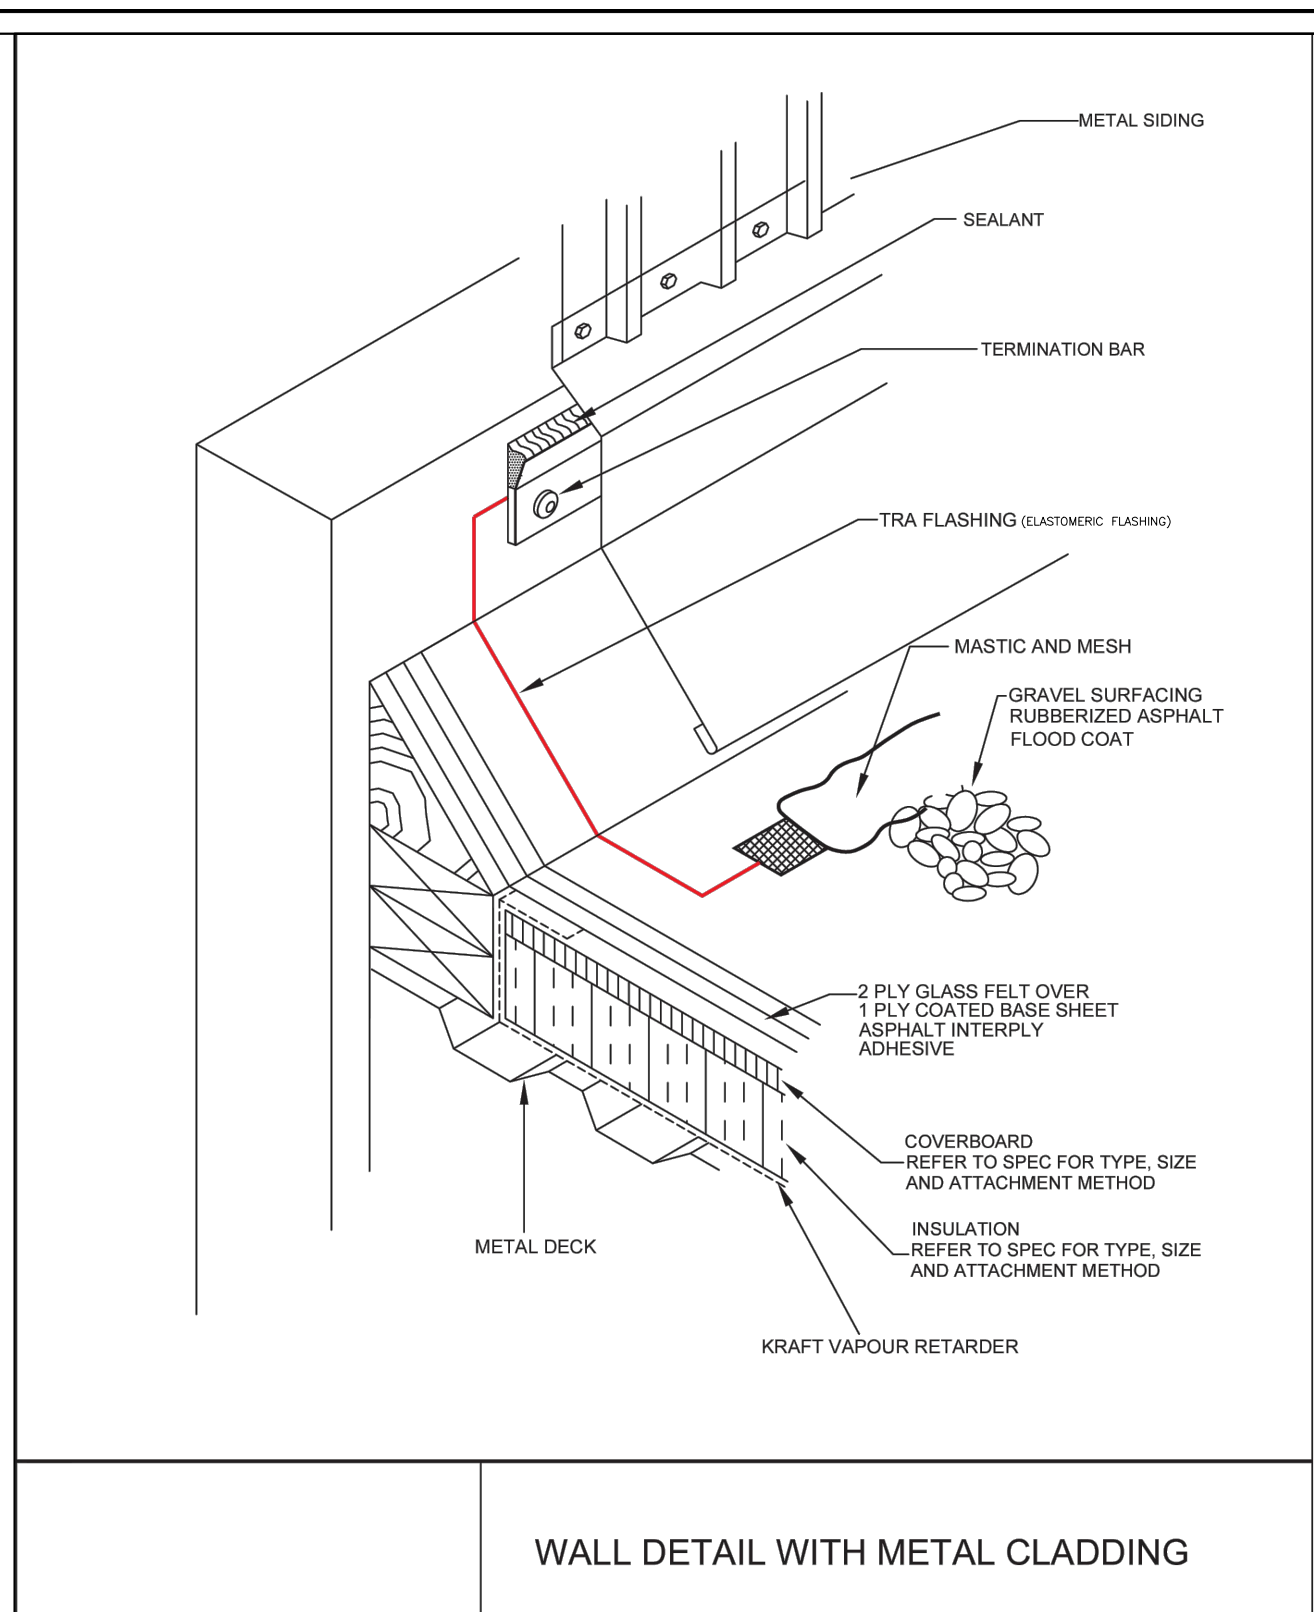

01 ROOF REPAIR DETAIL
NOT TO SCALE

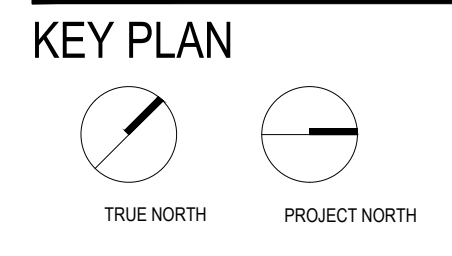


LEGEND

GENERAL NOTES:

- A. REMOVE ALL WIRING FROM ELECTRICAL ITEMS THAT WILL BE REMOVED AND ALL REDUNDANT CONDUIT BACK TO NEAREST JUNCTION BOX THAT WILL REMAIN, AND MAKE SAFE. INSTALL METAL COVER PLATES OVER EXPOSED OPENINGS AND ELECTRICAL BOXES. REFER TO ELECTRICAL FOR ADDITIONAL REQUIREMENTS.
- B. MAKE GOOD ALL AREAS AFFECTED BY REMOVALS - FLUSH TO ADJACENT SURFACE AND MATCH EXISTING FINISH.
- C. DISPOSE OF ALL DESIGNATED SUBSTANCES TO THE REQUIREMENTS OF AUTHORITIES HAVING JURISDICTION.
- D. ALL PIPING THAT IS TO BE REMOVED OR ABANDONED IS TO BE REMOVED BACK TO THE NEAREST JUNCTION AND CAPPED. REFER TO MECHANICAL FOR ADDITIONAL REQUIREMENTS.
- E. NOTE ALL EXISTING ITEMS MAY NOT BE SHOWN ON THESE DRAWINGS. A CAREFUL REVIEW OF THE SITE IS REQUIRED TO DETERMINE THE FULL EXTENT OF THE WORK SHOWN.
- F. THE ARCHITECTURAL DRAWINGS ARE TO BE READ IN CONJUNCTION WITH ALL PROJECT MANUALS, STRUCTURAL, CIVIL, MECHANICAL AND ELECTRICAL DRAWINGS. IN CASE OF DIFFERENCES BETWEEN CONSULTANTS' DOCUMENTS WITH RESPECT TO QUANTITY, SIZES OR SCOPE, THE GREATER SHALL APPLY.
- G. PROVIDE PROTECTION FOR ALL FINISHES OR SERVICES TO REMAIN.
- H. ALL WINDOWS FALLING WITHIN THE DEMOLITION AREA ARE TO HAVE COVERINGS, THEIR FITTINGS, MOUNTING HARDWARE REMOVED & RETURNED TO THE OWNER, OR DISPOSE AS DIRECTED BY THE OWNER.
- I. DEMOLITION NOTE REFERENCE NUMBERS, WHERE LOCATED ADJACENT TO A ROOM NAME/NUMBER APPLY TO THE ENTIRETY OF THE ROOM.
- J. GENERAL CONTRACTOR IS TO ALLOW FOR THE SUPPLY AND INSTALLATION OF LOOSE LINTELS AS REQUIRED WHERE NEW OPENINGS ARE BEING CREATED OR WIDENED. REFER TO THE LOOSE LINTEL SCHEDULE PROVIDED ON THE DRAWINGS, OR PROVIDE ENGINEERING WHERE THERE ARE NO STRUCTURAL DRAWINGS // SCHEDULE.
- K. GC IS REQUIRED TO REMOVE ALL REMAINING ADHESIVES ON WALLS WHERE COMMUNICATION BOARDS WERE REMOVED UNLESS BEING COVERED WITH NEW BOARDS, TYPICAL FOR ALL ROOMS AFFECTED BY WORK.
- L. EXISTING LED BALLASTS AND BULBS TO BE TURNED OVER TO OWNER (COORDINATE WITH M&E)
- M. ALL WORK TO BE COORDINATED WITH THE ASBESTOS CONSULTANT'S DESIGNATED SUBSTANCES REPORT AND SCOPE OF WORK HOLDER ASSOCIATES LTD. IS THE BOARD'S ASBESTOS CONSULTANT.
- N. REFER TO OTHER NOTES ON SHEET A-100

CONSTRUCTION NOTES:

- ① BRICK POINTING WORK TO BE DONE ON THE EXTERIOR SIDE OF THE ENTIRE WALL.
- ② INSTALL NEW BASE FLASHING ON ENTIRE WALL BASE.

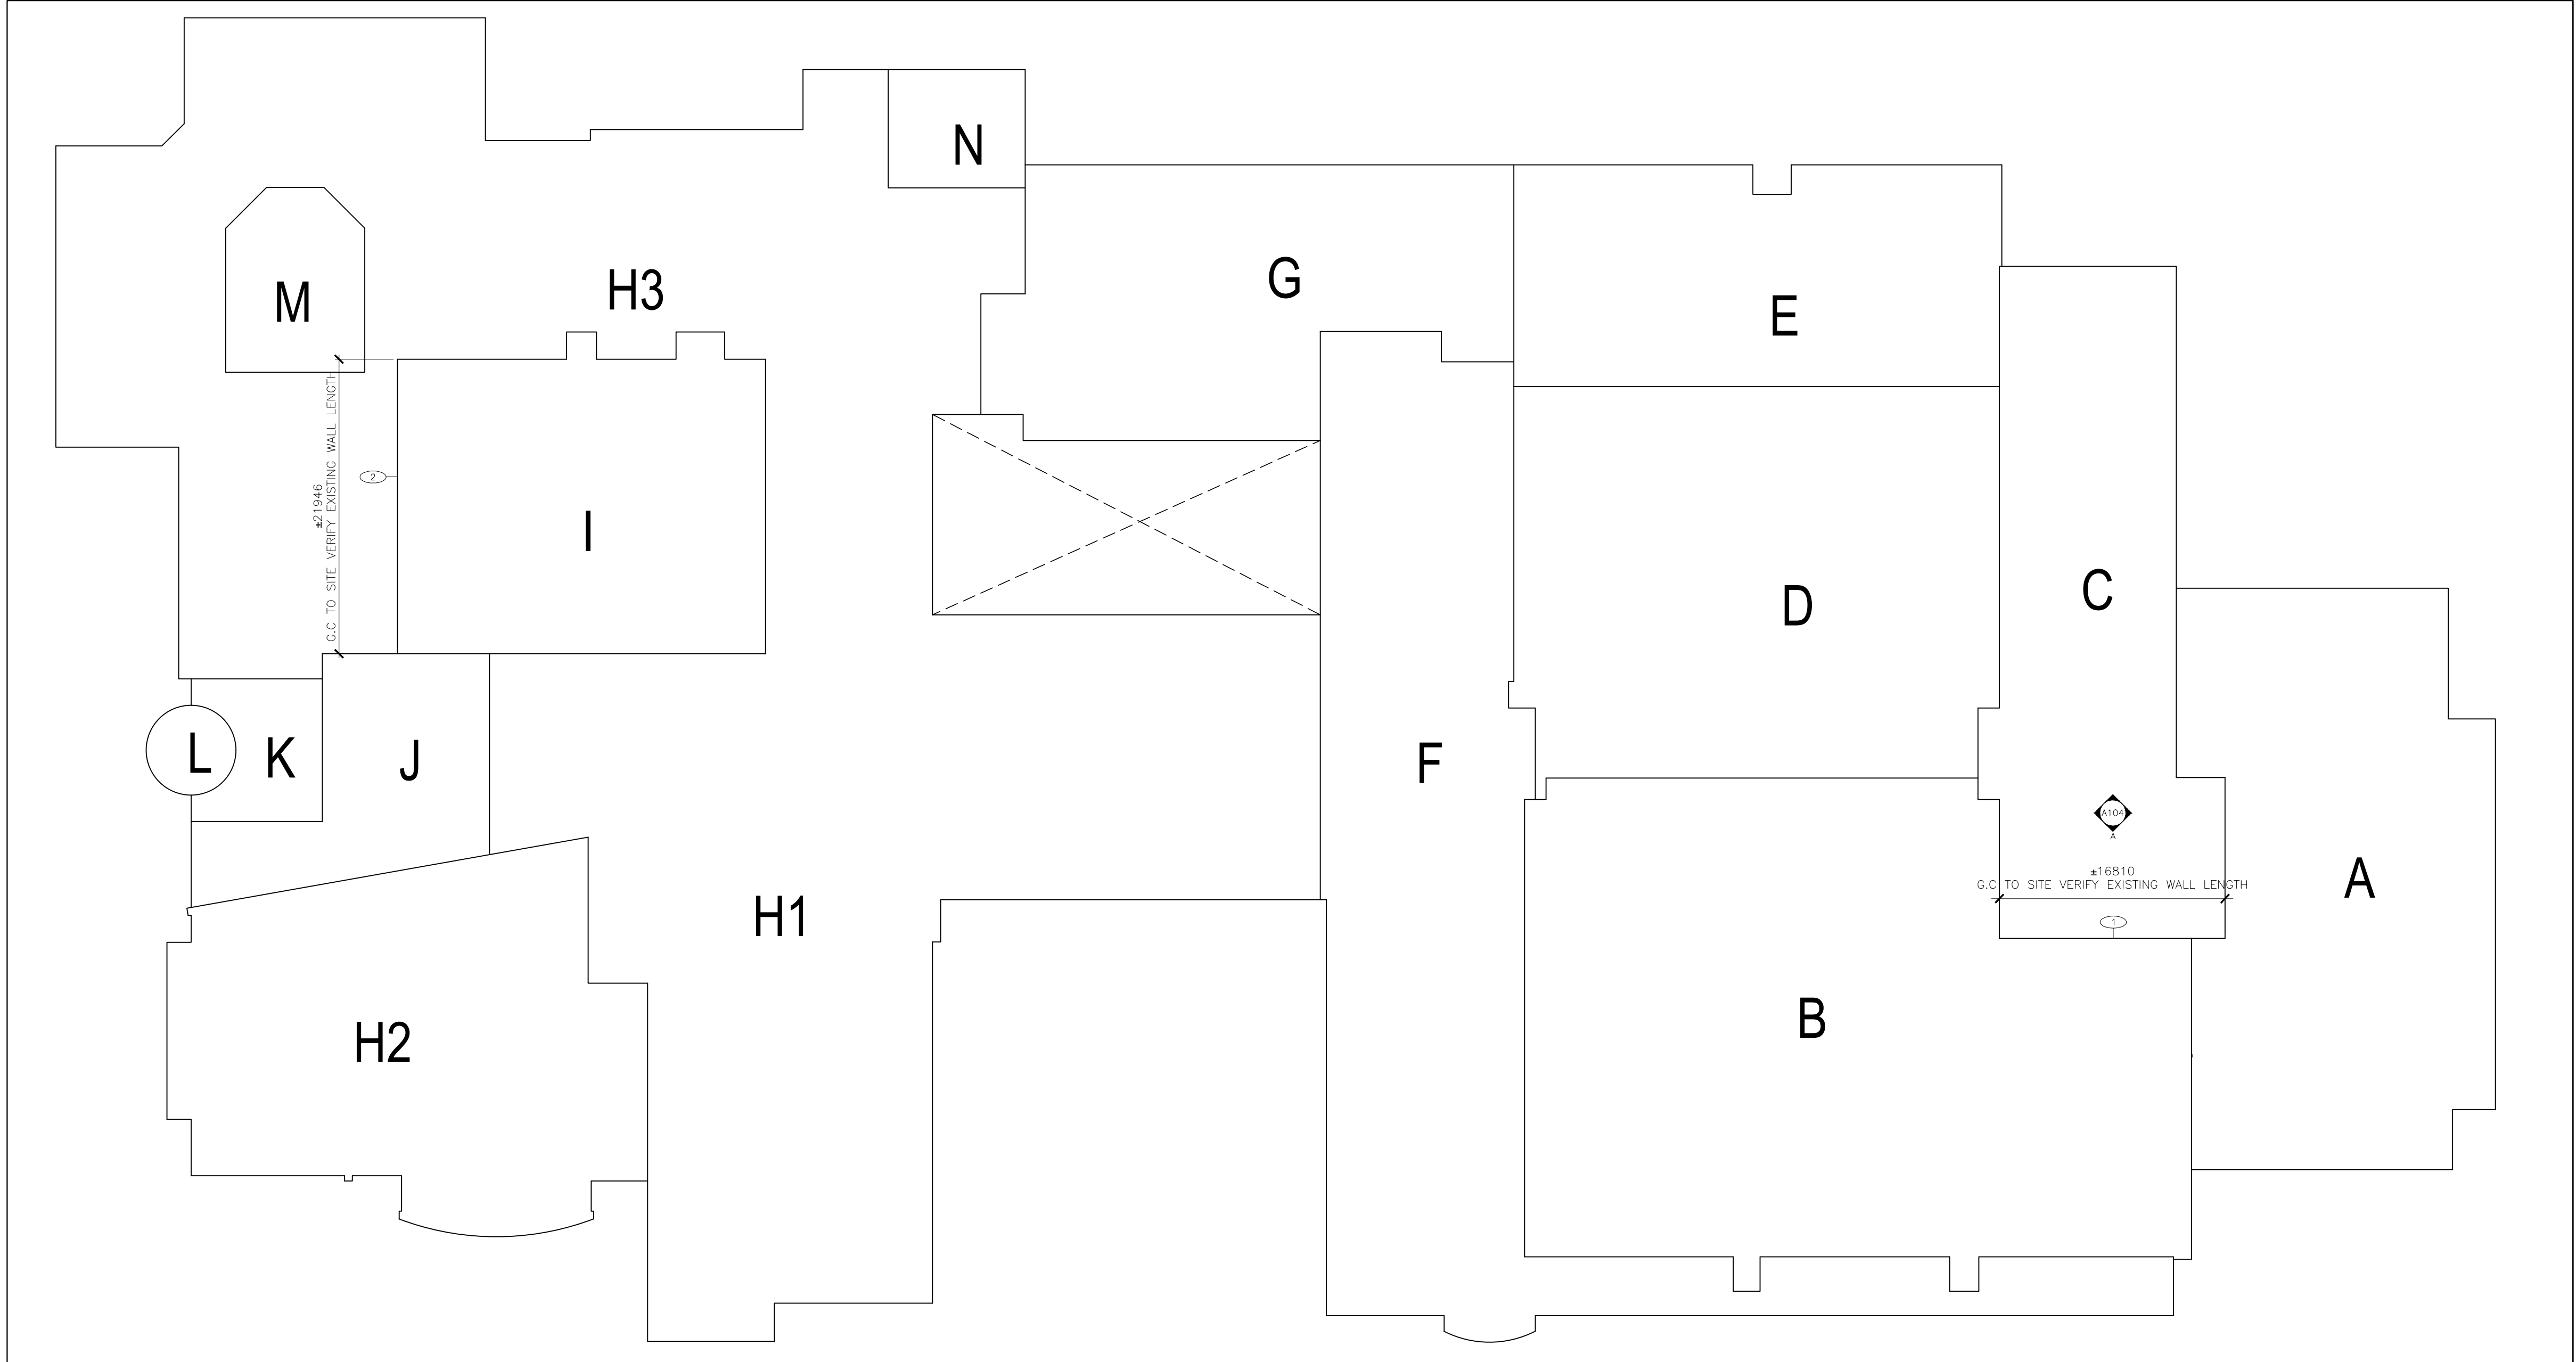

04 ROOF PLAN
1:300

ISSUED

DATE	DESCRIPTION	No.
2024-02-15	ISSUE FOR TENDER	1

ALL DRAWINGS, SPECIFICATIONS AND RELATED DOCUMENTATION ARE COPYRIGHT PROPERTY OF 1721 ARCHITECTS INC. AND MUST BE RETURNED UPON REQUEST. REPRODUCTION OF DRAWINGS, SPECIFICATIONS AND RELATED DOCUMENTATION IN PART OR IN WHOLE IS WRITTEN FORBIDDEN WITHOUT THE WRITTEN PERMISSION OF 1721 ARCHITECTS INC.
 DO NOT SCALE DRAWINGS
 CONTRACTOR MUST CHECK AND VERIFY ALL DIMENSION OF THE JOB.
 THIS DRAWING IS NOT TO BE USED FOR CONSTRUCTION UNTIL SIGNED BY THE ARCHITECT

Monsignor Doyle CSS

185 Myers Rd, Cambridge, ON N1R 7H2

ROOF PLAN

CHECKED: SD
 DRAWN: RN
 PROJECT No. 2330


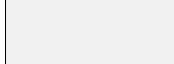


SCALE: AS NOTED

A104

GENERAL NOTES:


- REMOVE ALL WIRING FROM ELECTRICAL ITEMS THAT WILL BE REMOVED AND ALL REDUNDANT CONDUIT BACK TO NEAREST JUNCTION BOX THAT WILL REMAIN, AND MAKE SAFE. INSTALL METAL COVER PLATES OVER EXPOSED OPENINGS AND ELECTRICAL BOXES. REFER TO ELECTRICAL FOR ADDITIONAL REQUIREMENTS.
- MAKE GOOD ALL AREAS AFFECTED BY REMOVALS - FLUSH TO ADJACENT SURFACE AND MATCH EXISTING FINISH.
- DISPOSE OF ALL DESIGNATED SUBSTANCES TO THE REQUIREMENTS OF AUTHORITIES HAVING JURISDICTION.
- ALL PIPING THAT IS TO BE REMOVED OR ABANDONED IS TO BE REMOVED BACK TO THE NEAREST JUNCTION AND CAPPED. REFER TO MECHANICAL FOR ADDITIONAL REQUIREMENTS.
- NOTE ALL EXISTING ITEMS MAY NOT BE SHOWN ON THESE DRAWINGS. A CAREFUL REVIEW OF THE SITE IS REQUIRED TO DETERMINE THE FULL EXTENT OF THE WORK SHOWN.
- THE ARCHITECTURAL DRAWINGS ARE TO BE READ IN CONJUNCTION WITH ALL PROJECT MANUALS, STRUCTURAL, CIVIL, MECHANICAL AND ELECTRICAL DRAWINGS. IN CASE OF DIFFERENCES BETWEEN CONSULTANTS' DOCUMENTS WITH RESPECT TO QUANTITY, SIZES OR SCOPE, THE GREATER SHALL APPLY.
- PROVIDE PROTECTION FOR ALL FINISHES OR SERVICES TO REMAIN.
- ALL WINDOWS FALLING WITHIN THE DEMOLITION AREA ARE TO HAVE COVERINGS, THEIR FITTINGS, MOUNTING HARDWARE REMOVED & RETURNED TO THE OWNER, OR DISPOSE AS DIRECTED BY THE OWNER.
- DEMOLITION NOTE REFERENCE NUMBERS, WHERE LOCATED ADJACENT TO A ROOM NAME/NUMBER APPLY TO THE ENTIRETY OF THE ROOM.
- GENERAL CONTRACTOR IS TO ALLOW FOR THE SUPPLY AND INSTALLATION OF LOOSE LINTELS AS REQUIRED WHERE NEW OPENINGS ARE BEING CREATED OR WIDENED. REFER TO THE LOOSE LINTEL SCHEDULE PROVIDED ON THE DRAWINGS, OR PROVIDE ENGINEERING WHERE THERE ARE NO STRUCTURAL DRAWINGS / SCHEDULE.
- GC IS REQUIRED TO REMOVE ALL REMAINING ADHESIVES ON WALLS WHERE COMMUNICATION BOARDS WERE REMOVED UNLESS BEING COVERED WITH NEW BOARDS, TYPICAL FOR ALL ROOMS AFFECTED BY WORK.
- EXISTING LED BALLASTS AND BULBS TO BE TURNED OVER TO OWNER (COORDINATE WITH M&E)
- ALL WORK TO BE COORDINATED WITH THE ASBESTOS CONSULTANT'S DESIGNATED SUBSTANCES REPORT AND SCOPE OF WORK HOLDER ASSOCIATES LTD. IS THE BOARD'S ASBESTOS CONSULTANT.
- REFER TO OTHER NOTES ON SHEET A-100, A-101, A-102, A-103

LEGENDS:


-  CONSTRUCTION NOTE REFERENCE NUMBER
-  CARPET TILE
-  CERAMIC TILE FLOORING
-  IQ TILE W/ PATTERN

CONSTRUCTION NOTES:


- ALL WALLS TO BE PAINTED. (PATCH AND MAKE GOOD ALL FINISHES).
- INSTALL NEW FLOORING & BASE BOARD.
- INSTALL NEW ACOUSTIC CEILING TILE AND SUPPORTS, WHERE CONCRETE MASONRY BLOCK REMOVED.
- INSTALL NEW COUNTERTOP ON EXISTING MILLWORK.
- INSTALL NEW TOILET. (REFER MECHANICAL DRAWINGS).
- INSTALL NEW WALL HUNG SINKS. (REFER MECHANICAL DRAWINGS). G.C TO PROVIDE WOOD BLOCKING WHERE REQUIRED FOR SUPPORT OF WALL HUNG SINK.
- INSTALL NEW KITCHEN SINK. (REFER MECHANICAL DRAWINGS).
- INFILL EXISTING WALL OPENING, WALL TYPE TO MATCH EXISTING WALL. REFER DETAIL 3 IN DRAWING A-200.
- INSTALL NEW DATA AND OUTLETS (REFER ELECTRICAL DRAWINGS).
- INSTALL NEW SCREEN. REFER DRAWING A1000.
- REPLACE AND REPAIR BROKEN MASONRY BLOCK WALL WITH NEW CONCRETE BLOCK.
- INSTALL NEW FLOOR STRIP BETWEEN OLD-NEW AND TWO DIFFERENT FLOORING.
- G.C TO REMOVE AND STORE ANY EQUIPMENT AND MOVE ABLE FURNITURE/MILLWORK WHILE INSTALLATION OF NEW FLOOR. REINSTALL AFTER WORK IS DONE.

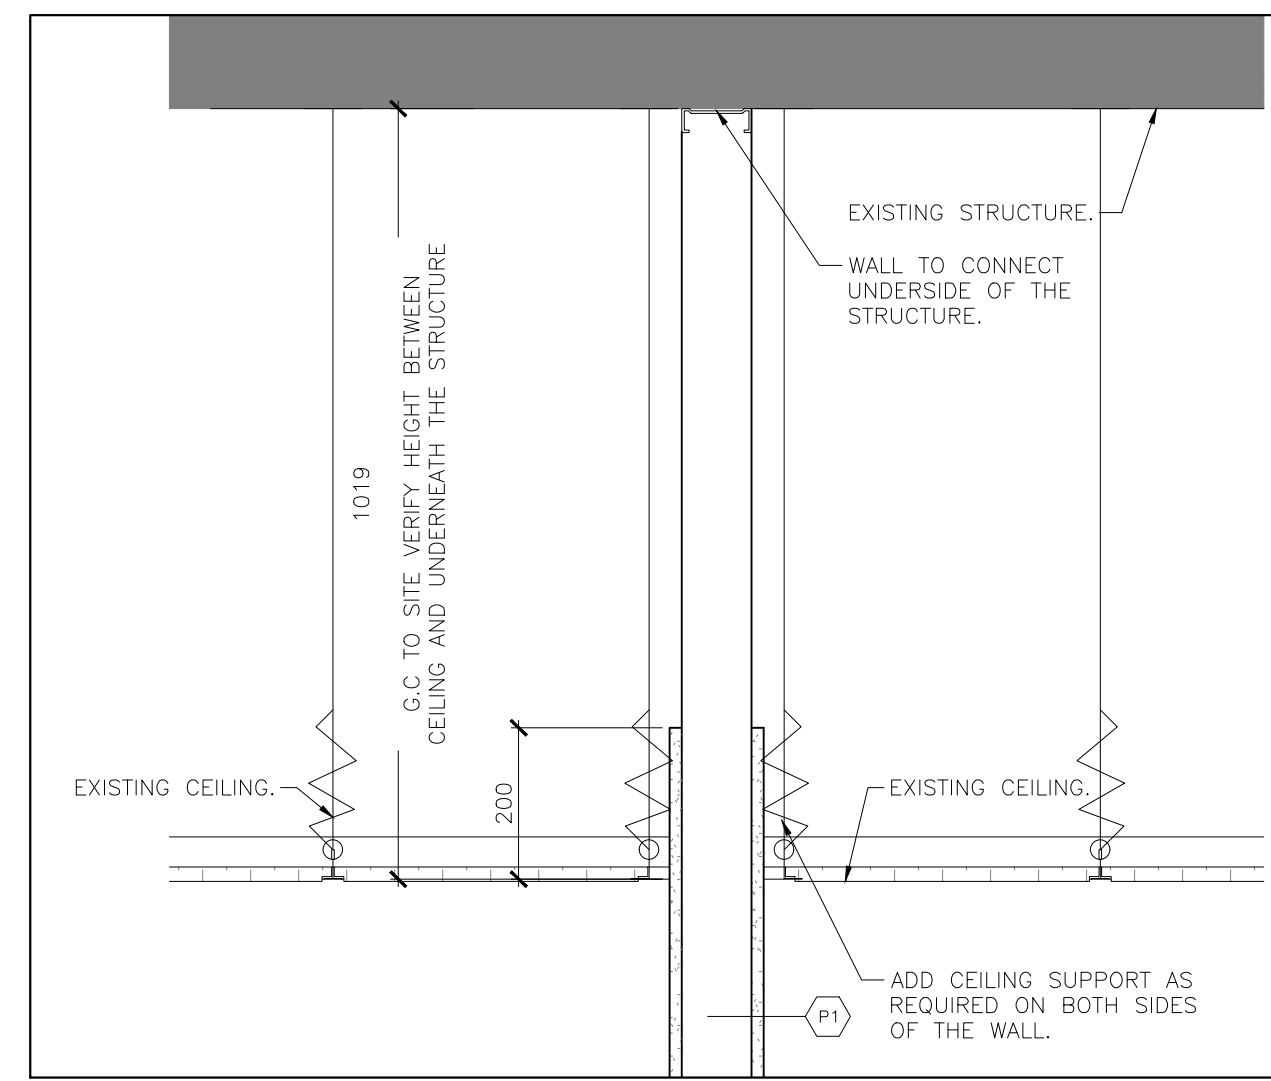


02 WALL AND CEILING DETAIL
1:10

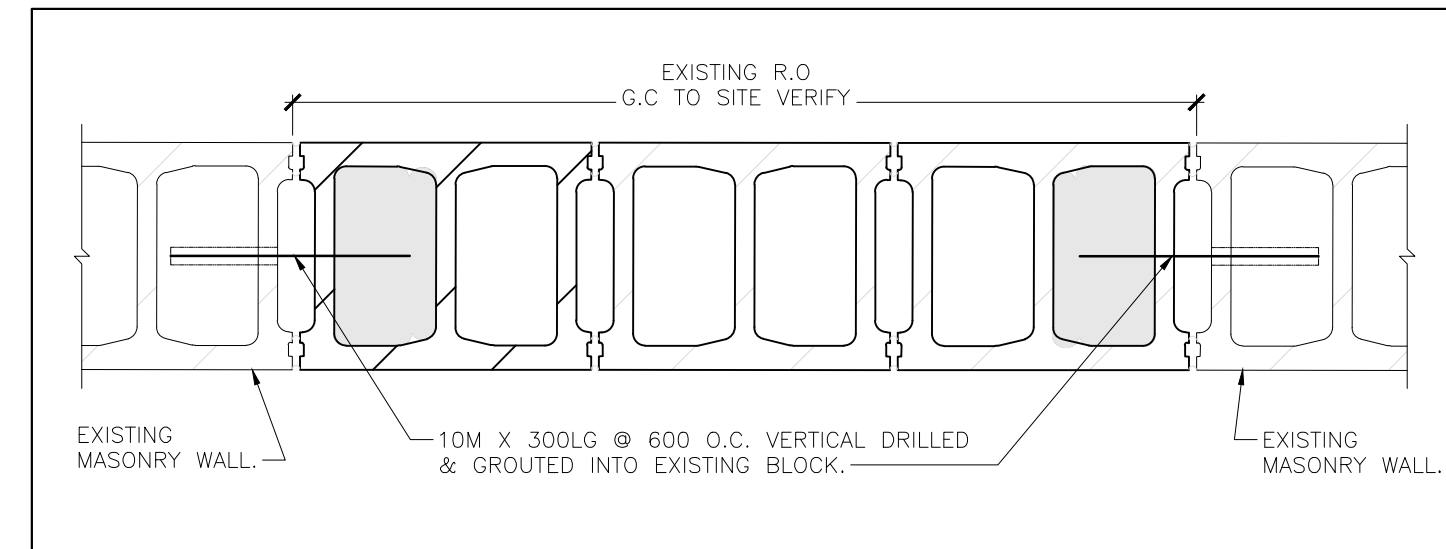


03 TYPICAL MASONRY WALL INFILL DETAIL
1:5

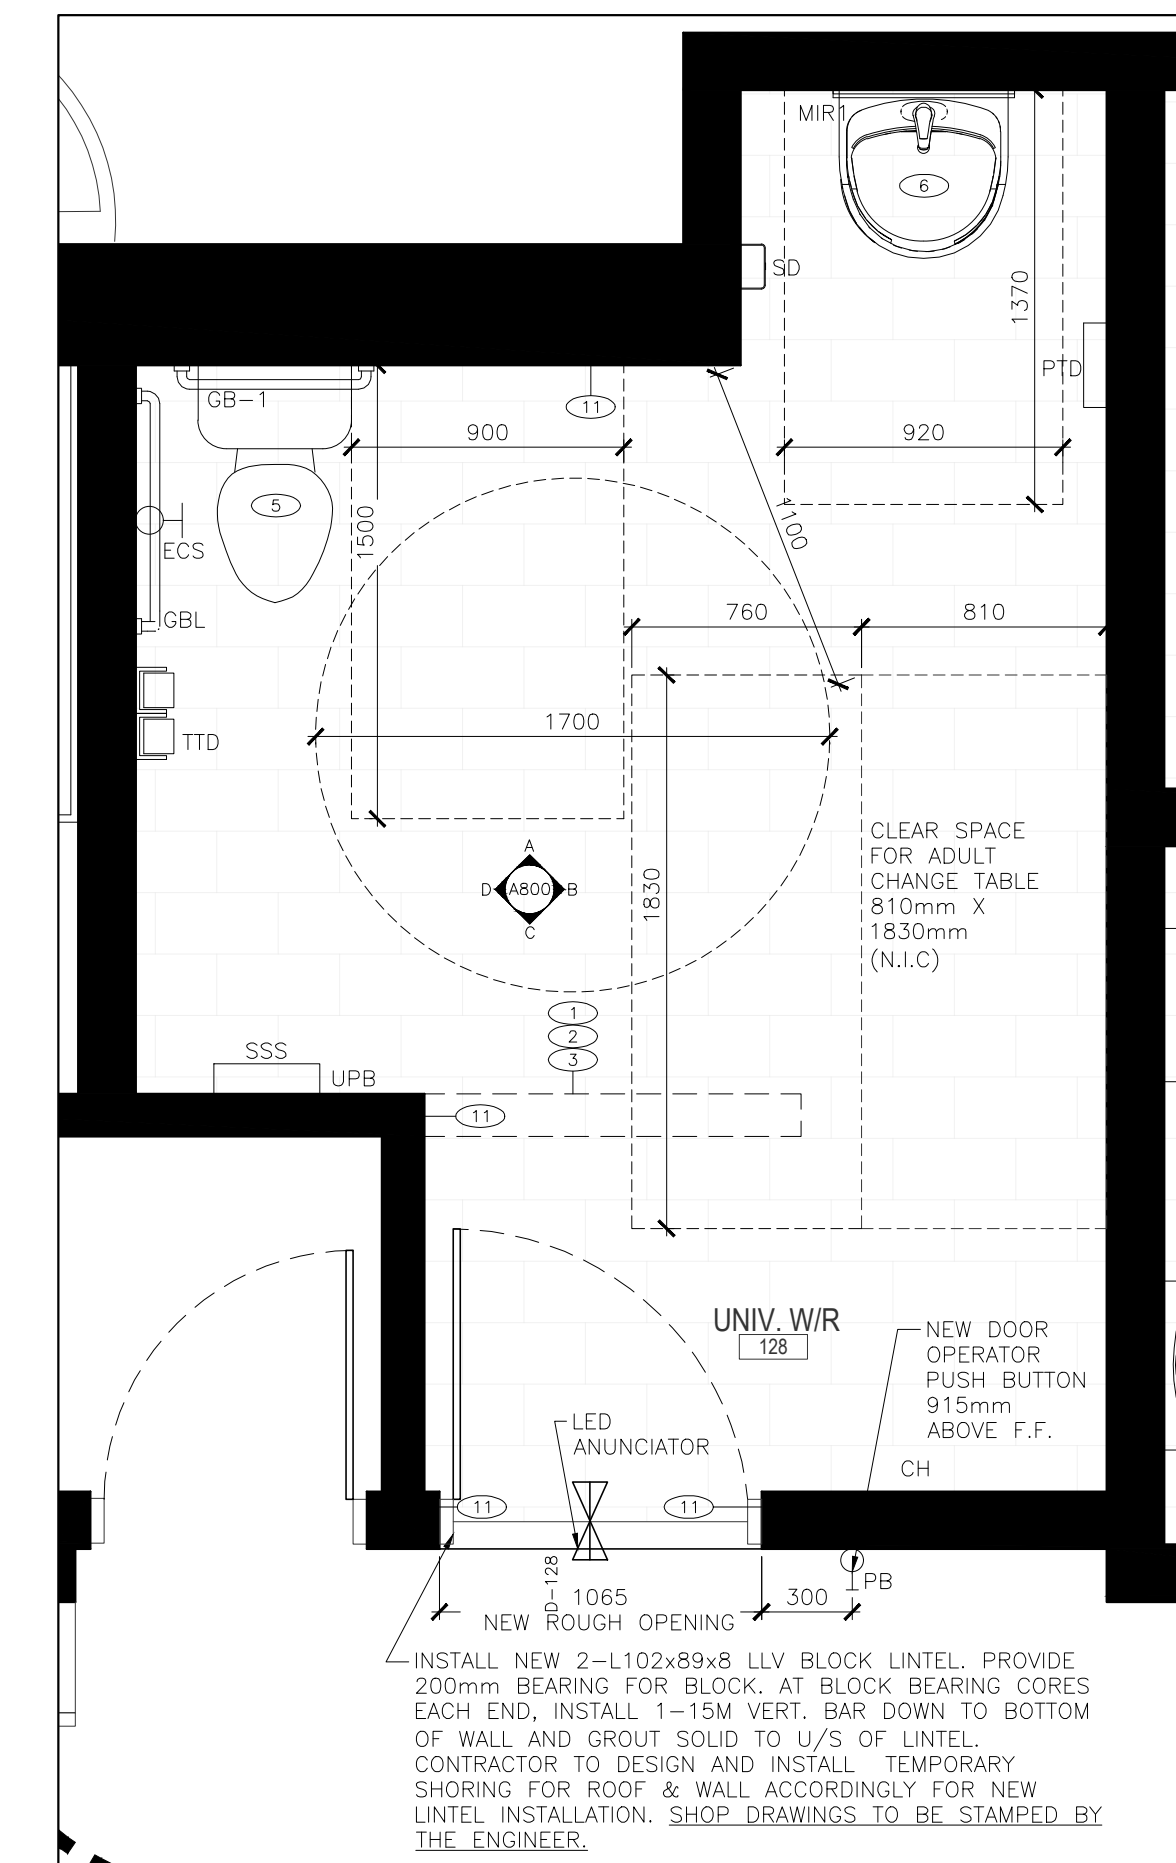


01 UNIVERSAL WASHROOM 128
1:25

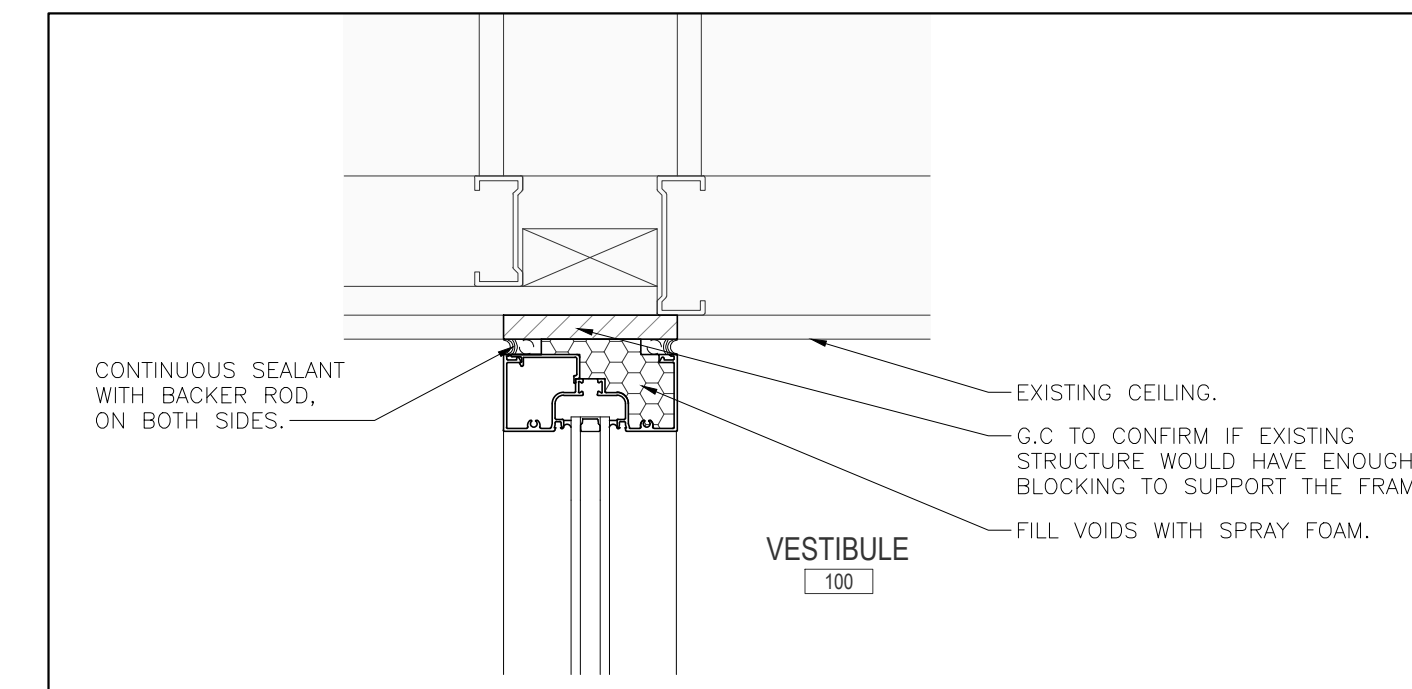

05 DETAIL 1
1:5

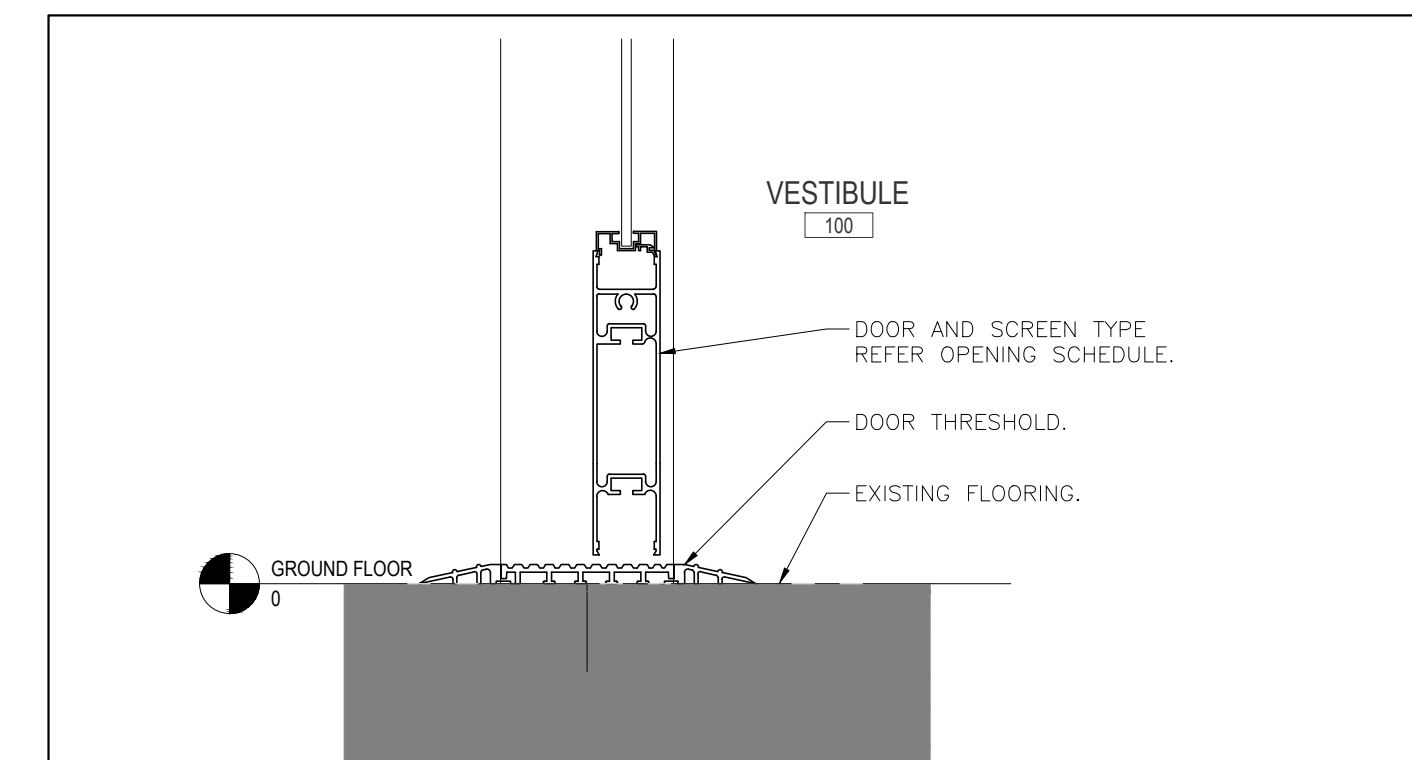


06 DETAIL 3
1:5

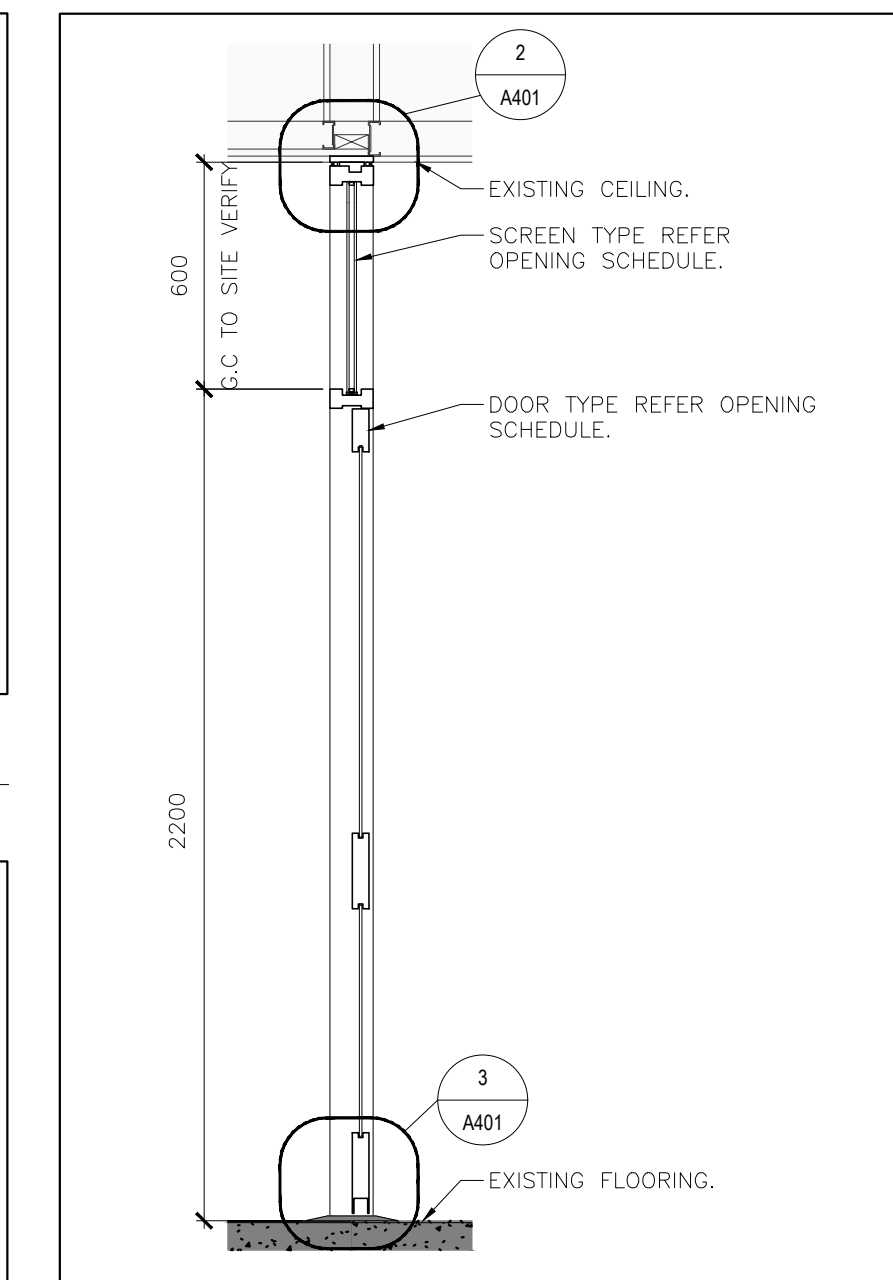

04 SCREEN SECTION
1:20

KEY PLAN

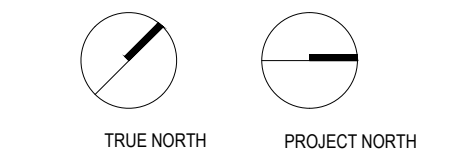

LEGEND

ISSUED

DATE	DESCRIPTION	No.
2024-02-15	ISSUE FOR TENERD	1

ALL DRAWINGS, SPECIFICATIONS AND RELATED DOCUMENTATION ARE COPYRIGHT PROPERTY OF 1721 ARCHITECTS INC. AND MUST BE RETURNED UPON REQUEST. REPRODUCTION OF DRAWINGS, SPECIFICATIONS AND RELATED DOCUMENTATION IN PART OR IN WHOLE IS WRITTEN FORBIDDEN WITHOUT THE WRITTEN PERMISSION OF 1721 ARCHITECTS INC.
DO NOT SCALE DRAWINGS
CONTRACTOR MUST CHECK AND VERIFY ALL DIMENSION OF THE JOB.
THIS DRAWING IS NOT TO BE USED FOR CONSTRUCTION UNTIL SIGNED BY THE ARCHITECT

Monsignor Doyle CSS

185 Myers Rd, Cambridge, ON N1R 7H2

DRAWING TITLE:
**ENLARGED DETAILS,
DETAILS AND SECTION**

CHECKED: SD
DRAWN: RN
PROJECT No. 2330

SCALE: AS NOTED

A200

GENERAL NOTES:

- A. REMOVE ALL WIRING FROM ELECTRICAL ITEMS THAT WILL BE REMOVED AND ALL REDUNDANT CONDUIT BACK TO NEAREST JUNCTION BOX THAT WILL REMAIN AND MAKE SAFE. INSTALL METAL COVER PLATES OVER EXPOSED OPENINGS AND ELECTRICAL BOXES. REFER TO ELECTRICAL FOR ADDITIONAL REQUIREMENTS.
- B. MAKE GOOD ALL AREAS AFFECTED BY REMOVALS - FLUSH TO ADJACENT SURFACE AND MATCH EXISTING FINISH.
- C. DISPOSE OF ALL DESIGNATED SUBSTANCES TO THE REQUIREMENTS OF AUTHORITIES HAVING JURISDICTION.
- D. ALL PIPING THAT IS TO BE REMOVED OR ABANDONED IS TO BE REMOVED BACK TO THE NEAREST JUNCTION AND CAPPED. REFER TO MECHANICAL FOR ADDITIONAL REQUIREMENTS.
- E. NOTE ALL EXISTING ITEMS MAY NOT BE SHOWN ON THESE DRAWINGS. A CAREFUL REVIEW OF THE SITE IS REQUIRED TO DETERMINE THE FULL EXTENT OF THE WORK SHOWN.
- F. THE ARCHITECTURAL DRAWINGS ARE TO BE READ IN CONJUNCTION WITH ALL PROJECT MANUALS, STRUCTURAL, CIVIL, MECHANICAL AND ELECTRICAL DRAWINGS. IN CASE OF DIFFERENCES BETWEEN CONSULTANTS' DOCUMENTS WITH RESPECT TO QUANTITY, SIZES OR SCOPE, THE GREATER SHALL APPLY.
- G. PROVIDE PROTECTION FOR ALL FINISHES OR SERVICES TO REMAIN.
- H. ALL WINDOWS FALLING WITHIN THE DEMOLITION AREA ARE TO HAVE COVERINGS, THEIR FITTINGS, MOUNTING HARDWARE REMOVED & RETURNED TO THE OWNER, OR DISPOSE AS DIRECTED BY THE OWNER.
- I. DEMOLITION NOTE REFERENCE NUMBERS, WHERE LOCATED ADJACENT TO A ROOM NAME/NUMBER APPLY TO THE ENTIRETY OF THE ROOM.
- J. GENERAL CONTRACTOR IS TO ALLOW FOR THE SUPPLY AND INSTALLATION OF LOOSE LINTELS AS REQUIRED WHERE NEW OPENINGS ARE BEING CREATED OR WIDENED. REFER TO THE LOOSE LINTEL SCHEDULE PROVIDED ON THE DRAWINGS, OR PROVIDE ENGINEERING WHERE THERE ARE NO STRUCTURAL DRAWINGS / SCHEDULE.
- K. G.C. IS REQUIRED TO REMOVE ALL REMAINING ADHESIVES ON WALLS WHERE COMMUNICATION BOARDS WERE REMOVED UNLESS BEING COVERED WITH NEW BOARDS. TYPICAL FOR ALL ROOMS AFFECTED BY WORK.
- L. EXISTING LED BALLASTS AND BULBS TO BE TURNED OVER TO OWNER (COORDINATE WITH M&E)
- M. ALL WORK TO BE COORDINATED WITH THE ASBESTOS CONSULTANT'S DESIGNATED SUBSTANCES REPORT AND SCOPE OF WORK HOLDER ASSOCIATES LTD. IS THE BOARD'S ASBESTOS CONSULTANT.
- N. REFER TO OTHER NOTES ON SHEET A-100, A-101, A-102, A-103

CONSTRUCTION NOTES:




1. ALL WALLS TO BE PAINTED. (PATCH AND MAKE GOOD ALL FINISHES).
 2. INSTALL NEW FLOORING & BASE BOARD.
 3. INSTALL NEW ACOUSTIC CEILING TILE AND SUPPORTS. WHERE CONCRETE MASONRY BLOCK REMOVED.
 4. INSTALL NEW COUNTERTOP ON EXISTING MILLWORK.
 5. INSTALL NEW TOILET. (REFER MECHANICAL DRAWINGS).
 6. INSTALL NEW WALL HUNG SINKS. (REFER MECHANICAL DRAWINGS). G.C TO PROVIDE WOOD BLOCKING WHERE REQUIRED FOR SUPPORT OF WALL HUNG SINK.
 7. INSTALL NEW KITCHEN SINK. (REFER MECHANICAL DRAWINGS).
 8. INFILL EXISTING WALL OPENING. WALL TYPE TO MATCH EXISTING WALL. REFER DETAIL 3 IN DRAWING A-200.
 9. INSTALL NEW DATA AND OUTLETS (REFER ELECTRICAL DRAWINGS).
 10. INSTALL NEW SCREEN. REFER DRAWING A1000.
 11. REPLACE AND REPAIR BROKEN MASONRY BLOCK WALL WITH NEW CONCRETE BLOCK.
- INSTALL NEW FLOOR STRIP BETWEEN OLD-NEW AND TWO DIFFERENT FLOORING.

DEMO NOTES:


PLEASE REFER ELECTRICAL DEMOLITION DRAWING FOR POWER AND DATA.

LEGEND


- ⊗ GROMMET

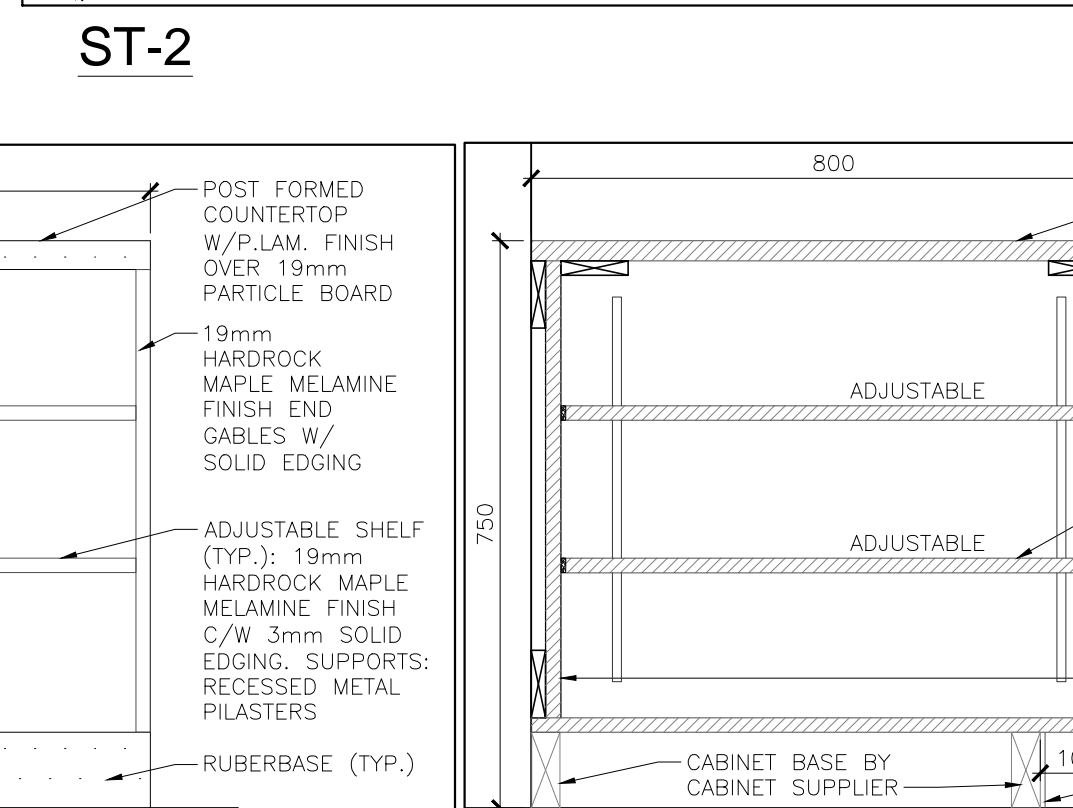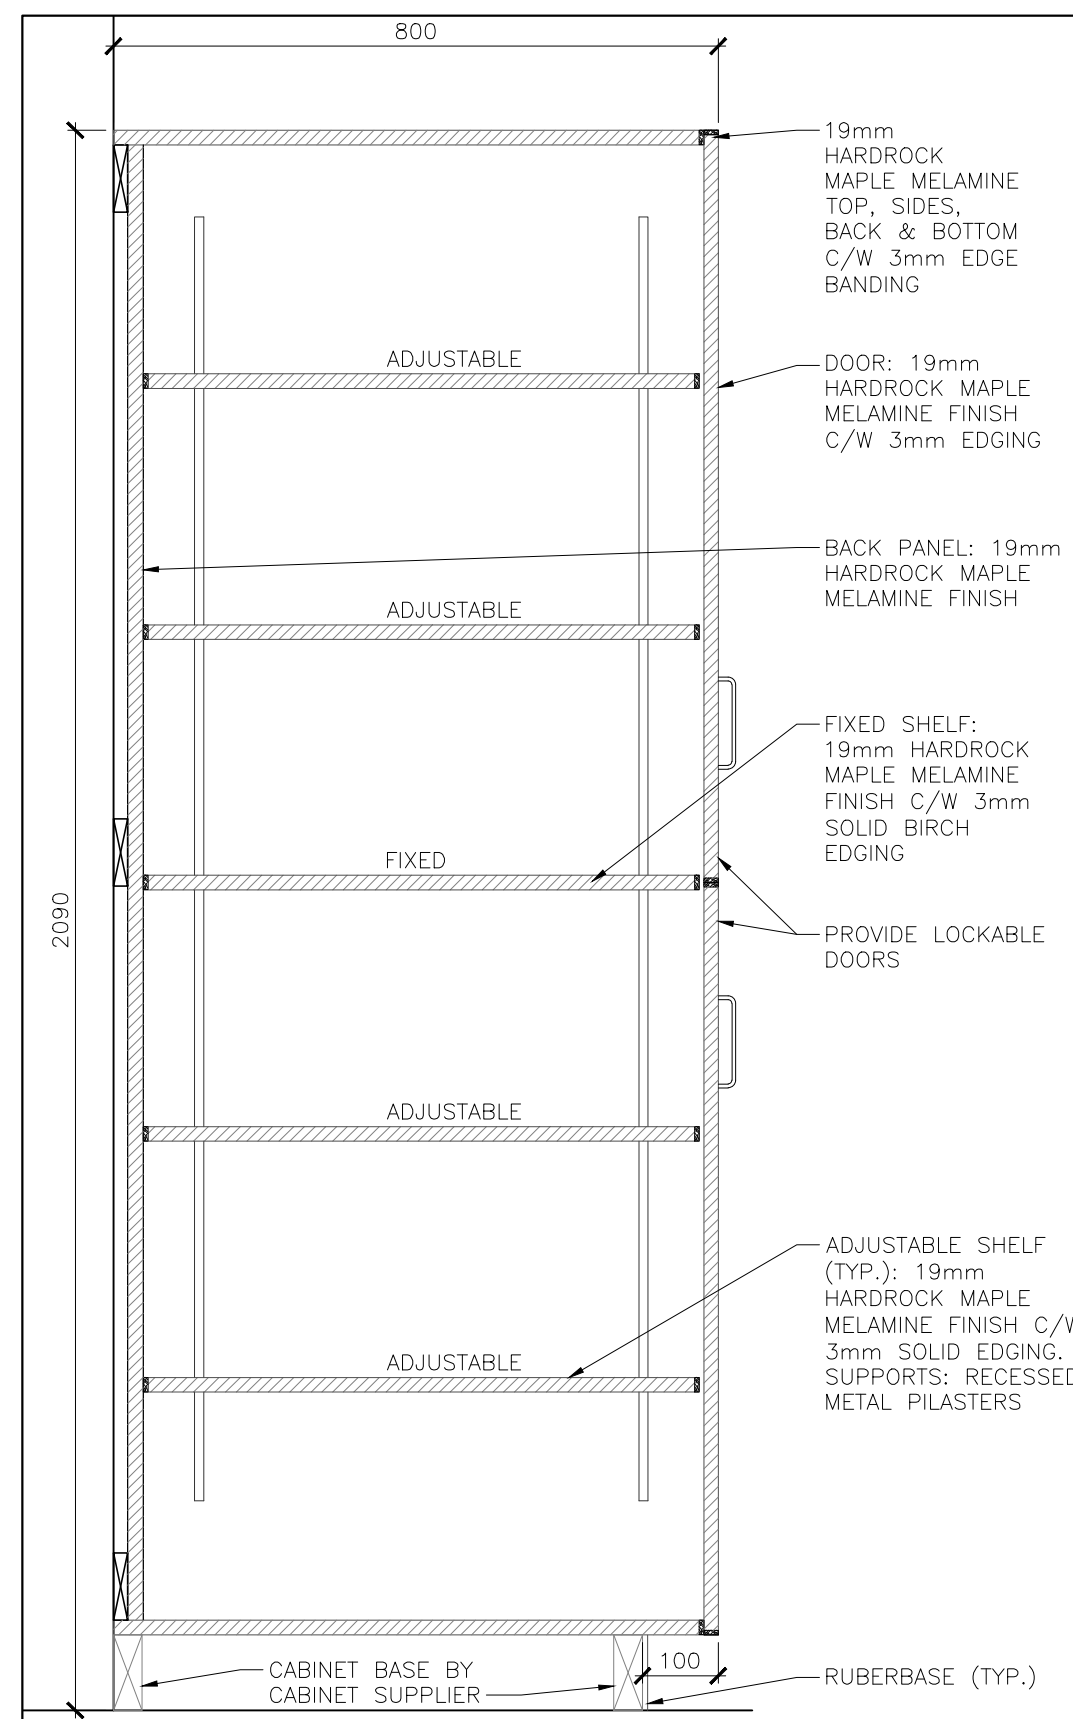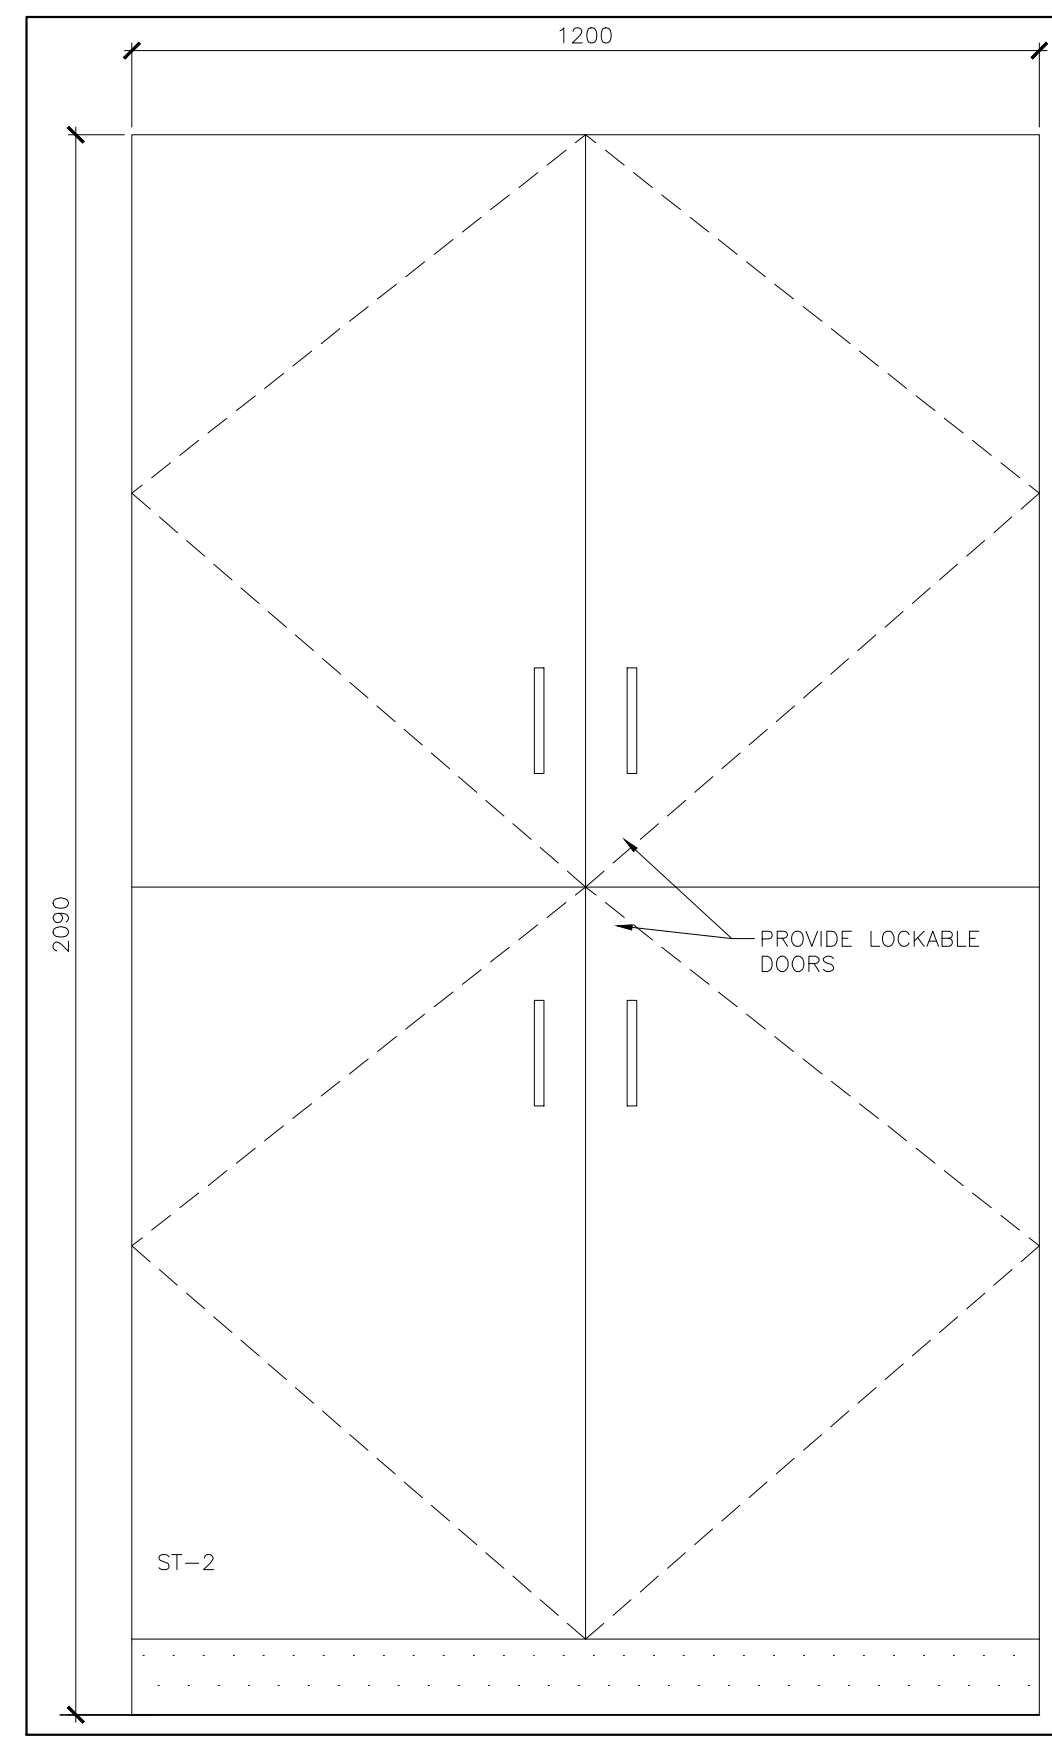


ST-1
MILLWORK DETAILS 1:10

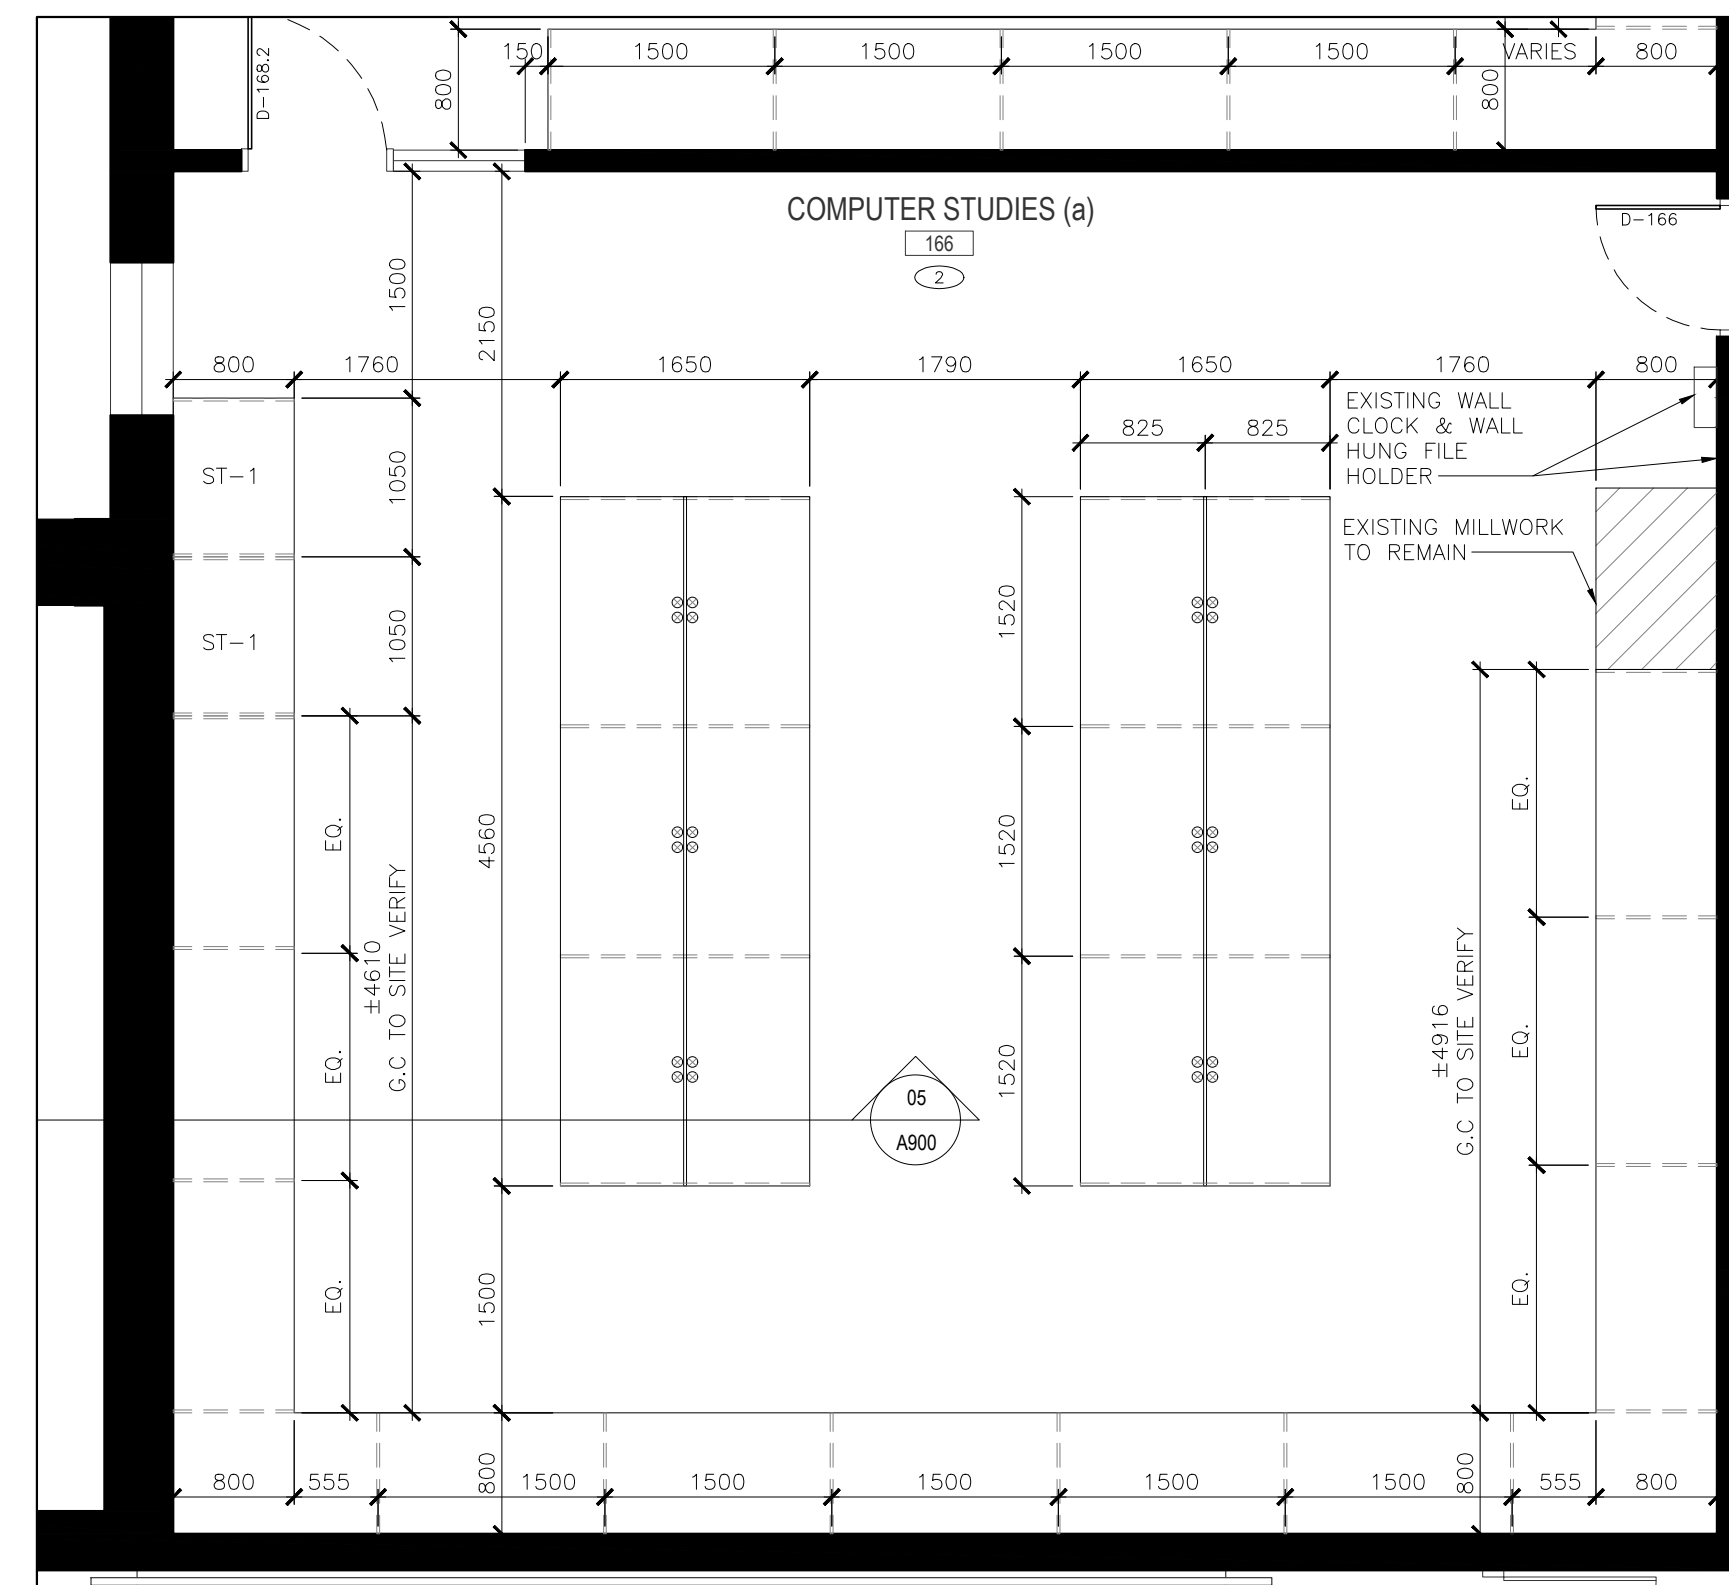


02 COMPUTER LAB 166 MILLWORK LAYOUT
1:50

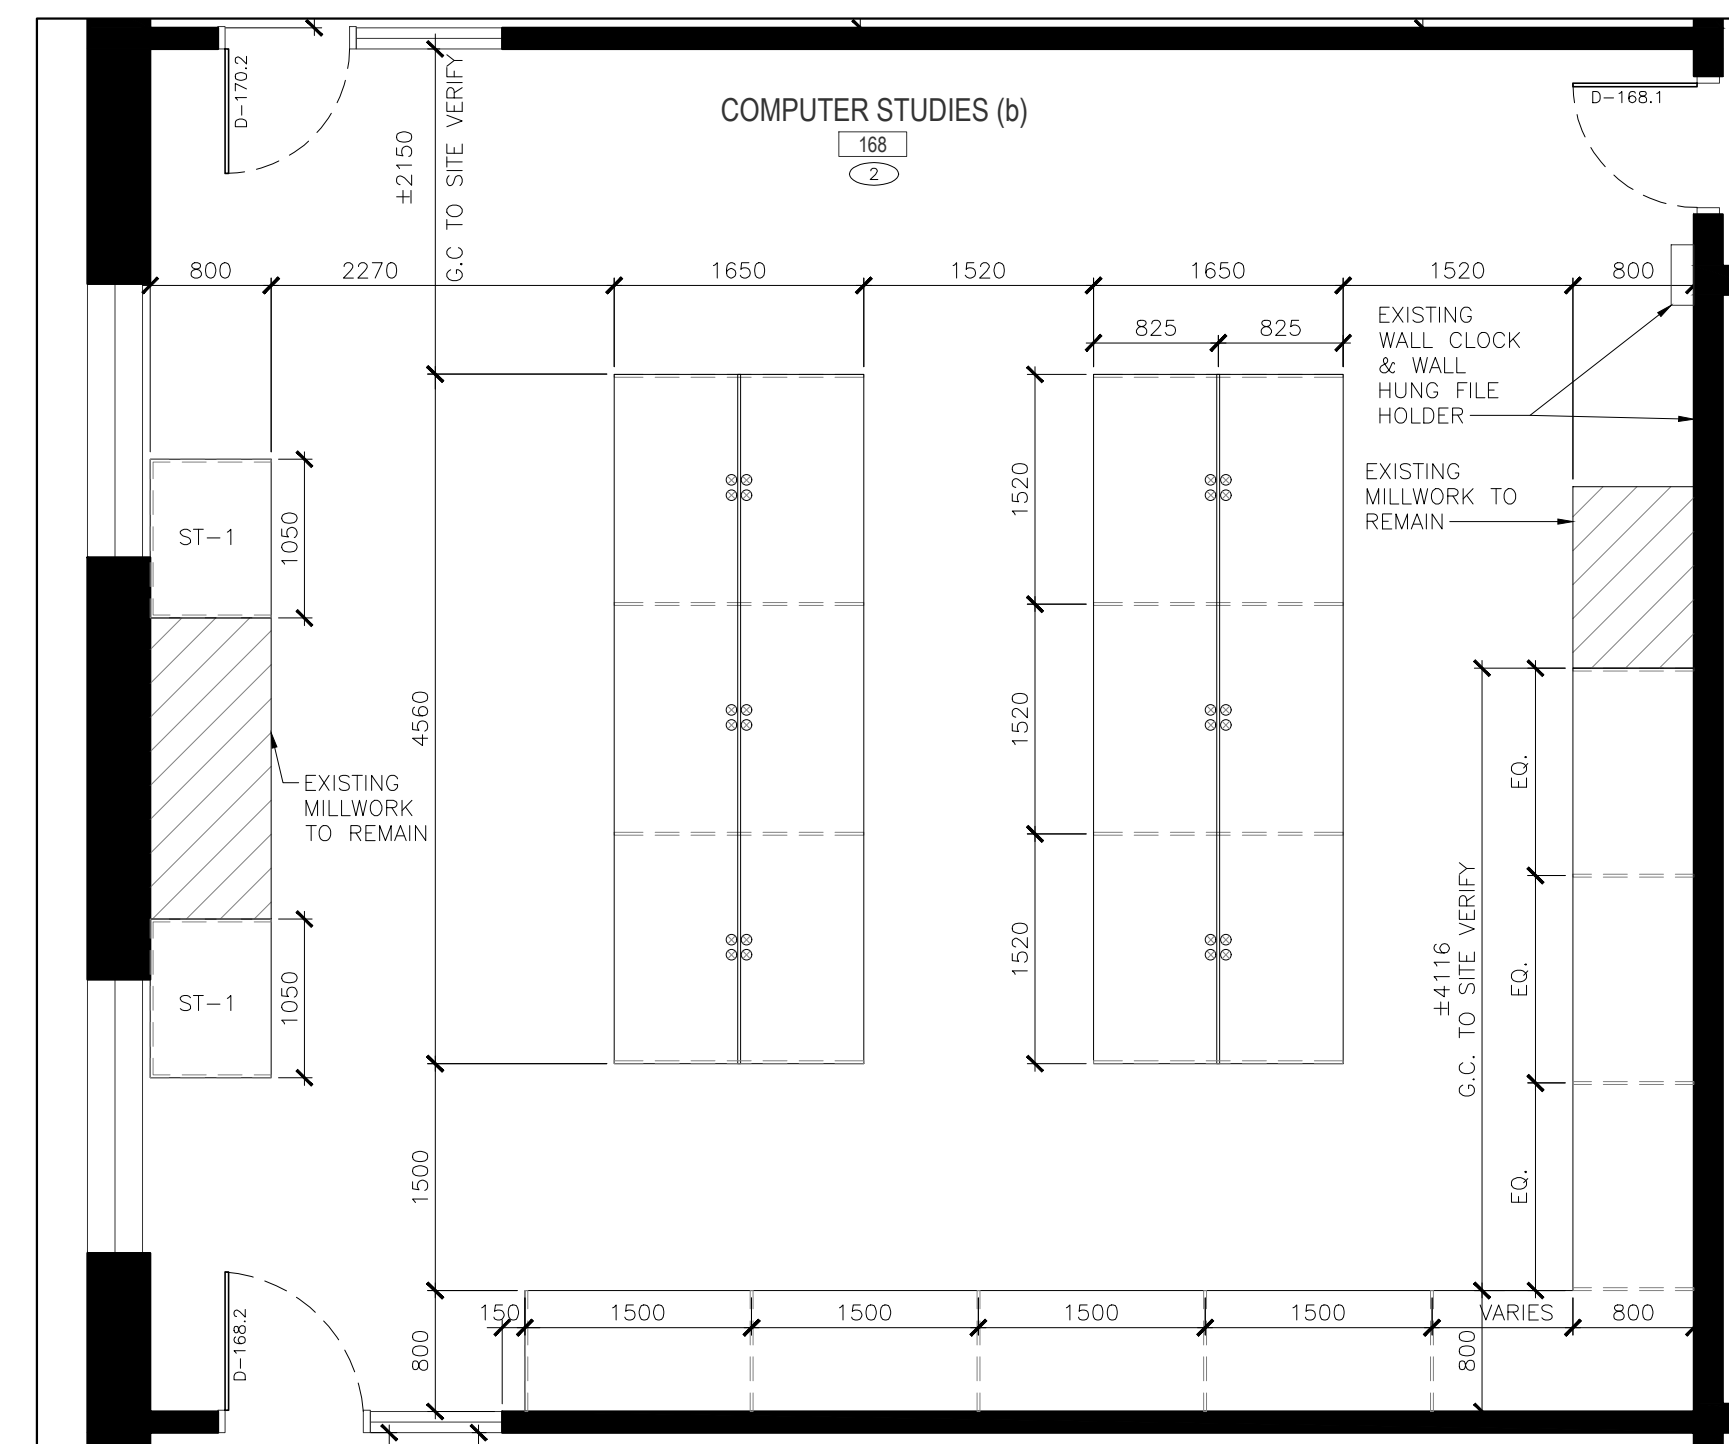


04 COMPUTER LAB 168 MILLWORK LAYOUT
1:50

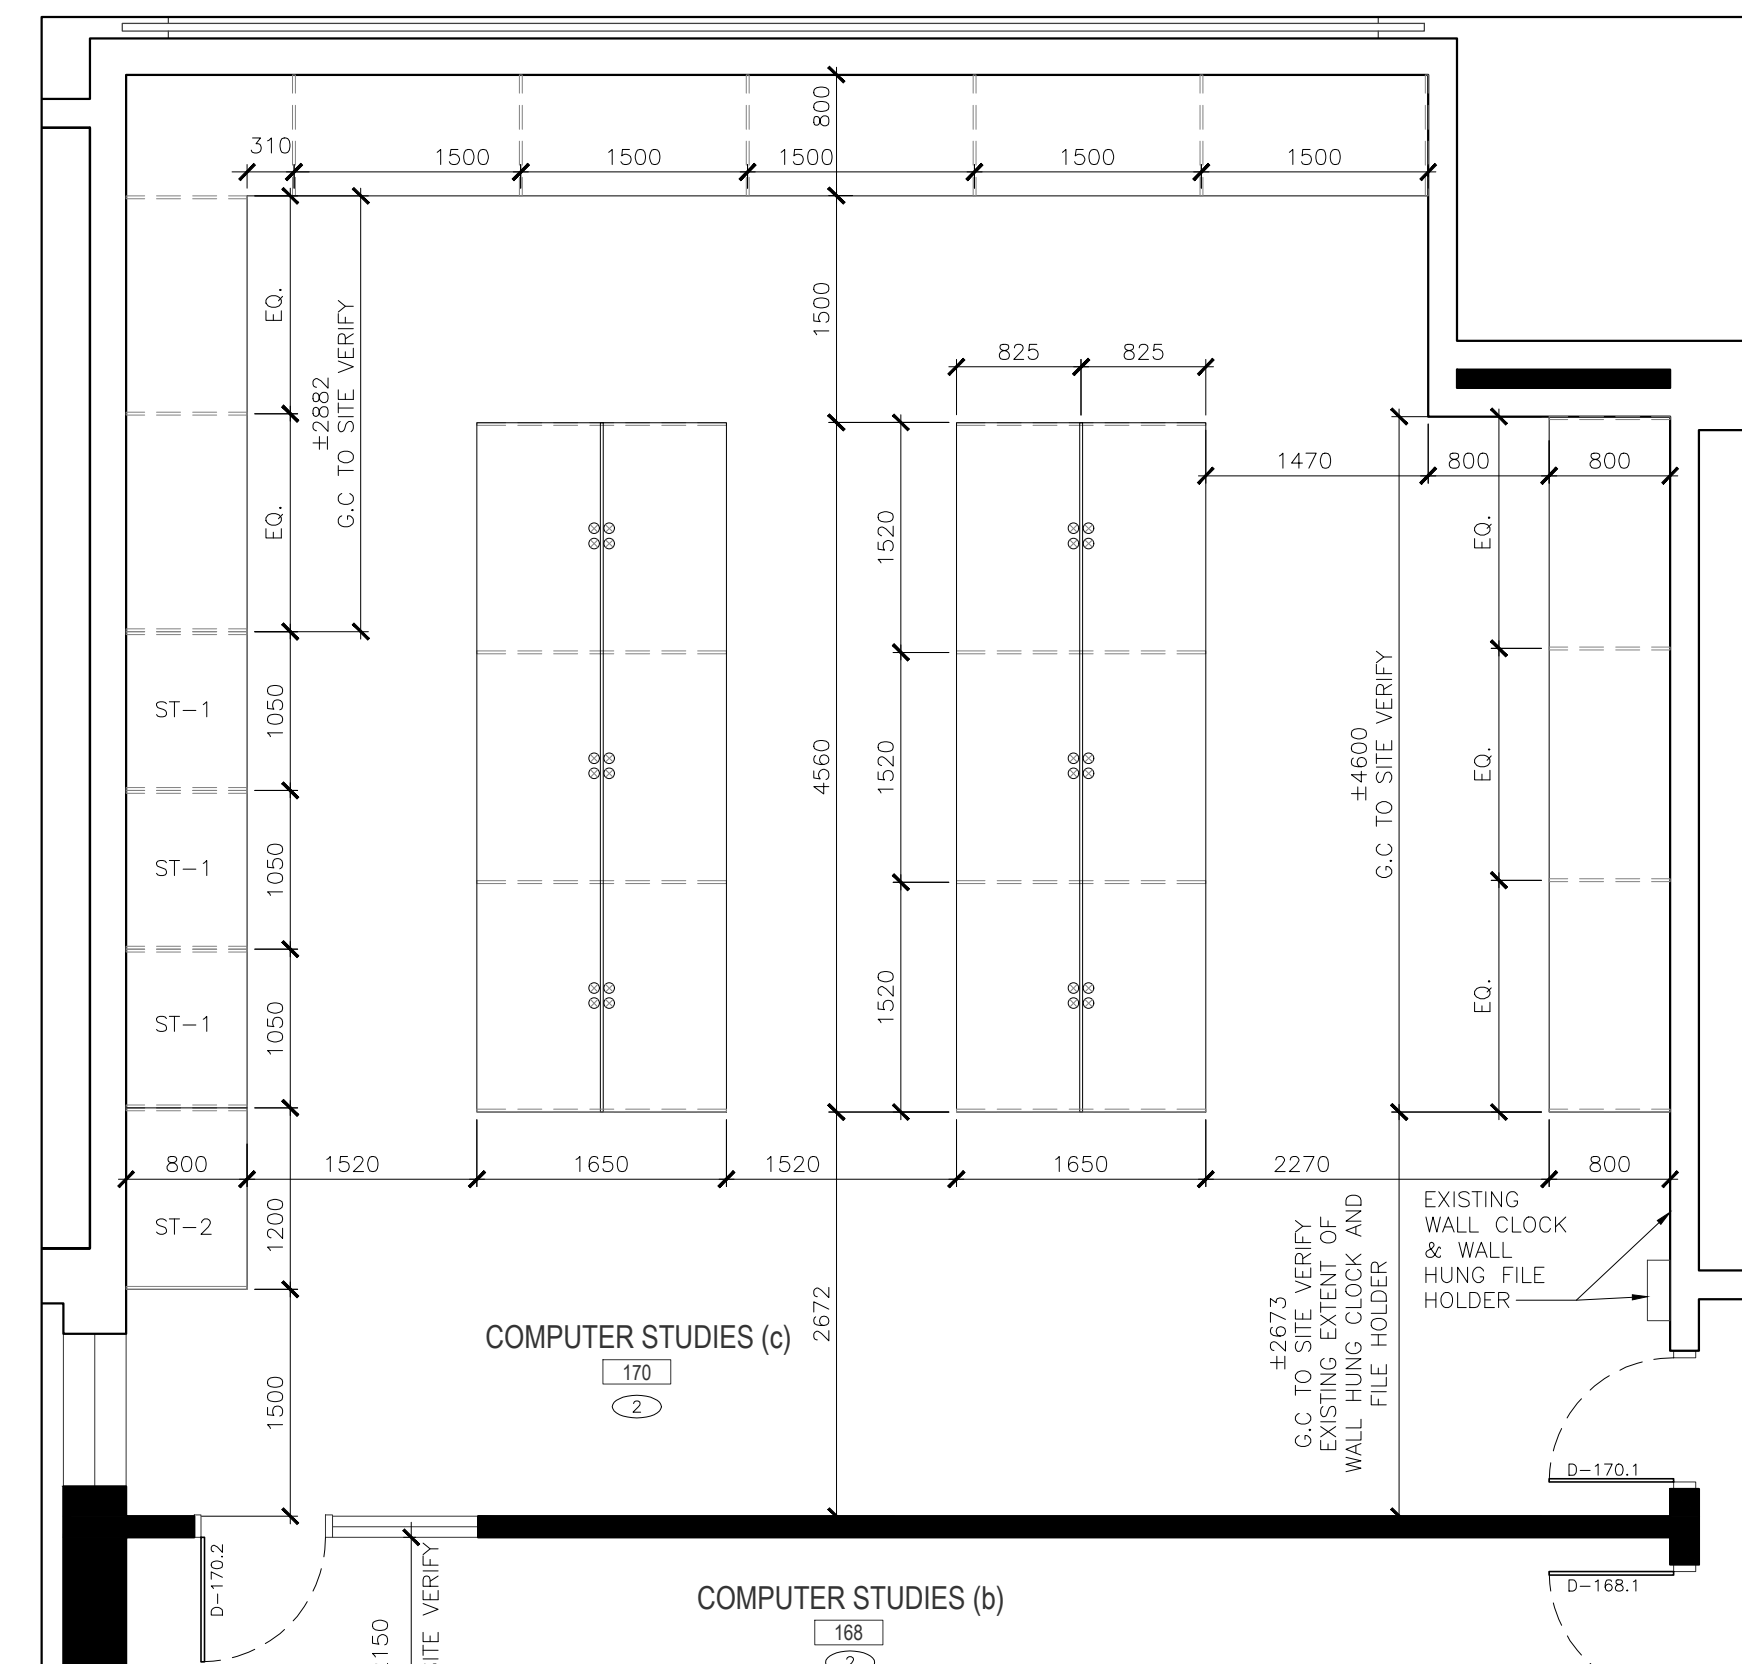


01 COMPUTER LAB 170 MILLWORK LAYOUT
1:50

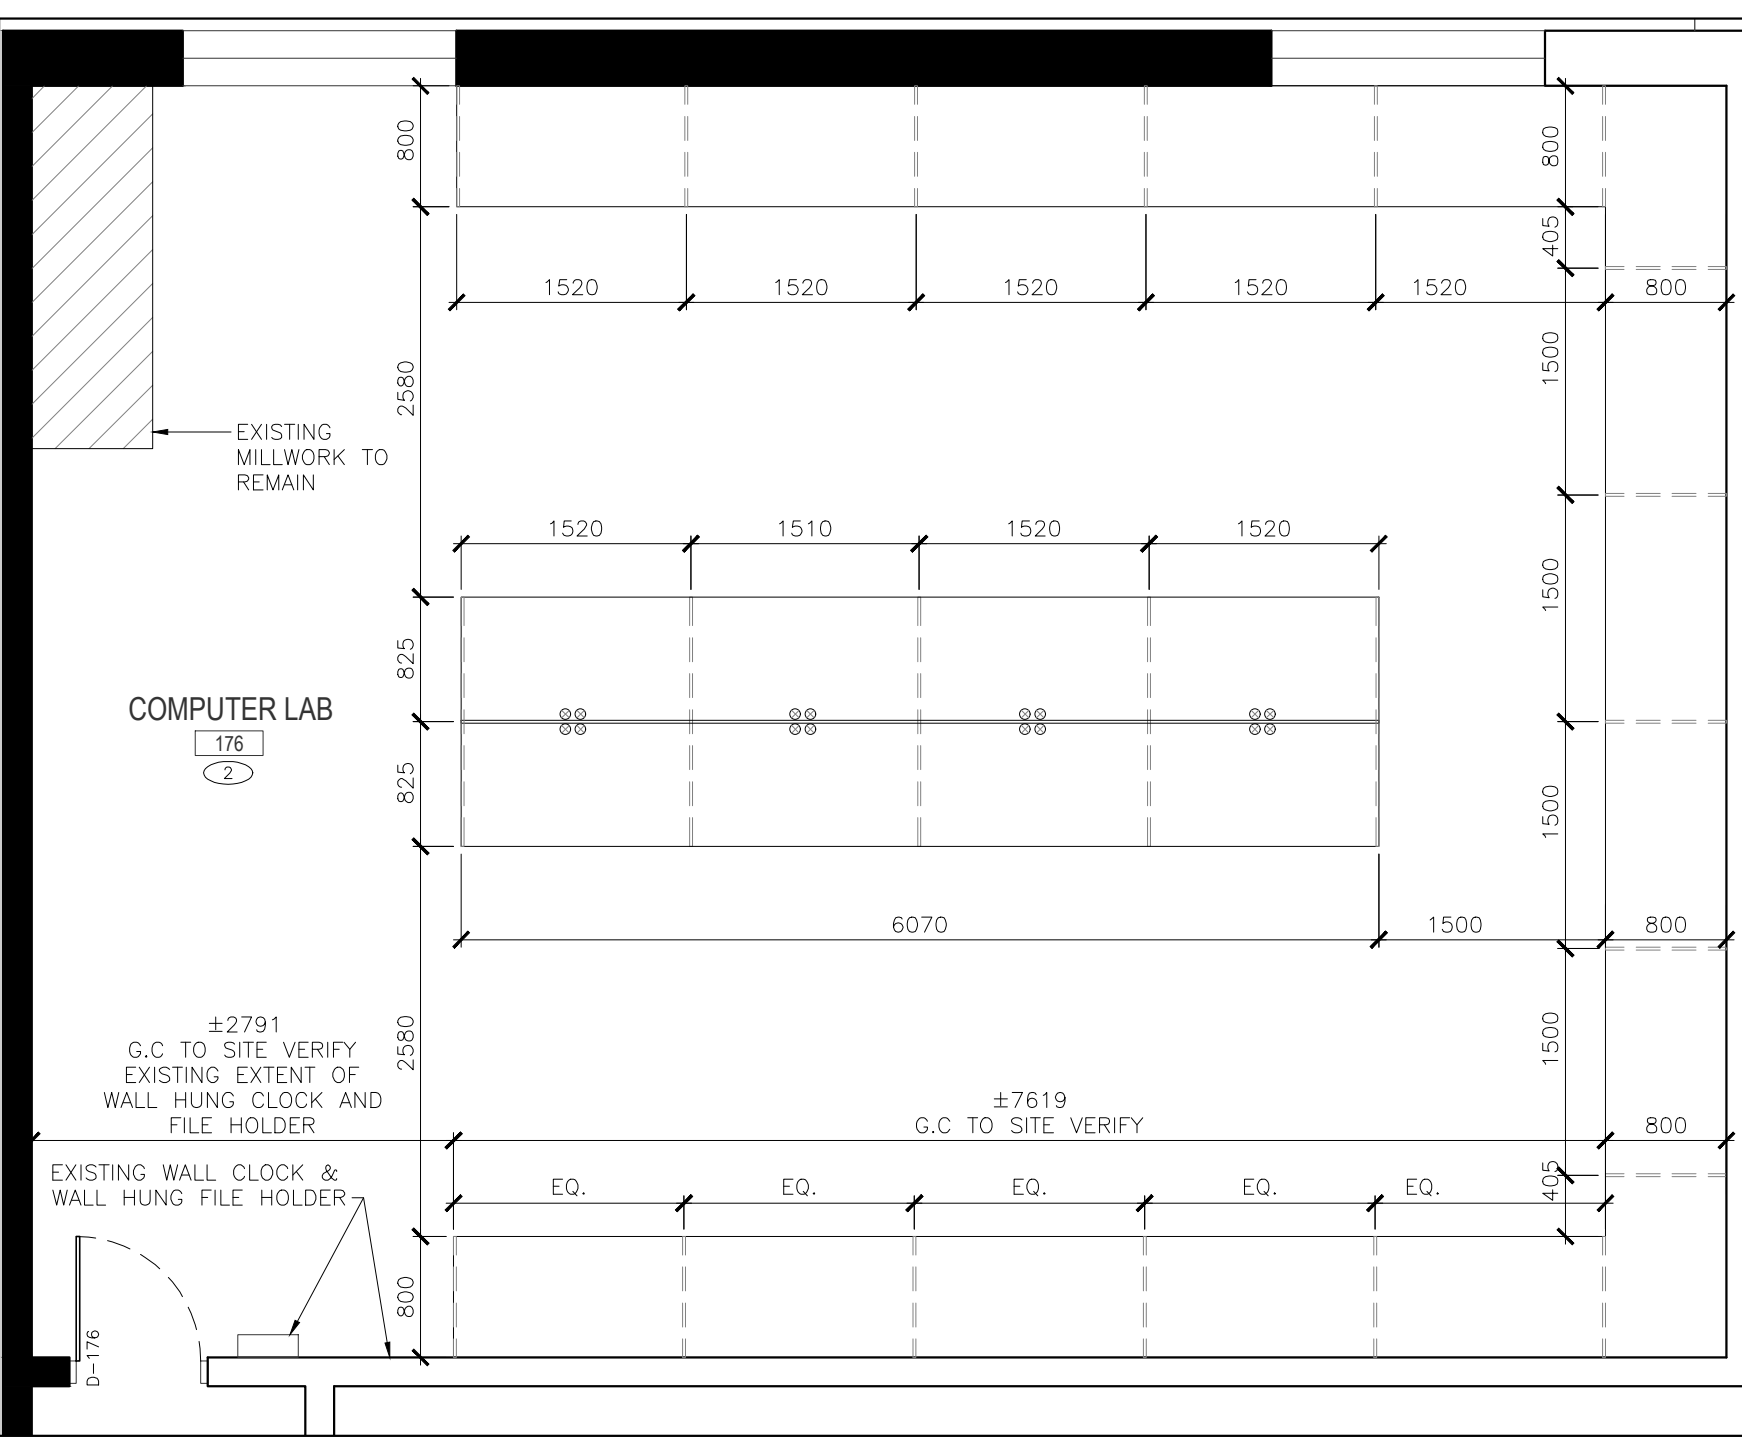

03 COMPUTER LAB 176 MILLWORK LAYOUT
1:50

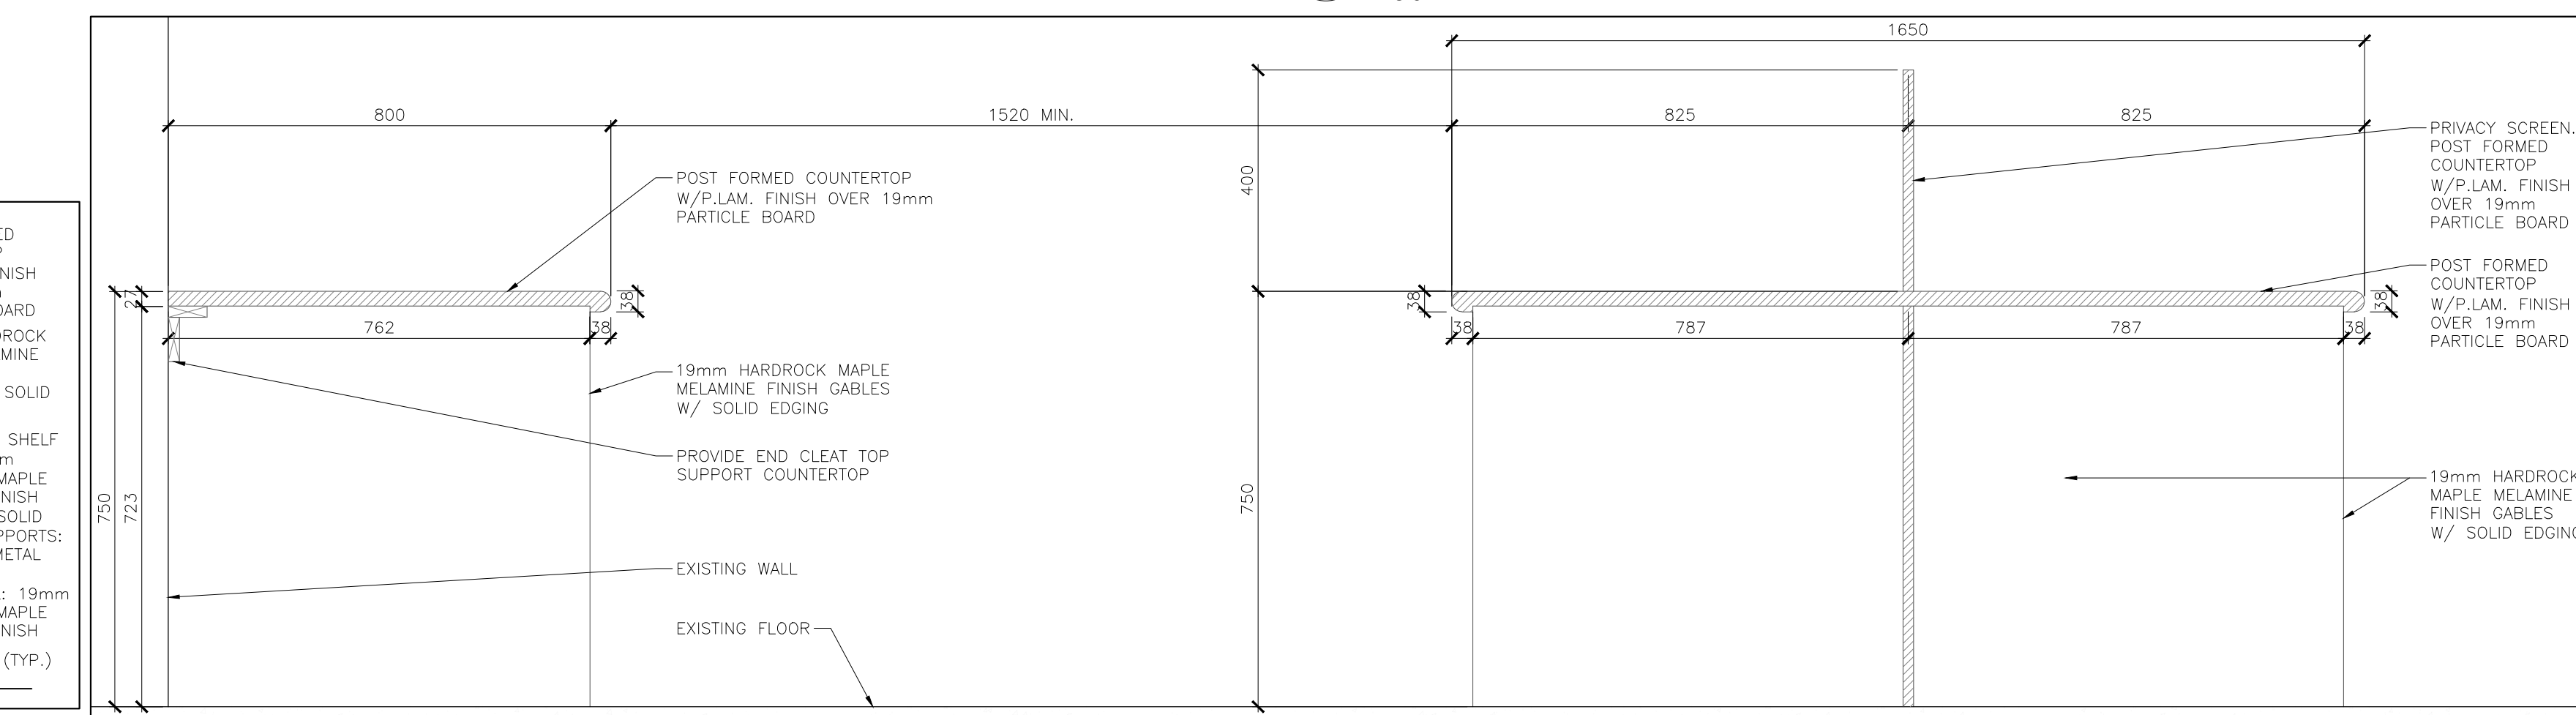

05 TYPICAL SECTION DETAIL
1:10

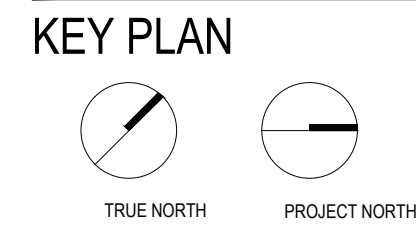

LEGEND

ISSUED

DATE	DESCRIPTION	No.
2024-02-15	ISSUE FOR TENDER	1

ALL DRAWINGS, SPECIFICATIONS AND RELATED DOCUMENTATION ARE COPYRIGHT PROPERTY OF 1721 ARCHITECTS INC. AND MUST BE RETURNED UPON REQUEST. REPRODUCTION OF DRAWINGS, SPECIFICATIONS AND RELATED DOCUMENTATION IN PART OR IN WHOLE IS WRITTEN FORBIDDEN WITHOUT THE WRITTEN PERMISSION OF 1721 ARCHITECTS INC.
DO NOT SCALE DRAWINGS
CONTRACTOR MUST CHECK AND VERIFY ALL DIMENSION OF THE JOB.
THIS DRAWING IS NOT TO BE USED FOR CONSTRUCTION UNTIL SIGNED BY THE ARCHITECT

Monsignor Doyle CSS

185 Myers Rd, Cambridge, ON N1R 7H2

DRAWING TITLE:
**PLAN DETAILS, ELEVATIONS,
MILLWORK DETAILS**

CHECKED: SD
DRAWN: RN
PROJECT No. 2330

SCALE: AS NOTED

A900

OPENING SCHEDULES

ROOM NAME	NUMBER	DOOR NUMBER	WIDTH	HEIGHT	TYPE	MATERIAL	FINISH	GLASS	FRAME	HARDWARE	JAMB DETAIL	FIRE RATING	COMMENTS
VESTIBULE	100	100.1	900	2150	B	WD	ANOD.	GL1	F1	AL	01		REFER TO ELEVATION IN DRAWING A1000
VESTIBULE	100	100.2	900	2150	B	WD	ANOD.	GL1	F1	AL	01		REFER TO ELEVATION IN DRAWING A1000
MAIN OFFICE	101	101	900	2150	B	WD	ANOD.	GL1	F1	AL	01		REFER TO ELEVATION IN DRAWING A1000
VICE PRINCIPAL	101A	101A	900	2150	B	WD	ANOD.	GL1	F1	AL	01		REFER TO ELEVATION IN DRAWING A1000
PRINCIPAL	101B	101B	900	2150	B	WD	ANOD.	GL1	F1	AL	01		REFER TO ELEVATION IN DRAWING A1000
OFFICE	101C	101C	900	2150	B	WD	ANOD.	GL1	F1	AL	01		REFER TO ELEVATION IN DRAWING A1000
MEETING ROOM	101D	101D	900	2150	B	WD	ANOD.	GL1	F1	AL	01		REFER TO ELEVATION IN DRAWING A1000
SVA V.P. OFFICE	101E	101E	900	2150	B	WD	ANOD.	GL1	F1	AL	01		REFER TO ELEVATION IN DRAWING A1000
MECH. RM.	101F	101F	900	2150	B	WD	ANOD.	GL1	F1	AL	01		REFER TO ELEVATION IN DRAWING A1000
ATTENDANCE/ HEALTH UNIT	102	102.1	900	2150	B	WD	ANOD.	GL1	F1	AL	01		REFER TO ELEVATION IN DRAWING A1000
ATTENDANCE/ HEALTH UNIT	102	102.2	900	2150	B	WD	ANOD.	GL1	F1	AL	01		REFER TO ELEVATION IN DRAWING A1000
ATTENDANCE/ HEALTH UNIT	102	102.3	900	2150	B	WD	ANOD.	GL1	F1	AL	01		REFER TO ELEVATION IN DRAWING A1000
OFFICE	102B	102B.1	900	2150	B	WD	ANOD.	GL1	F1	AL	01		REFER TO ELEVATION IN DRAWING A1000
OFFICE	102B	102B.2	900	2150	B	WD	ANOD.	GL1	F1	AL	01		REFER TO ELEVATION IN DRAWING A1000
NURSE	102C	102C	900	2150	B	WD	ANOD.	GL1	F1	AL	01		REFER TO ELEVATION IN DRAWING A1000
H. W/R	102D	102D	900	2150	B	WD	ANOD.	GL1	F1	AL	01		REFER TO ELEVATION IN DRAWING A1000
SCHOOL INFORMATION CENTRE	103	103	900	2150	B	WD	ANOD.	GL1	F1	AL	01		REFER TO ELEVATION IN DRAWING A1000
OFFICE	103A	103A	900	2150	B	WD	ANOD.	GL1	F1	AL	01		REFER TO ELEVATION IN DRAWING A1000
A.V. EQUIPMENT	103B	103B	900	2150	B	WD	ANOD.	GL1	F1	AL	01		REFER TO ELEVATION IN DRAWING A1000
STORAGE	103C	103C	900	2150	B	WD	ANOD.	GL1	F1	AL	01		REFER TO ELEVATION IN DRAWING A1000
STUDENT ACTIVITIES	104	104	900	2150	B	WD	ANOD.	GL1	F1	AL	01		REFER TO ELEVATION IN DRAWING A1000
OFFICE	104A	104A	900	2150	B	WD	ANOD.	GL1	F1	AL	01		REFER TO ELEVATION IN DRAWING A1000
STORAGE	104B	104B	900	2150	B	WD	ANOD.	GL1	F1	AL	01		REFER TO ELEVATION IN DRAWING A1000
H. W/R	105	105	900	2150	B	WD	ANOD.	GL1	F1	AL	01		REFER TO ELEVATION IN DRAWING A1000
SCIENCE PHYSICS (1)	106	106.1	900	2150	B	WD	ANOD.	GL1	F1	AL	01		REFER TO ELEVATION IN DRAWING A1000
SCIENCE PHYSICS (1)	106	106.2	900	2150	B	WD	ANOD.	GL1	F1	AL	01		REFER TO ELEVATION IN DRAWING A1000
CHEMICAL STORAGE	106A	106A	900	2150	B	WD	ANOD.	GL1	F1	AL	01		REFER TO ELEVATION IN DRAWING A1000
PREP. AREA	106B	106B	900	2150	B	WD	ANOD.	GL1	F1	AL	01		REFER TO ELEVATION IN DRAWING A1000
CUSTODIAN ROOM	107	107	900	2150	B	WD	ANOD.	GL1	F1	AL	01		REFER TO ELEVATION IN DRAWING A1000
SCIENCE PREP.	108	108.1	900	2150	B	WD	ANOD.	GL1	F1	AL	01		REFER TO ELEVATION IN DRAWING A1000
SCIENCE PREP.	108	108.2	900	2150	B	WD	ANOD.	GL1	F1	AL	01		REFER TO ELEVATION IN DRAWING A1000
SCIENCE PREP.	108	108.3	900	2150	B	WD	ANOD.	GL1	F1	AL	01		REFER TO ELEVATION IN DRAWING A1000
STAFF WORK ROOM	108A	108A.1	900	2150	B	WD	ANOD.	GL1	F1	AL	01		REFER TO ELEVATION IN DRAWING A1000
STAFF WORK ROOM	108A	108A.2	900	2150	B	WD	ANOD.	GL1	F1	AL	01		REFER TO ELEVATION IN DRAWING A1000
SCIENCE CHEMISTRY	109	109	900	2150	B	WD	ANOD.	GL1	F1	AL	01		REFER TO ELEVATION IN DRAWING A1000
SCIENCE GENERAL	110	110	900	2150	B	WD	ANOD.	GL1	F1	AL	01		REFER TO ELEVATION IN DRAWING A1000
SCIENCE PREP.	110A	110A.1	900	2150	B	WD	ANOD.	GL1	F1	AL	01		REFER TO ELEVATION IN DRAWING A1000
SCIENCE PREP.	110A	110A.2	900	2150	B	WD	ANOD.	GL1	F1	AL	01		REFER TO ELEVATION IN DRAWING A1000
SCIENCE PREP.	110A	110A.3	900	2150	B	WD	ANOD.	GL1	F1	AL	01		REFER TO ELEVATION IN DRAWING A1000
SCIENCE STORAGE	111	111	900	2150	B	WD	ANOD.	GL1	F1	AL	01		REFER TO ELEVATION IN DRAWING A1000
SCIENCE BIOLOGY	112	112.1	900	2150	B	WD	ANOD.	GL1	F1	AL	01		REFER TO ELEVATION IN DRAWING A1000
SCIENCE BIOLOGY	112	112.2	900	2150	B	WD	ANOD.	GL1	F1	AL	01		REFER TO ELEVATION IN DRAWING A1000
MENS W/R	113	113	900	2150	B	WD	ANOD.	GL1	F1	AL	01		REFER TO ELEVATION IN DRAWING A1000
CUST. RM.	114	114	900	2150	B	WD	ANOD.	GL1	F1	AL	01		REFER TO ELEVATION IN DRAWING A1000
WOMEN W/R	115	115	900	2150	B	WD	ANOD.	GL1	F1	AL	01		REFER TO ELEVATION IN DRAWING A1000
STAFF W/R	116	116	900	2150	B	WD	ANOD.	GL1	F1	AL	01		REFER TO ELEVATION IN DRAWING A1000
STAFF W/R	117	117	900	2150	B	WD	ANOD.	GL1	F1	AL	01		REFER TO ELEVATION IN DRAWING A1000
LEARNING RESOURCE I	118	118	900	2150	B	WD	ANOD.	GL1	F1	AL	01		REFER TO ELEVATION IN DRAWING A1000
W/R	118A	118A	900	2150	B	WD	ANOD.	GL1	F1	AL	01		REFER TO ELEVATION IN DRAWING A1000
SEMINAR I	119A	119A	900	2150	B	WD	ANOD.	GL1	F1	AL	01		REFER TO ELEVATION IN DRAWING A1000
SEMINAR II	119B	119B	900	2150	B	WD	ANOD.	GL1	F1	AL	01		REFER TO ELEVATION IN DRAWING A1000
LEARNING RESOURCE II	120	120.1	900	2150	B	WD	ANOD.	GL1	F1	AL	01		REFER TO ELEVATION IN DRAWING A1000
LEARNING RESOURCE II	120	120.2	900	2150	B	WD	ANOD.	GL1	F1	AL	01		REFER TO ELEVATION IN DRAWING A1000
LEARNING RESOURCE II	120	120.3	900	2150	B	WD	ANOD.	GL1	F1	AL	01		REFER TO ELEVATION IN DRAWING A1000
OFFICE	120A	120A	900	2150	B	WD	ANOD.	GL1	F1	AL	01		REFER TO ELEVATION IN DRAWING A1000
COMPUTER C/R	121	121	900	2150	B	WD	ANOD.	GL1	F1	AL	01		REFER TO ELEVATION IN DRAWING A1000
CLASSROOM	122	122	900	2150	B	WD	ANOD.	GL1	F1	AL	01		REFER TO ELEVATION IN DRAWING A1000
CLASSROOM	123	123	900	2150	B	WD	ANOD.	GL1	F1	AL	01		REFER TO ELEVATION IN DRAWING A1000
MEN W/R	124	124	900	2150	B	WD	ANOD.	GL1	F1	AL	01		REFER TO ELEVATION IN DRAWING A1000
WOMEN W/R	125	125	900	2150	B	WD	ANOD.	GL1	F1	AL	01		REFER TO ELEVATION IN DRAWING A1000
CUST.	126	126	900	2150	B	WD	ANOD.	GL1	F1	AL	01		REFER TO ELEVATION IN DRAWING A1000
H. W/R	127	127	900	2150	B	WD	ANOD.	GL1	F1	AL	01		REFER TO ELEVATION IN DRAWING A1000
UNIV. W/R	128	128	900	2150	B	WD	ANOD.	GL1	F1	AL	01		REFER TO ELEVATION IN DRAWING A1000
WOMEN STAFF W/R	129	129	900	2150	B	WD	ANOD.	GL1	F1	AL	01		REFER TO ELEVATION IN DRAWING A1000
CLASSROOM	130	130	900	2150	B	WD	ANOD.	GL1	F1	AL	01		REFER TO ELEVATION IN DRAWING A1000
CLASSROOM	131	131	900	2150	B	WD	ANOD.	GL1	F1	AL	01		REFER TO ELEVATION IN DRAWING A1000
CLASSROOM	132	132	900	2150	B	WD	ANOD.	GL1	F1	AL	01		REFER TO ELEVATION IN DRAWING A1000
WATER SERVICE	133	133	900	2150	B	WD	ANOD.	GL1	F1	AL	01		REFER TO ELEVATION IN DRAWING A1000
GYM A	134A	134A.1	1800	2150	D	WD	ANOD.	GL1	F1	AL	01		REFER TO ELEVATION IN DRAWING A1000
GYM A	134A	134A.2	1800	2150	D	WD	ANOD.	GL1	F1	AL	01		REFER TO ELEVATION IN DRAWING A1000
GYM B	134B	134B	1800	2150	D	WD	ANOD.	GL1	F1	AL	01		REFER TO ELEVATION IN DRAWING A1000
GYM C	134C	134C	1800	2150	D	WD	ANOD.	GL1	F1	AL	01		REFER TO ELEVATION IN DRAWING A1000
GYM A - STORAGE	134E	134E	900	2150	B	WD	ANOD.	GL1	F1	AL	01		REFER TO ELEVATION IN DRAWING A1000
GYM B - STORAGE	134F	134F	900	2150	B	WD	ANOD.	GL1	F1	AL	01		REFER TO ELEVATION IN DRAWING A1000
GYM C - STORAGE	134G	134G	900	2150	B	WD	ANOD.	GL1	F1	AL	01		REFER TO ELEVATION IN DRAWING A1000
PHYS. ED.	135	135.1	900	2150	B	WD	ANOD.	GL1	F1	AL	01		REFER TO ELEVATION IN DRAWING A1000
STAIR	135A	135A	1100	2150	A	HM	PT						
CHANGE ROOM WOMEN A	137	137	900	2150	B	WD	ANOD.	GL1	F1	AL	01		REFER TO ELEVATION IN DRAWING A1000
CHANGE ROOM WOMEN B	137	137	900	2150	B	WD	ANOD.	GL1	F1	AL	01		REFER TO ELEVATION IN DRAWING A1000
CHANGE ROOM MEN C	138	138	900	2150	B	WD	ANOD.	GL1	F1	AL	01		REFER TO ELEVATION IN DRAWING A1000
CHANGE ROOM MEN D	139	139	900	2150	B	WD	ANOD.	GL1	F1	AL	01		REFER TO ELEVATION IN DRAWING A1000
PHYS. ED.	140	140	900	2150	B	WD	ANOD.	GL1	F1	AL	01		REFER TO ELEVATION IN DRAWING A1000
STAIR	140A	140A	900	2150	B	WD	ANOD.	GL1	F1	AL	01		REFER TO ELEVATION IN DRAWING A1000
CHANGE ROOM E	141	141	900	2150	B	WD	ANOD.	GL1	F1	AL	01		REFER TO ELEVATION IN DRAWING A1000
FITNESS CENTRE	142	142	900	2150	B	WD	ANOD.	GL1	F1	AL	01		REFER TO ELEVATION IN DRAWING A1000
MACH.	143	143	900	2150	B	WD	ANOD.	GL1	F1	AL	01		REFER TO ELEVATION IN DRAWING A1000
W/R	144	144	900	2150	B	WD	ANOD.	GL1	F1	AL	01		REFER TO ELEVATION IN DRAWING A1000
ELEC. RM	146A	146A	900	2150	B	WD	ANOD.	GL1	F1	AL	01		REFER TO ELEVATION IN DRAWING A1000
CLASSROOM	147	147	900	2150	B	WD	ANOD.	GL1	F1	AL	01		REFER TO ELEVATION IN DRAWING A1000
CLASSROOM	148	148	900	2150	B	WD	ANOD.	GL1	F1	AL	01		REFER TO ELEVATION IN DRAWING A1000
CLASSROOM	149	149	900	2150	B	WD	ANOD.	GL1	F1	AL	01		REFER TO ELEVATION IN DRAWING A1000
CLASSROOM	150	150	900	2150	B	WD	ANOD.	GL1	F1	AL	01		REFER TO ELEVATION IN DRAWING A1000
CLASSROOM	151	151	900	2150	B	WD	ANOD.	GL1	F1	AL	01		REFER TO ELEVATION IN DRAWING A1000
STORAGE	152	152	900	2150	B	WD	ANOD.	GL1	F1	AL	01		REFER TO ELEVATION IN DRAWING A1000