


KEY PLAN

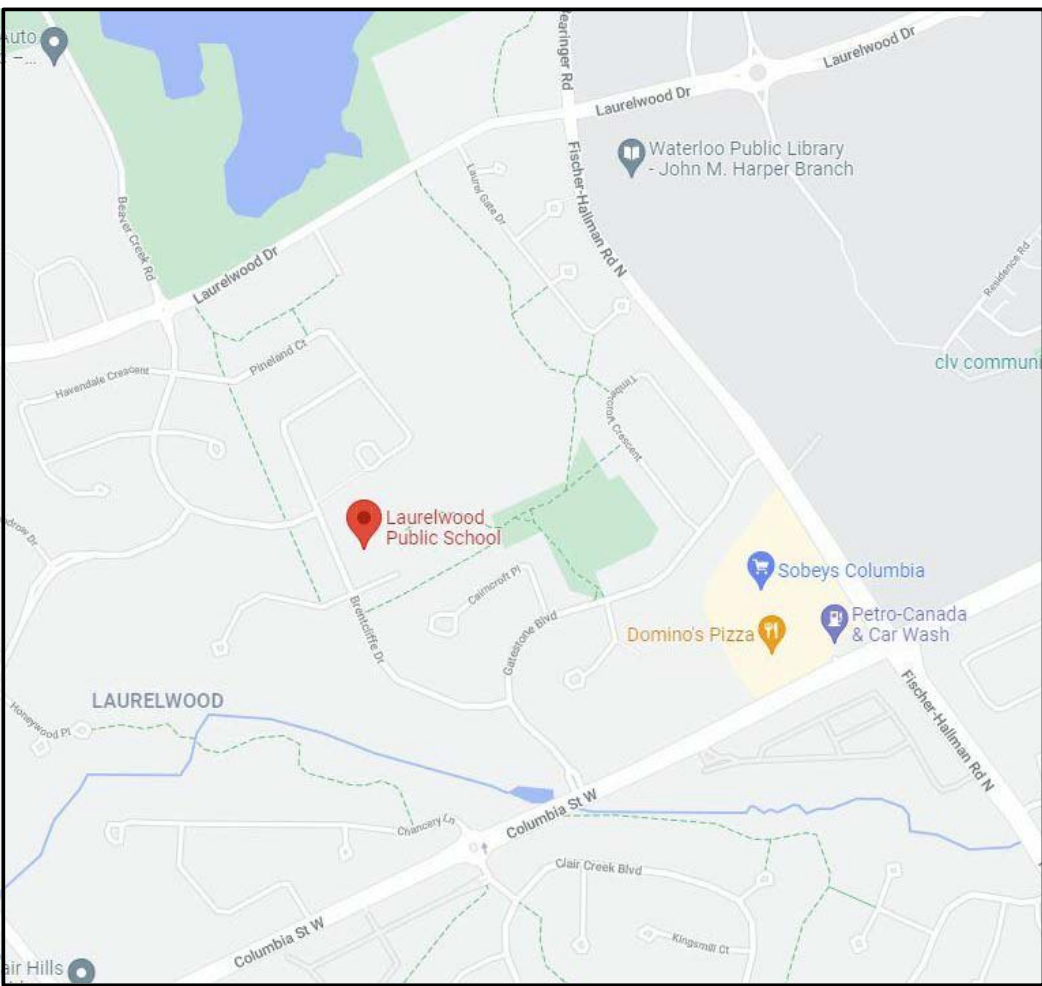

LAURELWOOD P.S. - HVAC AND CONTROLS UPGRADE
Tender No. 7263-RW-22

460 Brentcliffe Dr., Waterloo, ON N2T 2R5
March 11, 2022

HOSSACK
& ASSOCIATES
ARCHITECTS

4-2180 DUNWYN DRIVE
MISSISSAUGA, ONTARIO L5L 5M8
Tel: (905) 607-8284 Fax: (905) 607-8200

DEI
Consulting Engineers Inc.
MECHANICAL | ELECTRICAL | AQUATIC
35 Northline Road, Waterloo, ON N2V 1Y8
Phone: (519) 733-3555 Fax: (519) 733-3555
Website: deiassociates.ca



LAURELWOOD P.S. - HVAC AND CONTROLS UPGRADE

DRAWING LIST

ARCHITECTURAL

A-A01 KEY PLAN, SITE PLAN & OBC MATRIX
A-A02 PARTIAL GROUND FLOOR REFLECTED CEILING PLAN PART A
A-A03 PARTIAL GROUND FLOOR REFLECTED CEILING PLAN - PART B, ROOF PLAN AND DETAILS

STRUCTURAL

S2.1 OVERALL EXISTING ROOF FRAMING PLAN

MECHANICAL

M1.1 SCHEDULE LEGEND AND DETAIL
M2.1 FIRST FLOOR PART PLAN A - DEMOLITION
M2.2 FIRST FLOOR PART PLAN B - DEMOLITION
M3.1 FIRST FLOOR PART PLAN A - RENOVATION AND DETAILS
M3.2 FIRST FLOOR PART PLAN B - RENOVATION
M4.1 FIRST FLOOR FIRE PROTECTION
M5.1 ROOF PLAN - DEMOLITION
M5.2 ROOF PLAN - RENOVATION


ELECTRICAL

E1.1 KEY PLAN, DETAILS, DISTRIBUTION RISER DEMO. & RENO.
E1.2 FIRST FLOOR PART PLAN B - RENOVATION
E1.3 FIRE ALARM RISER DIAGRAM AND ELECTRICAL SPECIFICATION

SET No.

PROJECT NUMBER

21121A

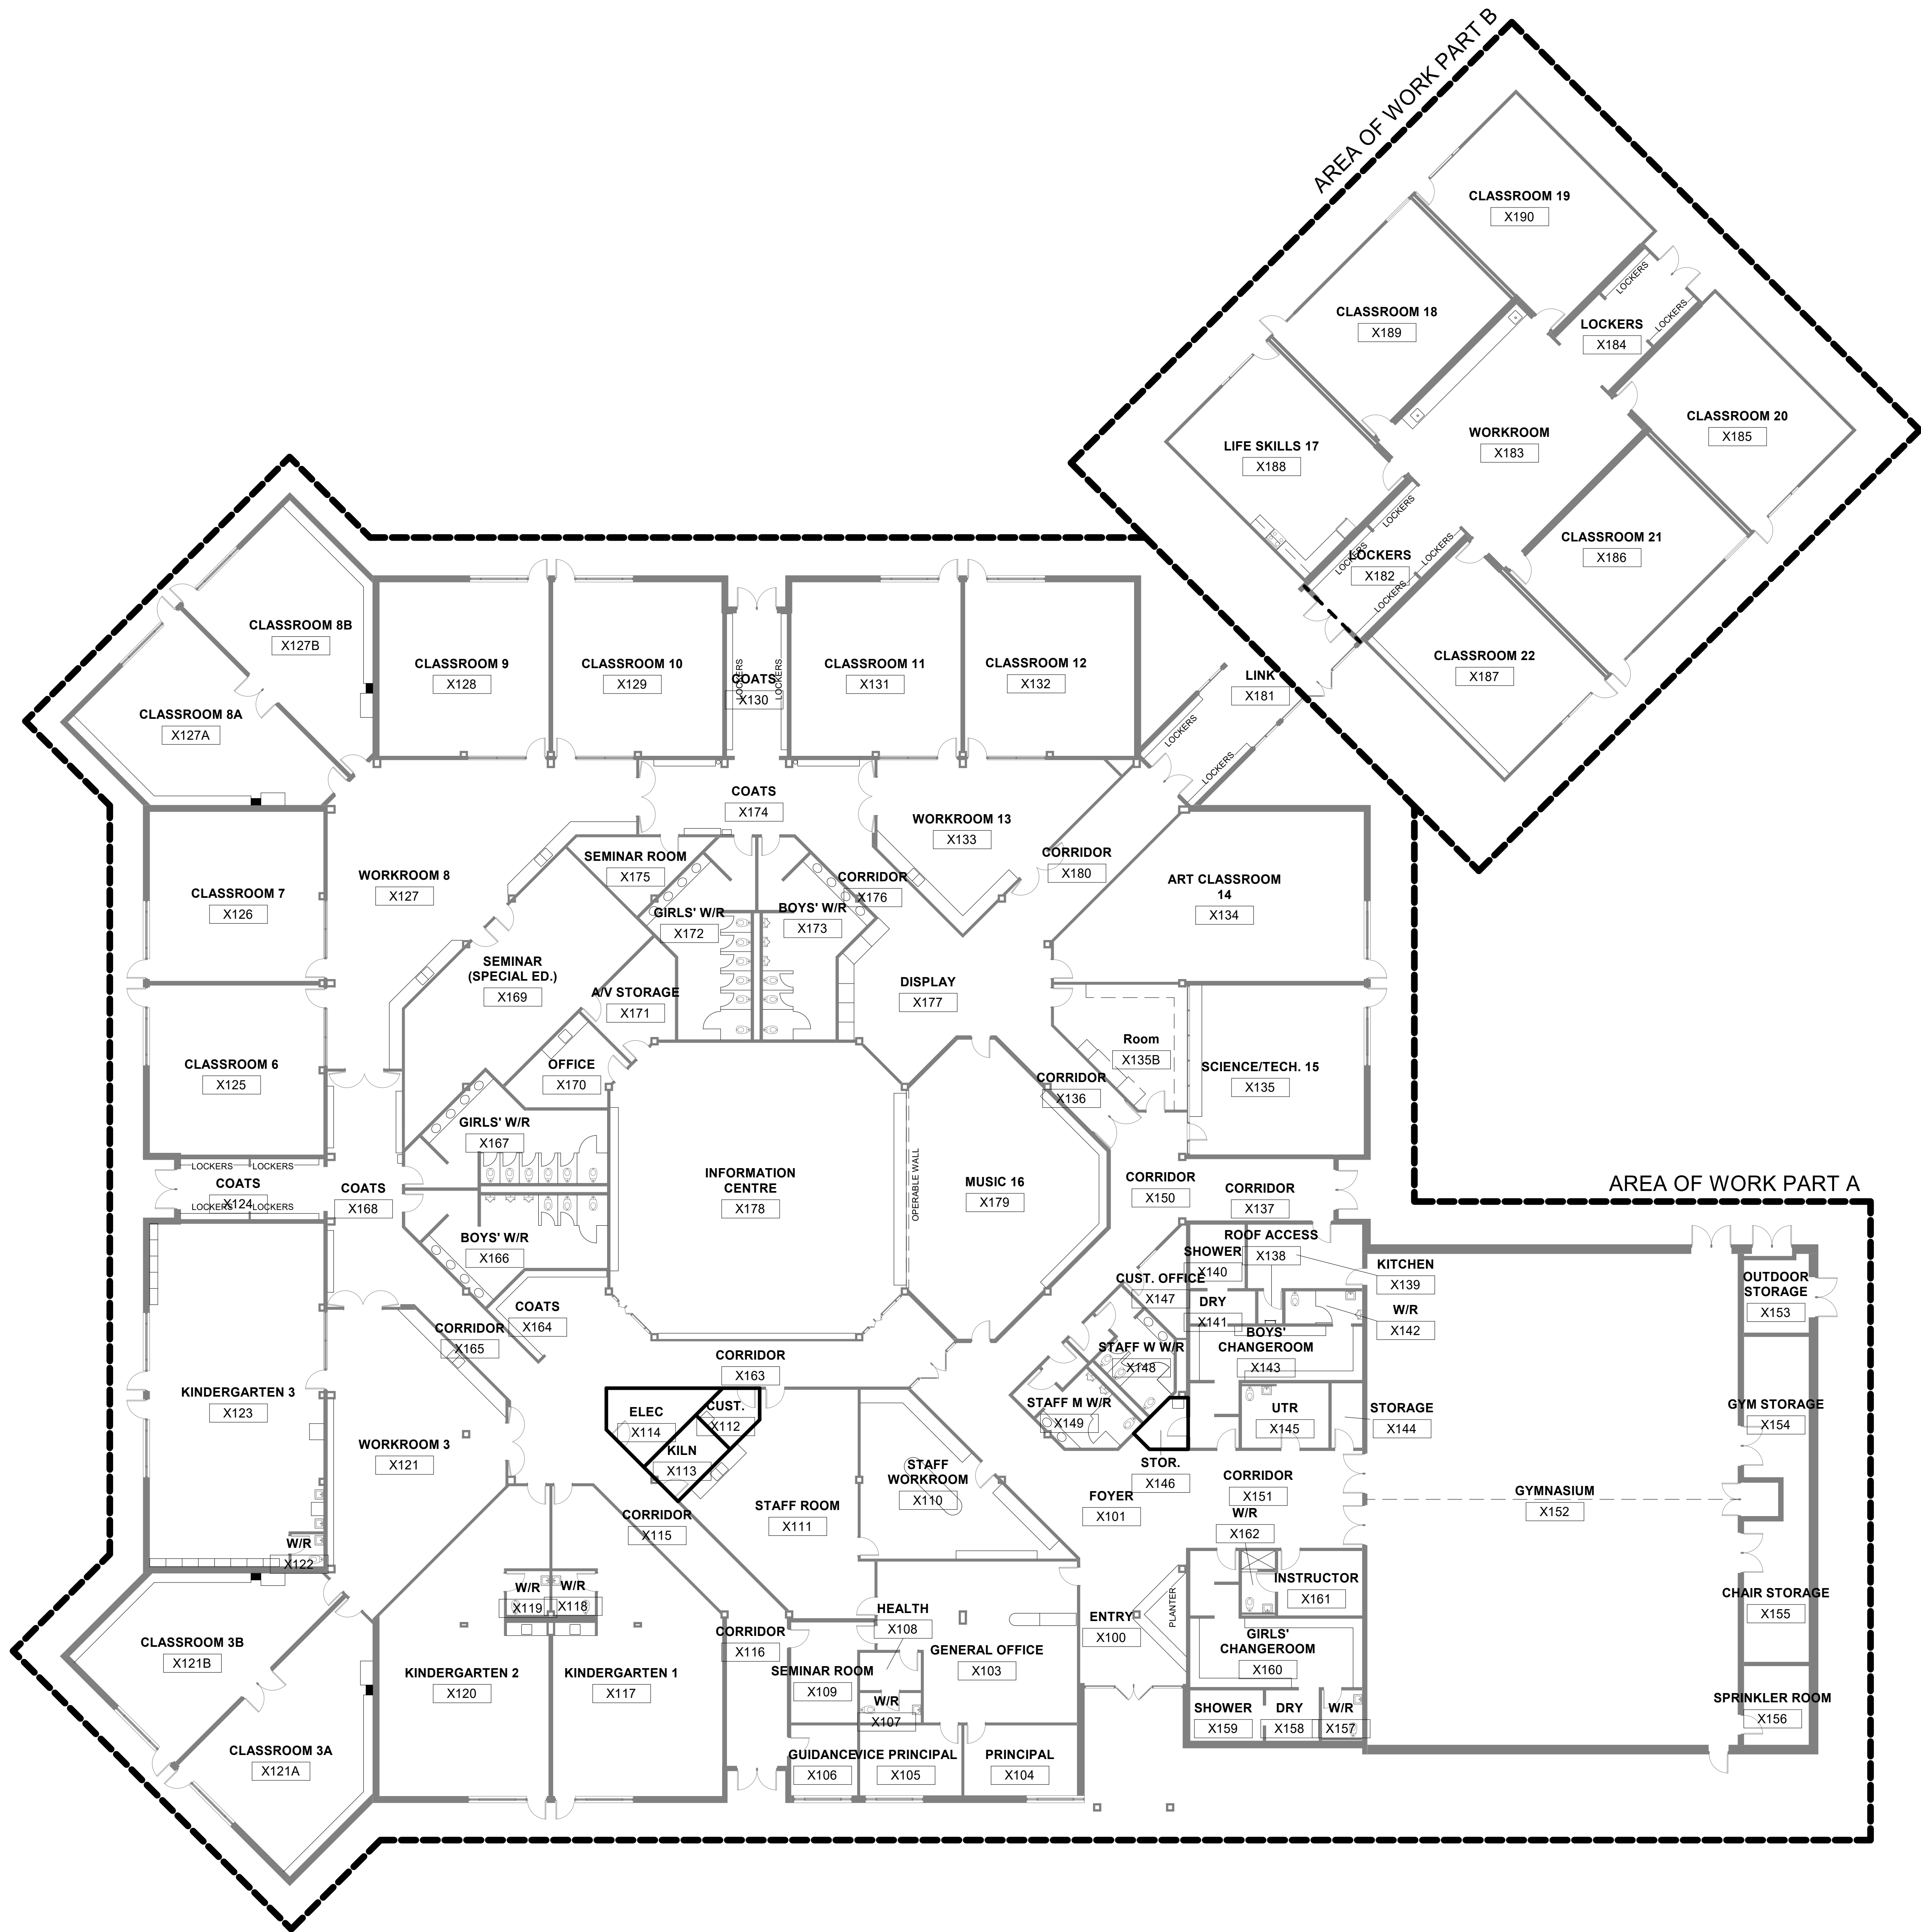


1 GROUND FLOOR - EXISTING
SCALE: 1" = 150'

OBC DATA MATRIX - PART 11


| Item | | | OBC Ref. |
|------|-------------------------------------|--|--|
| 11.1 | Existing building classification: | Describe Existing Use: ELEMENTARY SCHOOL (EX. SPRINKLERED) Construction Index: 5 - Non-combustible construction Hazard Index: 6 - Large Building - A2 Occupancy ■ Not applicable (no change of major occupancy) | 11.2.1 T 11.2.1.1A T 11.2.1.1B to N |
| 11.2 | Alteration to Existing Building is: | Basic Renovation: ■ Extensive Renovation: □ | 11.3.3.1 11.3.3.2 |
| 11.3 | Reduction in Performance Level: | Structural: By increase in occupant load: By change of major occupancy: Plumbing: Sewage-system: ■ No □ Yes ■ No □ Yes ■ No □ Yes ■ No □ Yes ■ No □ Yes N/A ■ No □ Yes N/A ■ No □ Yes | 11.4.2 11.4.2.1 11.4.2.2 11.4.2.3 11.4.2.4 11.4.2.5 |
| 11.4 | Compensating Construction: | Structural: Increase in occupant load: Change of major occupancy: Plumbing: Sewage-system: ■ No □ Yes ■ No □ Yes ■ No □ Yes ■ No □ Yes ■ No □ Yes N/A ■ No □ Yes N/A ■ No □ Yes | 11.4.2 11.4.2.1 11.4.2.2 11.4.2.3 11.4.2.4 11.4.2.5 |
| 11.5 | Compliance Alternatives Proposed: | ■ No (not required) □ Yes (give number(s)) | 11.5.1 |
| 11.6 | Alternative Measures Proposed: | ■ No □ Yes (explain) | 11.5.2 |

ROOF PENETRATIONS

REFER TO MECH., ELEC., STRUCTURAL DRAWINGS FOR NEW ROOF PENETRATIONS. G.C. TO SCRAPE BACK MIN. 400mm OF EXISTING ROOF FOR INSTALLATION AND TIES INTO EXISTING MEMBRANE AND INSULATION. COORDINATE WITH DIV. 15 & 16 & ROOFING DETAILS. PROVIDE PRESSURE TREATED WOOD BLOCKING AND CANT STRIP AT EDGES OF PENETRATION FROM NEW PENETRATIONS. COMPLETE WITH TRANSITION FLASHING MEMBRANES AND PREFIN. METAL FLASHING, AS REQUIRED FOR PENETRATIONS.

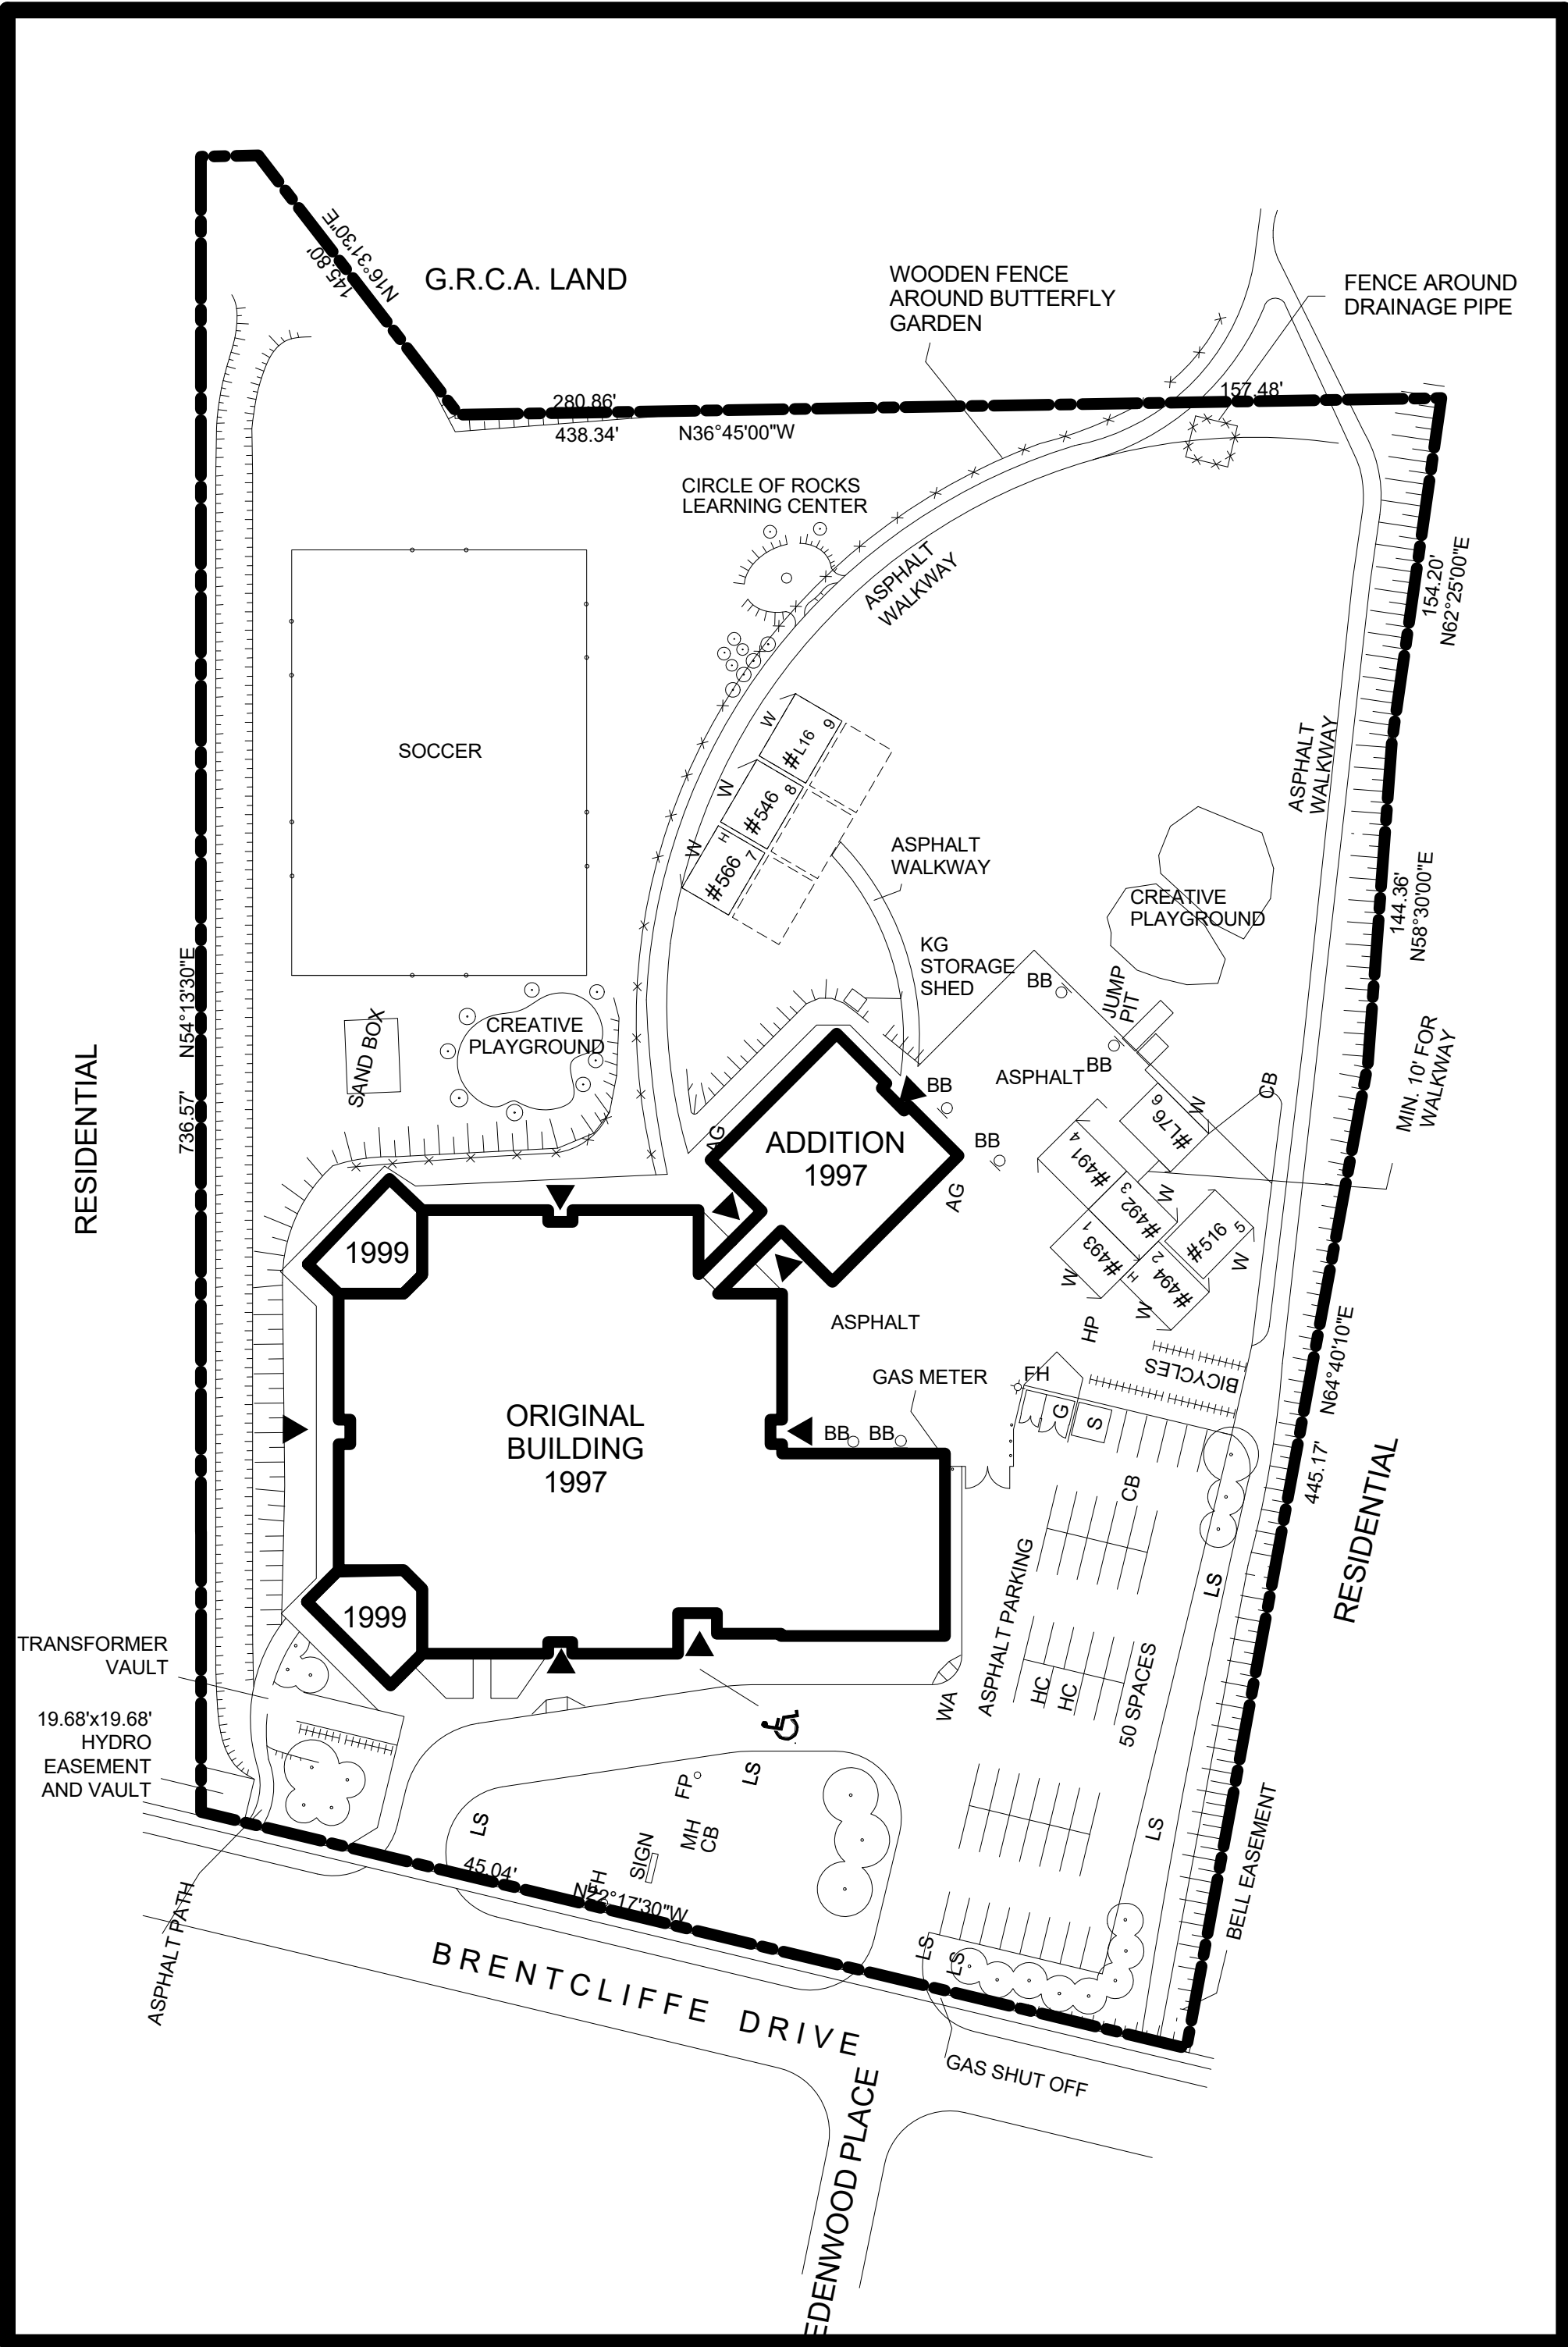

2 Site Plan
SCALE: 1" = 800'

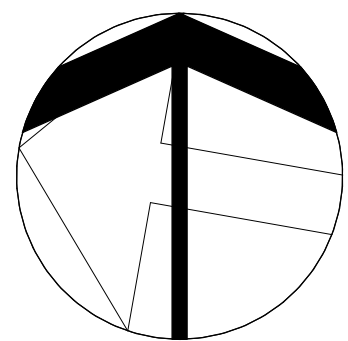

FIRE SEPARATION LEGEND

1 HOUR FIRE SEPARATION
3/4 HOUR FIRE SEPARATION


| NO. | DESCRIPTION | DATE |
|-----|--------------------------|----------|
| 2 | ISSUED FOR TENDER / BP | 22/03/11 |
| 1 | ISSUED FOR TENDER REVIEW | 22/03/11 |
| NO. | DESCRIPTION | DATE |

DRAWINGS ARE NOT TO BE SCALED. CONTRACTOR MUST CHECK AND VERIFY ALL DIMENSIONS AND CONDITIONS ON THE PROJECT AND MUST REPORT ANY DISCREPANCIES TO THE CONSULTANTS BEFORE PROCEEDING WITH THE WORK. THE USE OF THIS DRAWING OR PART THEREOF IS FORBIDDEN WITHOUT THE WRITTEN APPROVAL OF THE CONSULTANTS.



LAURELWOOD P.S. - HVAC AND CONTROLS UPGRADE

460 Brentcliffe Dr., Waterloo, ON N2T 2R5

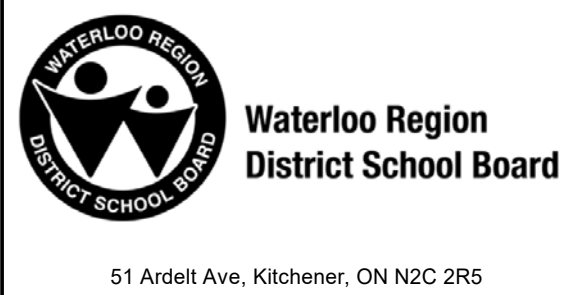

KEY PLAN, SITE PLAN & OBC MATRIX

HOSSACK & ASSOCIATES ARCHITECTS

2-1102 DUNDAS DRIVE
MISSISSAUGA, ONTARIO L5L 5B6
Tel: (905) 807-0294 Fax: (905) 807-0290

| SCALE | PROJECT |
|--------------|---------------------------|
| As indicated | 21121A |
| DATE | March 11, 2022 |
| DRAWN | DRAWING |
| CHECKED | PL |
| PRINT DATE | 3/11/2022 2:07:51 PM |
| REVIT FILE | T:\2021\2112102\Revit\RV1 |

GENERAL DEMOLITION NOTES
to be followed for Reflected Ceiling Plans

- PATCH AND MAKE GOOD ANY MINOR HOLES DUE TO HARDWARE IN EXISTING WALLS TO PREPARE FOR NEW FINISHES.
- OWNER TO REMOVE ALL PLAQUES, MIRRORS AND ARTWORK PRIOR TO DEMOLITION. PATCH AND MAKE GOOD ANY MINOR HOLES FROM REMOVALS IN EXISTING WALLS TO PREPARE FOR NEW FINISHES.
- COORDINATE AND PREPARE FOR NEW WORK INCLUDING REMOVALS, CUTTING, PREPARATION ETC. WHETHER ITEMS ARE SHOWN ON DEMOLITION PLAN OR NOT. INCLUDE ALL REQUIREMENTS FOR DEMOLITION AND PREPARATION TO SUIT PROPOSED FLOOR PLANS. ALL NECESSARY DISCONNECTS AND ALTERATIONS TO EXISTING MECHANICAL AND ELECTRICAL SYSTEMS SHALL BE INCLUDED. PATCH AND MAKE GOOD ALL EXISTING FINISHES TO REMAIN. REFER TO SCHEDULES AND SPECIFICATIONS FOR OTHER NECESSARY REQUIREMENTS.
- RENOVATED AREAS TO BE THOROUGHLY CLEANED TO OWNER SATISFACTION. ALL OF CONSTRUCTION DUST, DEBRIS AND MATERIALS.
- ALL DIMENSIONS IN AREA OF WORK TO BE FIELD VERIFIED BY G.C. PRIOR TO START OF CONSTRUCTION.

CONSTRUCTION RCP NOTES

ALL REMOVALS/DEMOLITIONS TO BE COORDINATED WITH STRUCTURAL, MECHANICAL, ELECTRICAL DRAWINGS PRIOR TO DEMOLITION START. FOR ADDITIONAL DEMOLITION, DOCUMENTS AND DETAILS SEE STRUCTURAL, MECH. AND ELEC. DWGS.

NOT ALL EXISTING LIGHT FIXTURES, GRILLES, DIFFUSERS, SPRINKLER HEADS ETC. ARE NOT SHOWN ON THIS PAGE. REFER TO DEMOLITION MECH AND ELECTRICAL DRAWINGS.

PATCH AND MAKE GOOD ALL EXISTING WALLS TO REMAIN FROM CEILING DEMOLITION AND REMOVED WALL MTD. LIGHT FIXTURES AND DEVICES. REFER TO PROPOSED PLANS AND FOR NEW CEILING MATERIALS AND FINISHES.

GENERAL CONTRACTOR IS RESPONSIBLE TO REVIEW ABATEMENT REPORT IN SPECIFICATION FOR EXTENT OF ALL DESIGNATED SUBSTANCE AND HAZARDOUS MATERIALS SURVEYS AND EXTENT OF ABATEMENT WORK.

NOTE: ALL EXISTING CEILING HEIGHTS ARE 4'-0" AND MAY VARY. FIELD VERIFY AS REQUIRED.

C1 CAREFULLY REMOVE EXISTING ACOUSTIC CEILING TILES, GRIDS, DIFFUSERS, LIGHTING, RETURNS, ETC. AS REQUIRED TO INSTALL NEW MECHANICAL DEVICES & DUCTWORK OR STRUCTURAL RE-INFORCEMENTS. SAFELY STORE ON SITE. UPON COMPLETION OF STRUCTURAL & MECHANICAL WORK REINSTALL TO MATCH PREVIOUS LOCATION. REFER TO STRUCT./MECH./ELEC. DRAWINGS. MAKE GOOD ANY HOLES FROM PERIMETER SUPPORTS.


C2 PRIME AND PAINT ALL NEW EXPOSED DUCT WORK & GRILLES TO MATCH ADJACENT. REFER TO SPECIFICATION FOR PAINT COLOUR.

C3 COMPLETELY REMOVE EXISTING GYPSUM CEILING, BULKHEADS, AND STUD FRAMING. PATCH AND MAKE GOOD EXISTING WALLS TO REMAIN AS REQUIRED FROM DEMOLITION. CAREFULLY REMOVE AND/OR RELOCATE EXISTING LIGHT FIXTURES, GRILLES, AND ELECTRICAL AND MECHANICAL DEVICES AS REQUIRED. SAFELY STORE DEVICES ON SITE. UPON COMPLETION OF STRUCTURAL & MECHANICAL WORK INSTALL NEW GYPSUM CEILING, BULKHEAD, FRAMING, INCLUDING ALL LIGHTING AND DEVICES. PRIME AND PAINT. REFER TO MECHANICAL AND ELECTRICAL DRAWINGS. REFER TO SPECIFICATION.

C4 COMPLETELY REMOVE EXISTING 1 HOUR FIRE RATED GYPSUM CEILING, BULKHEADS, AND STUD FRAMING. PATCH AND MAKE GOOD EXISTING WALLS TO REMAIN AS REQUIRED FROM DEMOLITION. CAREFULLY REMOVE AND/OR RELOCATE EXISTING LIGHT FIXTURES, GRILLES, AND ELECTRICAL AND MECHANICAL DEVICES AS REQUIRED. SAFELY STORE DEVICES ON SITE. UPON COMPLETION OF STRUCTURAL & MECHANICAL WORK INSTALL NEW 1 HOUR FIRE RATED GYPSUM CEILING, BULKHEAD, FRAMING, INCLUDING ALL LIGHTING AND DEVICES. PRIME AND PAINT. REFER TO MECHANICAL AND ELECTRICAL DRAWINGS. REFER TO SPECIFICATION.


C5 CAREFULLY SAW CUT OPENING IN EXISTING BLOCK WALL FOR NEW DUCTWORK. COORDINATE OPENING SIZE WITH MECHANICAL DRAWINGS.

C6 AREA OF STRUCTURAL REINFORCEMENT. PRIME AND PAINT NEW STRUCTURAL MEMBERS TO MATCH ADJACENT PAINT COLOURS. REFER TO STRUCTURAL DRAWINGS & SPECIFICATIONS.

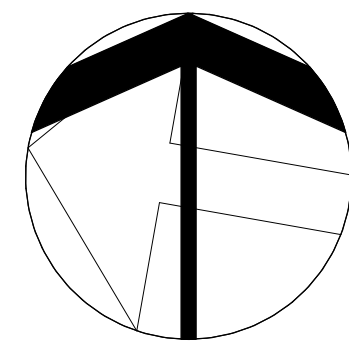

RCP LEGEND

- EX LIGHT FIXTURE REFER TO LIGHTING PLANS/LIGHTING SCHEDULES FOR TYPE
- EX LIGHT FIXTURE. REFER TO LIGHTING PLANS/LIGHTING SCHEDULES FOR TYPE
- EX LIGHT FIXTURE. REFER TO LIGHTING PLANS/LIGHTING SCHEDULES FOR TYPE
- ACOUSTIC CEILING PANELS REFER TO SPECIFICATIONS FOR DESCRIPTION OF TYPES
- GYPSUM BOARD CEILING OR BULKHEAD
- AREA OF EXISTING ACOUSTIC CEILING TILE & GRID TO BE RE-RE FOR MECHANICAL WORK
- AREA OF EXISTING GYPSUM CEILINGS TO BE RE-RE FOR MECHANICAL WORK
- AREA OF EXPOSED STRUCTURE. PRIME AND PAINT NEW MEMBERS TO MATCH ADJ.

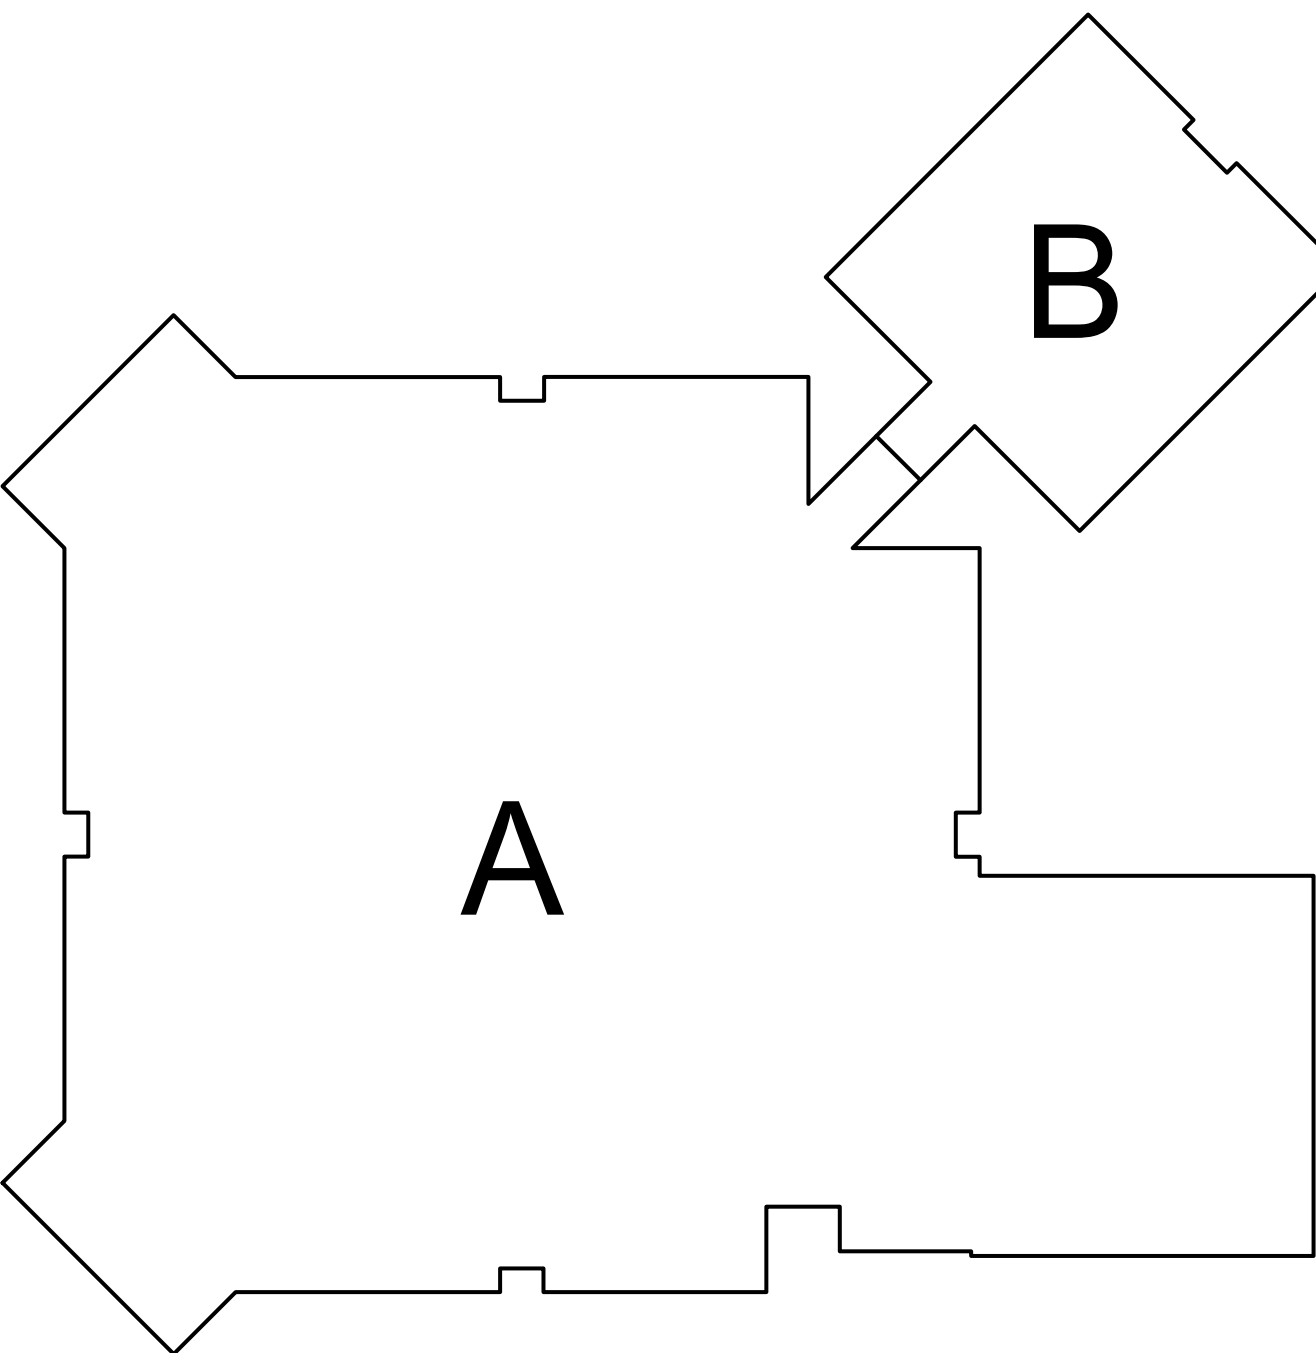

KEYPLAN - N.T.S.

| | | |
|----|--------------------------|----------|
| 2 | ISSUED FOR TENDER / BP | 22/03/11 |
| 1 | ISSUED FOR TENDER REVIEW | 22/03/01 |
| NO | DESCRIPTION | DATE |

DRAWINGS ARE NOT TO BE SCALED. CONTRACTOR MUST CHECK AND VERIFY ALL DIMENSIONS AND CONDITIONS ON THE PROJECT AND MUST REPORT ANY DISCREPANCIES TO THE CONSULTANTS BEFORE PROCEEDING WITH THE WORK. THE USE OF THIS DRAWING OR PART THEREOF IS FORBIDDEN WITHOUT THE WRITTEN APPROVAL OF THE CONSULTANTS.



LAURELWOOD P.S. -
HVAC AND CONTROLS
UPGRADE

460 Brentcliffe Dr, Waterloo, ON N2T 2R5



PARTIAL GROUND
FLOOR REFLECTED
CEILING PLAN -
PART A

HOSSACK
& ASSOCIATES
ARCHITECTS



| | |
|--------------|---------------------------|
| SCALE | PROJECT |
| As indicated | 21121A |
| DATE | March 11, 2022 |
| DRAWN | DRAWING |
| CHECKED | PL |
| PRINT DATE | 3/11/2022 2:08:22 PM |
| REVIT FILE | T:\2021\2112102\Revit.RVT |

GENERAL DEMOLITION NOTES
to be followed for Reflected Ceiling Plans

1. PATCH AND MAKE GOOD ANY MINOR HOLES DUE TO HARDWARE IN EXISTING WALLS TO PREPARE FOR NEW FINISHES.
2. OWNER TO REMOVE ALL PLAQUES, MIRRORS AND ARTWORK PRIOR TO DEMOLITION. PATCH AND MAKE GOOD ANY MINOR HOLES FROM REMOVALS IN EXISTING WALLS TO PREPARE FOR NEW FINISHES.
3. COORDINATE AND PREPARE FOR NEW WORK INCLUDING REMOVALS, CUTTING, PREPARATION ETC. WHETHER ITEMS ARE SHOWN ON DEMOLITION PLAN OR NOT. INCLUDE ALL REQUIREMENTS FOR DEMOLITION AND PREPARATION TO SUIT PROPOSED FLOOR PLANS. ALL NECESSARY DISCONNECTS AND ALTERATIONS TO EXISTING MECHANICAL AND ELECTRICAL SYSTEMS SHALL BE INCLUDED. PATCH AND MAKE GOOD ALL EXISTING FINISHES TO REMAIN. REFER TO SCHEDULES AND SPECIFICATIONS FOR OTHER NECESSARY REQUIREMENTS.
4. RENOVATED AREAS TO BE THOROUGHLY CLEANED TO OWNER SATISFACTION. ALL OF CONSTRUCTION DUST, DEBRIS AND MATERIALS.
5. ALL DIMENSIONS IN AREA OF WORK TO BE FIELD VERIFIED BY G.C. PRIOR TO START OF CONSTRUCTION.

CONSTRUCTION RCP NOTES

ALL REMOVALS/DEMOLITIONS TO BE COORDINATED WITH STRUCTURAL, MECHANICAL, ELECTRICAL DRAWINGS PRIOR TO DEMOLITION START. FOR ADDITIONAL DEMOLITION, DOCUMENTS AND DETAILS SEE STRUCTURAL, MECH AND ELECT. DWGS.

NOT ALL EXISTING LIGHT FIXTURES, GRILLES, DIFFUSERS, SPRINKLER HEADS ETC. ARE NOT SHOWN ON THIS PAGE. REFER TO DEMOLITION MECH AND ELECTRICAL DRAWINGS.


PATCH AND MAKE GOOD ALL EXISTING WALLS TO REMAIN FROM CEILING DEMOLITION AND REMOVED WALL MTD. LIGHT FIXTURES AND DEVICES. REFER TO PROPOSED PLANS AND FOR NEW CEILING MATERIALS AND FINISHES.

GENERAL CONTRACTOR IS RESPONSIBLE TO REVIEW ABATEMENT REPORT IN SPECIFICATION FOR EXTENT OF ALL DESIGNATED SUBSTANCE AND HAZARDOUS MATERIALS SURVEYS AND EXTENT OF ABATEMENT WORK.

NOTE: ALL EXISTING CEILING HEIGHTS ARE +/- AND MAY VARY. FIELD VERIFY AS REQUIRED.

CAREFULLY REMOVE EXISTING ACOUSTIC CEILING TILES, GRIDS, DIFFUSERS, LIGHTING, RETURNS, ETC. AS REQUIRED TO INSTALL NEW MECHANICAL DEVICES & DUCTWORK OR STRUCTURAL RE-INFORCEMENTS. SAFELY STORE ON SITE. UPON COMPLETION OF STRUCTURAL & MECHANICAL WORK REINSTALL TO MATCH PREVIOUS LOCATION. REFER TO STRUCT. MECH. ELECT. DRAWINGS. MAKE GOOD ANY HOLES FROM PERIMETER SUPPORTS.

CAREFULLY SAW CUT OPENING IN EXISTING BLOCK WALL FOR NEW DUCTWORK. REFER TO STRUCTURAL DRAWINGS FOR STANDARD LINTEL. CAULK AROUND OPENING & NEW DUCTWORK. COORDINATE OPENING SIZE WITH MECHANICAL DRAWINGS.

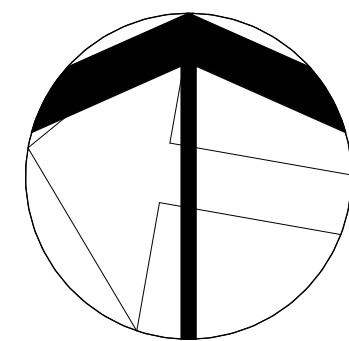



RCP LEGEND

- EX. LIGHT FIXTURE REFER TO LIGHTING PLANS/LIGHTING SCHEDULES FOR TYPE
- EX. LIGHT FIXTURE. REFER TO LIGHTING PLANS/LIGHTING SCHEDULES FOR TYPE
- EX. LIGHT FIXTURE. REFER TO LIGHTING PLANS/LIGHTING SCHEDULES FOR TYPE
- ACOUSTIC CEILING PANELS REFER TO SPECIFICATIONS FOR DESCRIPTION OF TYPES
- GYPSUM BOARD CEILING OR BULKHEAD
- AREA OF EXISTING ACOUSTIC CEILING TILE & GRID TO BE RE-RE FOR MECHANICAL WORK.
- AREA OF EXISTING GYPSUM CEILINGS TO BE RE-RE FOR MECHANICAL WORK.
- AREA OF EXPOSED STRUCTURE PRIME AND PAINT NEW MEMBERS TO MATCH ADJ.

CONSTRUCTION ROOF NOTES

ALL REMOVALS/DEMOLITIONS TO BE COORDINATED WITH STRUCTURAL, MECHANICAL, ELECTRICAL DRAWINGS PRIOR TO DEMOLITION START. FOR ADDITIONAL DEMOLITION, DOCUMENTS AND DETAILS SEE STRUCTURAL, MECH AND ELECT. DWGS.

1. DEMOLISH EXISTING ROOF CURB AND INFILL EXISTING ROOF SYSTEM. REFER TO SPECIFICATION AND TYPICAL DETAILS.
2. SUPPLY AND INSTALL BENT METAL SHROUD OVER EXISTING GAS PIPE. SHROUD TO EXTEND FROM TOP OF EXISTING GYM DOOR FRAME TO PARAPET. APPROX. 57M.
3. NEW HVAC UNITS TO BE INSTALLED ON EXISTING ROOF CURB WITH ADAPTER. REFER TO MECHANICAL SPECIFICATION & DRAWINGS.
4. NEW HVAC UNITS TO BE INSTALLED ON NEW 600MM ROOF CURB. CONTRACTOR TO REMOVE EXISTING ROOF CURB, AND CUT BACK ROOF & DECK AS REQUIRED TO INSTALL NEW CURB. REFER TO STANDARD DETAILS IN SPECIFICATION FOR NEW CURB AND ROOF TIE IN DETAIL. REFER TO MECHANICAL SPECIFICATION & DRAWINGS.

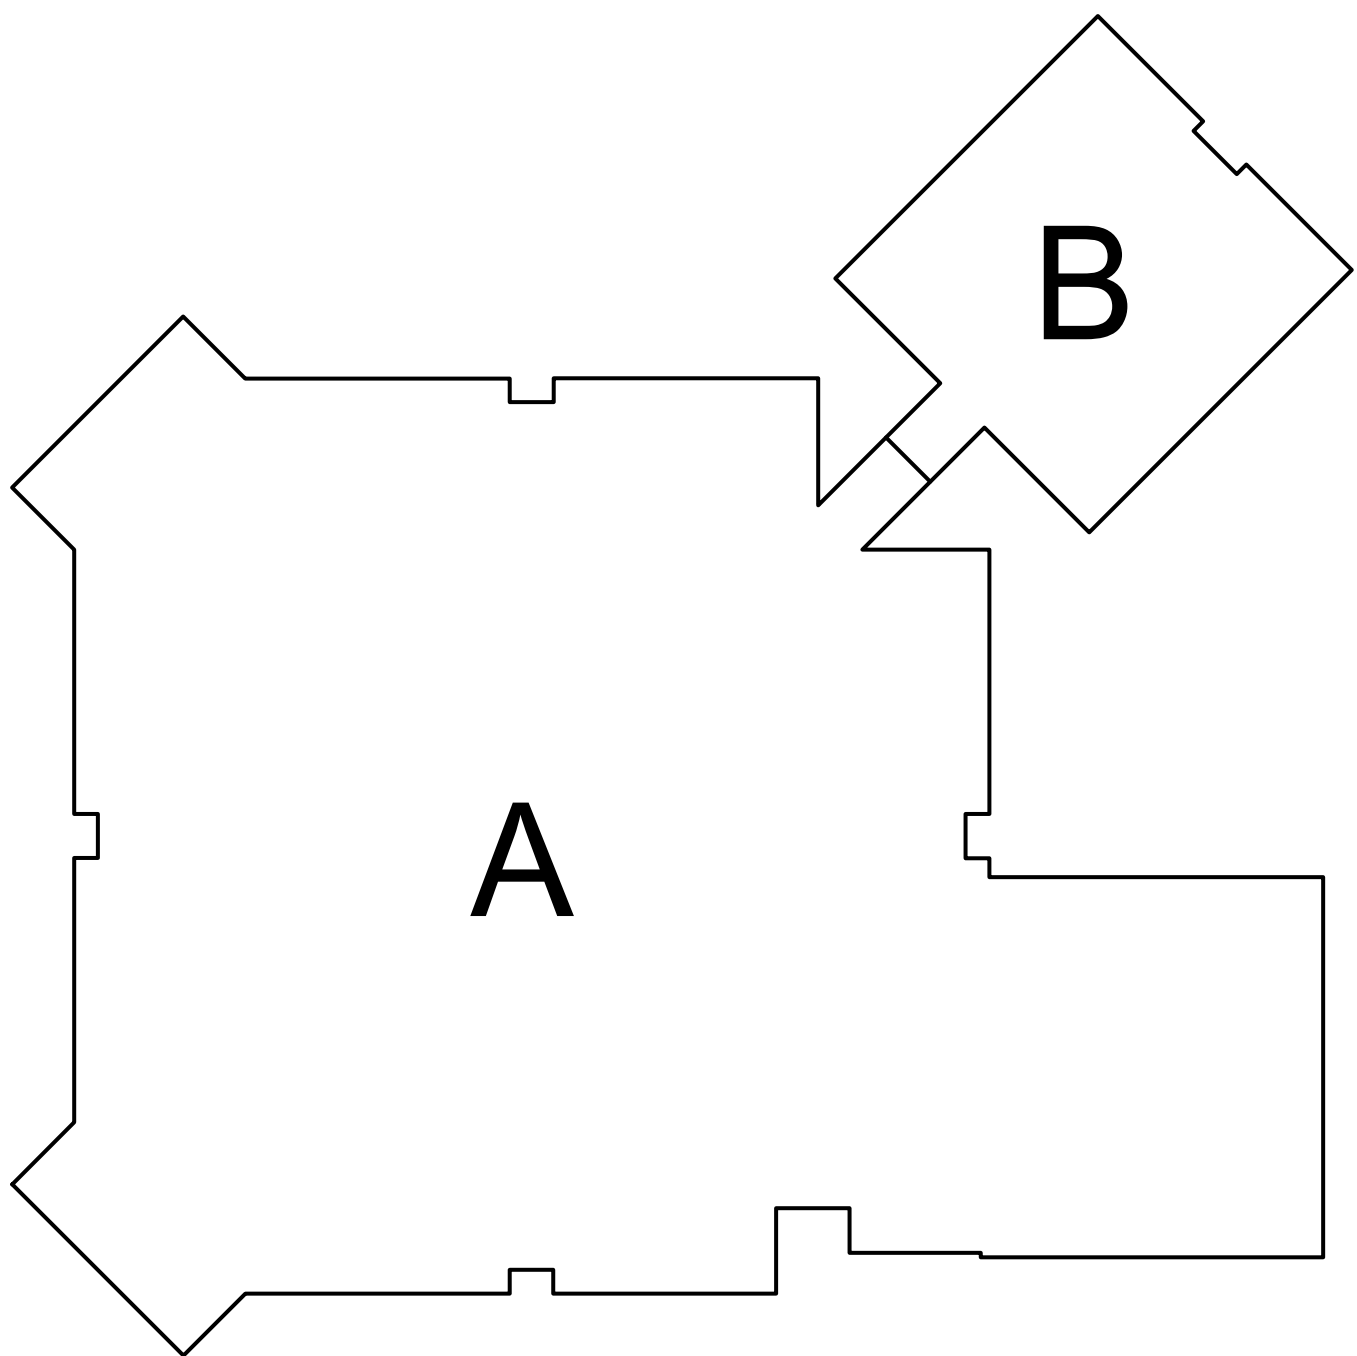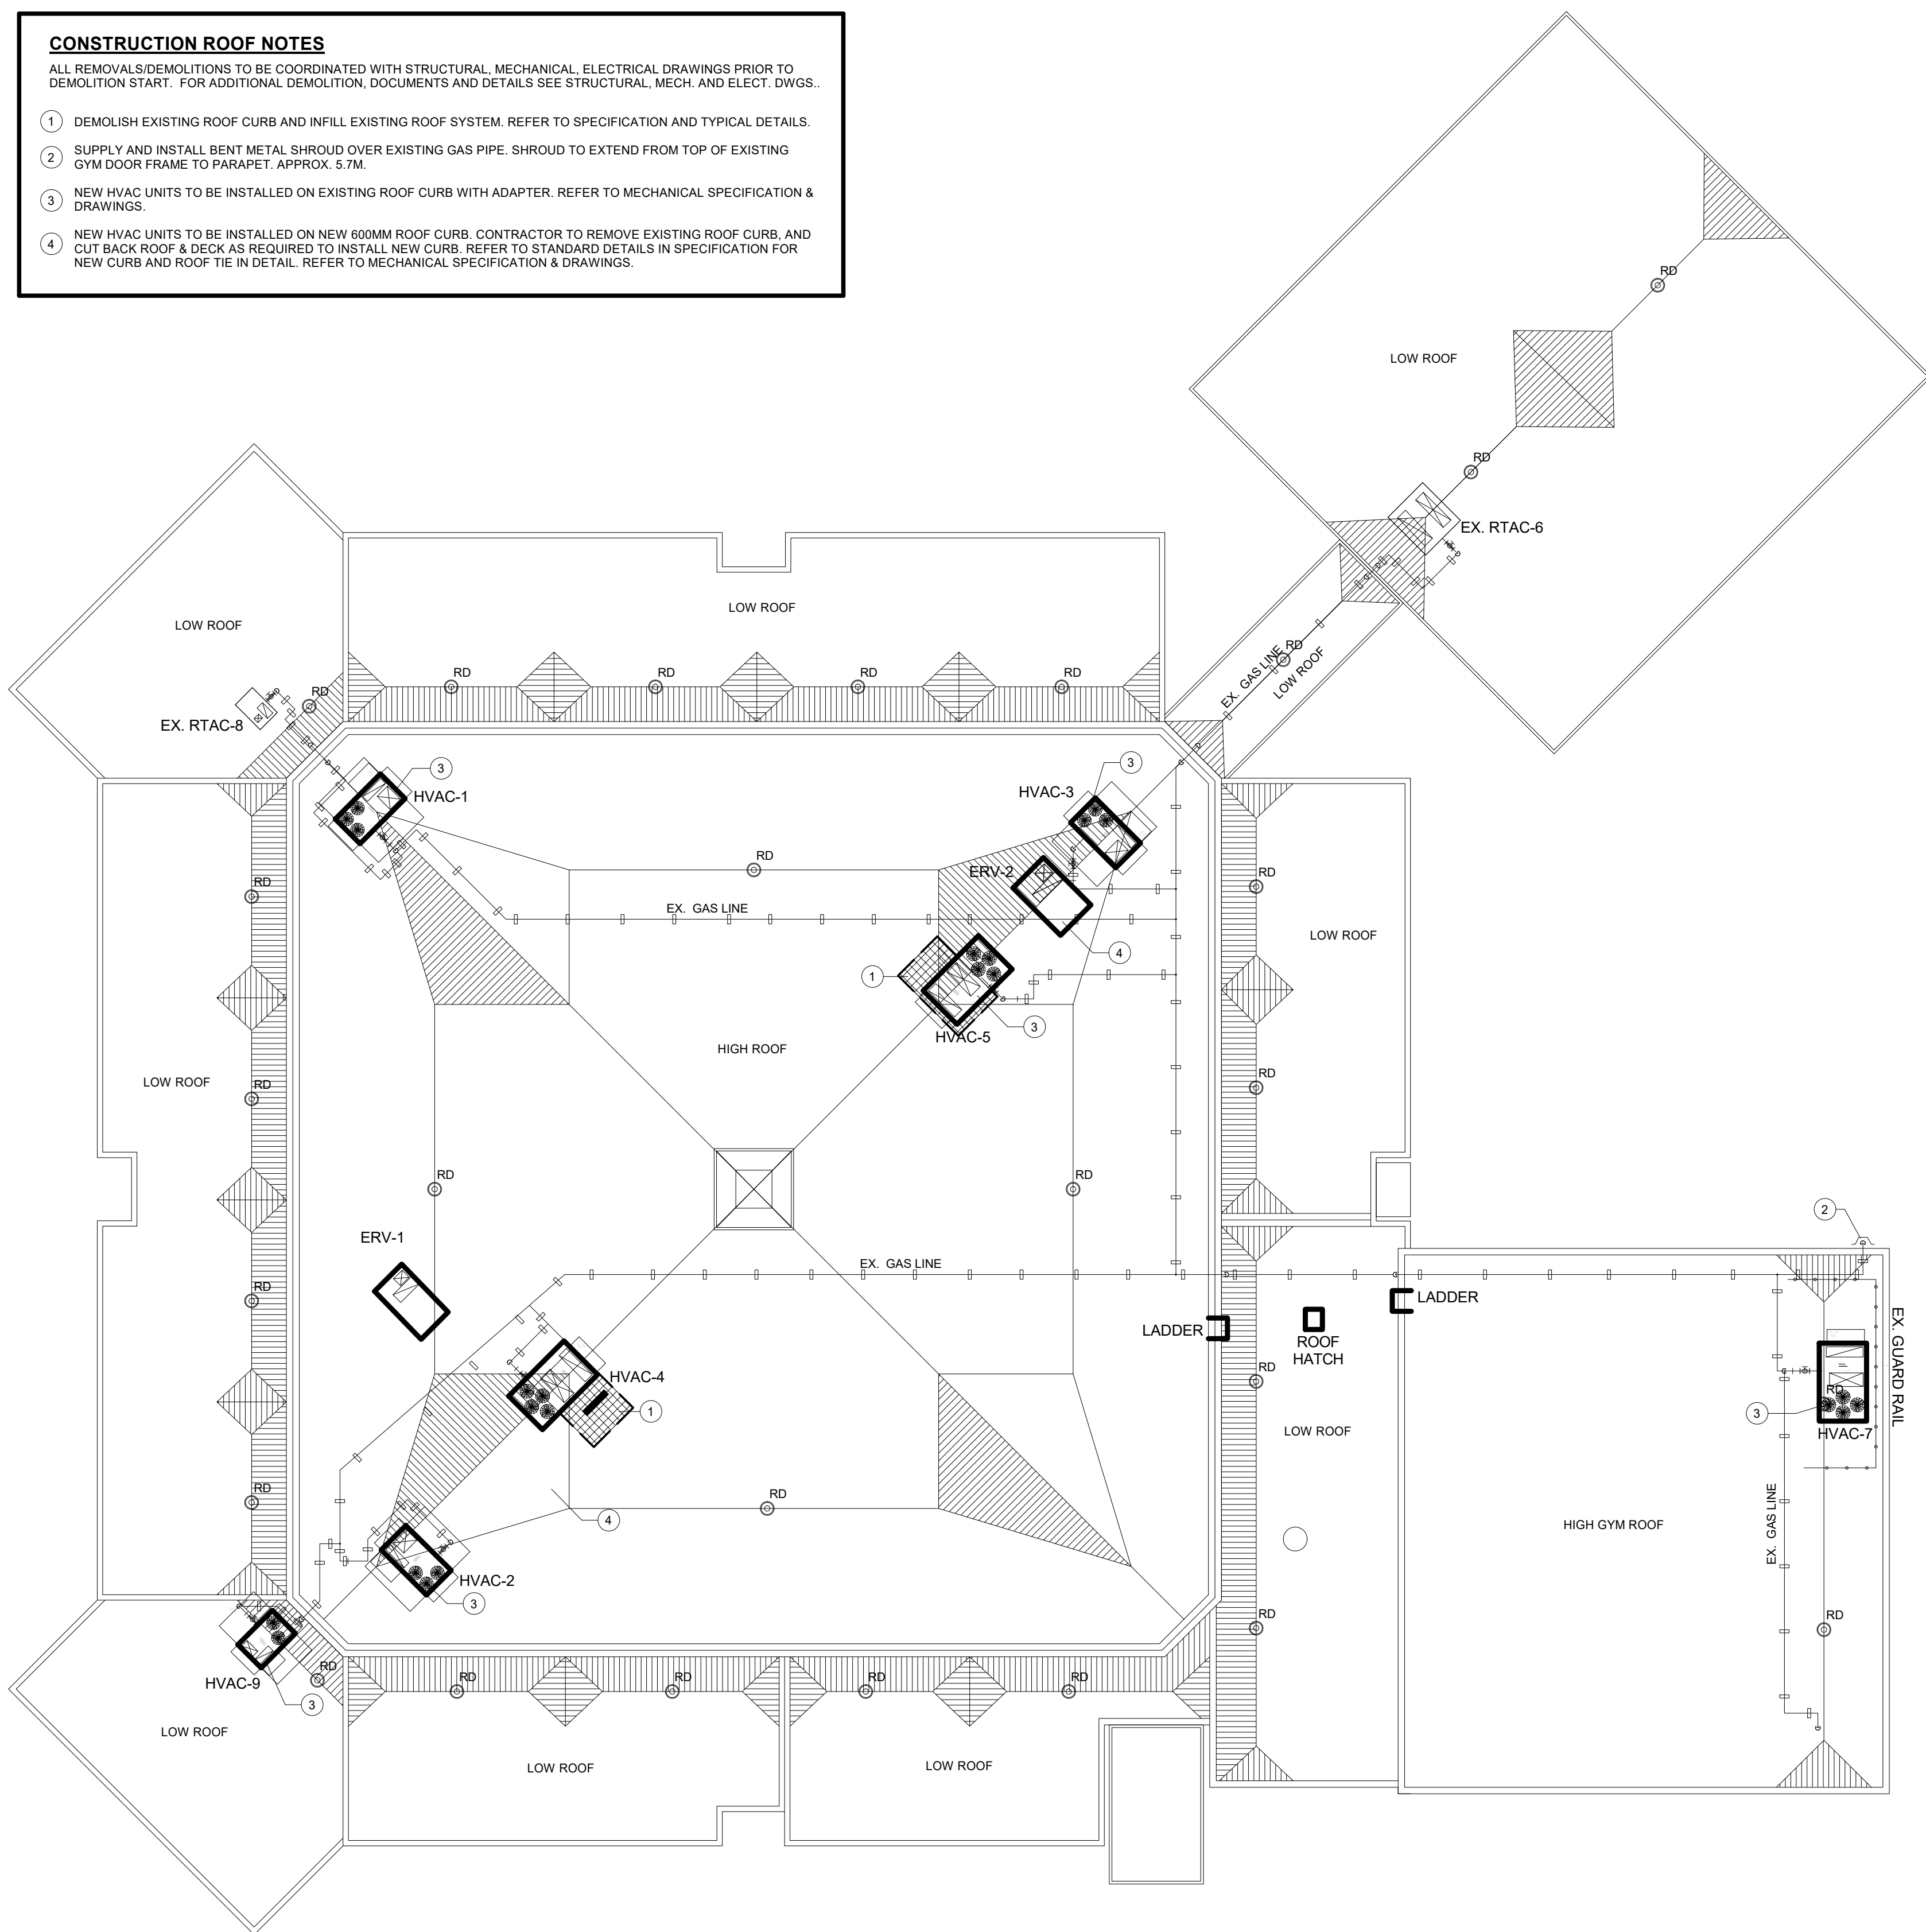

KEYPLAN - N.T.S.




| NO. | DESCRIPTION | DATE |
|-----|--------------------------|----------|
| 2 | ISSUED FOR TENDER / BP | 22/03/11 |
| 1 | ISSUED FOR TENDER REVIEW | 22/03/01 |

DRAWINGS ARE NOT TO BE SCALED. CONTRACTOR MUST CHECK AND VERIFY ALL DIMENSIONS AND CONDITIONS ON THE PROJECT AND MUST REPORT ANY DISCREPANCIES TO THE CONSULTANTS BEFORE PROCEEDING WITH THE WORK. THE USE OF THIS DRAWING OR PART THEREOF IS FORBIDDEN WITHOUT THE WRITTEN APPROVAL OF THE CONSULTANTS.



LAURELWOOD P.S. -
HVAC AND CONTROLS
UPGRADE

460 Brentcliffe Dr, Waterloo, ON N2T 2R5

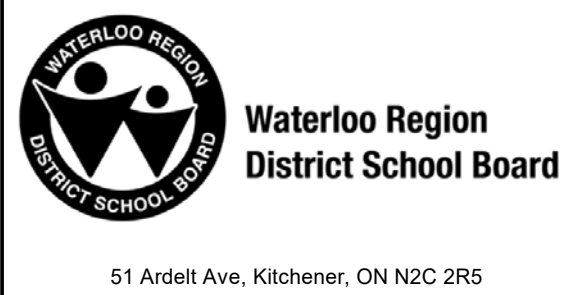

PARTIAL GROUND
FLOOR REFLECTED
CEILING PLAN -
PART B, ROOF PLAN
AND DETAILS

HOSSACK
& ASSOCIATES
ARCHITECTS



| SCALE | PROJECT |
|-----------------------------------|---------|
| As indicated | 21121A |
| DATE: March 11, 2022 | |
| DRAWN: JK | DRAWING |
| CHECKED: PL | PL |
| PRINT DATE: 3/11/2022 2:12:10 PM | |
| REVIT FILE: T:20212121022Rev1.RVT | |

REVIT FILE 02394-300 - Laurelwood v2020.rvt

HVAC UNIT SCHEDULE

| Item | Type | Sys. | Capacity (tons) | Capacity (cfm) | Heating (tons) | Heating (cfm) | Cooling (tons) | Cooling (cfm) | ESP in wc | Max. Position Outdoor Air | Size Bhp | Voltage | Electrical MCA | MOCP | Manufacturer & Model | Weight (lbs.) | Remarks |
|--------|--------------------------|------|--------------------|-------------------|-------------------|------------------|-------------------|------------------|--------------|------------------------------|-------------|---------|-------------------|------|-------------------------|------------------|--------------------------|
| HVAC-1 | PACKAGED ROOFTOP HVAC | WT | 12.5 | 4000 | GAS | 240 | 146 | 1.2 | 40% | 2.46 | 575/3/60 | 29 | 35 | | CARRIER 48HCE14 | 2000± | C/W HIGH STAGE HEATING |
| HVAC-2 | PACKAGED ROOFTOP HVAC | WT | 12.5 | 4880 | GAS | 240 | 146 | 1.2 | 40% | 3.15 | 575/3/60 | 29 | 35 | | CARRIER 48HCE14 | 2000± | C/W HIGH STAGE HEATING |
| HVAC-3 | PACKAGED ROOFTOP HVAC | WT | 12.5 | 4000 | GAS | 240 | 146 | 1.2 | 40% | 2.46 | 575/3/60 | 29 | 35 | | CARRIER 48HCE14 | 2000± | C/W HIGH STAGE HEATING |
| HVAC-4 | PACKAGED ROOFTOP HVAC | WT | 20 | 8530 | GAS | 525 | 256 | 1.2 | 40% | 5.92 | 575/3/60 | 54 | 60 | | CARRIER 48A3T020 | 4900± | C/W HIGH STAGE HEATING |
| HVAC-5 | PACKAGED ROOFTOP HVAC | WT | 20 | 8275 | GAS | 525 | 256 | 1.2 | 40% | 5.68 | 575/3/60 | 54 | 60 | | CARRIER 48A3T020 | 4900± | C/W HIGH STAGE HEATING |
| HVAC-7 | PACKAGED ROOFTOP HVAC | WT | 6 | 2000 | GAS | 125 | 72.0 | 1.2 | 40% | 1.74 | 575/3/60 | 18 | 20 | | CARRIER 48HCE07 | 1200± | C/W MEDIUM STAGE HEATING |

GENERAL HVAC UNIT NOTES:

1. ACCEPTABLE MANUFACTURERS: CARRIER, LENNOX, TRANE

2. UNITS HAVE 2 STAGE NATURAL GAS HEAT, 2 STAGE DX COOLING PLUS ECONOMIZER (1 STAGE ON SMALLER UNITS), BELT DRIVE FANS

3. PROVIDE STANDARD ROOF CURB ADAPTER, STAINLESS STEEL GAS HEAT EXCHANGER, CONDENSER COIL GUARD, FLUE GAS EXTENSION, POWER EXHAUST, ECONOMIZER, ALL HOODS & INLET SCREENS, AND 2 SETS MERV 13 DISPOSABLE FILTERS, ELECTRICAL/MECHANICAL CONTROLS, PADLOCK LATCHES, AND PREMIUM EFFICIENCY MOTORS.

4. CONTROLS: SYSTEM CONTROLS BY BAS CONTRACTOR, PROVIDE INTEGRAL CONTROLLER MATCHED TO BAS MANUFACTURER.

ERV SCHEDULE

| Item | Type | Supply Air | | | Exhaust Air | | | Air Temp Off Heat Exchanger | | | | Electrical | | Manufacturer | Model | Unit Weight lbs | Remarks | | | | |
|-------|------------------------------------|------------|----------|--------|-------------|----------|--------|-----------------------------|-----------|-----------|-----------|------------|---------|--------------|-------|-----------------|----------|-------|-------|-------|--|
| | | CFM | ESP w.g. | Fan hp | CFM | ESP w.g. | Fan hp | Summer DB | Winter DB | Summer WB | Winter WB | MCA | Voltage | | | | | | | | |
| ERV-1 | OUTDOOR ENERGY RECOVERY VENTILATOR | 2000 | 0.375 | 1.5 | 3050 | 0.375 | 3.0 | 75.0 | 63.0 | 72.0 | 56.0 | 76.1 | 64.4 | 65.9 | 52.0 | 16.9 | 575/3/60 | ALDES | PH40e | 1800± | C/W 24" HIGH ROOF CURB, BOTTOM INLET & DISCHARGE, MOTORS RATED FOR VFD |
| ERV-2 | OUTDOOR ENERGY RECOVERY VENTILATOR | 1470 | 0.375 | 0.75 | 2270 | 0.375 | 1.5 | 75.0 | 63.0 | 72.0 | 56.0 | 75.9 | 64.2 | 66.9 | 52.6 | 11.3 | 575/3/60 | ALDES | PH30e | 1600± | C/W 24" HIGH ROOF CURB, BOTTOM INLET & DISCHARGE, MOTORS RATED FOR VFD |

GENERAL ERV UNIT NOTES:

1. ACCEPTABLE MANUFACTURERS: ALDES, GREENHECK, RUSKIN, COOK

2. 24" HIGH INSULATED ROOF CURB, DEFROST CYCLE AND CONTROLS, FILTERS (MERV 13), MIXED AIR SECTION, AND PADLOCK LATCHES AND EXHAUST ONLY DEFROST CYCLE

3. CONTROLS: SYSTEM CONTROLS BY BAS CONTRACTOR, PROVIDE INTEGRAL CONTROLLER MATCHED TO BAS MANUFACTURER.

HEATING VENTILATION UNIT SCHEDULE

*ESP IS EXTERNAL TO THE CABINET

| Item | Type | Service | Capacity (cfm) | Size hp | Supply Air Fan Data Drive | ESP (in. wc) | Voltage | Electrical MCA | MOCP | Heating Capacity MBH | Manufacturer And Model | Weight lbs | Remarks |
|------|------------------------------|-----------|-------------------|------------|------------------------------|-----------------|----------|-------------------|------|----------------------------|---------------------------|---------------------------------|---------|
| HV-1 | OUTDOOR AIR HANDLING UNIT | GYMNASIUM | 6655 | 5 | VARIABLE FREQUENCY DRIVE | 1.0 | 575/3/60 | 12 | 15 | GAS | 300 | ENGINEERED AIR - D/E/AQ/C/NV | 2200± |

GENERAL HV UNIT NOTES:

1. ACCEPTABLE MANUFACTURERS: AAO, BOUSQUET, EH PRICE, VALENT, AND DAIKIN

2. UNITS HAVE 2 STAGE NATURAL GAS HEAT


3. PROVIDE STANDARD ROOF CURB ADAPTER, STAINLESS STEEL GAS HEAT EXCHANGER, FLUE GAS EXTENSION, ECONOMIZER, ALL HOODS & INLET SCREENS, AND 2 SETS MERV 13 DISPOSABLE FILTERS, ELECTRICAL/MECHANICAL CONTROLS, PADLOCK LATCHES, AND PREMIUM EFFICIENCY MOTORS.

4. CONTROLS: SYSTEM CONTROLS BY BAS CONTRACTOR, PROVIDE INTEGRAL CONTROLLER MATCHED TO BAS MANUFACTURER.

FAN SCHEDULE

| Item | Type | Service | Exhaust Air Data Capacity cfm | Size hp | SP in. wc | Voltage | Manufacturer | Model | Remarks |
|--------|-------------------------|---------------------|-------------------------------------|------------|--------------|----------|---------------|-------|---|
| * EF-2 | ROOF MOUNTED EXHAUST | WASHROOM EXHAUST | 800 | 1/3 | HP 0.625 | 120/1/60 | PENN BARRY | DX16S | C/W ADAPTER CURB AND BACKDRAFT DAMPER. DVR BY BAS CONTRACTOR |
| * EF-3 | ROOF MOUNTED EXHAUST | WASHROOM EXHAUST | 800 | 1/3 | HP 0.625 | 120/1/60 | PENN BARRY | DX16S | C/W ADAPTER CURB AND BACKDRAFT DAMPER. DVR BY BAS CONTRACTOR |
| * EF-4 | ROOF MOUNTED EXHAUST | WASHROOM EXHAUST | 250 | Fhp | 0.625 | 120/1/60 | PENN BARRY | DX10R | C/W ADAPTER CURB AND BACKDRAFT DAMPER. DVR BY BAS CONTRACTOR |

* ITEMIZED PRICE REFER TO SPECIFICATION

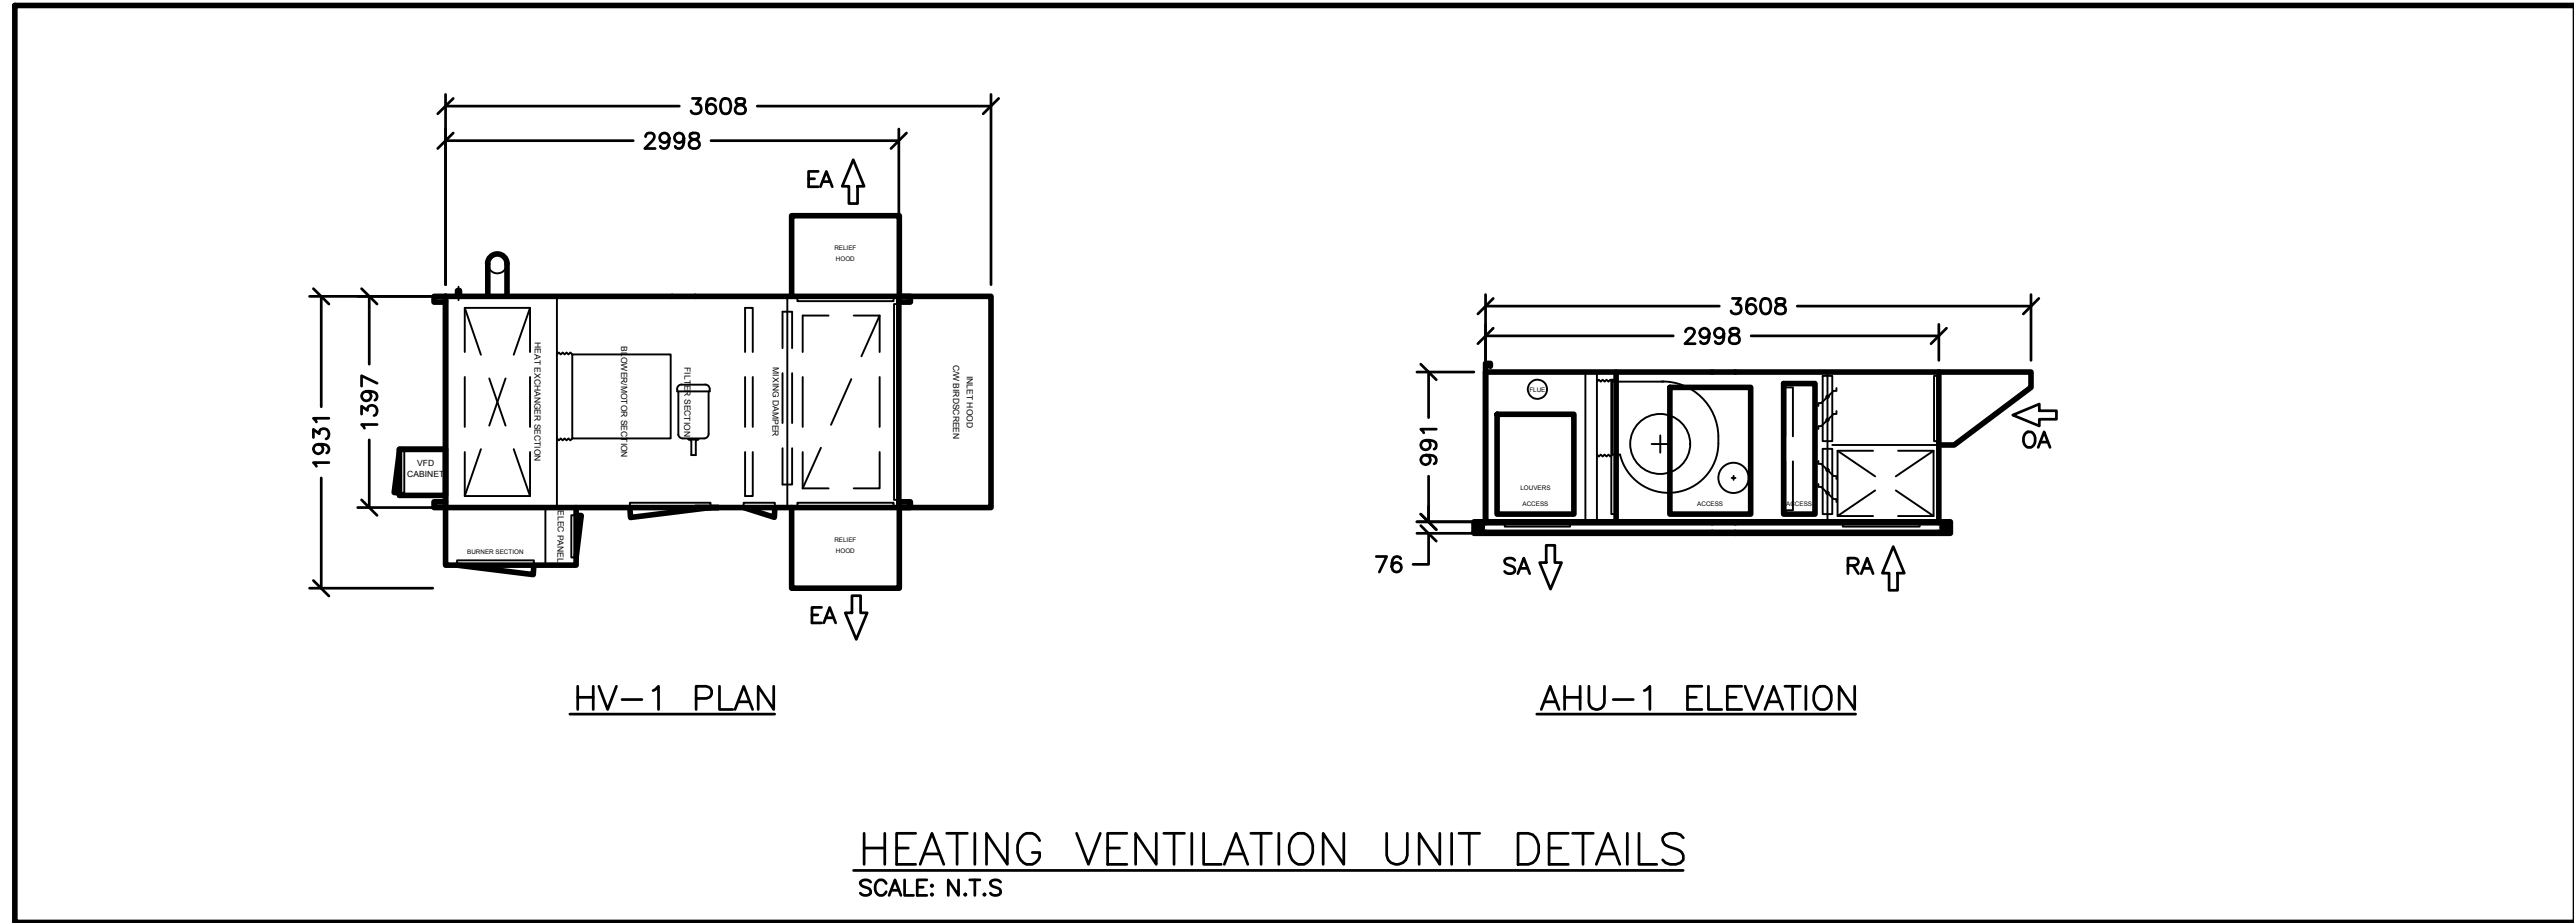

MECHANICAL LEGEND

| Item | Description | Item | Description |
|------|--|------|--------------------------------------|
| | CUT EXISTING & CONNECT NEW PIPING | | TEE CONNECTION |
| | VENT PIPING | | PIPE DOWN |
| | NATURAL GAS PIPING | | PIPE UP |
| | HIGH PRESSURE NATURAL GAS PIPING | | FLEXIBLE CONNECTION |
| | PRESSURE REDUCING VALVE | | REDUCER/INCREASER |
| | THERMOSTAT (WITH OR WITHOUT GUARD) | | UNION |
| | CARBON DIOXIDE (CO2) SENSOR (WITH OR WITHOUT GUARD) | | STRAINER |
| | SUPPLY AIR DUCT | | SCREWED OR WELDED PIPE CAP |
| | RETURN/EXHAUST AIR DUCT | | PLUG VALVE |
| | ACOUSTIC DUCT LINING | | BALL VALVE |
| | BALANCING DAMPER | | RISER VALVE |
| | OPPOSED BLADE DAMPER | | EXISTING DUCT (SIZE AS INDICATED) |
| | MOTORIZED DAMPER (OPPOSED BLADE) | | ABOVE FINISHED FLOOR |
| | FIRE DAMPER | | ABOVE FINISHED ROOF |
| | DIFFUSER/GRILLE SIZE (imp., TYPE & CAPACITY (cfm)) | | COMBINATION FIRE/SMOKE DAMPER |
| | SPRINKLER PIPING | | SMOKE DAMPER |

- GENERAL NOTES
- ALL DRAWINGS ARE TO BE READ IN CONJUNCTION WITH THE PREPARED SPECIFICATION.

• ALL PIPING, DUCTWORK, AND EQUIPMENT IS TO BE RESTRAINED TO MEET SEISMIC CODE REQUIREMENTS. SUPPLY AND INSTALL ALL SEISMIC RESTRAINT MATERIALS TO MANUFACTURER'S WRITTEN INSTRUCTIONS. REFER TO SPECIFICATION.

• UPON COMPLETION OF THE PROJECT OR UPON COMPLETION OF EACH INDIVIDUAL PHASE OF THE PROJECT THE CONTRACTORS SHALL PROVIDE THE FOLLOWING CERTIFICATES BEFORE CONFORMANCE LETTERS ARE ISSUED BY THE CONSULTANT:
 - COPY OF MANDATORY TSSA/CSA-B149 GAS PRESSURE TEST TAG
 - NFPA-13 SPRINKLER CONTRACTOR'S MATERIAL & TEST CERTIFICATE
 - FIRE PROTECTION ENGINEER'S INSPECTION/CONFORMANCE LETTER

ALL CERTIFICATES ARE TO BE SUBMITTED TOGETHER IN A SINGLE PACKAGE.

The contractor shall verify all dimensions and report all errors and discrepancies to the Consultant before commencement of the work. The drawings show general arrangement of services. Allow for future or actual building construction with permit. Obtain approval of all services and equipment from Consultant before commencement of the work. The drawings do not indicate all details, fittings and connections which may be required. Provide specifications, etc., prepared and issued by the consultant are the property of the consultant and must be returned at the completion of the project. These documents are not to be copied or used without the consent of the consultant.
© 2022 DEI & Associates Inc.



2. ISSUED FOR TENDER/BP

1. TENDER READY

NO. DESCRIPTION DATE


03.11.22

03.01.22

DRAWINGS ARE NOT TO BE SCALED. CONTRACTOR MUST CHECK AND VERIFY ALL DIMENSIONS AND CONDITIONS ON THE PROJECT, AND MUST REPORT ANY DISCREPANCIES TO THE CONSULTANTS BEFORE PROCEEDING WITH THE WORK. THE USE OF THIS DRAWING OR PART THEREOF IS FORBIDDEN WITHOUT THE WRITTEN APPROVAL OF THE CONSULTANTS.

CERTIFICATE OF PRACTICE #4292

LAURELWOOD PS -
HVAC AND CONTROLS
UPGRADE

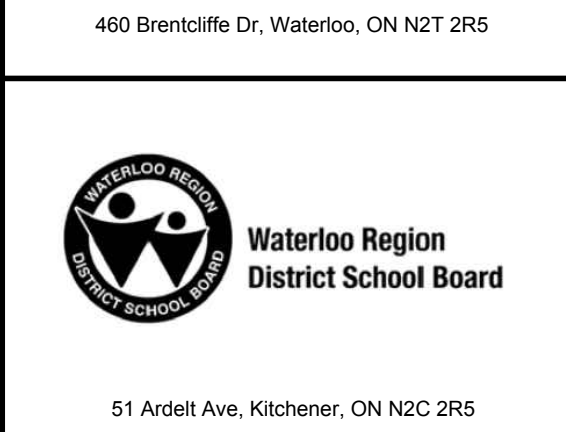

SCHEDULES,
LEGEND AND
DETAIL



SCALE

PROJECT

DATE

2/9/2021

DRAWN

AK

CHECKED

SO

PRINT DATE

REVIT FILE

21121A

DRAWING

M1.1




FIRST FLOOR PART PLAN A - DEMOLITION
SCALE: 1:100

GENERAL DEMOLITION NOTES


- EXISTING MECHANICAL ITEMS NOT SHOWN SHALL REMAIN UNLESS NOTED OTHERWISE.
- EXISTING MECHANICAL ITEMS SHOWN BUT NOT NOTED AS BEING REMOVED OR RENOVATED SHALL REMAIN AS PRESENTLY INSTALLED AND OPERATING.
- THIS CONTRACTOR SHALL BE RESPONSIBLE FOR VERIFYING ON SITE ALL LOCATIONS AND SIZES OF ALL SERVICES & EQUIPMENT PRIOR TO THE COMMENCEMENT OF WORK.
- ALL OPENINGS THAT RESULT FROM THE REMOVAL OF EQUIPMENT OR SERVICES SHALL BE NEATLY PATCHED WITH SUITABLE NEW MATERIALS TO SUIT EXISTING CONSTRUCTION.
- PLUMBING VENTS ARE NOT INDICATED OR IDENTIFIED. REMOVE ALL REDUNDANT VENTS WHILE MAINTAINING INTEGRITY OF EXISTING SYSTEMS TO REMAIN.
- REMOVAL OF EXISTING PIPING, OR DUCT SYSTEMS INCLUDES REMOVAL OF ALL HANGERS, INSULATION, FITTINGS, ETC.
- MAINTAIN INTEGRITY OF EXISTING SYSTEMS THAT ARE TO REMAIN OR BE MODIFIED.
- INSTALL NEW SYSTEM OR SERVICES WHERE REQUIRED TO MAINTAIN SYSTEM OPERATION PRIOR TO DEMOLITION OF EXISTING SERVICES.
- THIS CONTRACTOR IS TO REMOVE & REPLACE CEILING AS REQUIRED FOR REMOVAL/REPLACEMENT OF SERVICES.

SPECIFIC DEMOLITION NOTES

- EXISTING VVT DAMPER ACTUATOR AND CONTROL WIRING TO BE REMOVED COMPLETE.
- EXISTING THERMOSTAT/SENSOR TO BE REMOVED COMPLETE. REPLACE WITH NEW DDC THERMOSTAT/SENSOR.
- EXISTING SUPPLY AND RETURN DUCTWORK TO BE CUT ON RISER AND REMOVED UP TO EXISTING UNIT COMPLETE.
- EXISTING REHEAT COIL TO BE REMOVED COMPLETE. INFILL AND RECONNECT EXISTING DUCTWORK.

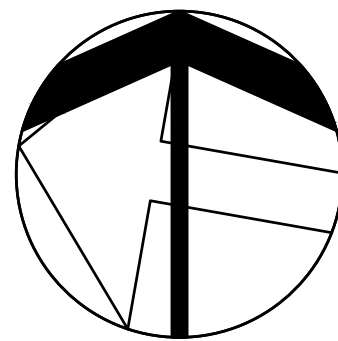

The contractor shall verify all dimensions and report of errors and omissions to the consultant before commencement of the work. The contractor shall also verify all dimensions and report of errors and omissions to the consultant before commencement of the work. The drawings are not to be used for any other purpose without the written approval of the consultant. The drawings are not to be used for any other purpose without the written approval of the consultant. The drawings are not to be used for any other purpose without the written approval of the consultant.

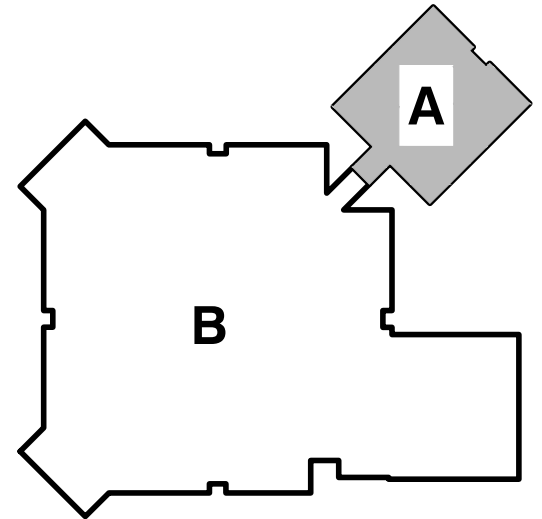

KEYPLAN



2. ISSUED FOR TENDER/BP 03.11.22
1. TENDER READY 03.01.22

NO. DESCRIPTION DATE
DRAWINGS ARE NOT TO BE SCALED. CONTRACTOR MUST CHECK AND VERIFY ALL DIMENSIONS AND CONDITIONS ON THE PROJECT, AND MUST REPORT ANY DISCREPANCIES TO THE CONSULTANTS BEFORE PROCEEDING WITH THE WORK. THE USE OF THIS DRAWING OR PART THEREOF IS FORBIDDEN WITHOUT THE WRITTEN APPROVAL OF THE CONSULTANTS.

CERTIFICATE OF PRACTICE #4292

LAURELWOOD PS -
HVAC AND CONTROLS
UPGRADE

460 Brentcliffe Dr. Waterloo, ON N2T 2R5



Waterloo Region
District School Board

51 Ardelt Ave, Kitchener, ON N2C 2R5


FIRST FLOOR PART
PLAN A - DEMOLITION

HOSSACK
& ASSOCIATES
ARCHITECTS



4-110-10000-0000
WATERLOO, ONTARIO L2L 0A8
TEL: 519-887-8888 FAX: 519-887-8889

| SCALE | PROJECT |
|------------------|---------|
| DATE 2/9/2021 | 21121A |
| DRAWN AK | DRAWING |
| CHECKED SO | M2.1 |
| PRINT DATE | |
| REVIT FILE | |

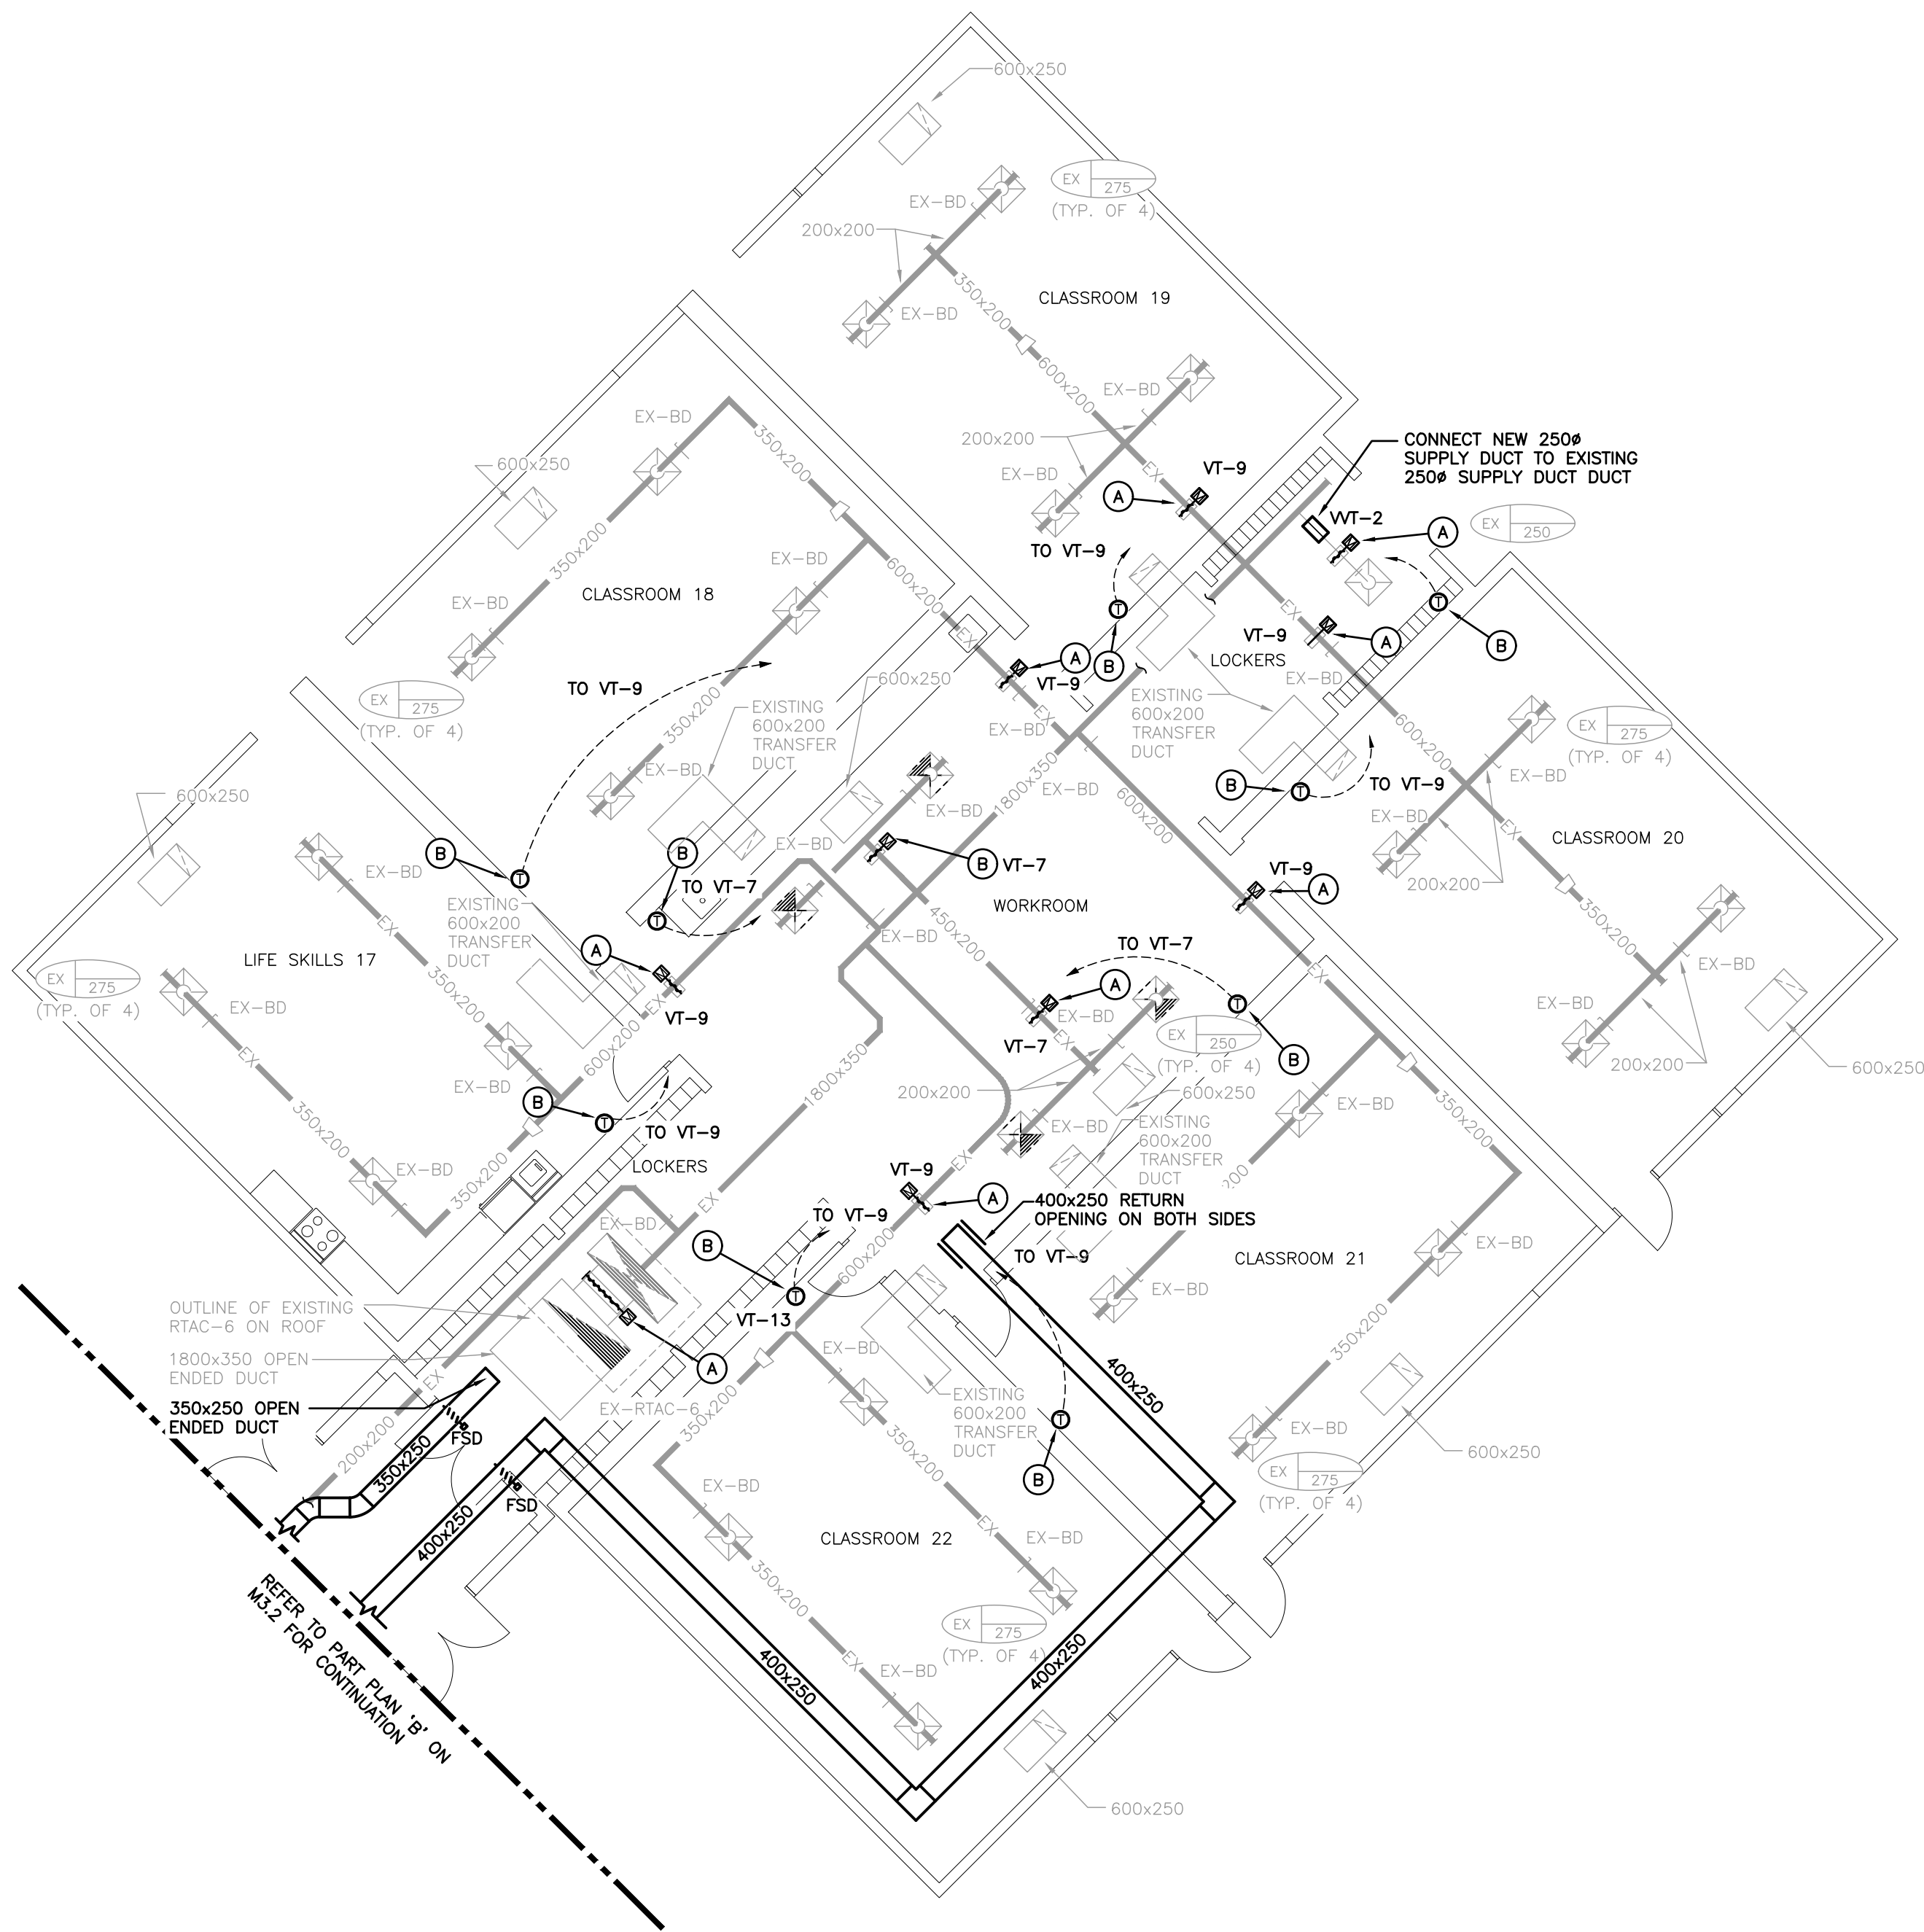











FIRST FLOOR PART PLAN A - RENOVATIONS
SCALE: 1:100

GENERAL RENOVATION NOTES



- PROVIDE VENTING FOR SANITARY FIXTURES TO OBC REQUIREMENTS. CO-ORDINATE VENTS THRU ROOF WITH GENERAL CONTRACTOR. MAINTAIN MINIMUM 3600MM (12'-0") BETWEEN SANITARY VENT AND ALL AIR INTAKE/EXHAUST OPENINGS.
- CO-ORDINATE ANY OWSJ BRIDGING RELOCATION OR REMOVAL/REPLACEMENT WITH THE GENERAL CONTRACTOR. PAY ALL COSTS REQUIRED TO MODIFY BRIDGING FOR INSTALLATION OF DUCTWORK.
- THIS CONTRACTOR SHALL PROVIDE TIEWRAP TO WRAP 50 BUNDLES OF EXISTING LOOSE WIRES IN THE EXISTING CORRIDOR CEILING ON EACH FLOOR. REFER TO DEMOLITION DRAWINGS FOR EXTENT OF EXISTING PIPING ABOVE CEILINGS TO REMAIN.
- NOT ALL EXISTING PIPING, DUCTWORK, WIRING, ETC. IS INDICATED. IT IS THE RESPONSIBILITY OF THIS CONTRACTOR TO REVIEW ALL EXISTING CONDITIONS ON SITE AND MAKE SURE ALL PIPING, DUCTWORK, WIRING, ETC. CAN BE INSTALLED AS INDICATED PRIOR TO SUBMITTING TENDER PRICE.

SPECIFIC RENOVATION NOTES

- PROVIDE NEW MOTORIZED DAMPER ACTUATOR AND CONTROL WIRING.
- NEW DDC THERMOSTAT/SENSOR. PROVIDE NEW CONTROL WIRING. FISH EXISTING WALL AS REQUIRED FOR NEW CONTROL WIRING.
- INSTALL CO₂ SENSOR IN RETURN DUCT.

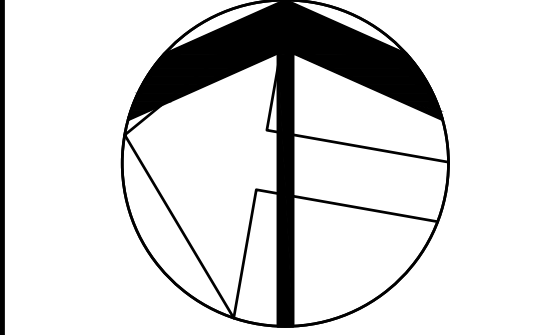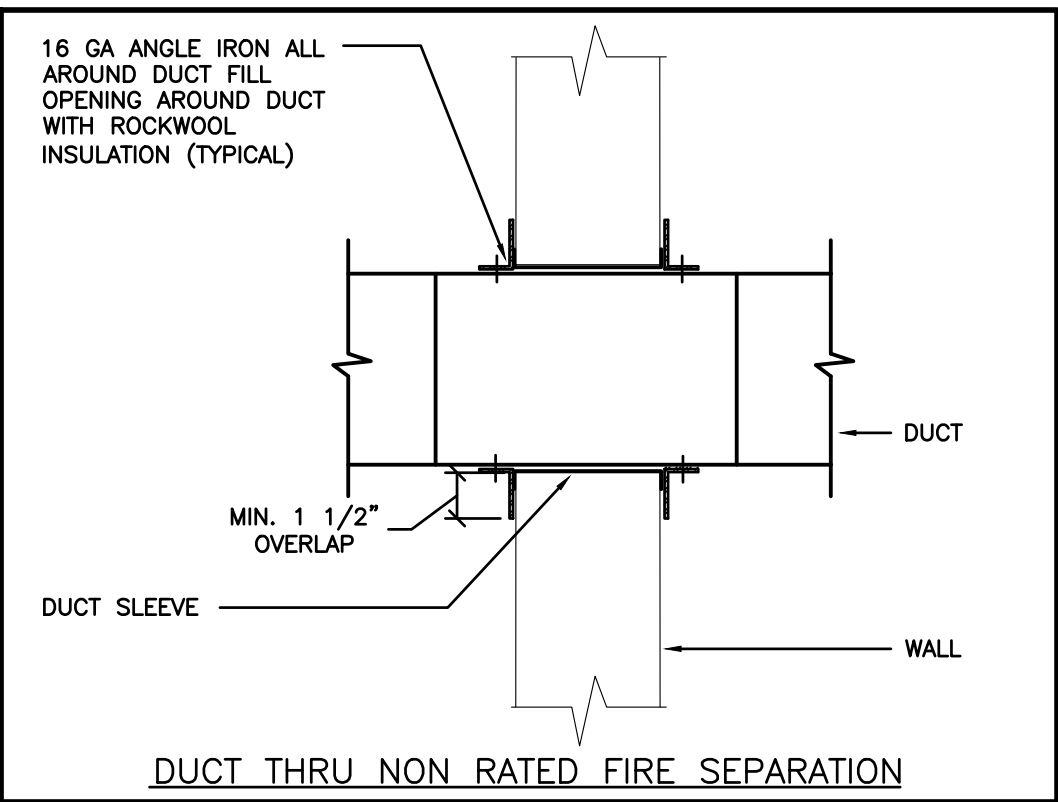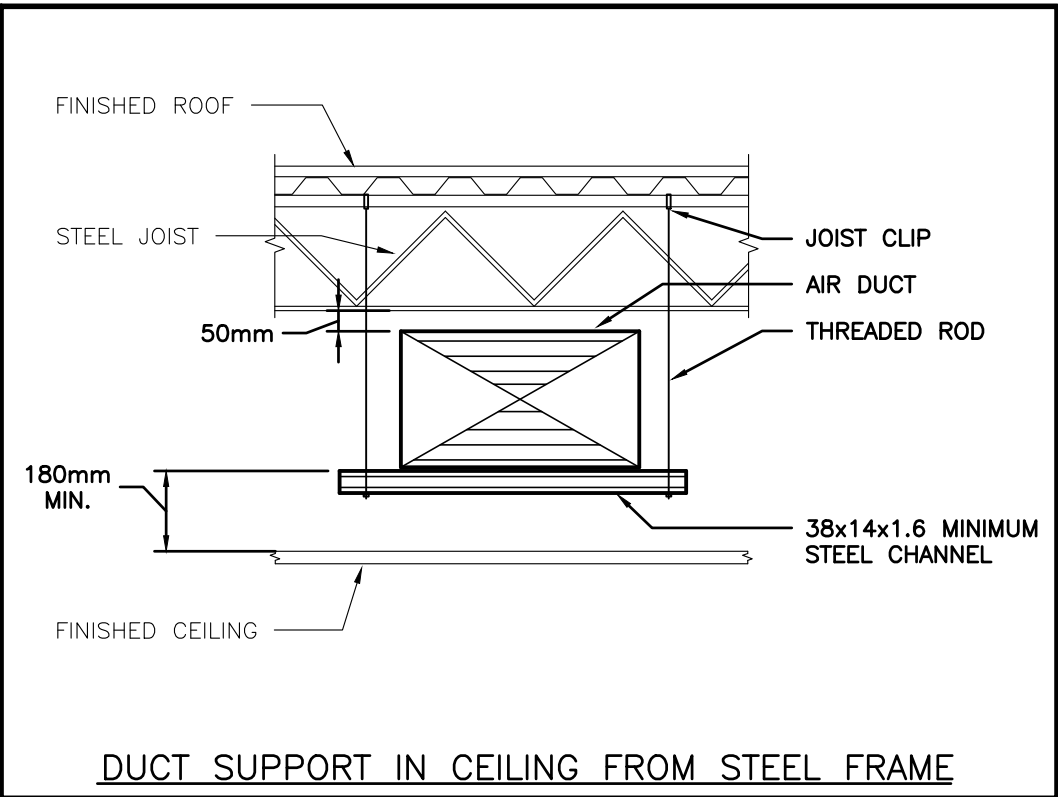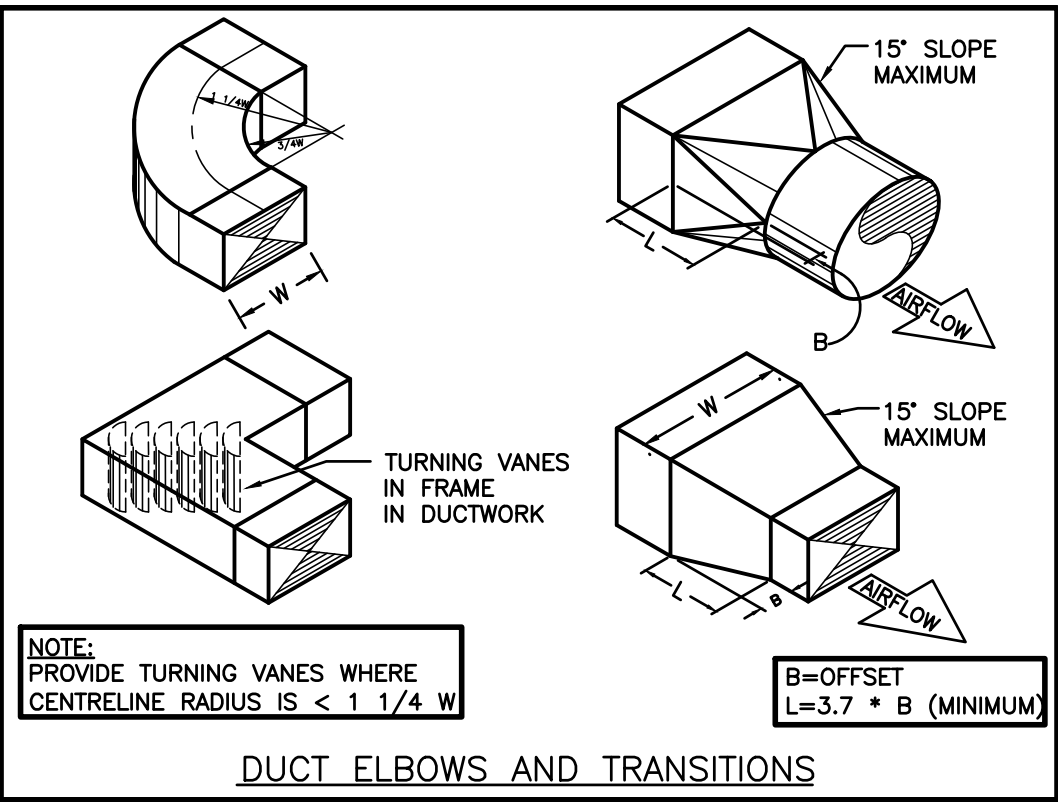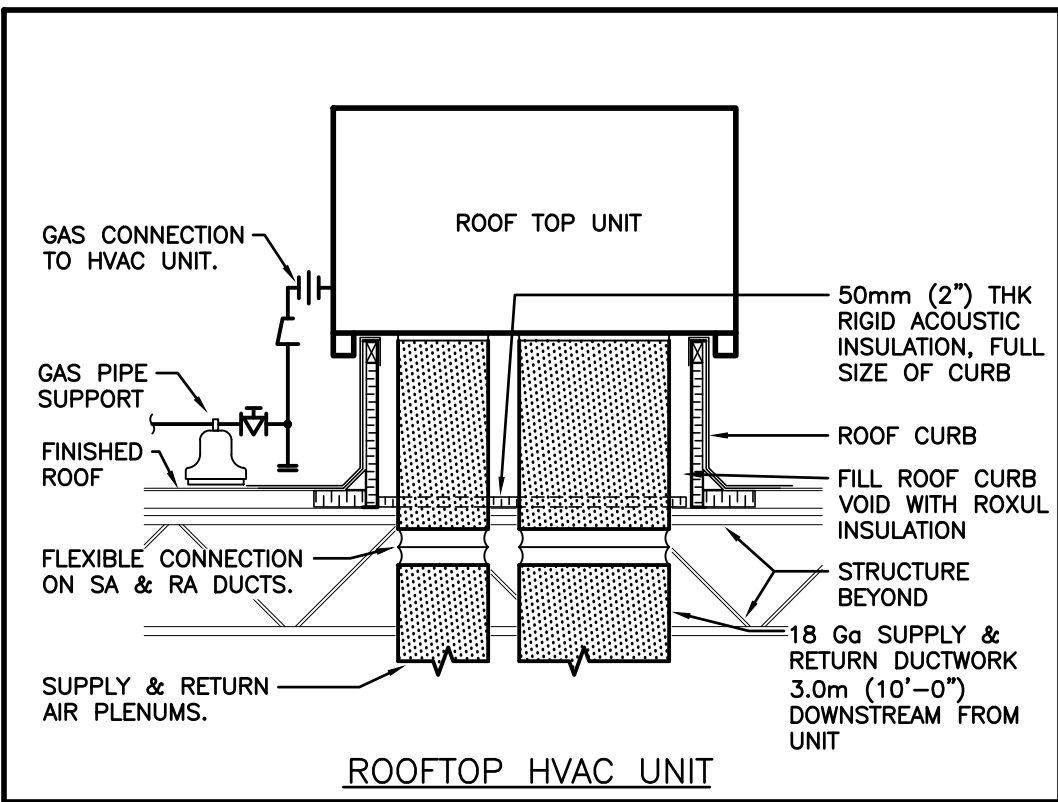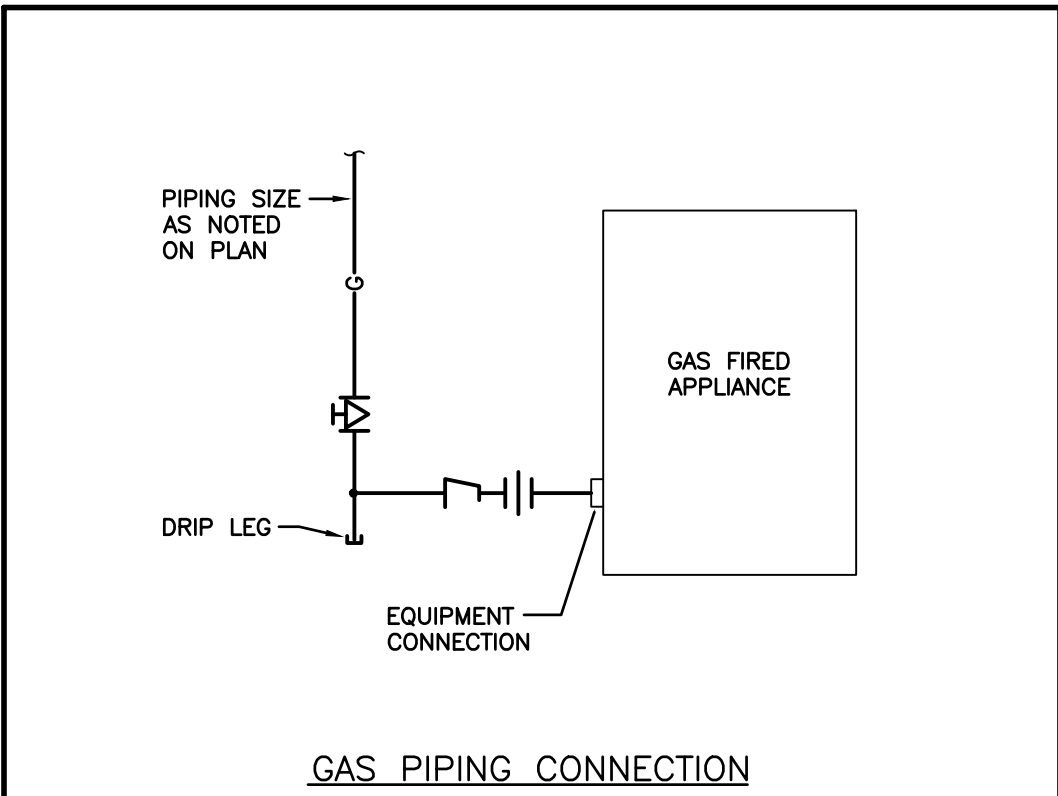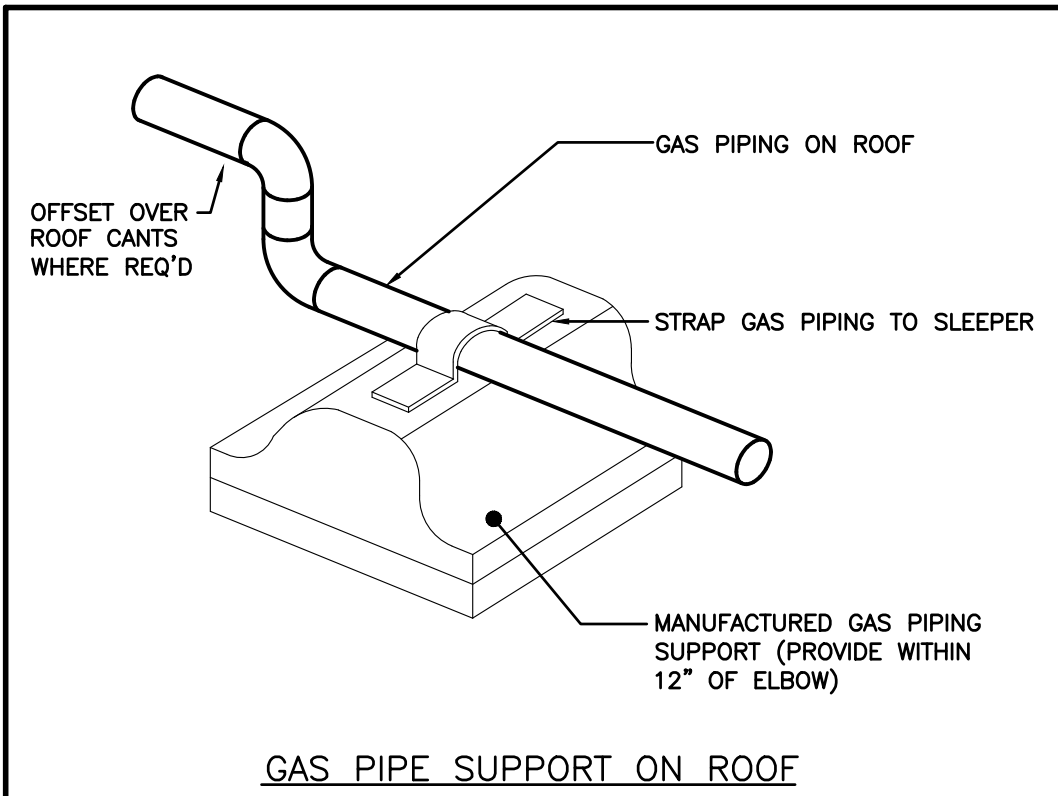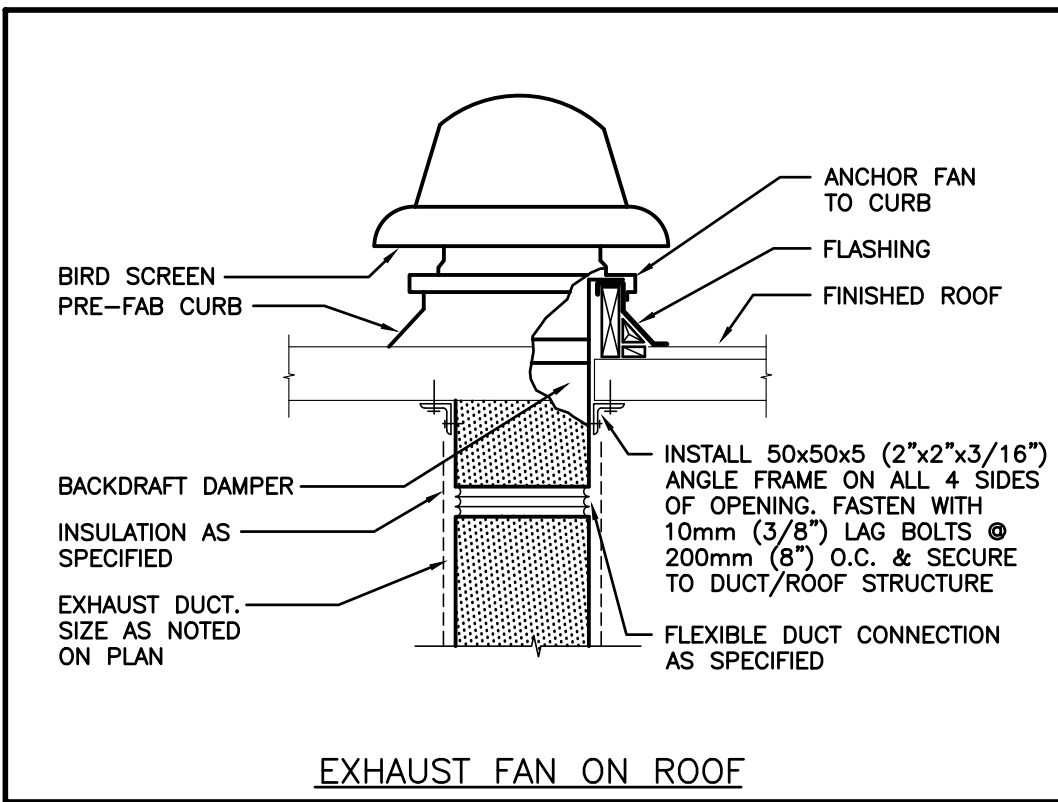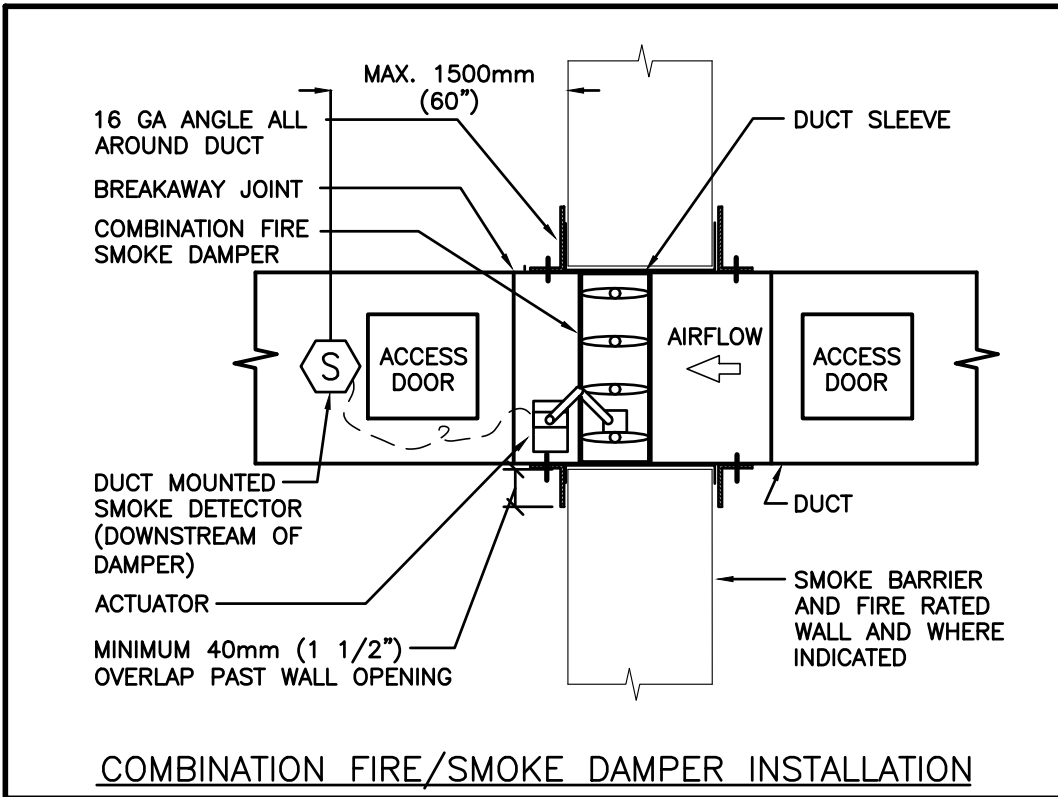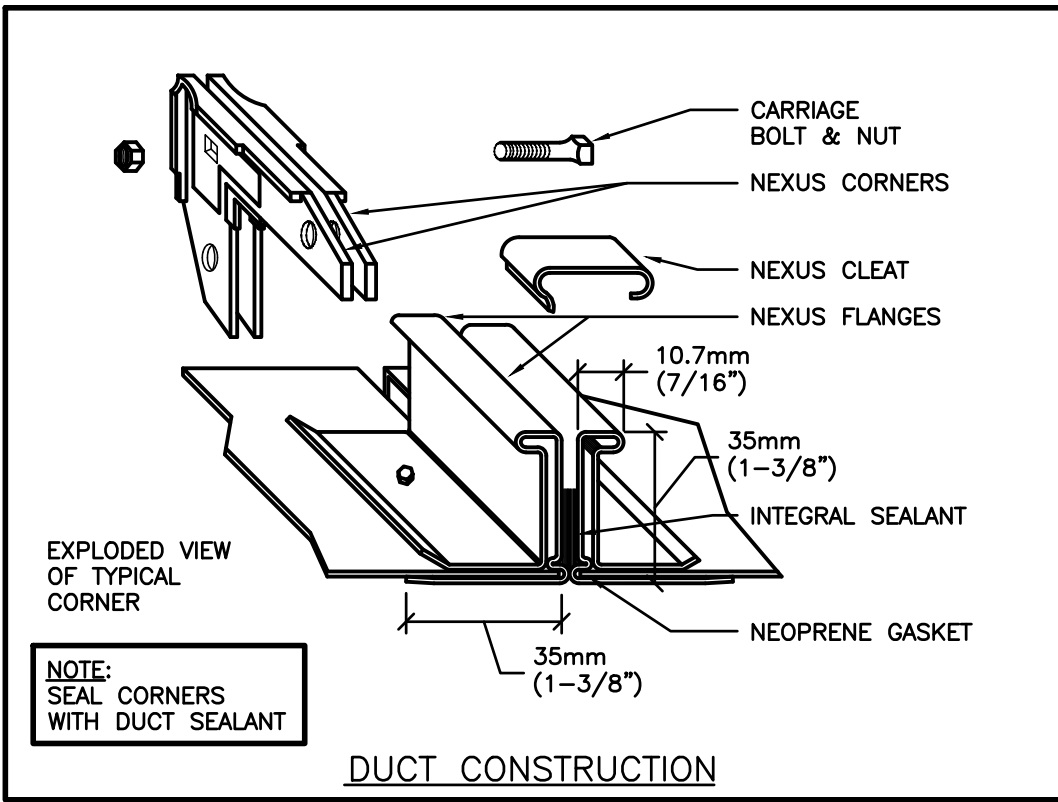

The contractor shall verify all dimensions and report of errors and omissions to the consultant before commencement of the work. The consultant shall verify all dimensions and report of errors and omissions to the consultant before commencement of the work. The consultant shall verify all dimensions and report of errors and omissions to the consultant before commencement of the work. The consultant shall verify all dimensions and report of errors and omissions to the consultant before commencement of the work.

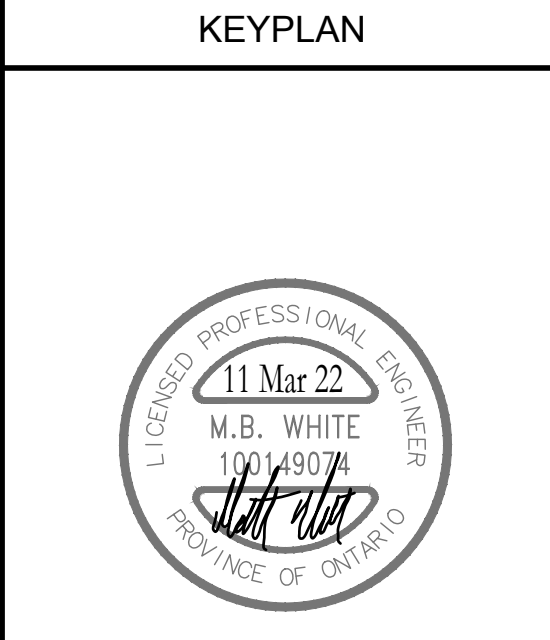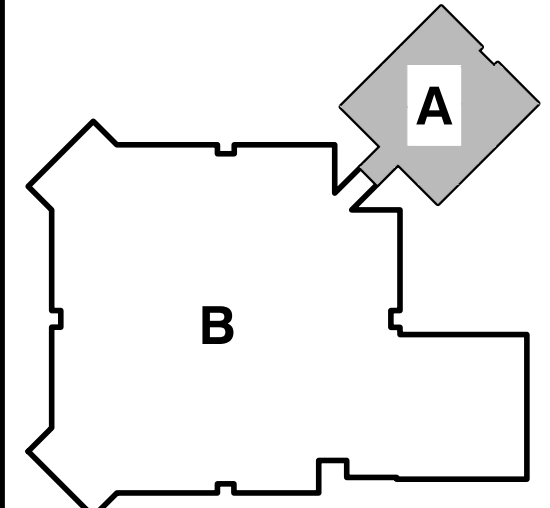

| NO. | DESCRIPTION | DATE |
|-----|----------------------|----------|
| 2. | ISSUED FOR TENDER/BP | 03.11.22 |
| 1. | TENDER READY | 03.01.22 |

DRAWINGS ARE NOT TO BE SCALED. CONTRACTOR MUST CHECK AND VERIFY ALL DIMENSIONS AND CONDITIONS ON THE PROJECT, AND MUST REPORT ANY DISCREPANCIES TO THE CONSULTANTS BEFORE PROCEEDING WITH THE WORK. THE USE OF THIS DRAWING OR PART THEREOF IS FORBIDDEN WITHOUT THE WRITTEN APPROVAL OF THE CONSULTANTS.

CERTIFICATE OF PRACTICE #4292

LAURELWOOD PS - HVAC AND CONTROLS UPGRADE


460 Brentcliffe Dr, Waterloo, ON N2T 2R5



FIRST FLOOR PART PLAN A - RENOVATION AND DETAILS



| SCALE | PROJECT |
|------------|---------|
| DATE | 21121A |
| 2/9/2021 | |
| DRAWN | AK |
| CHECKED | SO |
| PRINT DATE | |
| REVIT FILE | |

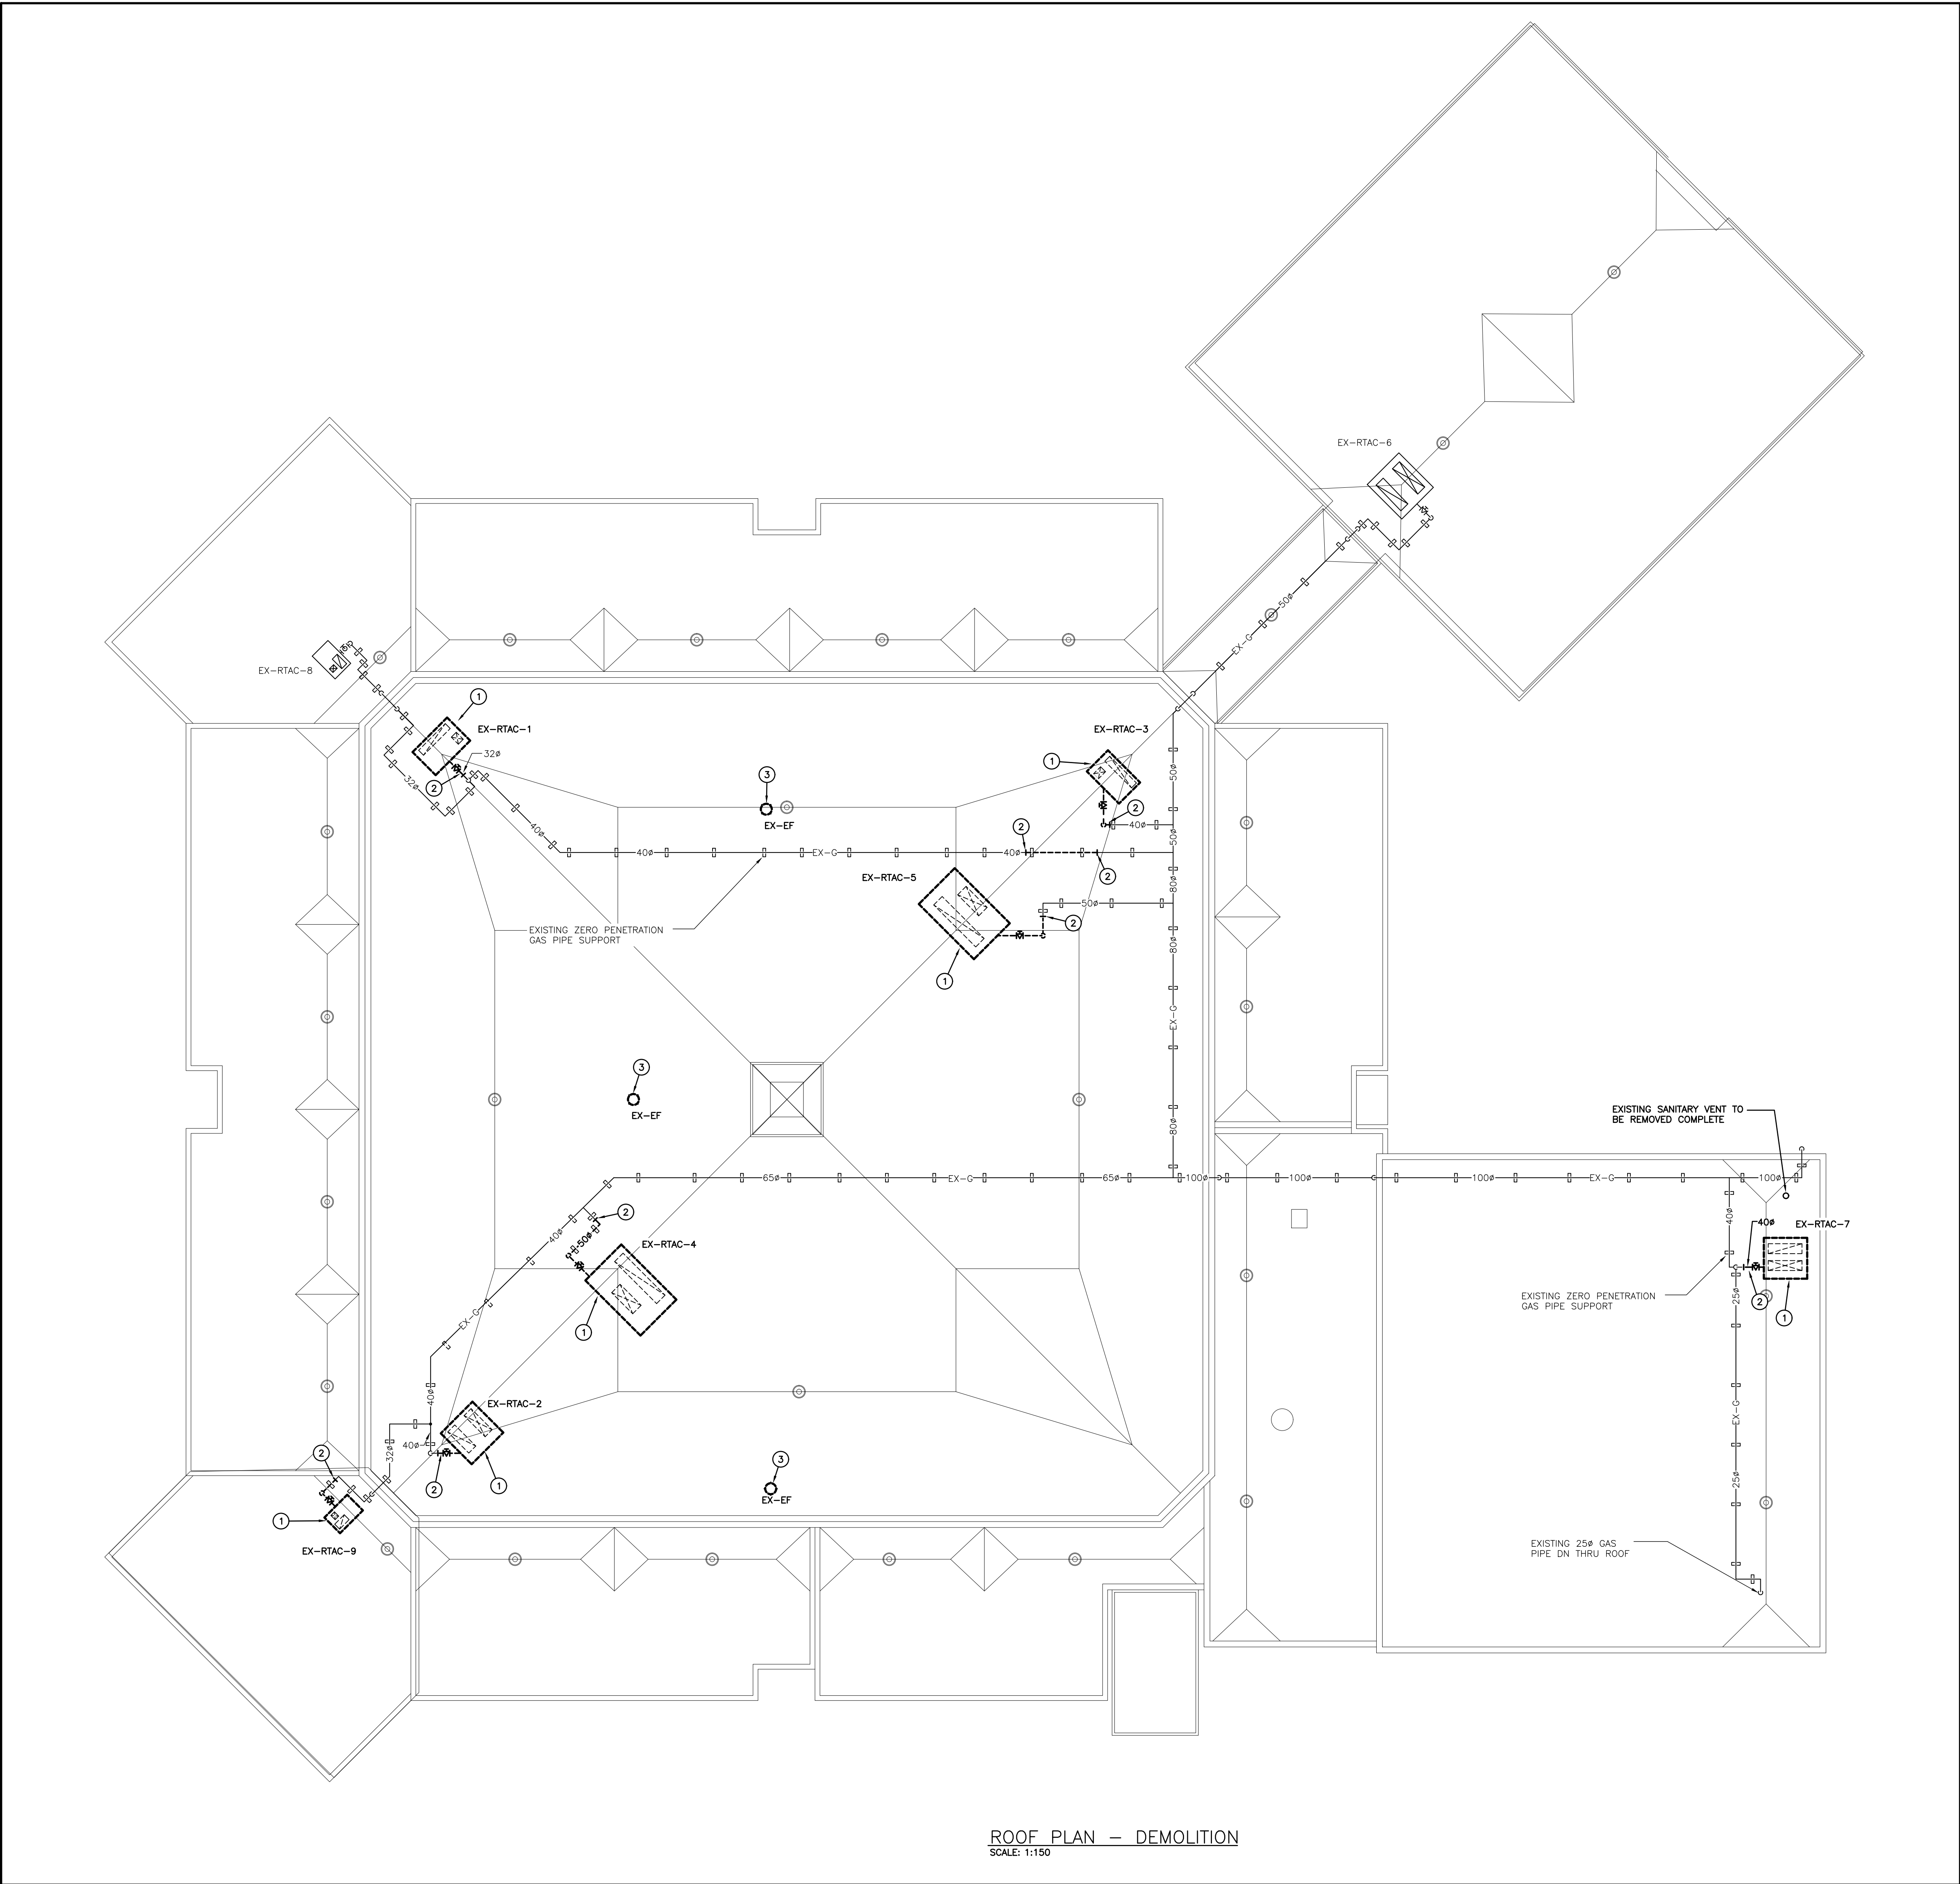


ROOF PLAN - DEMOLITION
SCALE: 1:150

GENERAL DEMOLITION NOTES


- EXISTING MECHANICAL ITEMS NOT SHOWN SHALL REMAIN UNLESS NOTED OTHERWISE.
- EXISTING MECHANICAL ITEMS SHOWN BUT NOT NOTED AS BEING REMOVED OR RENOVATED SHALL REMAIN AS PRESENTLY INSTALLED AND OPERATING.
- THIS CONTRACTOR SHALL BE RESPONSIBLE FOR VERIFYING ON SITE ALL LOCATIONS AND SIZES OF ALL SERVICES & EQUIPMENT PRIOR TO THE COMMENCEMENT OF WORK.
- ALL OPENINGS THAT RESULT FROM THE REMOVAL OF EQUIPMENT OR SERVICES SHALL BE NEATLY PATCHED WITH SUITABLE NEW MATERIALS TO SUIT EXISTING CONSTRUCTION.
- REMOVAL OF EXISTING PIPING, OR DUCT SYSTEMS INCLUDES REMOVAL OF ALL HANGERS, INSULATION, FITTINGS, ETC.
- MAINTAIN INTEGRITY OF EXISTING SYSTEMS THAT ARE TO REMAIN OR BE MODIFIED.
- INSTALL NEW SYSTEM OR SERVICES WHERE REQUIRED TO MAINTAIN SYSTEM OPERATION PRIOR TO DEMOLITION OF EXISTING SERVICES.
- THIS CONTRACTOR IS TO REMOVE & REPLACE CEILINGS AS REQUIRED FOR REMOVAL/REPLACEMENT OF SERVICES.

SPECIFIC DEMOLITION NOTES

- EXISTING HVAC UNIT TO BE DISCONNECTED AND REMOVED COMPLETE.
- EXISTING GAS PIPING TO BE CUT AND REMOVED COMPLETE. REPLACE EXISTING ISOLATION VALVE WITH NEW.
- EXISTING EXHAUST FAN TO BE REMOVED COMPLETE. EXISTING ROOF CURB TO REMAIN FOR INSTALLATION OF NEW EXHAUST FAN MODIFY EXISTING DUCTWORK AS REQUIRED TO SUIT DUCT CONNECTION TO NEW EXHAUST FAN.

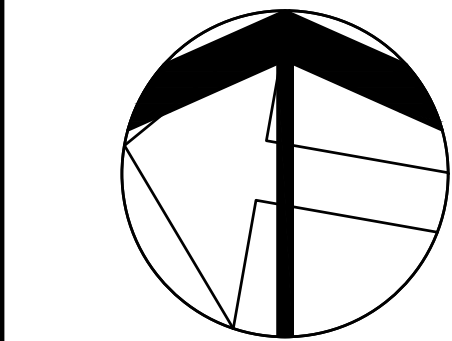

The contractor shall verify all dimensions and report all errors and discrepancies to the Consultant before commencement of the work. The contractor shall be responsible for verifying on site all locations and sizes of all services & equipment prior to the commencement of work. The contractor shall be responsible for verifying on site all locations and sizes of all services & equipment prior to the commencement of work. The contractor shall be responsible for verifying on site all locations and sizes of all services & equipment prior to the commencement of work.

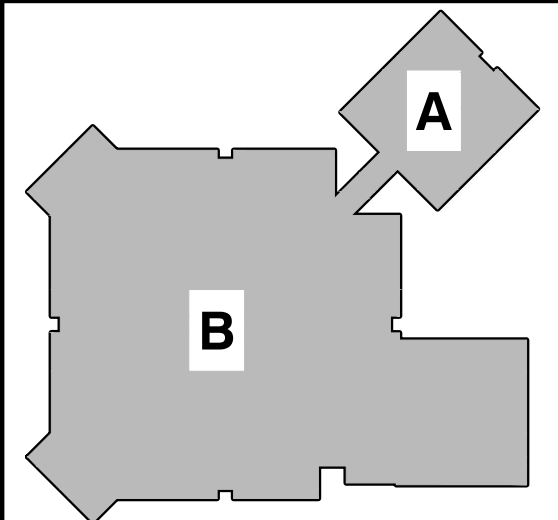

KEYPLAN



| | | |
|-----|----------------------|----------|
| 2. | ISSUED FOR TENDER/BP | 03.11.22 |
| 1. | TENDER READY | 03.01.22 |
| NO. | DESCRIPTION | DATE |

DRAWINGS ARE NOT TO BE SCALED. CONTRACTOR MUST CHECK AND VERIFY ALL DIMENSIONS AND CONDITIONS ON THE PROJECT, AND MUST REPORT ANY DISCREPANCIES TO THE CONSULTANTS BEFORE PROCEEDING WITH THE WORK. THE USE OF THIS DRAWING OR PART THEREOF IS FORBIDDEN WITHOUT THE WRITTEN APPROVAL OF THE CONSULTANTS.

CERTIFICATE OF PRACTICE #4292

LAURELWOOD PS -
HVAC AND CONTROLS
UPGRADE

460 Brentcliffe Dr, Waterloo, ON N2T 2R5




51 Ardelt Ave, Kitchener, ON N2C 2R5

ROOF PLAN -
DEMOLITION




| | |
|------------|---------|
| SCALE | PROJECT |
| DATE | 21121A |
| 2/9/2021 | |
| DRAWN | AK |
| CHECKED | SO |
| PRINT DATE | |
| REVIT FILE | |

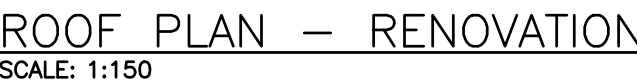

- MAINTAIN MINIMUM 3700MM (12'-0") LATERAL DISTANCE BETWEEN SANITARY VENTS AND ALL AIR INTAKE/EXHAUST OPENINGS.
- MAINTAIN MINIMUM 3000MM (10'-0") LATERAL DISTANCE BETWEEN PRV, FUEL FIRED APPLIANCE, AND/OR EXHAUST VENTS AND ALL AIR INTAKE/EXHAUST OPENINGS.
- ALL EQUIPMENT SHALL BE MINIMUM 3.0M FROM EDGE OF ROOF.


- A. INSTALL NEW HVAC UNIT ON EXISTING ROOF CURB COMPLETE WITH NEW ADAPTER CURB
- B. CONNECT NEW 2 1/2" GAS PIPING TO EXISTING 3 1/2" GAS PIPING COMPLETE WITH NEW ISOLATION VALVE.
- C. CONNECT NEW 3 1/2" GAS PIPING TO EXISTING 4 1/2" GAS PIPING COMPLETE WITH NEW ISOLATION VALVE.
- D. CONNECT NEW 5 1/2" GAS PIPING TO EXISTING 5 1/2" GAS PIPING COMPLETE WITH NEW ISOLATION VALVE.
- E. CONNECT NEW 3 1/2" GAS PIPING TO EXISTING 3 1/2" GAS PIPING COMPLETE WITH NEW ISOLATION VALVE.
- F. CONNECT NEW 4 1/2" HPG PIPING TO EXISTING 4 1/2" HPG PIPING COMPLETE WITH NEW ISOLATION VALVE.
- G. INSTALL NEW ERV UNIT ON NEW 600MM (24") ROOF CURB.
- H. CONNECT NEW EXHAUST FAN TO EXISTING DUCTWORK, C/W ADAPTER CURB

NOTE:
ALL EXISTING GAS PIPING SHALL BE
RE-LABELED WITH REVISED PRESSURE.
ALL EXISTING LABELS TO BE REMOVED.
PAINT ALL GAS PIPING WITH MINIMUM
TWO (2) COATS OF YELLOW PAINT

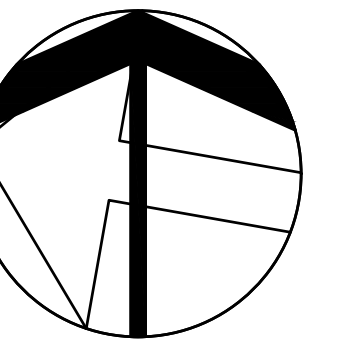


The contractor shall verify all dimensions and report all errors and discrepancies to the Consultant before commencement of the work. The drawings are for information only. The Contractor shall follow as closely as actual building construction will permit. Obtain approval for relocation of service from Consultant before commencement of the work. The drawings do not indicate all details. Fitting and assessment which may be required. Provide the same to meet the required conditions. Drawings and specifications, etc., prepared and issued by the consultant are the property of the consultant and must be returned at the completion of the project. These documents are not to be copied, reproduced or copied without the consent of the Consultant. Do not scale this drawing.

© 2022 DE & Associates Inc.

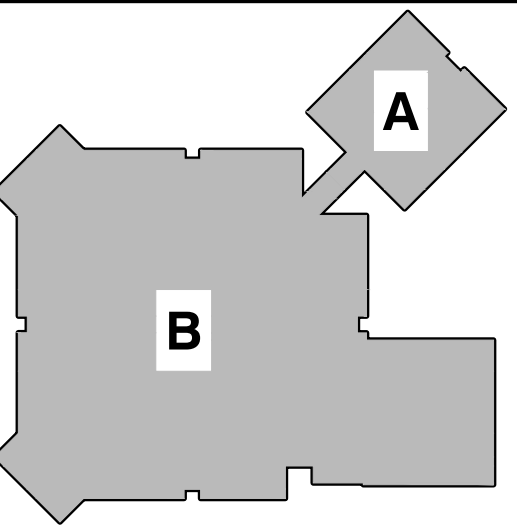

KEYPLAN

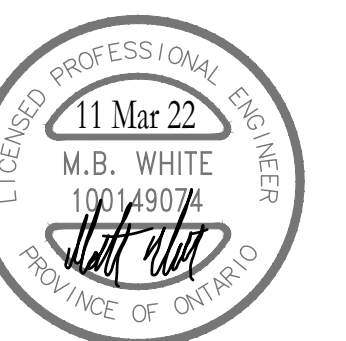

| | | |
|-----|----------------------|----------|
| 2. | ISSUED FOR TENDER/BP | 03.11.22 |
| 1. | TENDER READY | 03.01.22 |
| NO. | DESCRIPTION | DATE |

DRAWINGS ARE NOT TO BE SCALED. CONTRACTOR MUST CHECK AND VERIFY ALL DIMENSIONS AND CONDITIONS ON THE PROJECT; AND MUST REPORT ANY DISCREPANCIES TO THE CONSULTANTS BEFORE PROCEEDING WITH THE WORK. THE USE OF THIS DRAWING OR PART THEREOF IS FORBIDDEN WITHOUT THE WRITTEN APPROVAL OF THE CONSULTANTS.

CERTIFICATE OF PRACTICE #4292

LAURELWOOD PS -
HVAC AND CONTROLS
UPGRADE

60 Brentcliffe Dr, Waterloo, ON N2T 2R5


**Waterloo Region
District School Board**


51 Ardelt Ave, Kitchener, ON N2C 2R5

ROOF PLAN - RENOVATION


**HOSSACK
& ASSOCIATES
ARCHITECTS**

4-2150 DUNWYN DRIVE
MISSISSAUGA, ONTARIO L5L 5M8
Tel (905) 607-8284 Fax (905) 607-8290

| | | |
|------------------|---------|--------|
| SCALE | PROJECT | 21121A |
| DATE 2/9/2021 | | |
| DRAWN | DRAWING | M5.2 |
| AK | | |
| CHECKED | | |
| SO | | |
| PRINT DATE | | |
| REVIT FILE | | |

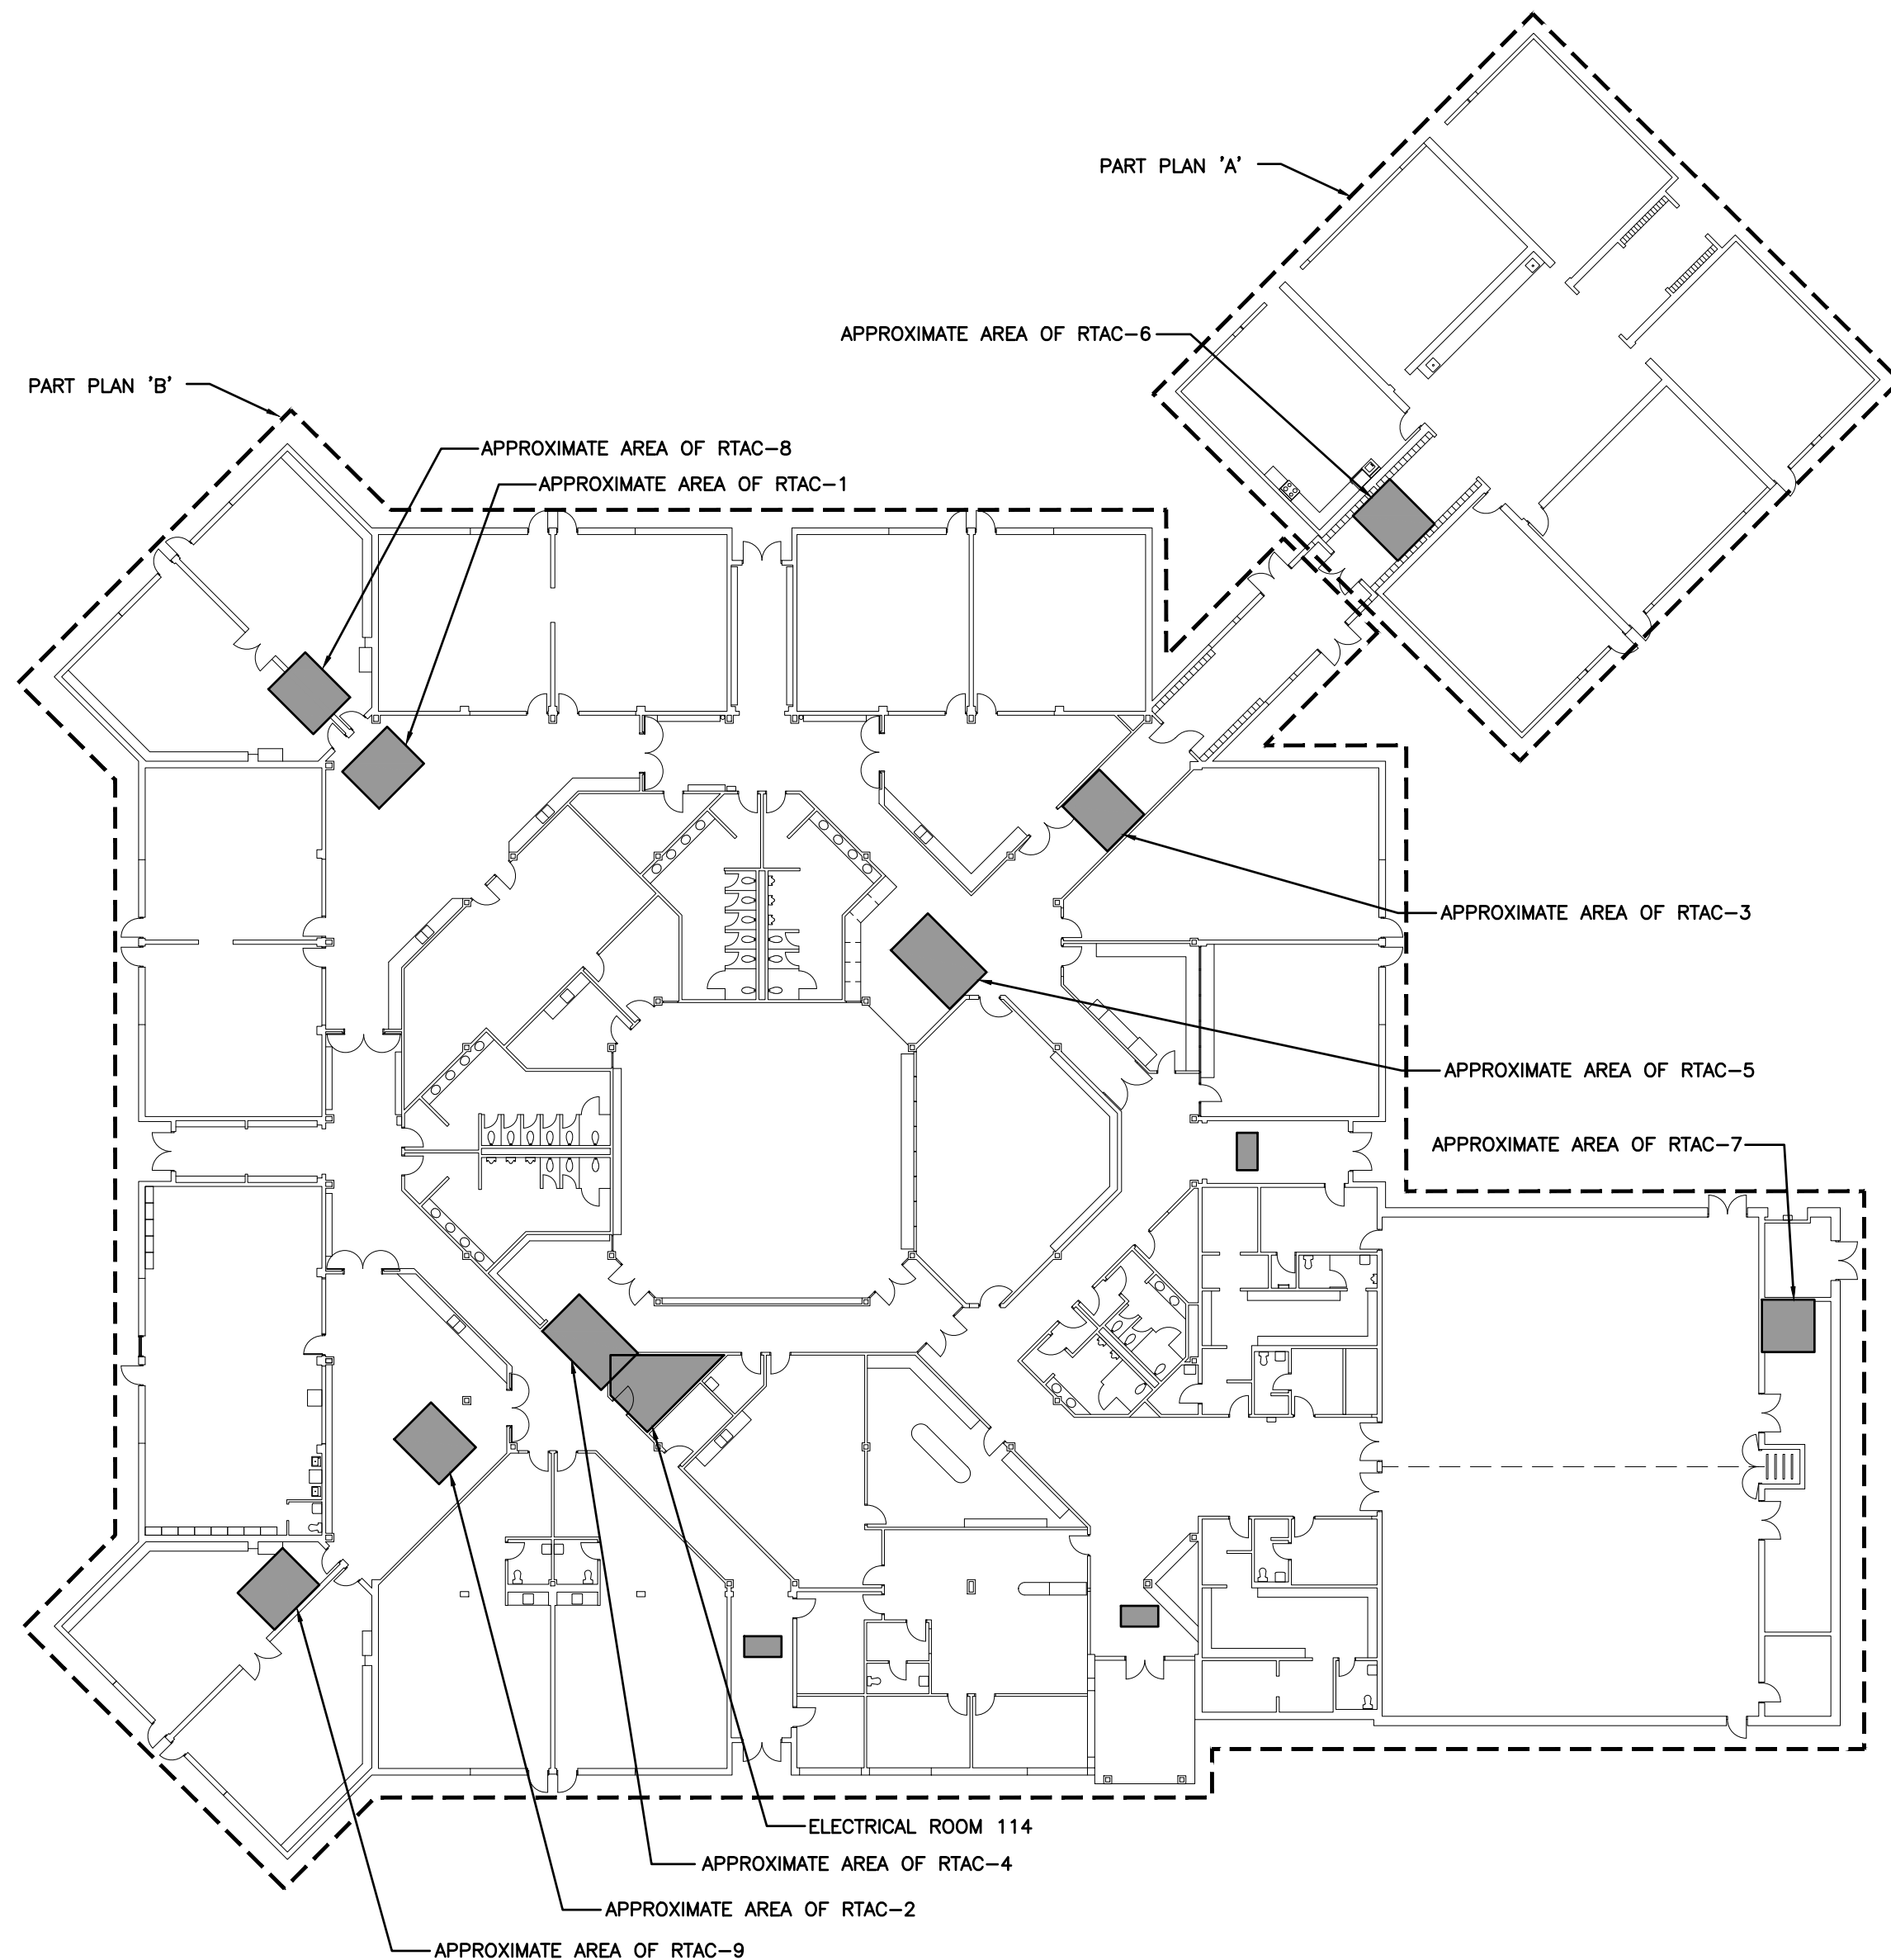

| ELECTRICAL SYMBOLS | | NOTE: ALL SYMBOLS MAY NOT BE USED | |
|---|--|-----------------------------------|---|
| POWER | | GENERAL | |
| | PANEL AS INDICATED | ER | INDICATES EXISTING ITEM TO REMAIN |
| | FUSED DISCONNECT | D | INDICATES EXISTING ITEM TO BE DELETED |
| | UNFUSED DISCONNECT | R | INDICATES EXISTING ITEM TO BE RELOCATED/IN RELOCATED POSITION |
| | JUNCTION BOX | GF | GROUND FAULT |
| | DIRECT CONNECTION | WP | WEATHERPROOF |
| STANDARD CIRCUITING LABELING | | | NOTE INDICATOR |
| POWER PANEL LABEL CIRCUIT INDICATION SWITCH LEG (IF APPLICABLE) | | | MECHANICAL ITEM NO. |
| ELECTRIC HEAT | | LIGHTING | |
| | FAN FORCED ELECTRIC HEATER (TYPE AS INDICATED) | | FLUORESCENT LIGHT FIXTURE TYPE AS INDICATED |

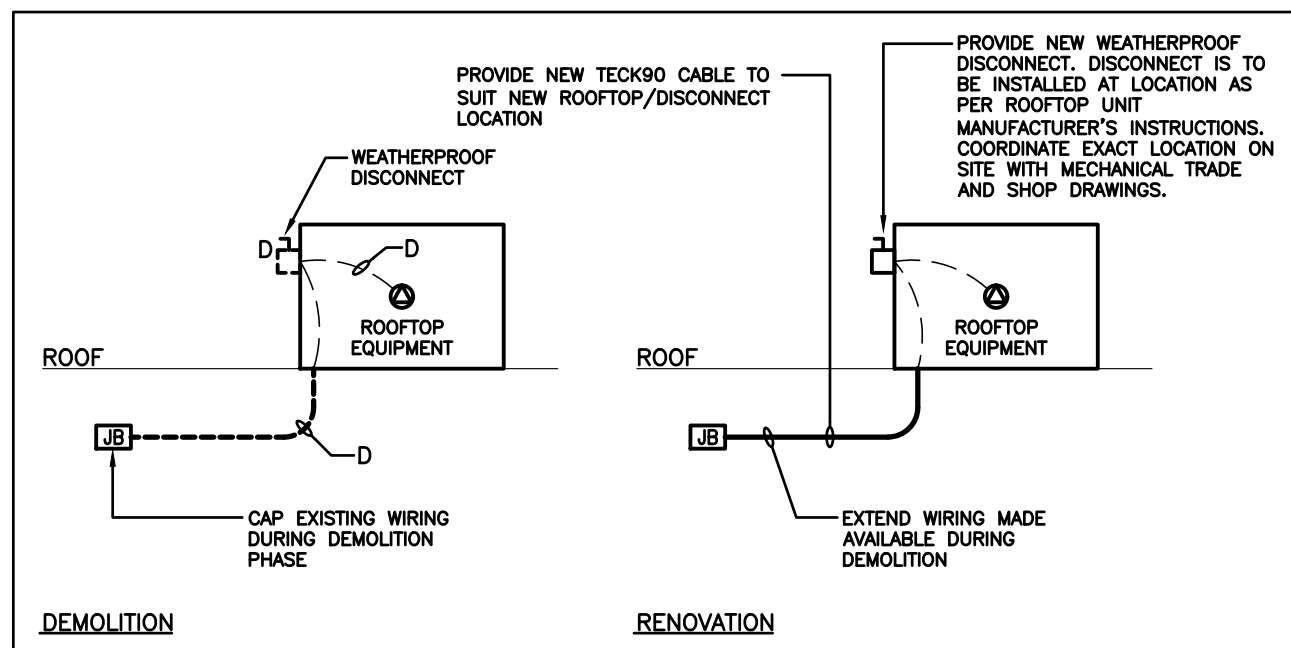

- NOTES:
- CONTRACTOR SHALL INCLUDE IN PRICING TO INSTALL NEW TECK90 CU CONDUCTORS FROM LOCAL JUNCTION BOX THROUGH ROOF CONE AS DETAILED.
 - INSTALLATION OF JUNCTION BOXES AND CONDUCTOR SPLICING ON ROOFTOP IS NOT AN ACCEPTABLE METHOD OF INSTALLATION. ALL SPLICING MUST BE COMPLETED WITH JUNCTION BOX ON ROOF DECK. PROVIDE UNISTRUT AND SUSPEND FROM ADEQUATE STRUCTURE.
 - WEATHERPROOF DISCONNECT SHALL BE INSTALLED IN ACCORDANCE WITH MANUFACTURER'S RECOMMENDED POSITIONING. THE ELECTRICAL CONTRACTOR SHALL COORDINATE WITH MECHANICAL SHOP DRAWINGS PRIOR TO ROUGH-IN.

A-ROOFTOP UNIT RE-FEED
SCALE: NTS

- GENERAL NOTES
- 'ER' INDICATES EXISTING ITEM TO REMAIN.
 - 'R' INDICATES EXISTING ITEM IN RELOCATED POSITION.
 - 'D' INDICATES EXISTING ITEM TO BE DELETED, UNLESS OTHERWISE NOTED DISCONNECT AND REMOVE NOTED DEVICE AND WIRING BACK TO SOURCE.
 - ALL DEVICES SHOWN ARE NEW UNLESS OTHERWISE NOTED.
 - EXISTING ELECTRICAL EQUIPMENT NOT SHOWN SHALL REMAIN UNLESS OTHERWISE NOTED.
 - MAINTAIN SERVICE TO ALL EXISTING DEVICES TO REMAIN.
 - REVISE PANEL DIRECTORIES TO SUIT CHANGES (TYPED).

- SPECIFIC RENOVATION NOTES
- INDICATES APPROXIMATE LOCATION OF ROOFTOP UNIT ABOVE. DISCONNECT EXISTING FEEDER TO SUIT. INSTALL NEW FEEDER IN CONJUNCTION WITH NOTED DETAIL AND DISTRIBUTION RISER DIAGRAM.
 - INDICATES 120V POWER CONNECTION TO FIRE SMOKE DAMPER. PROVIDE ADDITIONAL MONITORING MODULE AND DUAL VOLTAGE RELAY TO SUIT. REFER TO SPECIFICATION FOR ADDITIONAL INFORMATION FOR EXACT REQUIREMENTS.
 - INDICATED REHEAT COIL IS TO BE REMOVED COMPLETE. DISCONNECT AND MAINTAIN WIRING. EXTEND EXISTING 600V 3P WIRING TO SUIT NEW FAN FORCED HEATER.

| LED LIGHT FIXTURE SCHEDULE | | | | |
|----------------------------|--|---------|--------|----------------------------|
| Item | Manufacturer/Catalog Number | Voltage | Lamp | Mounting |
| R | TUROLIGHT CAT. #HV-TBSPSP4/10.4W/40/T/DE | 120V | LED T8 | RETROFIT |
| 3 | EARTHTRONICS MODEL LT814840BDECT | | | REPLACEMENT 120VAC T8 LAMP |



ALL UPGRADED FIXTURES MUST HAVE WRDSB SUPPLIED GREEN TYPE 'B' LED IDENTIFICATION STICKER ON SURFACE MOUNTED FIXTURES OR ON THE T-BAR CEILING ADJACENT TO T-BAR LAY-IN FIXTURES (CONTACT CALLED GINORCH REGHR).

COMPLETE RETROFIT IN COMPLIANCE WITH UL1598C.


| HEATER SCHEDULE | | FOR INFORMATION REGARDING EQUAL MANUFACTURERS REFER TO SPECIFICATION. | |
|-----------------|--|---|--|
| Item | Manufacturer/Catalog Number | | |
| A | 3000 WATT 600V VOLT THREE PHASE FAN FORCED HEATER C/W SURFACE MOUNTING BOX, STANDARD FACTORY FINISH TO SUIT ARCHITECT. PROVIDE 24V CONTROL RELAY FOR CONTROL FOR BAS THERMOSTAT. | | |
| | OUELLET CAT. #0AOC3036-T-R | | |

| DISTRIBUTION RISER NOTES | SPECIFIC DEMOLITION NOTES |
|---|---|
| 1 REFER TO SPECIFICATION FOR INFORMATION REGARDING MOULDED CASE CIRCUIT BREAKERS. | D1 FEDERAL PIONEER PANEL TO BE REPLACED WITH NEW PANEL AS PER THE RENOVATION DRAWINGS. DISCONNECT FEEDER AND BRANCH CIRCUITS BUT MAINTAIN FOR RE-CONNECTION TO NEW PANEL. |
| 2 ALL DISTRIBUTION EQUIPMENT ARE TO BE PROVIDED WITH WARNING LABELS CONFORMING TO THE ONTARIO ELECTRICAL SAFETY CODE RULE #2-306(1),(2) | |
| 3 INSTALL GROUND WIRE TO SUIT THE ELECTRICAL SAFETY CODE IN ALL CONDUIT. | |

| SPECIFIC RENOVATION NOTES |
|--|
| R1 RECONNECT EXISTING MAIN AND BRANCH CIRCUIT WIRING WHERE APPLICABLE. |

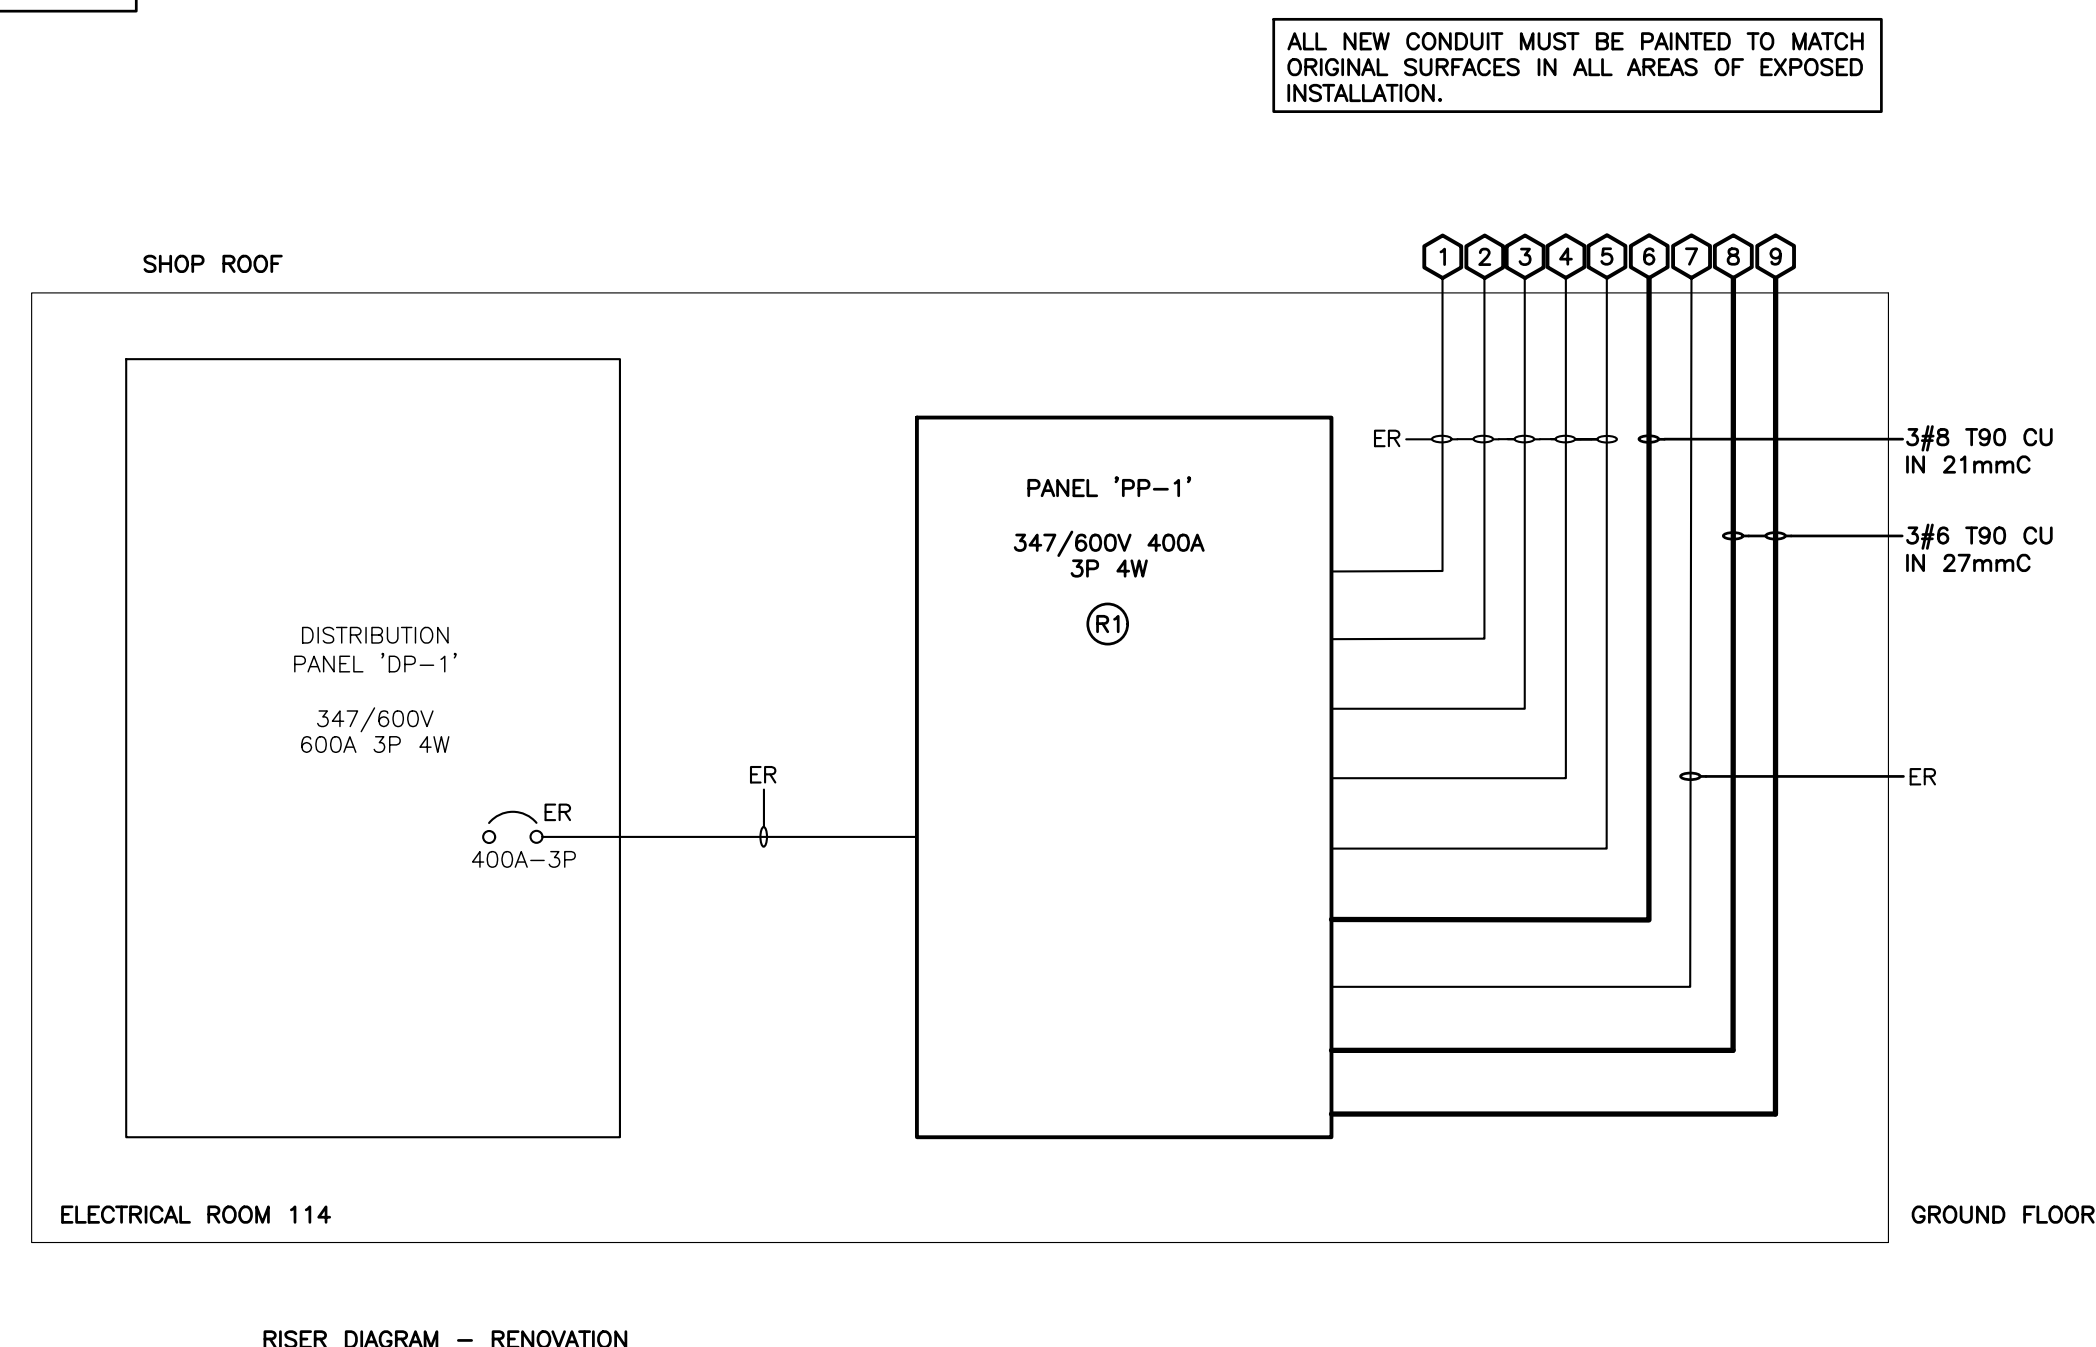
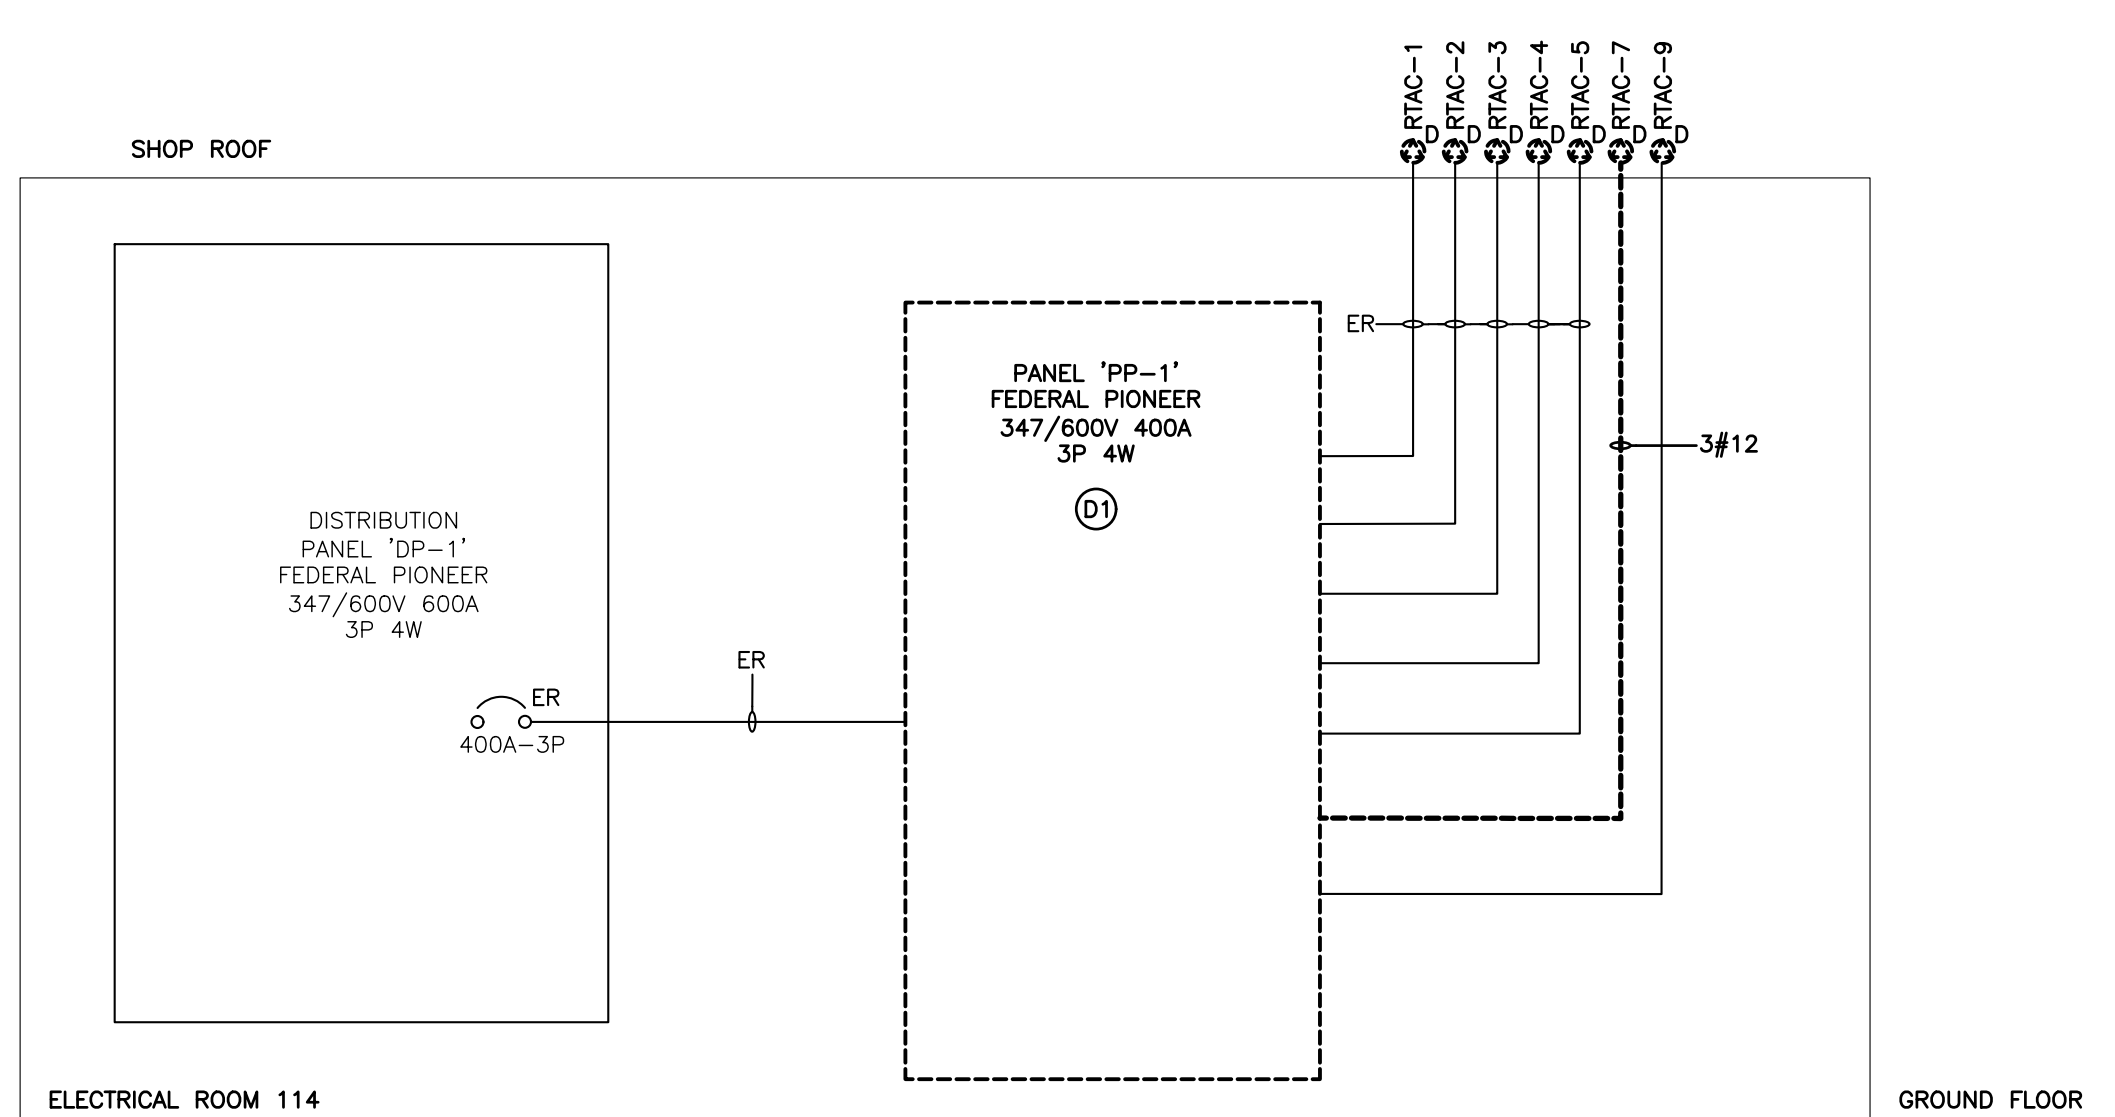


| EQUIPMENT WIRING SCHEDULE | | | | | | | | | | | | | | | E=ELECTRICAL M=MECHANICAL O=OTHERS |
|---------------------------|------------------|-------------|---------|--------|-------|----------|--------|---------|-------------|-----------------|---------------|-----------------|--------------|-------------|--|
| Electrical Item | Description | Provided by | Voltage | Size | Phase | Magnetic | Manual | Contact | Combination | Frequency Drive | Hand/Off/Auto | On/Off Selector | High/Low/Off | Pilot Light | Interlocking |
| 1 | HVAC-1 | M | 575 | 29 MCA | 3 | | | | | | | | | | |
| 2 | HVAC-2 | M | 575 | 29 MCA | 3 | | | | | | | | | | |
| 3 | HVAC-3 | M | 575 | 29 MCA | 3 | | | | | | | | | | |
| 4 | HVAC-4 | M | 575 | 55 MCA | 3 | | | | | | | | | | |
| 5 | HVAC-5 | M | 575 | 55 MCA | 3 | | | | | | | | | | |
| 6 | HV-7 | M | 575 | 5HP | 3 | | | | | | | | | | |
| 7 | HVAC-9 | M | 575 | 18 MCA | 3 | | | | | | | | | | |
| 8 | ERV-1 | M | 575 | 7.5 HP | 3 | | | | | | | | | | |
| 9 | ERV-2 | M | 575 | 5 HP | 3 | | | | | | | | | | |
| 10 | EXHAUST FAN EF-2 | M | 120 | 1/3 HP | 1 | | | | | | | | | | |
| 11 | EXHAUST FAN EF-3 | M | 120 | 1/3 HP | 1 | | | | | | | | | | |
| 12 | EXHAUST FAN EF-4 | M | 120 | FHP | 1 | | | | | | | | | | |

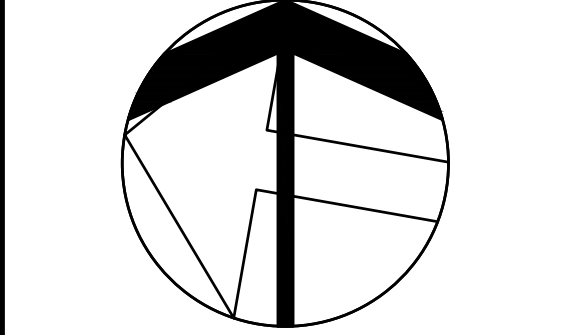

The contractor shall verify all dimensions and report of error and discrepancies to the Consultant before commencement of the work. The contractor shall be responsible for the accuracy of the drawings and shall be responsible for the accuracy of the information provided by the Consultant. The contractor shall be responsible for the accuracy of the information provided by the Consultant. The contractor shall be responsible for the accuracy of the information provided by the Consultant.

DEI
Consulting Engineers Ltd.
MECHANICAL ELECTRICAL PLUMBING
55 Northland Road, Waterloo, ON N2V 4Y8
Phone: 519-751-2025
Website: denassociates.ca
Project Number: 21121A

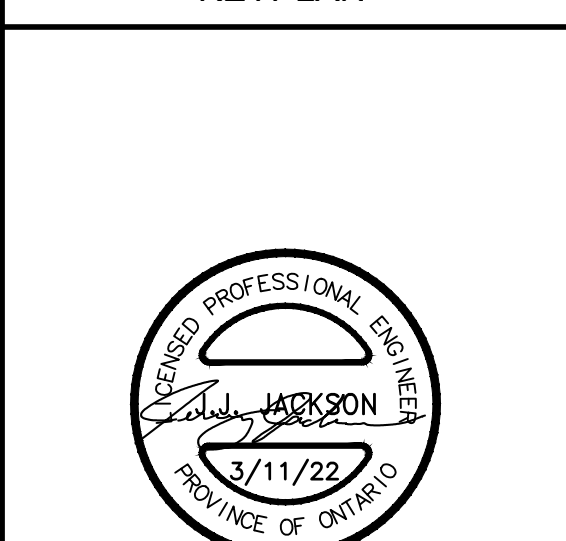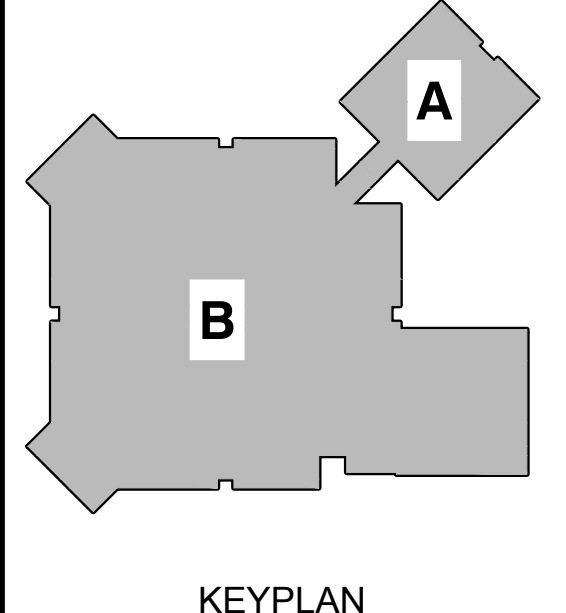

| NO. | DESCRIPTION | DATE |
|-----|----------------------|----------|
| 2. | ISSUED FOR TENDER/BP | 03.11.22 |
| 1. | TENDER READY | 03.01.22 |

DRAWINGS ARE NOT TO BE SCALED. CONTRACTOR MUST CHECK AND VERIFY ALL DIMENSIONS AND CONDITIONS ON THE PROJECT, AND MUST REPORT ANY DISCREPANCIES TO THE CONSULTANTS BEFORE PROCEEDING WITH THE WORK. THE USE OF THIS DRAWING OR PART THEREOF IS FORBIDDEN WITHOUT THE WRITTEN APPROVAL OF THE CONSULTANTS.

CERTIFICATE OF PRACTICE #4292

LAURELWOOD PS -
HVAC AND CONTROLS
UPGRADE

460 Brentcliffe Dr. Waterloo, ON N2T 2R5




51 Ardelt Ave, Kitchener, ON N2C 2R5

KEY PLAN, DETAILS,
DISTRIBUTION
RISER DEMOLITION,
AND RENOVATION

HOSSACK & ASSOCIATES
ARCHITECTS
1111 GERRARD STREET EAST
SUITE 200
TORONTO, ONTARIO M4M 1B7
TEL: (416) 461-8888 FAX: (416) 461-8889

| SCALE | PROJECT |
|------------|---------|
| DATE | 21121A |
| 2/9/2021 | |
| DRAWN | AK |
| CHECKED | SD |
| PRINT DATE | E1.1 |
| REVIT FILE | |

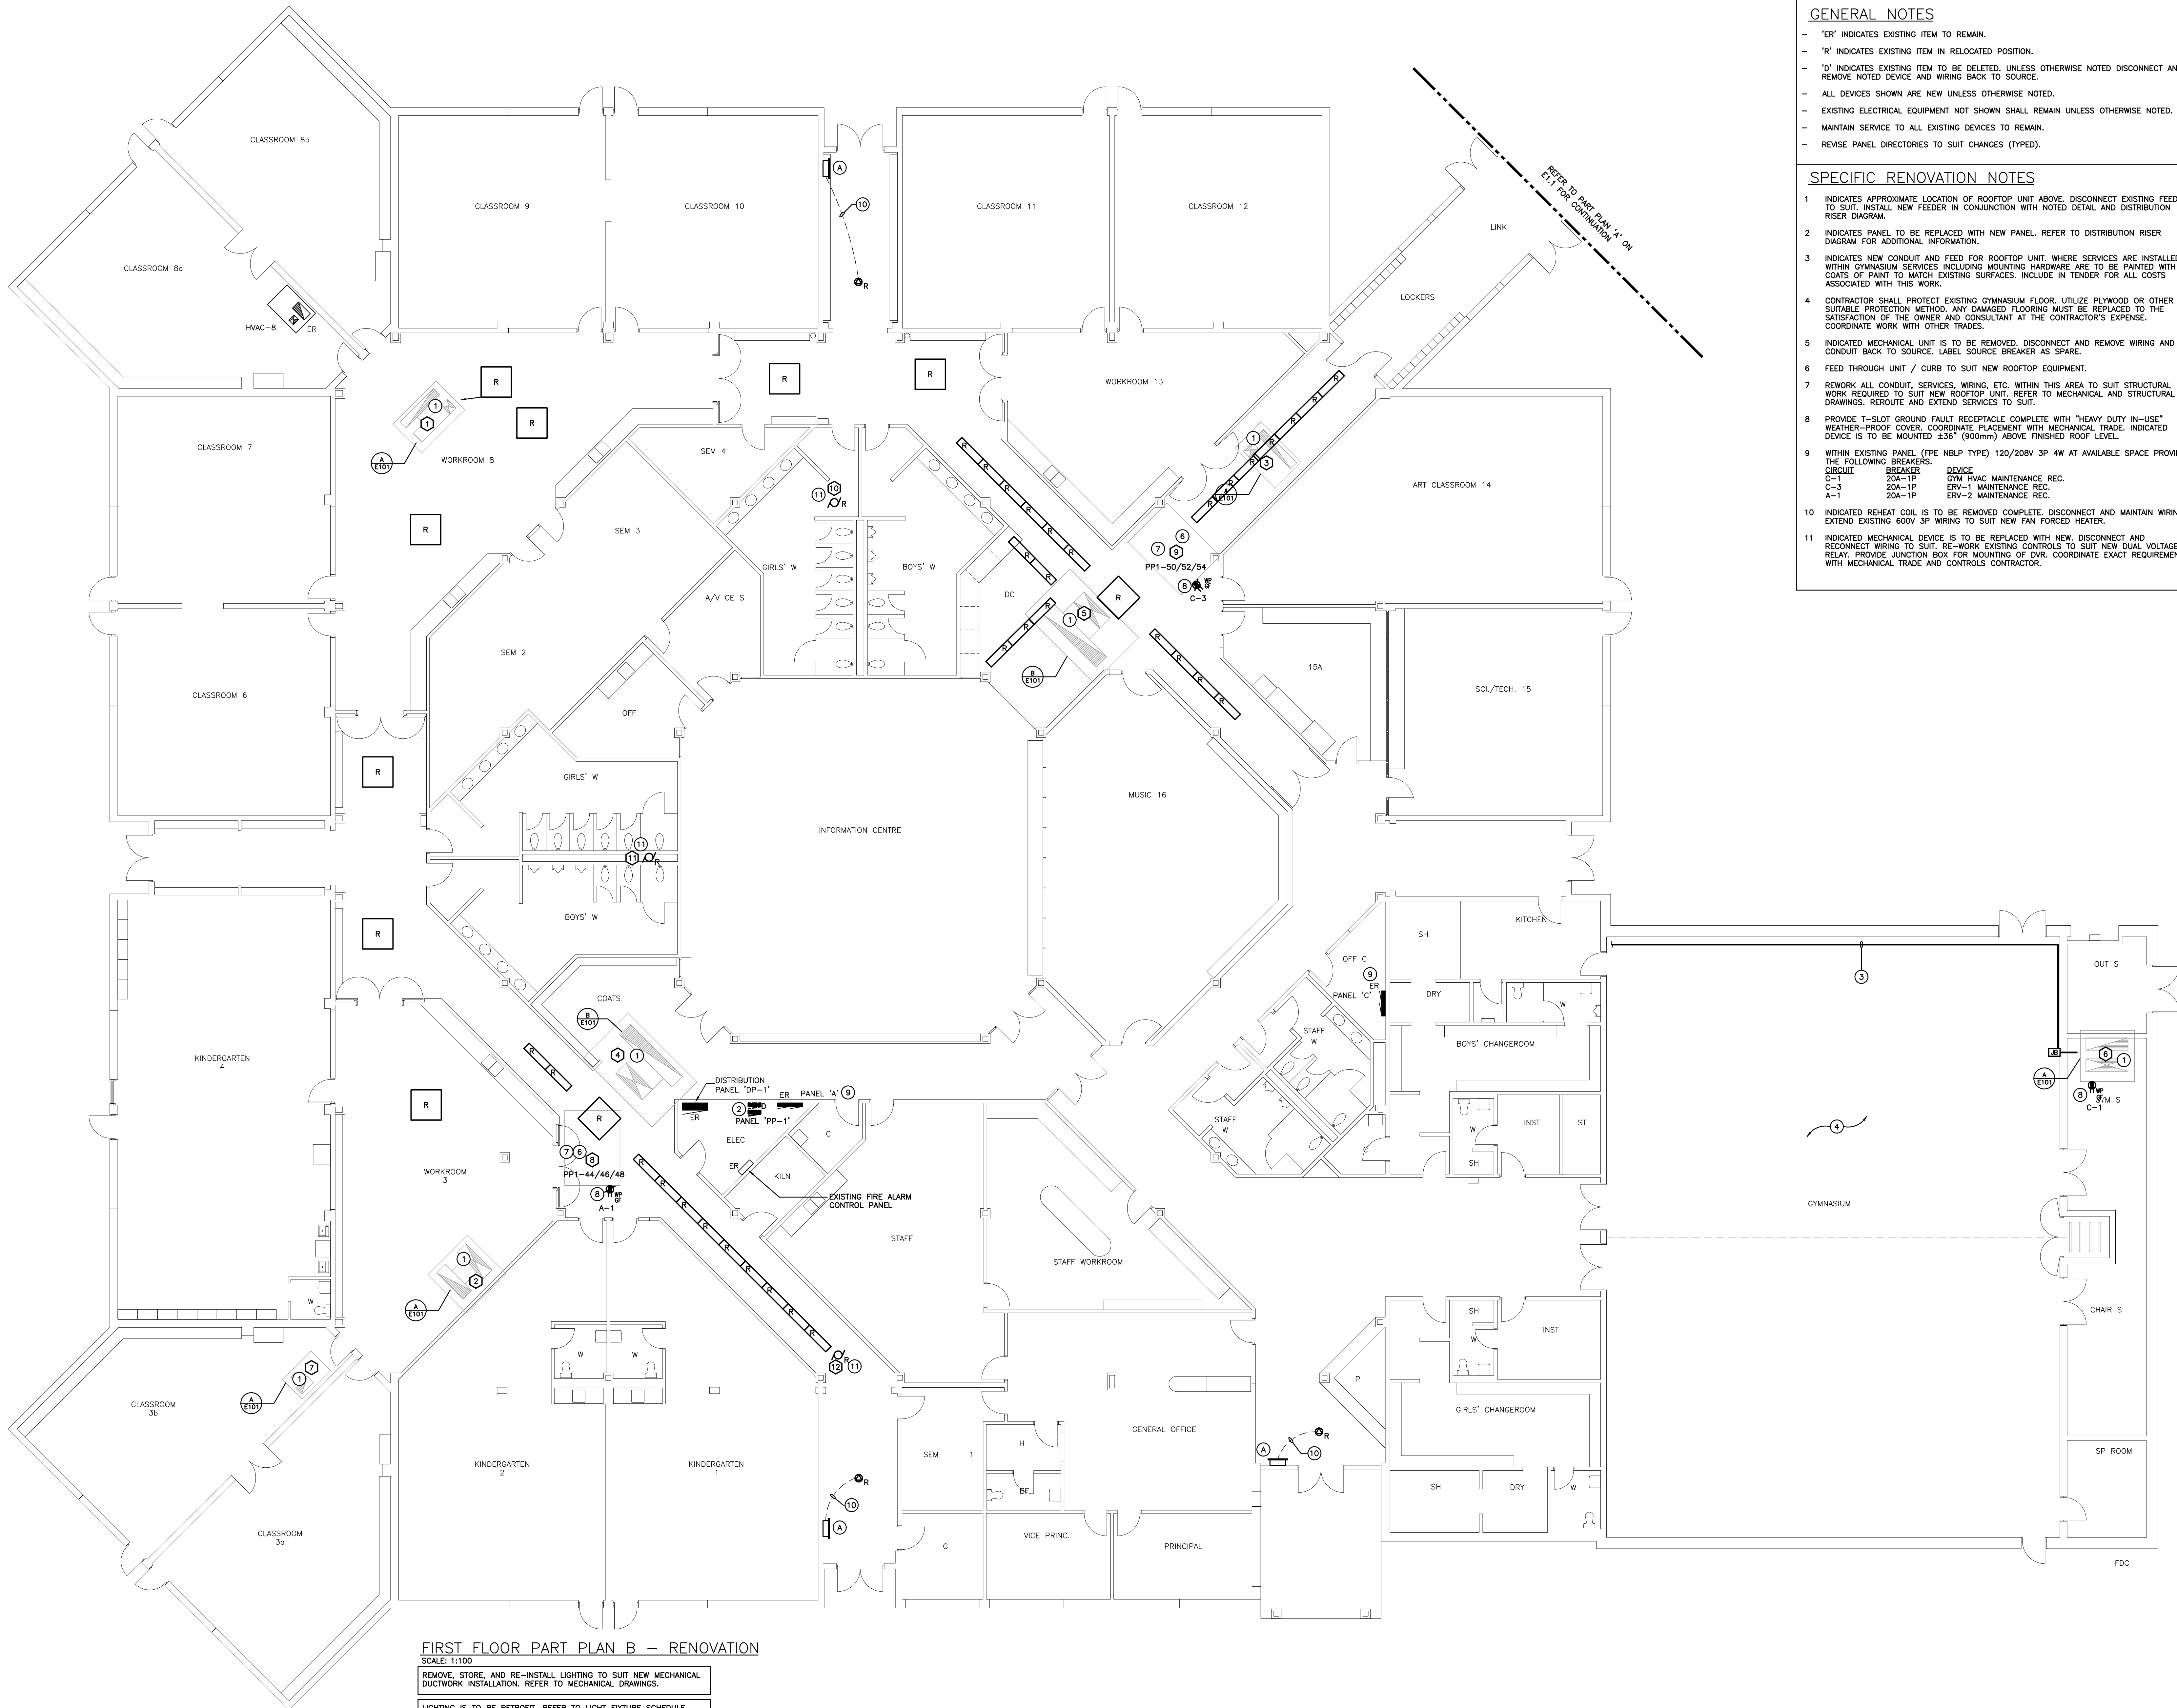


FIRST FLOOR PART PLAN B – RENOVATION
SCALE: 1:100
REMOVE, STORE, AND RE-INSTALL LIGHTING TO SUIT NEW MECHANICAL DUCTWORK INSTALLATION. REFER TO MECHANICAL DRAWINGS.
LIGHTING IS TO BE RETROFIT. REFER TO LIGHT FIXTURE SCHEDULE.
REMOVE EXISTING BALLASTS AND RE-WIRE TO SUIT 120V T8 LAMPS.

GENERAL NOTES

- 'ER' INDICATES EXISTING ITEM TO REMAIN.
- 'R' INDICATES EXISTING ITEM IN RELOCATED POSITION.
- 'D' INDICATES EXISTING ITEM TO BE DELETED, UNLESS OTHERWISE NOTED DISCONNECT AND REMOVE NOTED DEVICE AND WIRING BACK TO SOURCE.
- ALL DEVICES SHOWN ARE NEW UNLESS OTHERWISE NOTED.
- EXISTING ELECTRICAL EQUIPMENT NOT SHOWN SHALL REMAIN UNLESS OTHERWISE NOTED.
- MAINTAIN SERVICE TO ALL EXISTING DEVICES TO REMAIN.
- REVISE PANEL DIRECTORIES TO SUIT CHANGES (TYPED).


SPECIFIC RENOVATION NOTES

- INDICATES APPROXIMATE LOCATION OF ROOFTOP UNIT ABOVE. DISCONNECT EXISTING FEEDER TO SUIT. INSTALL NEW FEEDER IN CONJUNCTION WITH NOTED DETAIL AND DISTRIBUTION RISER DIAGRAM.
- INDICATES PANEL TO BE REPLACED WITH NEW PANEL. REFER TO DISTRIBUTION RISER DIAGRAM FOR ADDITIONAL INFORMATION.
- INDICATES NEW CONDUIT AND FEED FOR ROOFTOP UNIT. WHERE SERVICES ARE INSTALLED WITHIN GYMNASIUM SERVICES INCLUDING MOUNTING HARDWARE ARE TO BE PAINTED WITH 2 COATS OF PAINT TO MATCH EXISTING SURFACES. INCLUDE IN TENDER FOR ALL COSTS ASSOCIATED WITH THIS WORK.
- CONTRACTOR SHALL PROTECT EXISTING GYMNASIUM FLOOR. UTILIZE PLYWOOD OR OTHER SUITABLE PROTECTION METHOD. ANY DAMAGED FLOORING MUST BE REPLACED TO THE SATISFACTION OF THE OWNER AND CONSULTANT AT THE CONTRACTOR'S EXPENSE. COORDINATE WORK WITH OTHER TRADES.
- INDICATED MECHANICAL UNIT IS TO BE REMOVED. DISCONNECT AND REMOVE WIRING AND CONDUIT BACK TO SOURCE. LABEL SOURCE BREAKER AS SPARE.
- FEED THROUGH UNIT / CURB TO SUIT NEW ROOFTOP EQUIPMENT.
- REWORK ALL CONDUIT, SERVICES, WIRING, ETC. WITHIN THIS AREA TO SUIT STRUCTURAL WORK REQUIRED TO SUIT NEW ROOFTOP UNIT. REFER TO MECHANICAL AND STRUCTURAL DRAWINGS. REROUTE AND EXTEND SERVICES TO SUIT.
- PROVIDE T-SLOT GROUND FAULT RECEPTACLE COMPLETE WITH "HEAVY DUTY IN-US" WEATHER-PROOF COVER. COORDINATE PLACEMENT WITH MECHANICAL TRADE. INDICATED DEVICE IS TO BE MOUNTED ±36" (900mm) ABOVE FINISHED ROOF LEVEL.
- WITHIN EXISTING PANEL (FPE NBLP TYPE) 120/208V 3P 4W AT AVAILABLE SPACE PROVIDE THE FOLLOWING BREAKERS.
CIRCUIT BREAKER DEVICE
C-1 20A-1P GYM HVAC MAINTENANCE REC.
C-3 20A-1P ERY-1 MAINTENANCE REC.
A-1 20A-1P ERY-2 MAINTENANCE REC.
- INDICATED REHEAT COIL IS TO BE REMOVED COMPLETE. DISCONNECT AND MAINTAIN WIRING. EXTEND EXISTING 600V 3P WIRING TO SUIT NEW FAN FORCED HEAT.
- INDICATED MECHANICAL DEVICE IS TO BE REPLACED WITH NEW. DISCONNECT AND RECONNECT WIRING TO SUIT. RE-WORK EXISTING CONTROLS TO SUIT NEW DUAL VOLTAGE RELAY. PROVIDE JUNCTION BOX FOR MOUNTING OF DVR. COORDINATE EXACT REQUIREMENTS WITH MECHANICAL TRADE AND CONTROLS CONTRACTOR.

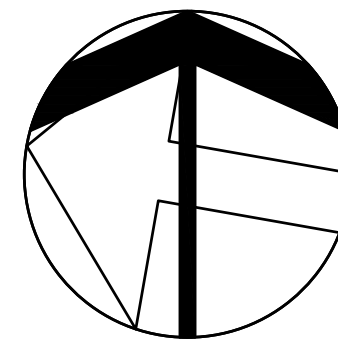

The contractor shall verify all dimensions and report all errors and omissions to the Consultant before commencement of the work. The contractor shall be responsible for the accuracy of the drawings and shall be responsible for the accuracy of the information provided. The contractor shall be responsible for the accuracy of the information provided. The contractor shall be responsible for the accuracy of the information provided.

DEI
Consulting Engineers
MECHANICAL, ELECTRICAL, PLUMBING
55 Northland Road, Waterloo, ON N2V 1Y8
Phone: 519-759-2855
Website: deiassociates.ca
Project Number: 21121A

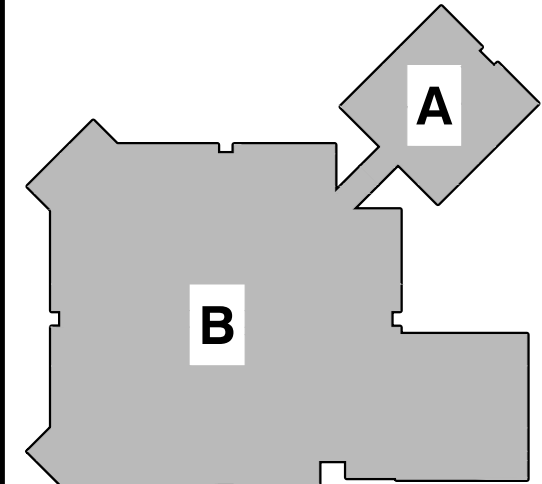

KEYPLAN



| | | |
|-----|----------------------|----------|
| 2. | ISSUED FOR TENDER/BP | 03.11.22 |
| 1. | TENDER READY | 03.01.22 |
| NO. | DESCRIPTION | DATE |

DRAWINGS ARE NOT TO BE SCALED. CONTRACTOR MUST CHECK AND VERIFY ALL DIMENSIONS AND CONDITIONS OF THE PROJECT, AND MUST REPORT ANY DISCREPANCIES TO THE CONSULTANTS BEFORE PROCEEDING WITH THE WORK. THE USE OF THIS DRAWING OR PART THEREOF IS FORBIDDEN WITHOUT THE WRITTEN APPROVAL OF THE CONSULTANTS.

DRAWINGS ARE NOT TO BE SCALED. CONTRACTOR MUST CHECK AND VERIFY ALL DIMENSIONS AND CONDITIONS ON THE PROJECT, AND MUST REPORT ANY DISCREPANCIES TO THE CONSULTANTS BEFORE PROCEEDING WITH THE WORK. THE USE OF THIS DRAWING OR PART THEREOF IS FORBIDDEN WITHOUT THE WRITTEN APPROVAL OF THE CONSULTANTS.

CERTIFICATE OF PRACTICE #4292

LAURELWOOD PS -
HVAC AND CONTROLS
UPGRADE

460 Brentcliffe Dr, Waterloo, ON N2T 2R5



51 Ardelt Ave, Kitchener, ON N2C 2R5

FIRST FLOOR PART
PLAN 'B' -
RENOVATION

**HOSSACK
& ASSOCIATES
ARCHITECTS**



4-1100 DUNDAS STREET
WATERLOO, ONTARIO N2L 2M6
TEL: 519-887-8200 FAX: 519-887-8200

| | |
|------------|---------|
| SCALE | PROJECT |
| DATE | 21121A |
| 2/9/2021 | |
| DRAWN | DRAWING |
| KZ | |
| CHECKED | E1.2 |
| SD | |
| PRINT DATE | |
| REVIT FILE | |

| FIRE ALARM RISER NOTES | |
|------------------------|---|
| F1 | REFER TO FLOOR PLANS FOR EXACT LOCATION AND QUANTITIES OF DEVICES. |
| F2 | INDICATES FIRE ALARM CONNECTION TO SMOKE DAMPER INTEGRAL DUCT DETECTOR. PROVIDE DUAL INPUT MONITOR/CONTACT MODULE AND DUAL VOLTAGE RELAY TO MONITOR AC POWER SUPPLY TO DAMPER AND ASSOCIATED DUCT DETECTOR BY MECHANICAL TRADE. REFER TO MECHANICAL DRAWINGS. |



- | | DEVICE | EDWARDS |
|----|---------------------------------|-----------|
| 2 | CONTROL PANEL: (ADDRESSABLE) | |
| | | EST 3X |
| | INTELLIGENT DEVICES: | |
| 18 | MONITOR MODULE | SIGA—MM1 |
| 19 | CONTROL MODULE | SIGA—CR |
| 19 | ISOLATOR MODULE | SIGA—IM |
| 21 | ANNUNCIATOR | EST3—BANN |

1. LIFE SAFETY AND FIRE PROTECTION SYSTEMS ARE TO BE INSTALLED TO COMPLY WITH THE PROVISIONS OF THE CURRENT APPLICABLE BUILDING AND FIRE CODES. AS A RESULT, COMMISSIONING OF THESE INTEGRATED SYSTEMS MUST BE PERFORMED AS A WHOLE PROJECT.
2. THESE SYSTEMS AS APPLICABLE TO ANY GIVEN PROJECT INCLUDE BUT ARE NOT LIMITED TO FIRE ALARM AND ACCESS CONTROL, AND EGRESS DEVICES.
3. ALL WORK IS TO BE PERFORMED IN ACCORDANCE WITH CAN/ULC S1001-2011. SPECIAL CONSIDERATION IS TO BE GIVEN TO THE SEQUENCE OF OPERATIONS . THE WORK TO BE PERFORMED BY THIS CONTRACTOR IS ALSO DESCRIBED IN CAN/ULC S1001-2011.
4. ALL APPLICABLE CONTRACTORS, SUB-CONTRACTORS, TESTING AGENTS, AND SUPPLIERS ARE TO INCLUDE ALL REQUIRED COSTS IN THEIR RESPECTIVE TENDER COSTS. THIS TESTING AGENT MUST BE A THIRD PARTY FIRM NOT ASSOCIATED WITH THIS PROJECT IN ANY MANNER.

1. FURNISH COMPLETE CATALOG DATA FOR MANUFACTURED ITEMS OF EQUIPMENT TO BE USED IN THE WORK TO CONSULTANT FOR REVIEW AND APPROVAL. THE CATALOG DATA SHALL BE SUBMITTED TO THE CONSULTANT WITHIN THE TIME FRAME SPECIFIED IN THE CONTRACT DOCUMENTS. IF MATERIAL OR EQUIPMENT IS NOT AS SPECIFIED OR SUBMITTAL IS NOT COMPLETE, IT WILL BE REJECTED BY CONSULTANT.

2. ADDITIONAL SHOP DRAWINGS REQUIRED BY THE CONTRACTOR FOR MAINTENANCE MANUALS, SITE COPIES ETC. SHALL BE SUBMITTED TO THE CONSULTANT WITHIN THE TIME FRAME SPECIFIED IN THE CONTRACT DOCUMENTS. THE CONSULTANT SHALL BE BORNE BY THE CONTRACTOR.

3. IF THE SUBMITTALS WILL NOT BE ACCEPTED.

4. CATALOG DATA OR SHOP DRAWINGS FOR EQUIPMENT, WHICH ARE NOT AS BEING REVIEWED BY CONSULTANT OR HIS ENGINEER SHALL NOT SUPERSEDE CONTRACT DOCUMENTS.

5. REVIEW COMMENTS OF CONSULTANT SHALL NOT RELIEVE THIS DIVISION FROM RESPONSIBILITY FOR DEVIATIONS FROM CONTRACT DOCUMENTS UNLESS CONSULTANT'S ATTENTION HAS BEEN CALLED TO SUCH DEVIATIONS IN WRITING AT TIME OF SUBMISSION, NOTWITHSTANDING THE REVIEW OF THE SUBMITTALS BY THE CONSULTANT.

6. CHECK WORK DESCRIBED BY CATALOG DATA WITH CONTRACT DOCUMENTS FOR DEVIATIONS AND ERRORS.

7. SHOP DRAWINGS AND PRODUCT DATA SHALL SHOW:

8. MOUNTING ARRANGEMENTS.

9. OPERATING AND MAINTENANCE CLEARANCES, E.G. ACCESS DOOR SWING SPACES.

10. MATERIALS AND PRODUCT DATA SHALL BE ACCOMPANIED BY:

11. DETAILED DRAWINGS OF BASES, SUPPORTS, AND ANCHOR BOLTS.

12. MANUFACTURER TEST DATA WHERE REQUESTED.

13. MANUFACTURER TO CERTIFY AS TO CURRENT MODEL PRODUCTION.

14. CERTIFICATION OF COMPLIANCE TO APPLICABLE CODES.

15. THE SUBMITTALS SHALL BE ACCOMPANIED BY THE FOLLOWING ACCESSORIES, MATERIALS, GAUGES, DIMENSIONS, AND OTHER PERTINENT INFORMATION. LIST ON CATALOG COVERS PAGE NUMBERS OF SUBMITTED ITEMS, UNDERLINE APPLICABLE DATA.


16. THE SHOP DRAWINGS, DRAWING RETENTION, REVIEW AND REVISIONS, TESTING AND INSTALLATION SHALL BE COMPLETED BY THE CONTRACTOR. IF A SHOP DRAWING IS RETURNED AS NOTED THIS CONTRACTOR MUST PROVIDE WRITTEN INDICATION THAT THE COMMENTS HAVE BEEN COMPLIED WITH.

17. A PARTIAL LIST OF SHOP DRAWINGS INCLUDES:

18. DISCONNECTS

19. PANELBOARDS

- .1 PANEL BOARDS MUST CONFORM TO CSA C22.2 NO. 29 (LATEST EDITION).
- .2 IN ADDITION TO CSA REQUIREMENTS MANUFACTURER'S NAMEPLATE MUST SHOW FAULT CURRENT THAT PANEL INCLUDING BREAKERS HAS BEEN BUILT TO WITHSTAND. SERIES RATING IS ACCEPTABLE—SUBMIT INFORMATION WITH SHOP DRAWINGS.
- .3 BUS AND BREAKERS/SWITCHES MUST BE RATED FOR 10KA (SYMMETRICAL) INTERRUPTING CAPACITY OR AS INDICATED.
- .4 SEQUENCE PHASE BUSSING WITH ODD NUMBERED BREAKERS ON LEFT AND EVEN ON RIGHT, WITH EACH BREAKER IDENTIFIED BY PERMANENT NUMBER IDENTIFICATION AS TO CIRCUIT NUMBER AND PHASE.
- .5 PANEL BOARD MAINS, NUMBER OF CIRCUITS, AND NUMBER AND SIZE OF BRANCH CIRCUIT AS INDICATED.
- .6 TWO KEYS FOR EACH PANEL BOARD AND KEY PANEL BOARDS ALIKE.
- .7 ALUMINUM BUS WITH NEUTRAL OF SAME AMPERE RATING AS MAINS.
- .8 MAINS MUST BE SUITABLE FOR BOLT-ON BREAKERS. PROVIDE MAIN (IF APPLICABLE) AND BRANCH BREAKERS AS BOLT-ON STYLE.
- .9 TRIM AND DOOR FINISH MUST BE BAKED GRAY ENAMEL.
- .10 BREAKERS WITH THERMAL AND MAGNETIC TRIPPING IN PANEL BOARD EXCEPT AS INDICATED OTHERWISE.
- .11 PROVIDE NAMEPLATE FOR EACH PANEL BOARD WITH ENGRAVED DESCRIPTION AS INDICATED.
- .12 FOR EACH NEW AND EXISTING PANEL PROVIDE COMPLETE CIRCUIT DIRECTORY WITH TYPEWRITTEN LEGEND SHOWING LOCATION OF EACH CIRCUIT.
- .13 LOCATE PANEL BOARDS AS INDICATED AND MOUNT SECURELY, PLUMB, TRUE AND SQUARE, TO ADJOINING SURFACES.
- .14 INSTALL SURFACE MOUNTED PANEL BOARDS ON PLYWOOD BACKBOARDS. WHERE PRACTICAL, GROUP PANEL BOARDS ON COMMON BACKBOARD.
- .15 CONNECT LOADS TO CIRCUITS.
- .16 CONNECT NEUTRAL CONDUCTORS TO COMMON NEUTRAL BUS.
- .17 POWER DISTRIBUTION CIRCUIT BREAKER PANEL BOARD MUST BE ONE OF THE FOLLOWING:
 - CUTLER HAMMER CAT. #PQW—R—LINE—C PLR—3A OR PLR—4A
 - SCHNEIDER ELECTRIC CAT. #COP OR I—LINE SERIES
 - SIEMENS CAT. #P2 SERIES
- .18 ALL REDUNDANT BREAKERS ARE TO REMAIN AND BE RE—LABELLED AS "SPARE".

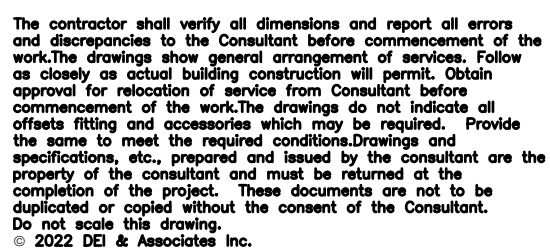

| | | |
|--|--|--|
| | | |
| | | |
| | | |
| | | |
| | | |
| | | |

| | | |
|-----|----------------------|----------|
| 2. | ISSUED FOR TENDER/BP | 03.11.22 |
| 1. | TENDER READY | 03.01.22 |
| NO. | DESCRIPTION | DATE |

DRAWINGS ARE NOT TO BE SCALED. CONTRACTOR MUST CHECK AND VERIFY ALL DIMENSIONS AND CONDITIONS ON THE PROJECT; AND MUST REPORT ANY DISCREPANCIES TO THE CONSULTANTS BEFORE PROCEEDING WITH THE WORK. THE USE OF THIS DRAWING OR PART THEREOF IS FORBIDDEN WITHOUT THE WRITTEN APPROVAL OF THE CONSULTANTS.

CERTIFICATE OF PRACTICE #4292

LAURELWOOD PS -
HVAC AND CONTROLS
UPGRADE

460 Brentcliffe Dr, Waterloo, ON N2T 2R5



51 Ardelt Ave, Kitchener, ON N2C 2R5

FIRE ALARM RISER DIAGRAM AND ELECTRICAL SPECIFICATION

**HOSSACK
& ASSOCIATES
ARCHITECTS**



4-2160 DUNWIN DRIVE
MISSAUGA, ONTARIO L5L 5M8
(905) 607-6294 Fax (905) 607-6290

| | |
|------------------|---------|
| SCALE | PROJECT |
| DATE 2/9/2021 | 21121A |
| DRAWN KZ | DRAWING |
| CHECKED SD | E1.3 |
| PRINT DATE | |
| REVIT FILE | |