

YMBOL	ELECTRICAL LEGEND DESCRIPTION
- MBOL	LINETYPES
	NEW WORK WORK TO BE DEMOLISHED, OR REMOVED
	EXISTING MATERIAL/EQUIPMENT/SERVICES TO REMAIN
	ABBREVIATIONS
E D	EXISTING TO REMAIN EXISTING TO BE DEMOLISHED/REMOVED
R	EXISTING TO BE RELOCATED/IN RELOCATED POSITION
ER	EXISTING TO BE REMAIN AND REPLACED WITH NEW
RR RL	REMOVE AND REINSTALL IN SAME POSITION REMOVE AND RELOCATE
С	CEILING MOUNTED CONNECTION
W F	WALL MOUNTED CONNECTION FLOOR MOUNTED CONNECTION
Ę.	CENTRE LINE
AFF	ABOVE FINISHED FLOOR
AFG O/C	ABOVE FINISHED GRADE OVER COUNTER
U/C	UNDER CABINET
U/F	UNDER RAISED FLOOR
CCT CTE	CIRCUIT CONNECT TO EXISTING
AFCI	ARC FAULT CIRCUIT INTERRUPTER
GFCI	GROUND FAULT CIRCUIT INTERRUPTER
GFI IG	GROUND FAULT INTERRUPTER ISOLATED GROUND
TL	TWIST LOCK
TR WG	TAMPER RESISTANT WIRE GLIARD
WP	WIRE GUARD WEATHER PROOF
R/I	ROUGH-IN ONLY
NIC SIM	NOT IN CONTRACT SIMILAR TO
SIM. TYP.	TYPICAL TYPICAL
05.5	ABBREVIATIONS - CODES AND STANDARDS
OBC DESC	ONTARIO BUILDING CODE ONTARIO ELECTRICAL SAFETY CODE
)L00	ANNOTATIONS
01	ROOM NUMBER
CL WR	CLOSET WASHROOM
	FIRE PROTECTION
SPK	FIRE EXTINGUISHER SPRINKLER HEAD
FHC	STANDPIPE FIRE HOSE CABINET
	HVAC
① BBH	THERMOSTAT OR TEMPERATURE SENSOR ELECTRIC BASEBOARD HEATER (BBH)
FFH	FORCED FLOW HEATER
ERV	ENERGY RECOVERY VENTILATOR
HRU MUA	HEAT RECOVERY UNIT MAKE-UP AIR UNIT
	CONDUIT AND BOXES
—] —0	CONDUIT WITH END BUSHING CONDUIT UP
	CONDUIT DOWN
JB	JUNCTION BOX
PB	PULL BOX
DW	CONNECTIONS TO EQUIPMENT
DW FR	DISHWASHER FRIDGE
MW	MICROWAVE
HD	HAND DRYER. ALLOW UP TO 208V-1PH-20A
PSC	PLUMBING SENSOR CONTROL (TOUCHLESS FAUCETS)
PTP	PLUMBING TRAP PRIMER 1 PHASE DIRECT CONNECTION OUTLIET AS NOTED
•	1-PHASE DIRECT CONNECTION OUTLET AS NOTED.
	3-PHASE DIRECT CONNECTION OUTLET AS NOTED.
W	ADJACENT TO 3-PHASE DIRECT CONNECTION, DENOTES WALL SYSTEM FURNITURE FEED FOR POWER AND COMMUNICATIONS.
6	SINGLE PHASE MOTOR, HP (KW) AS NOTED.
,	THREE PHASE MOTOR, HP (KW) AS NOTED.
<u> </u>	CLOCK.
R TO SPEC	LIGHTING CONTROLS FICATIONS AND RESPECTIVE SCHEDULES FOR EXACT REQUIREMENTS
	SWITCH OR OTHER USER INTERFACE DEVICE AS DESCRIBED ON
\$	LIGHTING CONTROLS SCHEDULE.
DIM	ADJACENT TO SWITCH, DENOTES DIMMING SWITCH.
K	ADJACENT TO SWITCH, DENOTES KEY SWITCH.
M	ADJACENT TO SWITCH, DENOTES MASTER CONTROL FOR ALL LUMINAIRES IN A ROOM OR SPACE, OR AS NOTED.
	WALL MOUNTED SWITCH/OCCUPANCY SENSOR. PIR DENOTES
PIR	'PASSIVE INFRARED', DT DENOTES 'DUAL PASSIVE INFRARED'ULTRASONIC'. LINE VOLTAGE TO SUIT CONTROLLED
<u>. </u>	CIRCUIT.
PP T	POWER PACK
T	TIMER SWITCH. CEILING MOUNTED OCCUPANCY SENSOR. PIR DENOTES 'PASSIVE
(DT)	INFRARED', UT DENOTES 'ULTRASONIC' (OR MICROPHONIC), DT DENOTES 'DUAL TECHNOLOGY'.
-OT	WALL MOUNTED OCCUPANCY SENSOR.
	DISTRIBUTION EQUIPMENT
	SURFACE MOUNTED LIGHTING AND RECEPTACLE PANELBOARD

THIS LEGEND IS GENERIC. ALL SYMBOLS LISTED MAY NOT BE APPLICABLE FOR THIS PROJECT. REFER TO FLOOR PLANS TO DETERMINE USED DEVICES AND EQUIPMENT.

	ELECTRICAL LEGEND
SYMBOL	DESCRIPTION
	FUSED DISCONNECT SWITCH
	POWER RECEPTACLES AND BOXES 120V U-GROUND DUPLEX RECEPTACLE.
	120V U-GROUND DUPLEX RECEPTACLE - CONTROLLED (ASHRAE 90.1-2010, 8.4.2).
 	120V U-GROUND QUAD RECEPTACLE.
\leftarrow	SPECIAL RECEPTACLE. VERIFY OUTLET REQUIREMENTS PRIOR TO ROUGH-IN.
+	120V U-GROUND DUPLEX RECEPTACLE MOUNTED ABOVE COUNTER TOP OR AS INSTRUCTED ON SITE.
	LIGHTING FIXTURES ORDANCE WITH IES DG-3-00 WHERE NOT DETAILED OTHERWISE HERE
	ING FIXTURE SCHEDULE FOR FURTHER DETAILS AND EXACT FIXTURE REQUIREMENTS.
	SURFACE MOUNTED LINEAR LUMINAIRE
	RECESSED MOUNTED LUMINAIRE
\Diamond	RECESSED DOWNLIGHT
Z1, Z2, ETC.	DENOTES ZONING/CIRCUTING ASSIGNMENTS FOR LUMINAIRES AND CONTROLS IN THE SAME SPACE.
REFER TO I	EMERGENCY LIGHTING EMERGENCY LIGHTING FIXTURE SCHEDULE FOR EXACT FIXTURE
	REQUIREMENTS. CEILING OR WALL MOUNTED ILLUMINATED EXIT SIGN. SHADED
	AREA INDICATES ILLUMINATED FACE. PROVIDE DIRECTIONAL ARROWS AS INDICATED ON PLANS.
	EMERGENCY LIGHTING BATTERY UNIT. ONE AND TWO HEAD WALL MOUNTED EMERGENCY LIGHTING
* •*	REMOTE UNITS.
EM	DENOTES 'EMERGENCY" COMMUNICATIONS
4	WALL MOUNTED DATA (D) OR VOICE (V) OUTLET. PROVIDE 1V AND UNLESS NOTED OTHERWISE.
◀	WALL MOUNTED VOICE (TELEPHONE) OUTLET. PROVIDE 1V UNLES NOTED OTHERWISE.
	WALL MOUNTED DATA OUTLET. PROVIDE 1D UNLESS NOTED
WAP	OTHERWISE. WIRELESS ACCESS POINT (WIFI)
⟨PA⟩	PUBLIC ADDRESS SPEAKER, CEILING AND WALL MOUNTED,
	RESPECTIVELY. ACCESS CONTROL
CR	CARD READER
ES	DOOR CONTACT ELECTRIC STRIKE
•	MUSHROOM HEAD PUSH BUTTON FOR MAGLOCK RELEASE, OR
•	OTHER PUSH BUTTON AS INDICATED BARRIER FREE DOOR OPERATOR PUSH BUTTON
	INTRUSION DETECTION
	GLASS BREAK (GB)
(MD)	MOTION DETECTOR (MD)
KP	KEYPAD (KP)
	SOUNDER FIRE DETECTION AND ALARM
FACP	FIRE ALARM CONTROL PANEL
FAAP	FIRE ALARM ANNUNICIATOR PANEL FIRE ALARM PASSIVE GRAPHIC
FAZ	FIRE ALARM ZONE
FSZ EOL	FIRE ALARM SUPERVISORY ZONE END OF LINE DEVICE
WG	WIRE GUARD
	MANUAL PULL STATION (MPS)
CG	WHERE NOTED ADJACENT TO MANUAL PULL STATIONS, DENOTES PULL STATION C/W LEXAN COVER.
	FIRE ALARM HORN
	FIRE ALARM HORN/STROBE, WALL MOUNTED. FIRE ALARM WALL MOUNTED STROBE LIGHT
-	PHOTOELECTRIC SMOKE DETECTOR
A	ADJACENT TO SMOKE DETECTOR, INDICATES C/W AUXILIARY RELAY
SA	WHEN ADJACENT TO PHOTOELECTRIC SMOKE DETECTOR,
	INDICATES RESIDENTIAL SMOKE ALARM DUCT MOUNTED SMOKE DETECTOR
EOL	END OF LINE (EOL) DEVICE ON ZONE INITIATION OR SIGNAL
IM	CIRCUITS ISOLATOR MODULE
•	HEAT DETECTOR - FIXED TEMPERATURE
НО	MAGNETIC DOOR HOLDER AND RELEASING DEVICE ("HOLD OPEN
FS PS	FLOW SWITCH PRESSURE SWITCH
SV	SUPERVISED VALVE
	SINGLE LINE DIAGRAM
• • •	CIRCUIT BREAKER DISCONNECT (UNFUSED)
	FUSE
	METER
>11C	TRANSFORMER
≾∥⊱	
	CONTACTOR
C DP	DISTRIBUTION PANELBOARD
DP PP	DISTRIBUTION PANELBOARD POWER PANELBOARD
DP	DISTRIBUTION PANELBOARD
DP PP SPD	DISTRIBUTION PANELBOARD POWER PANELBOARD SURGE PROTECTIVE DEVICE SWITCHBOARD TRANSFORMER
DP PP SPD SWBD	DISTRIBUTION PANELBOARD POWER PANELBOARD SURGE PROTECTIVE DEVICE SWITCHBOARD TRANSFORMER DETAIL REFERENCES
DP PP SPD SWBD	DISTRIBUTION PANELBOARD POWER PANELBOARD SURGE PROTECTIVE DEVICE SWITCHBOARD TRANSFORMER
DP PP SPD SWBD	DISTRIBUTION PANELBOARD POWER PANELBOARD SURGE PROTECTIVE DEVICE SWITCHBOARD TRANSFORMER DETAIL REFERENCES

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E401	SCHEDULES & DETAILS - ELECTRICAL					



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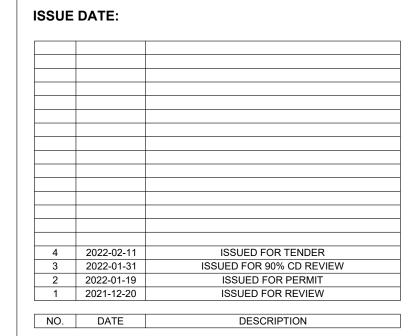
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PROJECT:

Park Manor Public School - Phase 2 Renovations

DRAWING TITLE:


ELECTRICAL LEGEND & SHEET

PROJECT NO: ED-20-301
SCALE: NOT TO SCALE
DRAWN BY: CW

REVIEWED BY: TWS

PROJECT NORTH:

DRAWING NO:

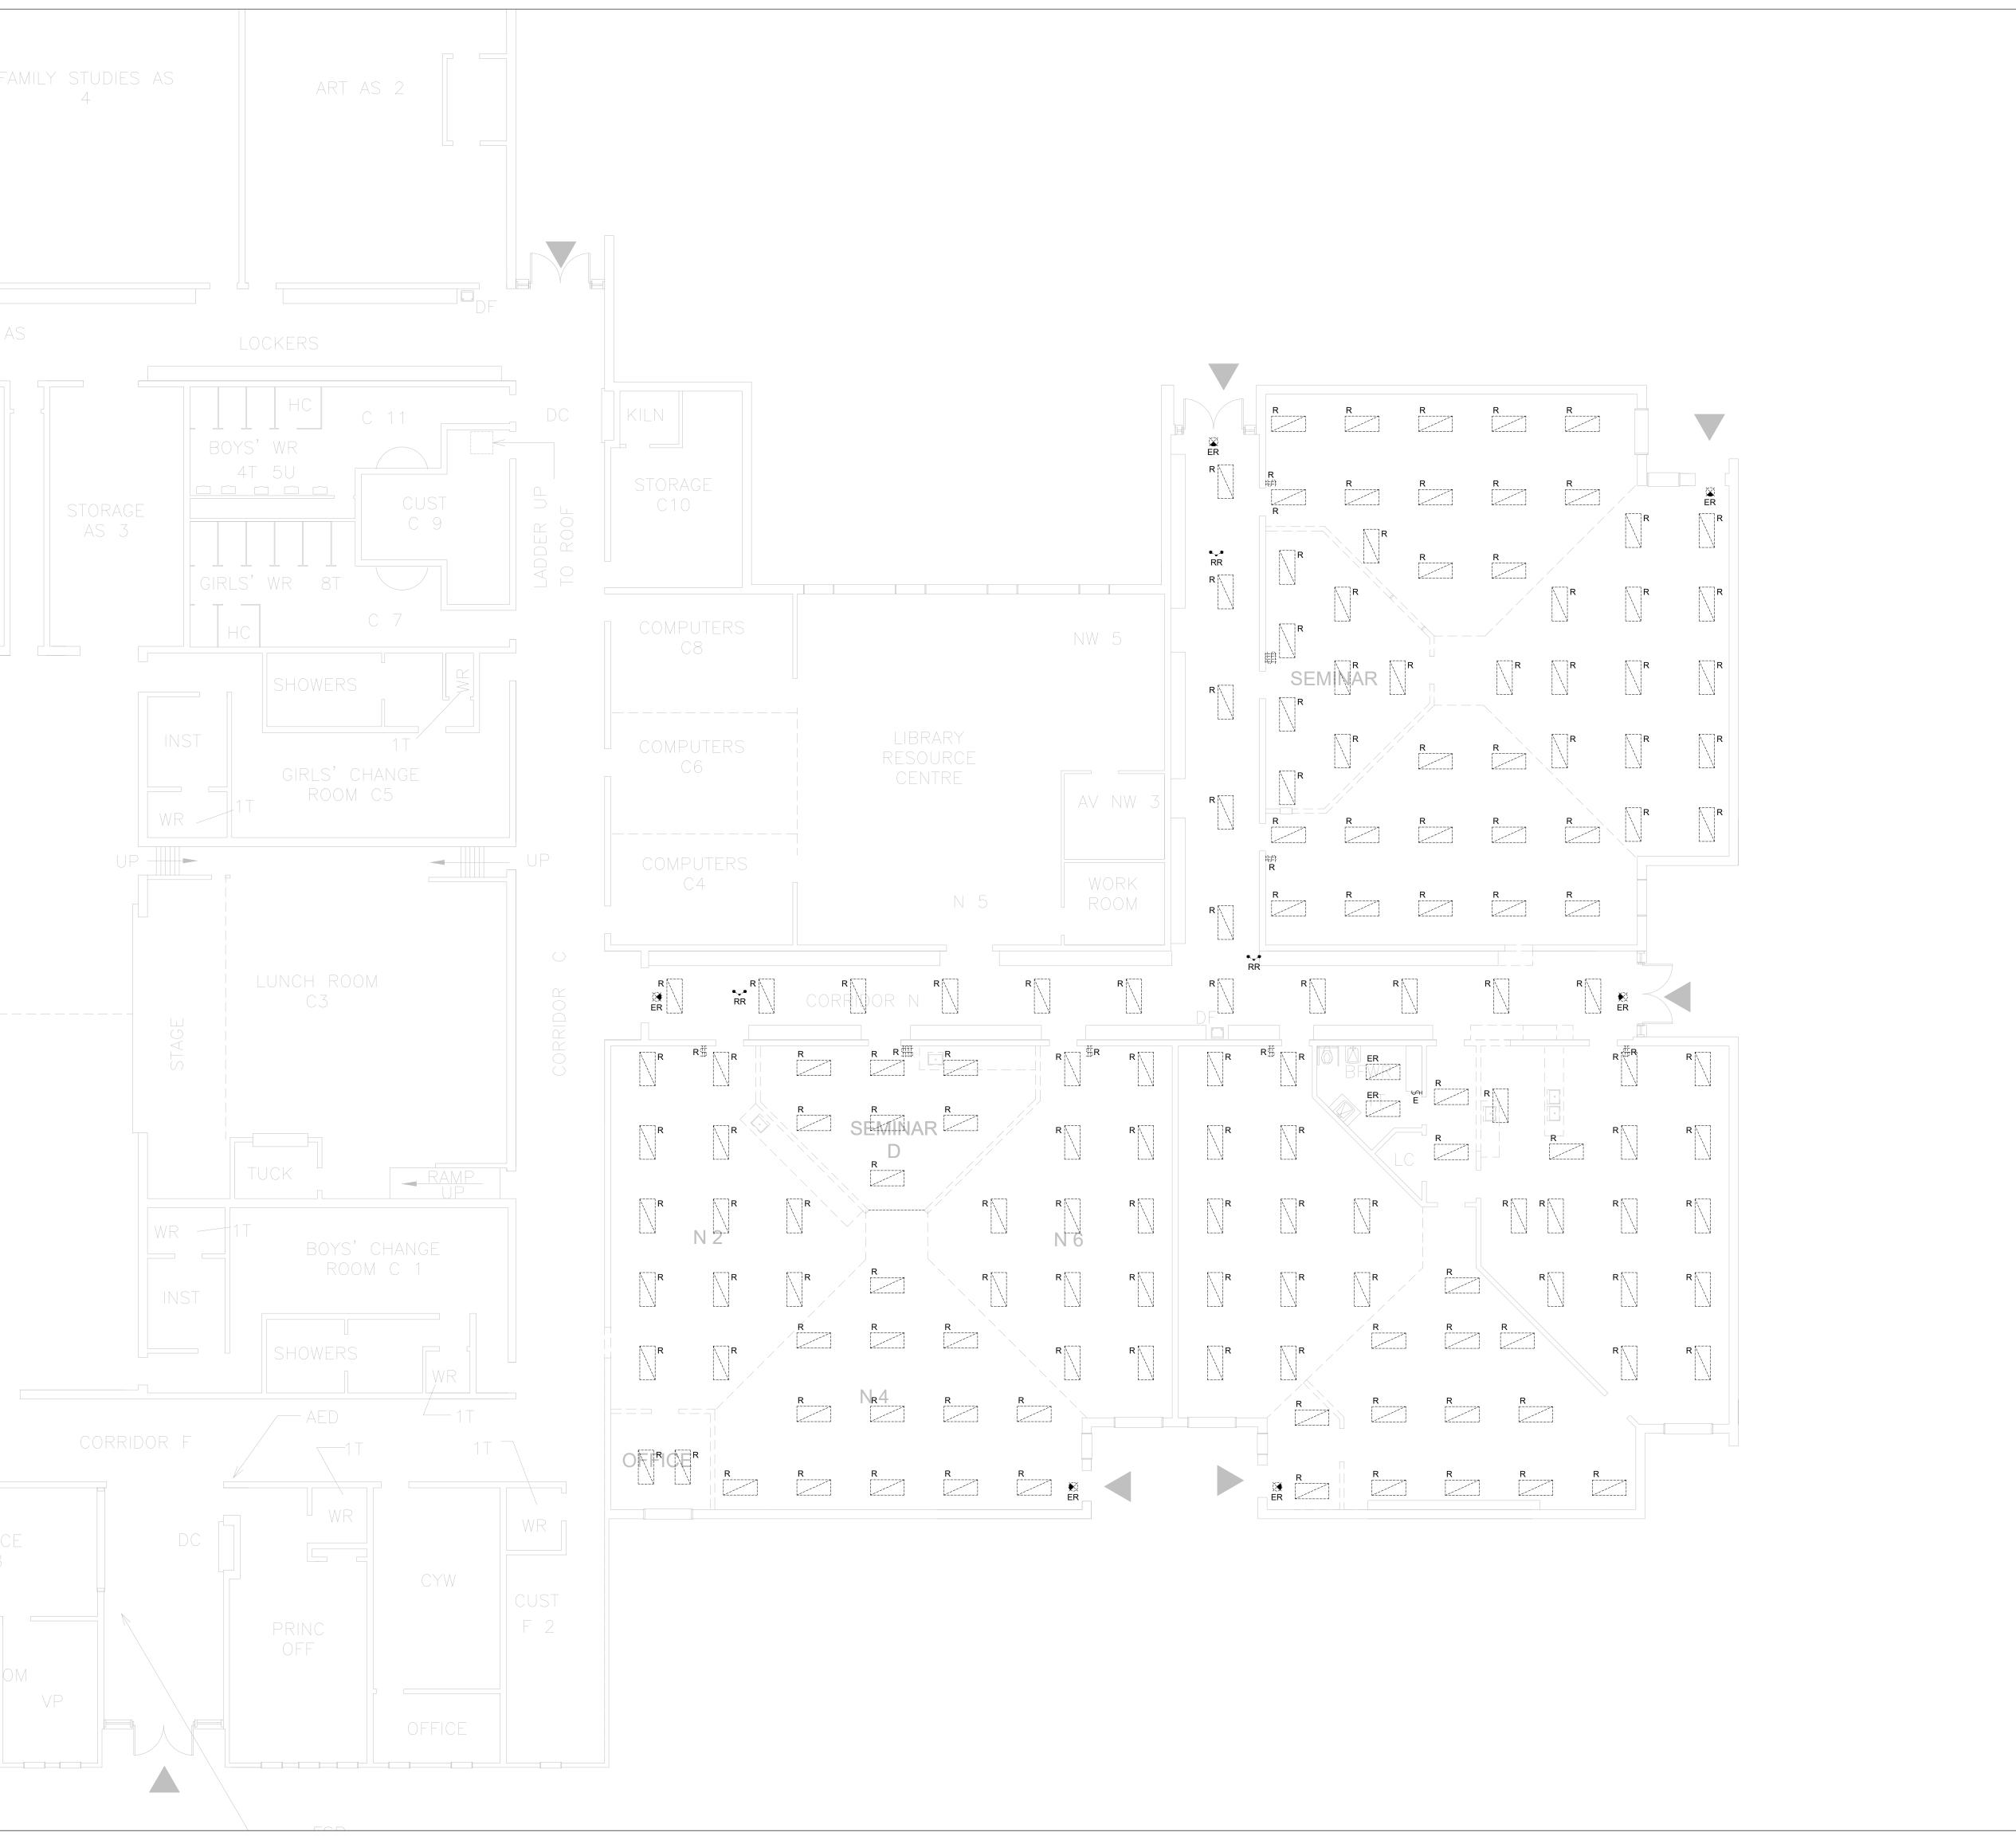

1. THIS DRAWING IS ISSUED TO SHOW PROPOSED SCOPE OF WORK ONLY.
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AREA (UNLESS OBSOLETE) ARE TO BE MAINTAINED AND/OR RELOCATED
TO SUIT THE SCOPE OF WORK.

DEMOLITION KEY NOTES:

EXISTING LIGHTING CIRCUITS TO BE RETAINED. MODIFY EXISTING BRANCH CIRCUIT WIRING AS REQUIRED AND RECONNECT TO NEW LIGHTING ARRANGEMENT COMPLETE. WHERE EXISTING LIGHT SWITCHES ARE BEING RETAINED, BE RESPONSIBLE TO RETAIN EXISTING SWITCHING ARRANGEMENT FOR NEW LUMINAIRES.

2



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PROJECT:

Park Manor Public School - Phase 2 Renovations

DRAWING TITLE:

PARTIAL GROUND FLOOR DEMOLITION PLAN - LIGHTING

PROJECT NO: ED-20-301 PROJECT NORTH
SCALE: 1:100
DRAWN BY: CW
REVIEWED BY: TWS

DRAWING NO:



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TO SUIT THE SCOPE OF WORK.

DEMOLITION KEY NOTES:

- EXISTING POWER AND DATA DEVICES FOR SAFE WELCOME MONITOR TO BE RELOCATED TO ACCOMMODATE RENOVATION WORK WITHIN OFFICE. BE RESPONSIBLE TO MODIFY EXISTING WIRING AND CABLING AS REQUIRED TO SUIT NEW LOCATION OF DEVICES AS SHOWN ON NEW WORK PLAN. ELECTRICAL CONTRACTOR SHALL ALSO RELOCATE EXISTING MONITOR.
- 2 EXISTING RECEPTACLE, TIME SWITCH AND PUBLIC ADDRESS SYSTEM HEAD END EQUIPMENT TO BE RELOCATED TO ACCOMMODATE RENOVATION WORK WITHIN OFFICE. BE RESPONSIBLE TO MODIFY EXISTING BRANCH CIRCUIT AND SYSTEM WIRING AS REQUIRED TO SUIT NEW LOCATION OF DEVICES AS SHOWN ON NEW WORK PLANS.



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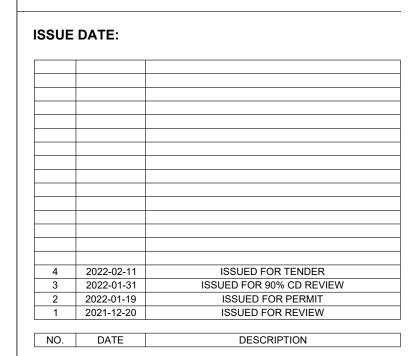
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PROJECT:

Park Manor Public School - Phase 2 Renovations

DRAWING TITLE:

PARTIAL GROUND FLOOR DEMOLITION PLAN - POWER & SYSTEMS


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DEMOLITION KEY NOTES:

- CONNECTION TO EXISTING ZONE #1 ROOF UNIT TO BE REMOVED IN ITS ENTIRETY BACK TO SOURCE MAIN SWITCHBOARD ON GROUND FLOOR, INCLUDING ALL ASSOCIATED WIRING AND CONDUIT BACK TO SOURCE. RETAIN EXISTING DISCONNECT SWITCH WITHIN MAIN SWITCHBOARD AS SPARE FOR RE-USE WITH NEW UNIT AND REMOVE EXISTING
- CONNECTION TO EXISTING GYM ROOF UNIT TO BE REMOVED IN ITS ENTIRETY BACK TO SOURCE MAIN SWITCHBOARD ON GROUND FLOOR, INCLUDING ALL ASSOCIATED WIRING AND CONDUIT BACK TO SOURCE. RETAIN EXISTING DISCONNECT SWITCH WITHIN MAIN SWITCHBOARD AS SPARE FOR RE-USE WITH NEW UNIT AND REMOVE EXISTING FUSES.
- CONNECTION TO EXISTING ZONE #2 ROOF UNIT TO BE REMOVED IN ITS ENTIRETY BACK TO SOURCE MAIN SWITCHBOARD ON GROUND FLOOR, INCLUDING ALL ASSOCIATED WIRING AND CONDUIT BACK TO SOURCE. RETAIN EXISTING DISCONNECT SWITCH WITHIN MAIN SWITCHBOARD AS SPARE FOR RE-USE WITH NEW UNIT AND REMOVE EXISTING FUSES.



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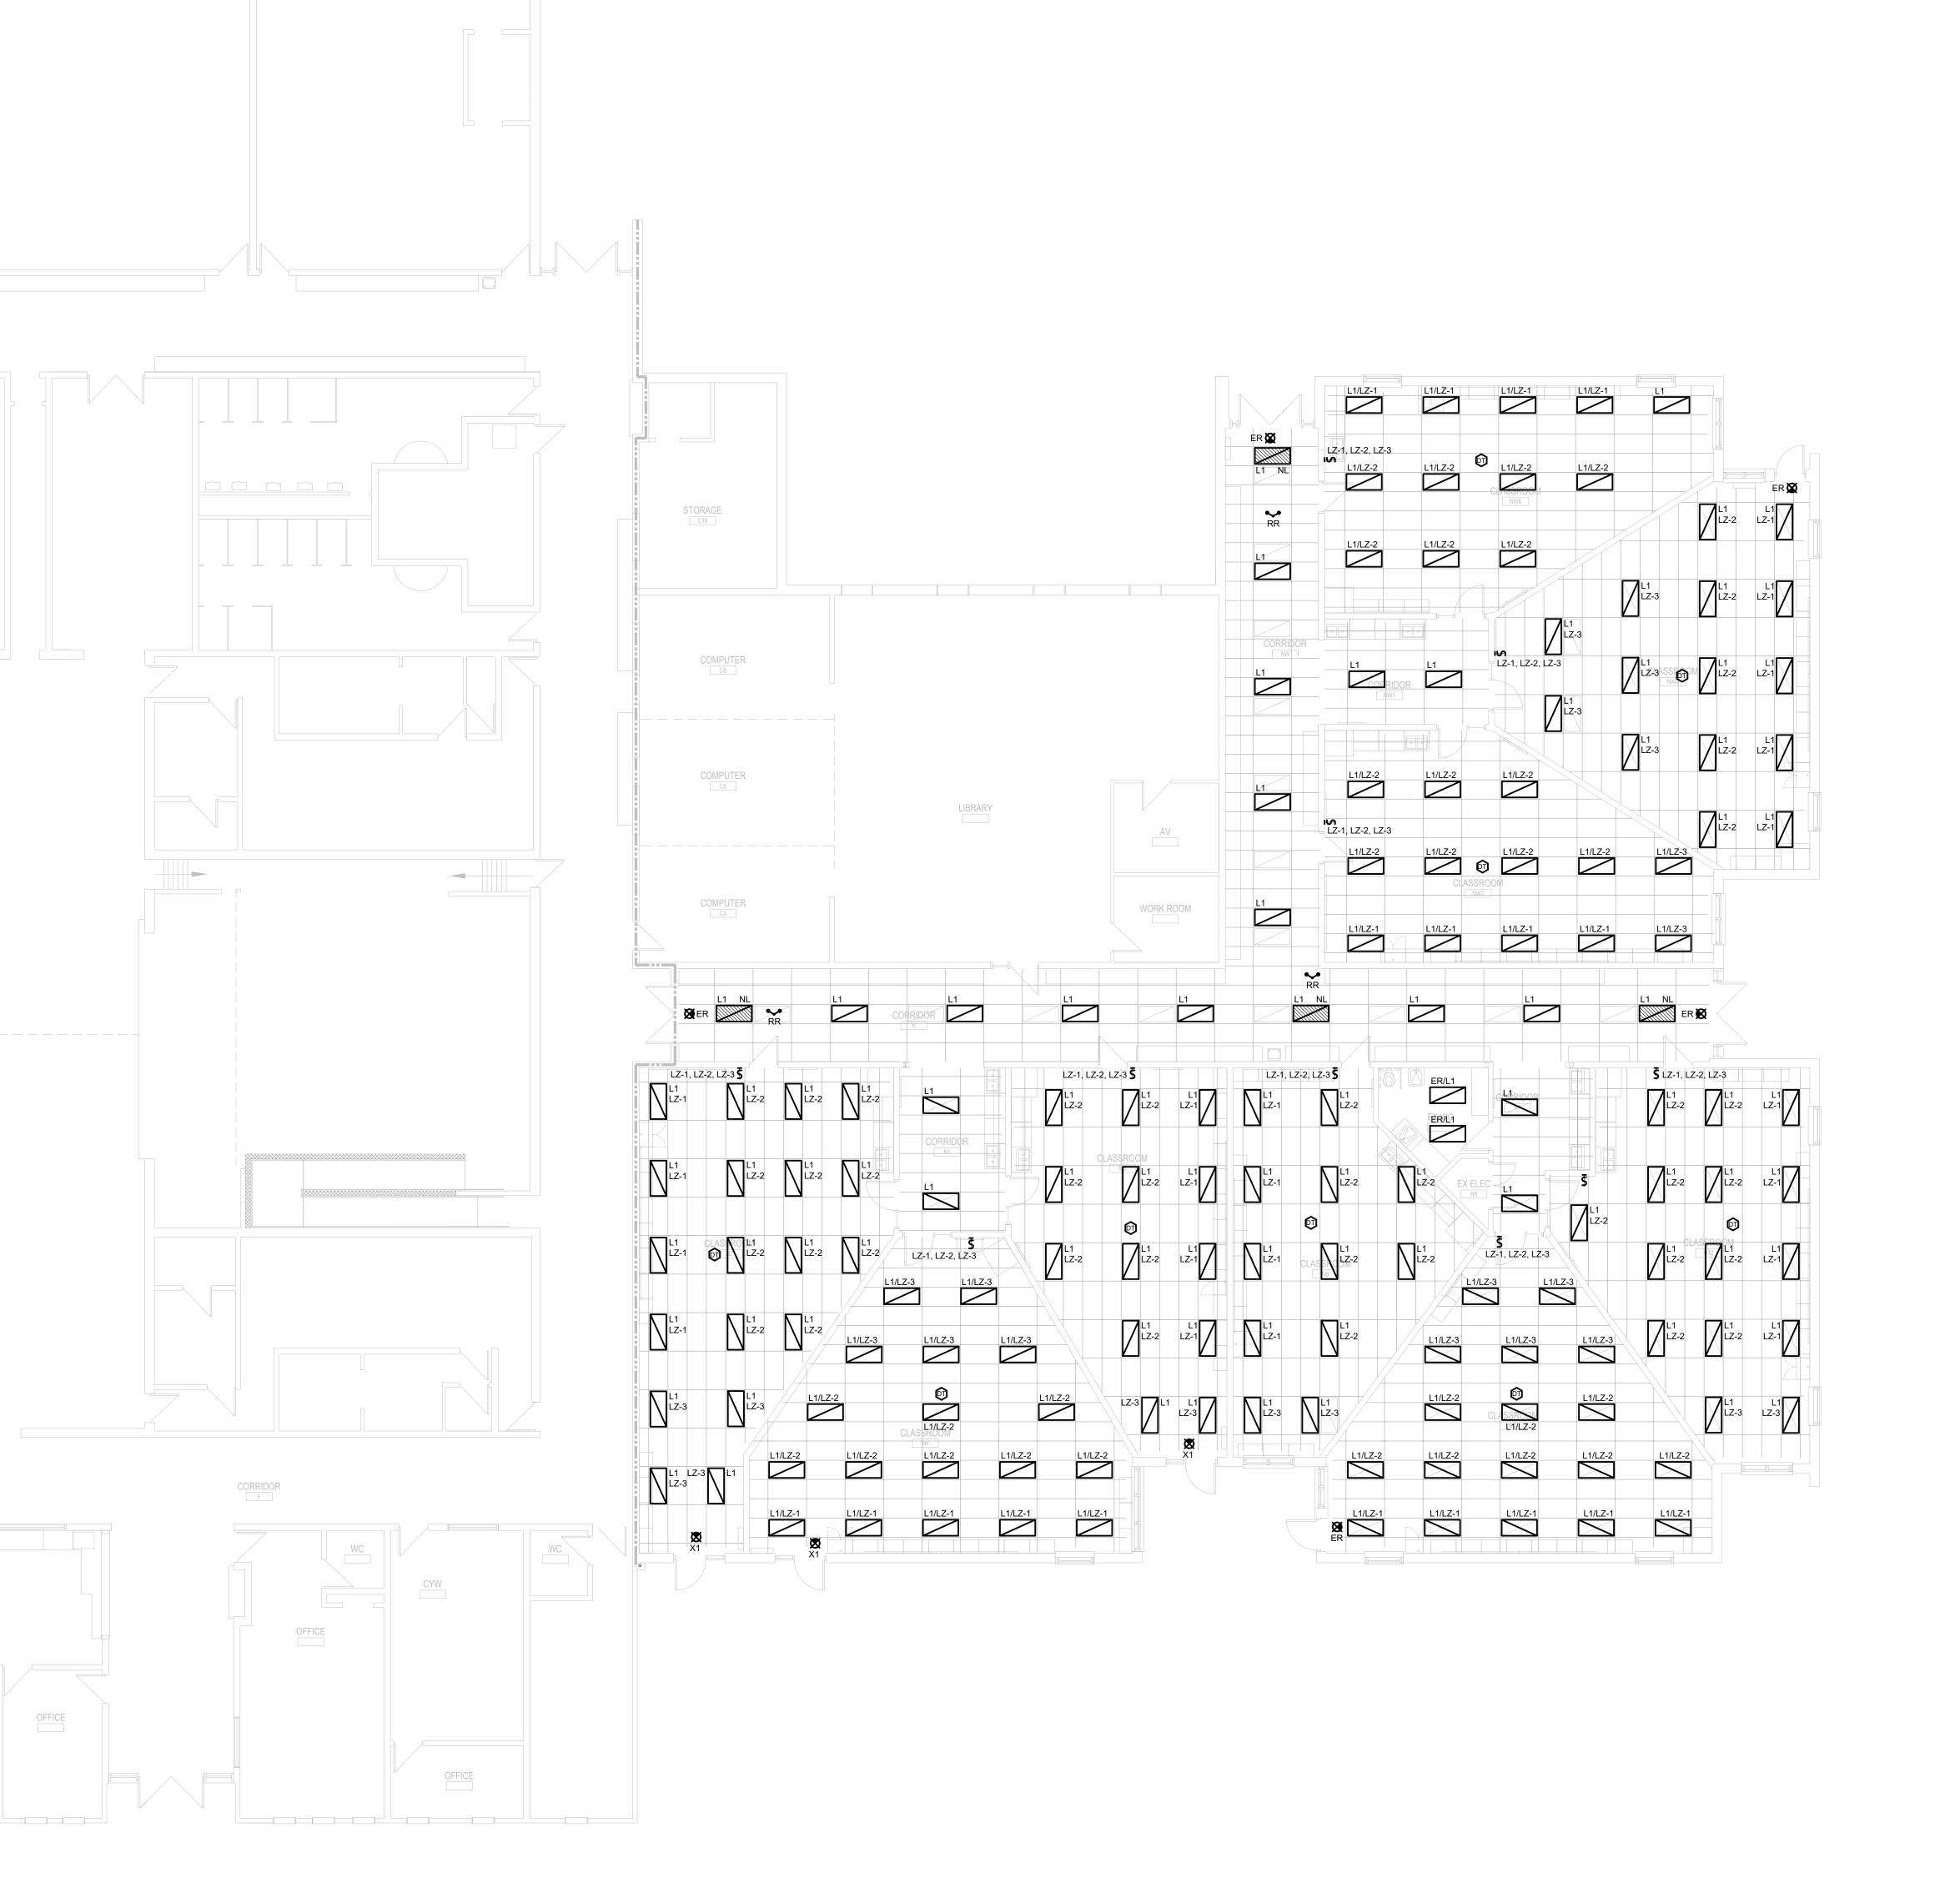
PARTIAL ROOF DEMOLITION PLAN - ELECTRICAL

PROJECT NO: ED-20-301
SCALE: 1:100
DRAWN BY: CW

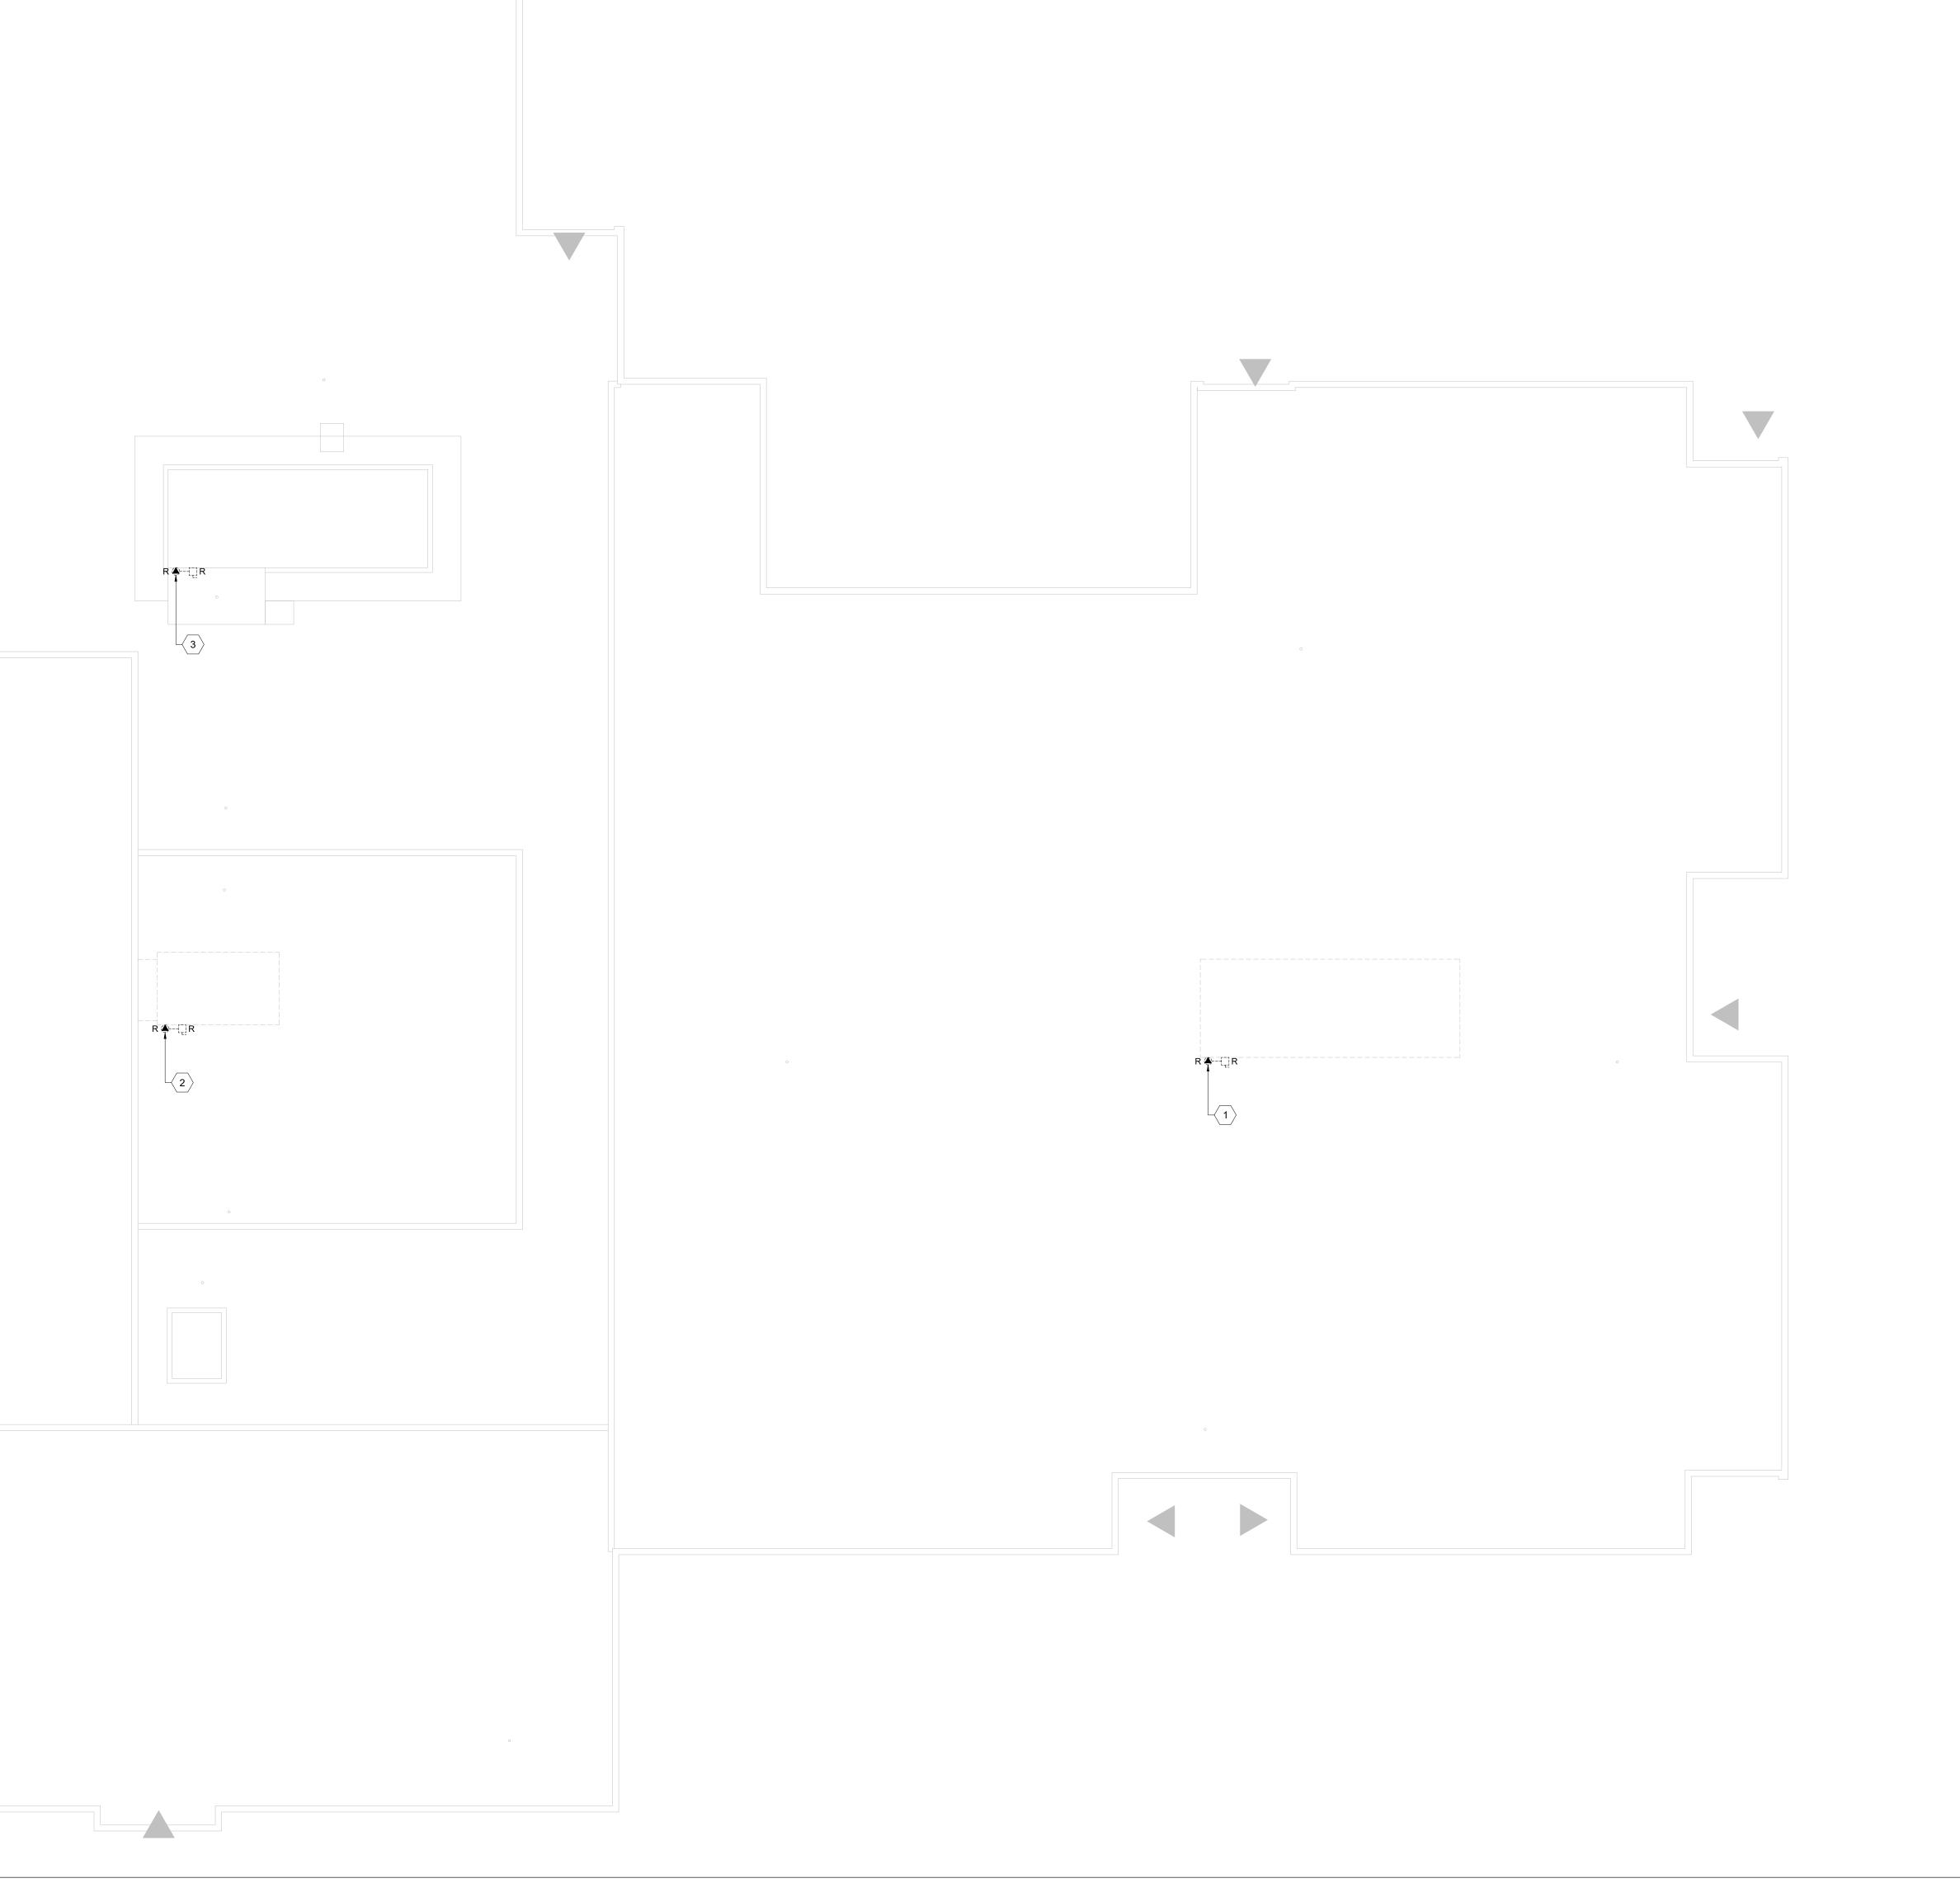REVIEWED BY: TWS

PROJECT NORTH:

DRAWING NO:



LOCATION OF DEVICES AND LUMINAIRES ARE NOTED FOR DIAGRAMMATIC PURPOSES, CONTRACTOR SHALL BE RESPONSIBLE TO REVIEW ARCHITECTURAL ELEVATIONS AND REFLECTED CEILING PLANS AND SITE CONDITIONS FOR EXACT DEVICE AND LUMINAIRE PLACEMENT.

- 2. NEW DEVICES SHOWN ON EXISTING WALL CONSTRUCTION SHALL BE INSTALLED SURFACE MOUNTED ON FS TYPE BACK BOXES WITH SURFACE RACEWAY (LEGRAND WIREMOLD 400 SERIES OR EQUIVALENT WHITE), FROM DEVICE UP TO CEILING SPACE. CONDUIT SHALL BE PROVIDED ABOVE CEILING SPACE IN ALL LOCATIONS. COORDINATE INSTALLATION WITH GENERAL CONTRACTOR AND CURRENT HAZARDOUS MATERIALS SURVEY.
- FOR NEW BRANCH CIRCUITS NOTED ON THE FLOOR PLANS, PROVIDE A NEW 15A-1P BREAKER WITHIN EXISTING PANEL INDICATED AND EXTEND NEW FEEDERS TO EXISTING PANEL AND CONNECT COMPLETE.

NEW WORK KEY NOTES:

1



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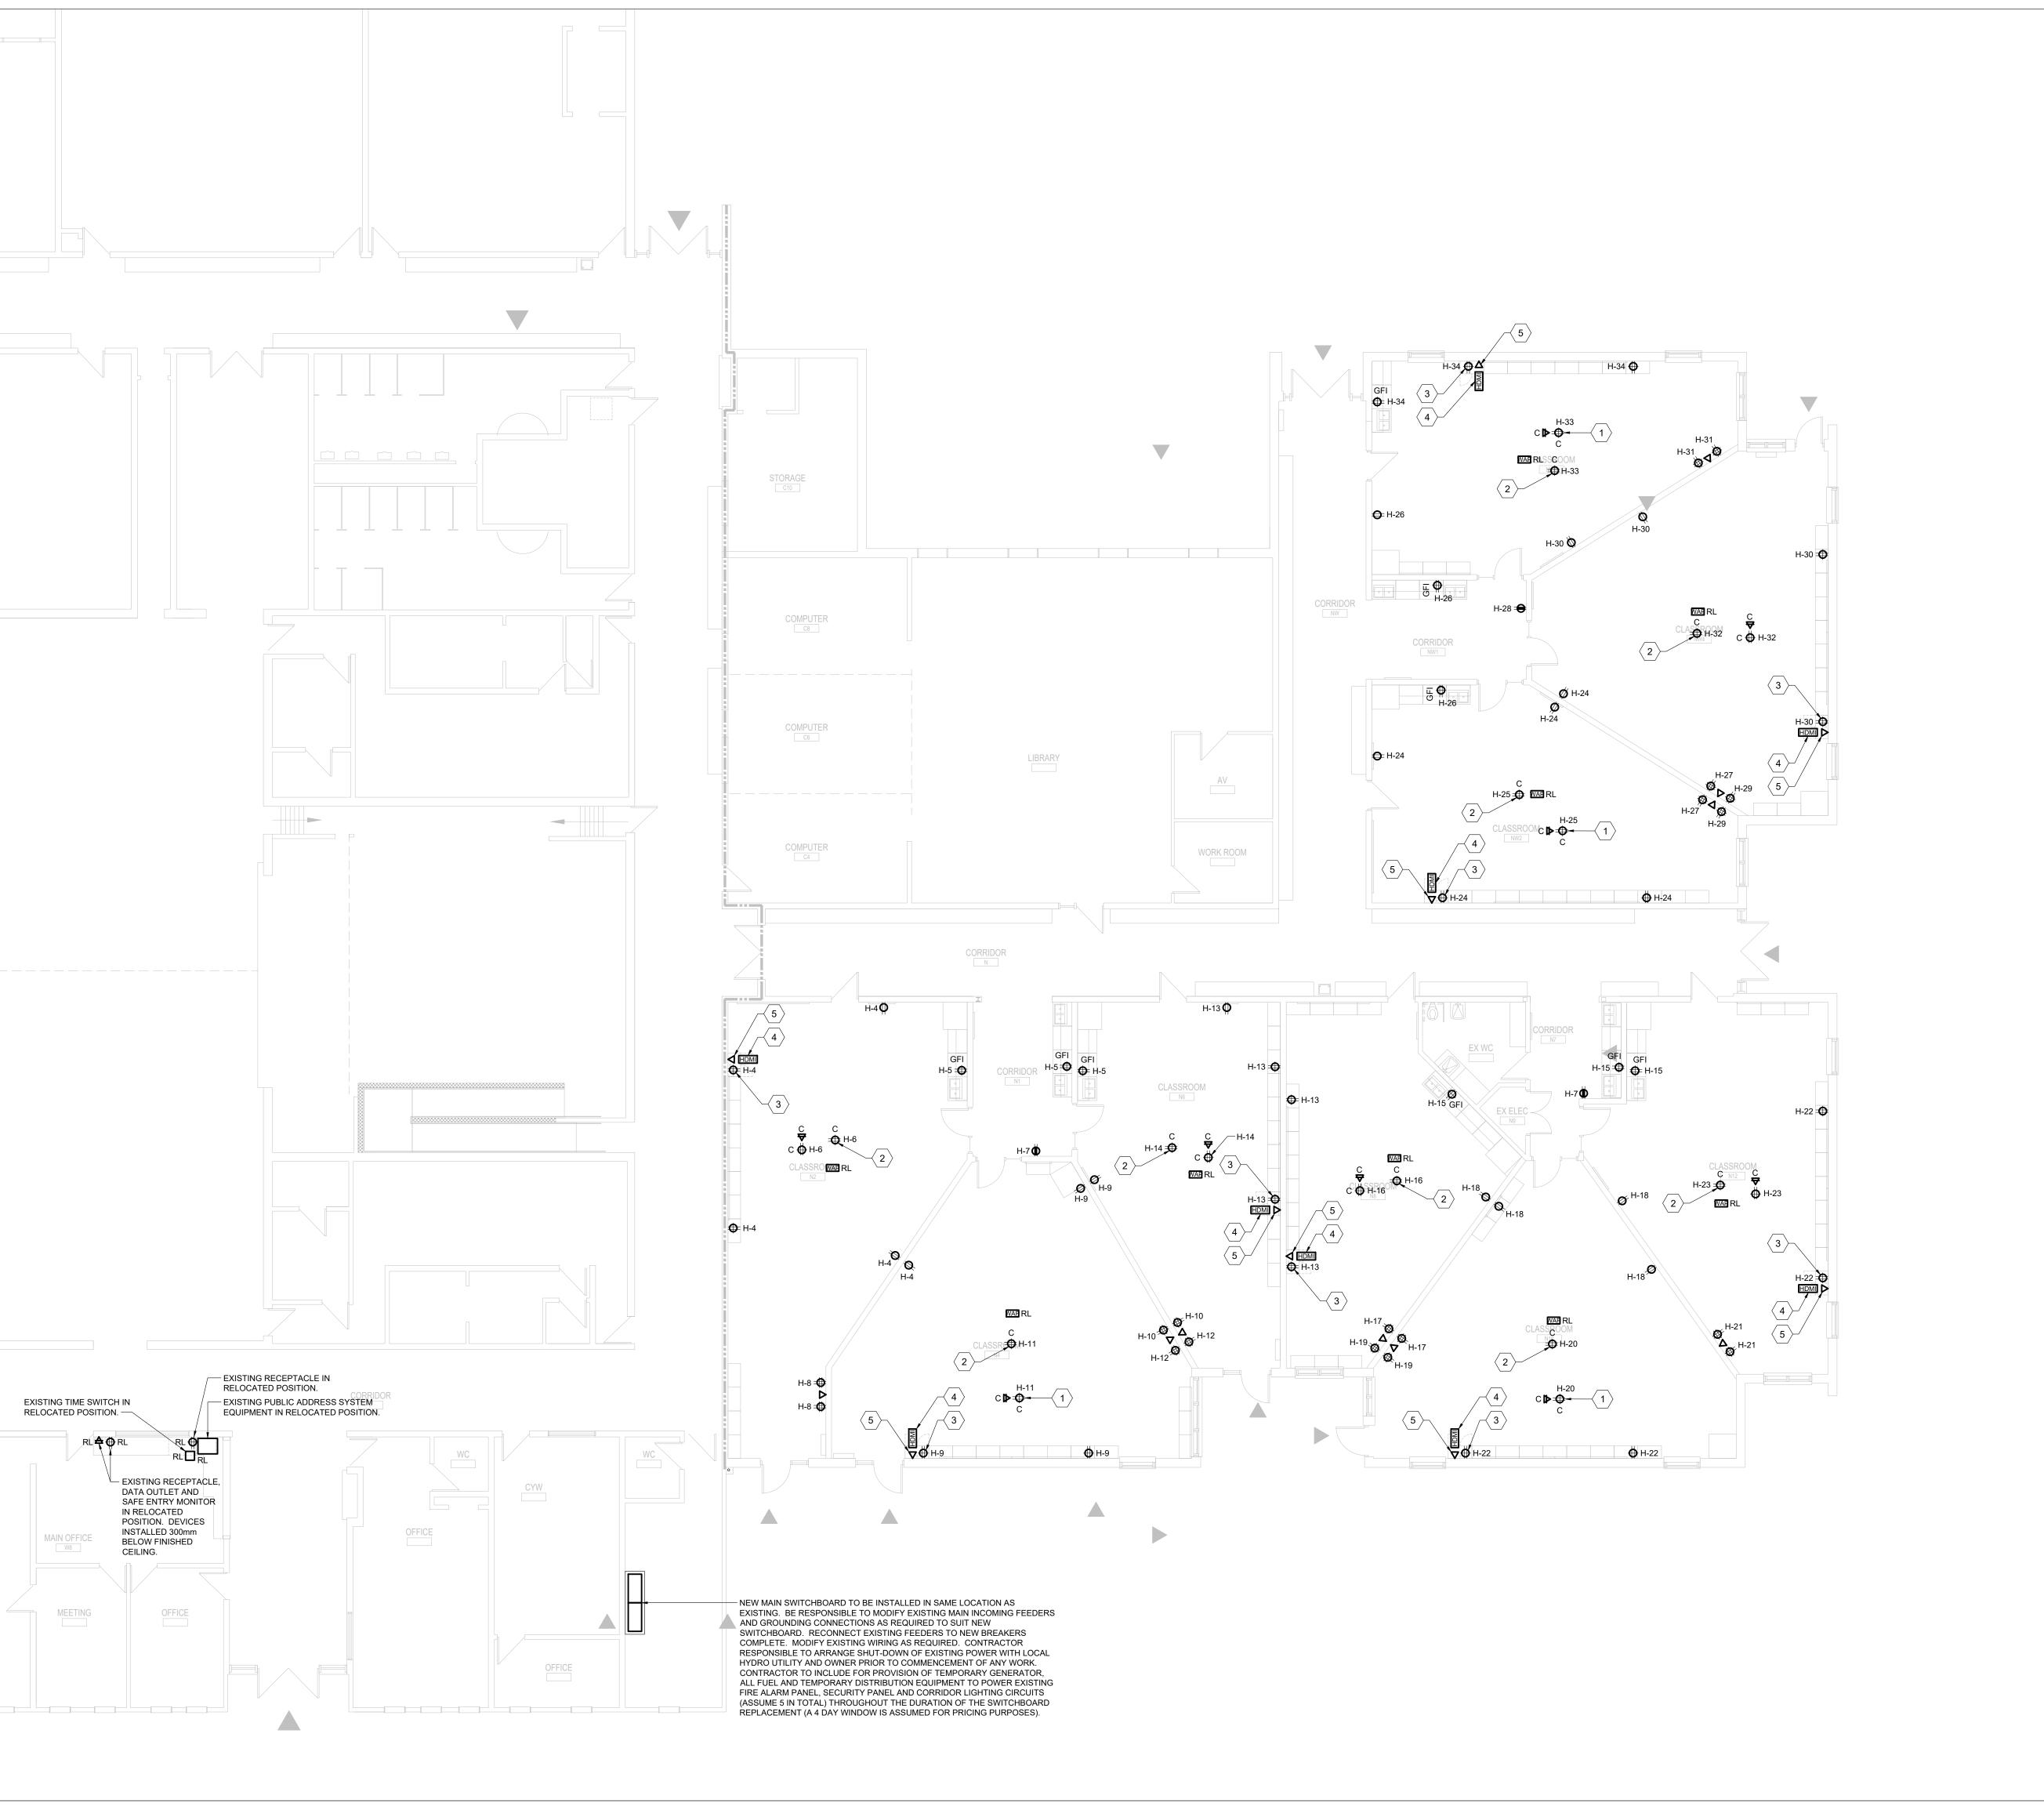
PARTIAL GROUND FLOOR NEW WORK PLAN - LIGHTING

PROJECT NO: ED-20-301
SCALE: 1:100
DRAWN BY: CW

REVIEWED BY: TWS

PROJECT NORTH

DRAWING NO:



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- NEW DEVICES SHOWN ON EXISTING WALL CONSTRUCTION SHALL BE INSTALLED SURFACE MOUNTED ON FS TYPE BACK BOXES WITH SURFACE RACEWAY (LEGRAND WIREMOLD 400 SERIES OR EQUIVALENT - WHITE), FROM DEVICE UP TO CEILING SPACE. CONDUIT SHALL BE PROVIDED ABOVE CEILING SPACE IN ALL LOCATIONS. COORDINATE INSTALLATION WITH GENERAL CONTRACTOR AND CURRENT HAZARDOUS MATERIALS SURVEY.
- FOR NEW BRANCH CIRCUITS NOTED ON THE FLOOR PLANS, PROVIDE A NEW 15A-1P BREAKER WITHIN EXISTING PANEL INDICATED AND EXTEND NEW FEEDERS TO EXISTING PANEL AND CONNECT COMPLETE.

NEW WORK KEY NOTES:

- RECEPTACLE WITHIN CEILING SPACE FOR CEILING MOUNTED PROJECTOR. PROJECTOR TO BE SUPPLIED BY OWNER AND INSTALLED BY ELECTRICAL CONTRACTOR. CONTRACTOR RESPONSIBLE TO PROVIDE SUITABLE CEILIN MOUNT SUPPORT BRACKET AND EXTENSION ARM FOR PROJECTOR. PROJECTOR MODEL TO BE SUPPLIED IS OPTOMA #ZW400. CONNECT RECEPTACLE TO BRANCH CIRCUIT NOTED WITH 2#10 + GROUND IN 21mm CONDUIT.
- RECEPTACLE WITHIN CEILING SPACE FOR "TOP CAT" CEILING MOUNT AUDIO SYSTEM. AUDIO SYSTEM SUPPLIED BY OWNER AND INSTALLED AND CONNECTED BY ELECTRICAL CONTRACTOR. CONNECT RECEPTACLE TO BRANCH CIRCUIT NOTED WITH 2#10 + GROUND IN 21mm
- RECEPTACLE AND "TOP CAT" AUDIO SYSTEM MEDIA $^{
 angle}$ connector installed above millwork unit. Connec RECEPTACLE TO BRANCH CIRCUIT NOTED WITH 2#10 + GROUND IN 21mm CONDUIT. PROVIDE SINGLE COMPARTMENT SURFACE RACEWAY ON FINISHED WALL FROM RECEPTACLE UP TO CEILING SPACE AND CONDUIT FROM CEILING TO PANELBOARD NOTED.
- SINGLE GANG BACKBOX FOR HDMI WALL PLATE INSTALLED ABOVE MILLWORK UNIT. EXTEND SINGLE COMPARTMENT SURFACE RACEWAY FROM BACKBOX TO ABOVE CEILING AND 41mm CONDUIT, COMPLETE WITH PULL STRING, FROM SURFACE RACEWAY TO TERMINATE WITHIN CEILING SPACE ABOVE NEW PROJECTOR LOCATION. HDMI WALL PLATE AND WIRING TO BE SUPPLIED BY OWNER AND INSTALLED BY ELECTRICAL CONTRACTOR. COORDINATE WITH WRDSB I.T DEPARTMENT DURING CONSTRUCTION.
- SINGLE GANG BACKBOX FOR DATA OUTLET TO BE INSTALLED ABOVE MILLWORK UNIT. EXTEND SINGLE COMPARTMENT SURFACE RACEWAY FROM BACKBOX TO ABOVE CEILING, AND TERMINATE WITHIN CEILING SPACE OF ROOM. DATA OUTLET AND CABLING TO BE SUPPLIED AND INSTALLED BY WRDSB PREFERRED VENDOR. COORDINATE WITH WRDSB I.T. DEPARTMENT AND VENDOR DURING CONSTRUCTION.



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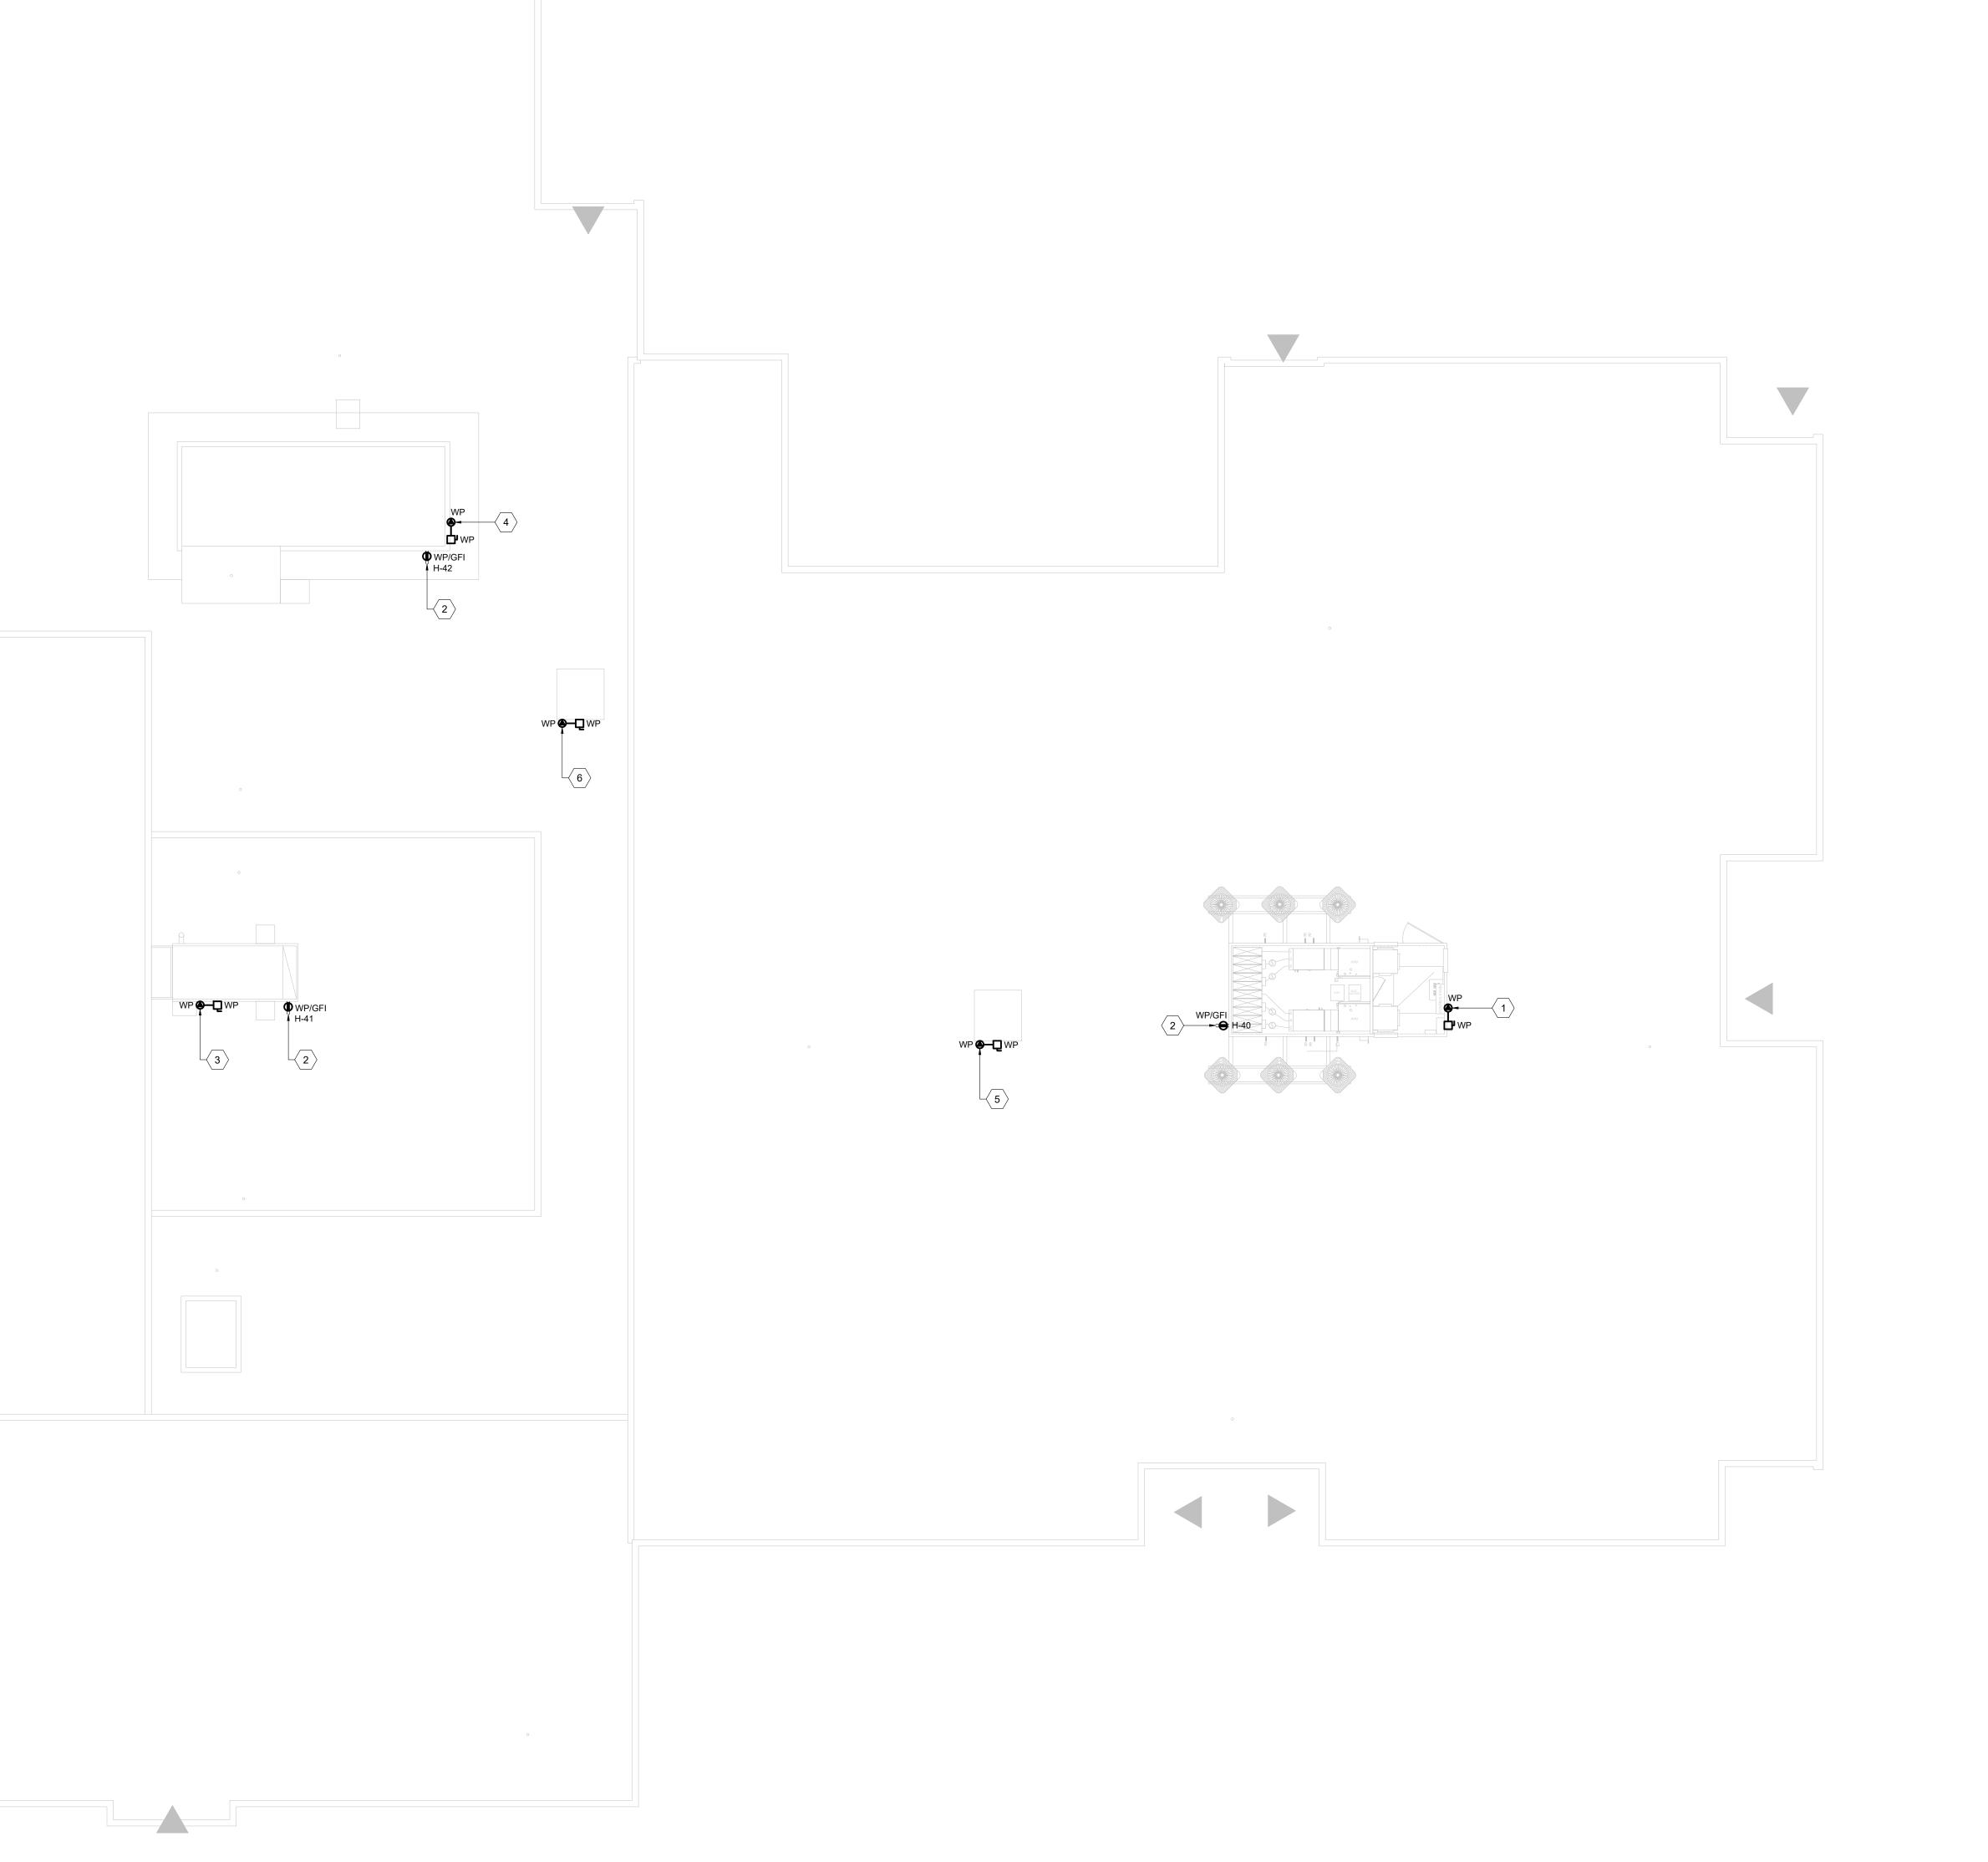
DRAWING TITLE:

PARTIAL GROUND FLOOR NEW WORK PLAN - POWER & SYSTEMS

PROJECT NORTH

PROJECT NO: ED-20-301 SCALE: DRAWN BY: **REVIEWED BY: TWS**

DRAWING NO:



GENERAL NEW WORK NOTES

BE RESPONSIBLE TO COORDINATE ALL FINAL EQUIPMENT LOCATIONS AND ELECTRICAL CONNECTIONS TO MECHANICAL EQUIPMENT WITH MECHANICAL CONTRACTOR ON SITE.

NEW WORK SHEET KEYNOTES

- CONNECTION TO ROOF MOUNTED UNIT 'HVAC-1'. EXTEND 3#2/0 + 1#6
 GROUND IN 78mm (3") CONDUIT FROM UNIT TO BREAKER IN NEW MAIN
 SWITCHBOARD AND CONNECT COMPLETE. ANY NEW ROOF PENETRATIONS
 SHALL BE PROPERLY SEALED AND MADE WEATHER AND WATER TIGHT.
 MAINTAIN ANY EXISTING FIRE RATING. UNIT MOUNTED DISCONNECT
 SWITCH SUPPLIED AND INSTALLED BY ELECTRICAL CONTRACTOR.
- CONNECTION TO ROOF MOUNTED SERVICE RECEPTACLE. FOR BRANCH CIRCUIT NOTED, EXTEND 2#10 + GROUND IN 21mm CONDUIT FROM RECEPTACLE FROM A SPARE 20A-1P BREAKER IN PANEL 'LP-H' AND CONNECT COMPLETE. REFER TO PANEL SCHEDULES FOR BREAKER REQUIREMENTS. ANY NEW ROOF PENETRATIONS SHALL BE PROPERLY SEALED AND MADE WEATHER AND WATER TIGHT. MAINTAIN ANY EXISTING FIRE RATING. RECEPTACLE TO BE PROVIDED BY ELECTRICAL CONTRACTOR AND INSTALLED ON NEW ROOF MOUNTED AIR HANDLING UNIT. COORDINATE INSTALLATION WITH MECHANICAL CONTRACTOR ON SITE
- CONNECTION TO ROOF MOUNTED UNIT 'HV-1'. EXTEND 3#4 + GROUND IN 41mm (1.5") CONDUIT FROM UNIT TO TO BREAKER IN NEW MAIN SWITCHBOARD AND CONNECT COMPLETE. ANY NEW ROOF PENETRATIONS SHALL BE PROPERLY SEALED AND MADE WEATHER AND WATER TIGHT. MAINTAIN ANY EXISTING FIRE RATING. UNIT MOUNTED DISCONNECT SWITCH SUPPLIED AND INSTALLED BY ELECTRICAL CONTRACTOR.
- CONNECTION TO ROOF MOUNTED UNIT 'HVAC-2'. EXTEND 3#2/0 + 1#6
 GROUND IN 78mm (3") CONDUIT FROM UNIT TO BREAKER IN NEW MAIN
 SWITCHBOARD AND CONNECT COMPLETE. ANY NEW ROOF PENETRATIONS
 SHALL BE PROPERLY SEALED AND MADE WEATHER AND WATER TIGHT.
 MAINTAIN ANY EXISTING FIRE RATING. UNIT MOUNTED DISCONNECT
 SWITCH SUPPLIED AND INSTALLED BY ELECTRICAL CONTRACTOR.
- CONNECTION TO ROOF MOUNTED UNIT 'ERV-1'. EXTEND 3#6 + GROUND IN 27mm (1") CONDUIT FROM UNIT TO TO BREAKER IN NEW MAIN SWITCHBOARD AND CONNECT COMPLETE. ANY NEW ROOF PENETRATIONS SHALL BE PROPERLY SEALED AND MADE WEATHER AND WATER TIGHT. MAINTAIN ANY EXISTING FIRE RATING. UNIT MOUNTED DISCONNECT SWITCH SUPPLIED AND INSTALLED BY ELECTRICAL CONTRACTOR.
- CONNECTION TO ROOF MOUNTED UNIT 'ERV-2'. EXTEND 3#8 + GROUND IN 27mm (1") CONDUIT FROM UNIT TO TO BREAKER IN NEW MAIN SWITCHBOARD AND CONNECT COMPLETE. ANY NEW ROOF PENETRATIONS SHALL BE PROPERLY SEALED AND MADE WEATHER AND WATER TIGHT. MAINTAIN ANY EXISTING FIRE RATING. UNIT MOUNTED DISCONNECT SWITCH SUPPLIED AND INSTALLED BY ELECTRICAL CONTRACTOR.



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WEB: WWW.QUASARCG.COM

FOR QUESTIONS REGARDING THIS PROJECT PLEASE EMAIL: ED-20-301@QUASARCG.COM

ISSUE	DATE:	
4	2022-02-11	ISSUED FOR TENDER
3	2022-01-31	ISSUED FOR 90% CD REVIEW
2	2022-01-19	ISSUED FOR PERMIT
1	2021-12-20	ISSUED FOR REVIEW
NO	DATE	DESCRIPTION

PROJECT:

Park Manor Public School - Phase 2 Renovations

DRAWING TITLE:


PARTIAL ROOF NEW WORK PLAN
- ELECTRICAL

PROJECT NO: ED-20-301
SCALE: 1:100
DRAWN BY: CW

REVIEWED BY: TWS

PROJECT NORTH:

DRAWING NO:

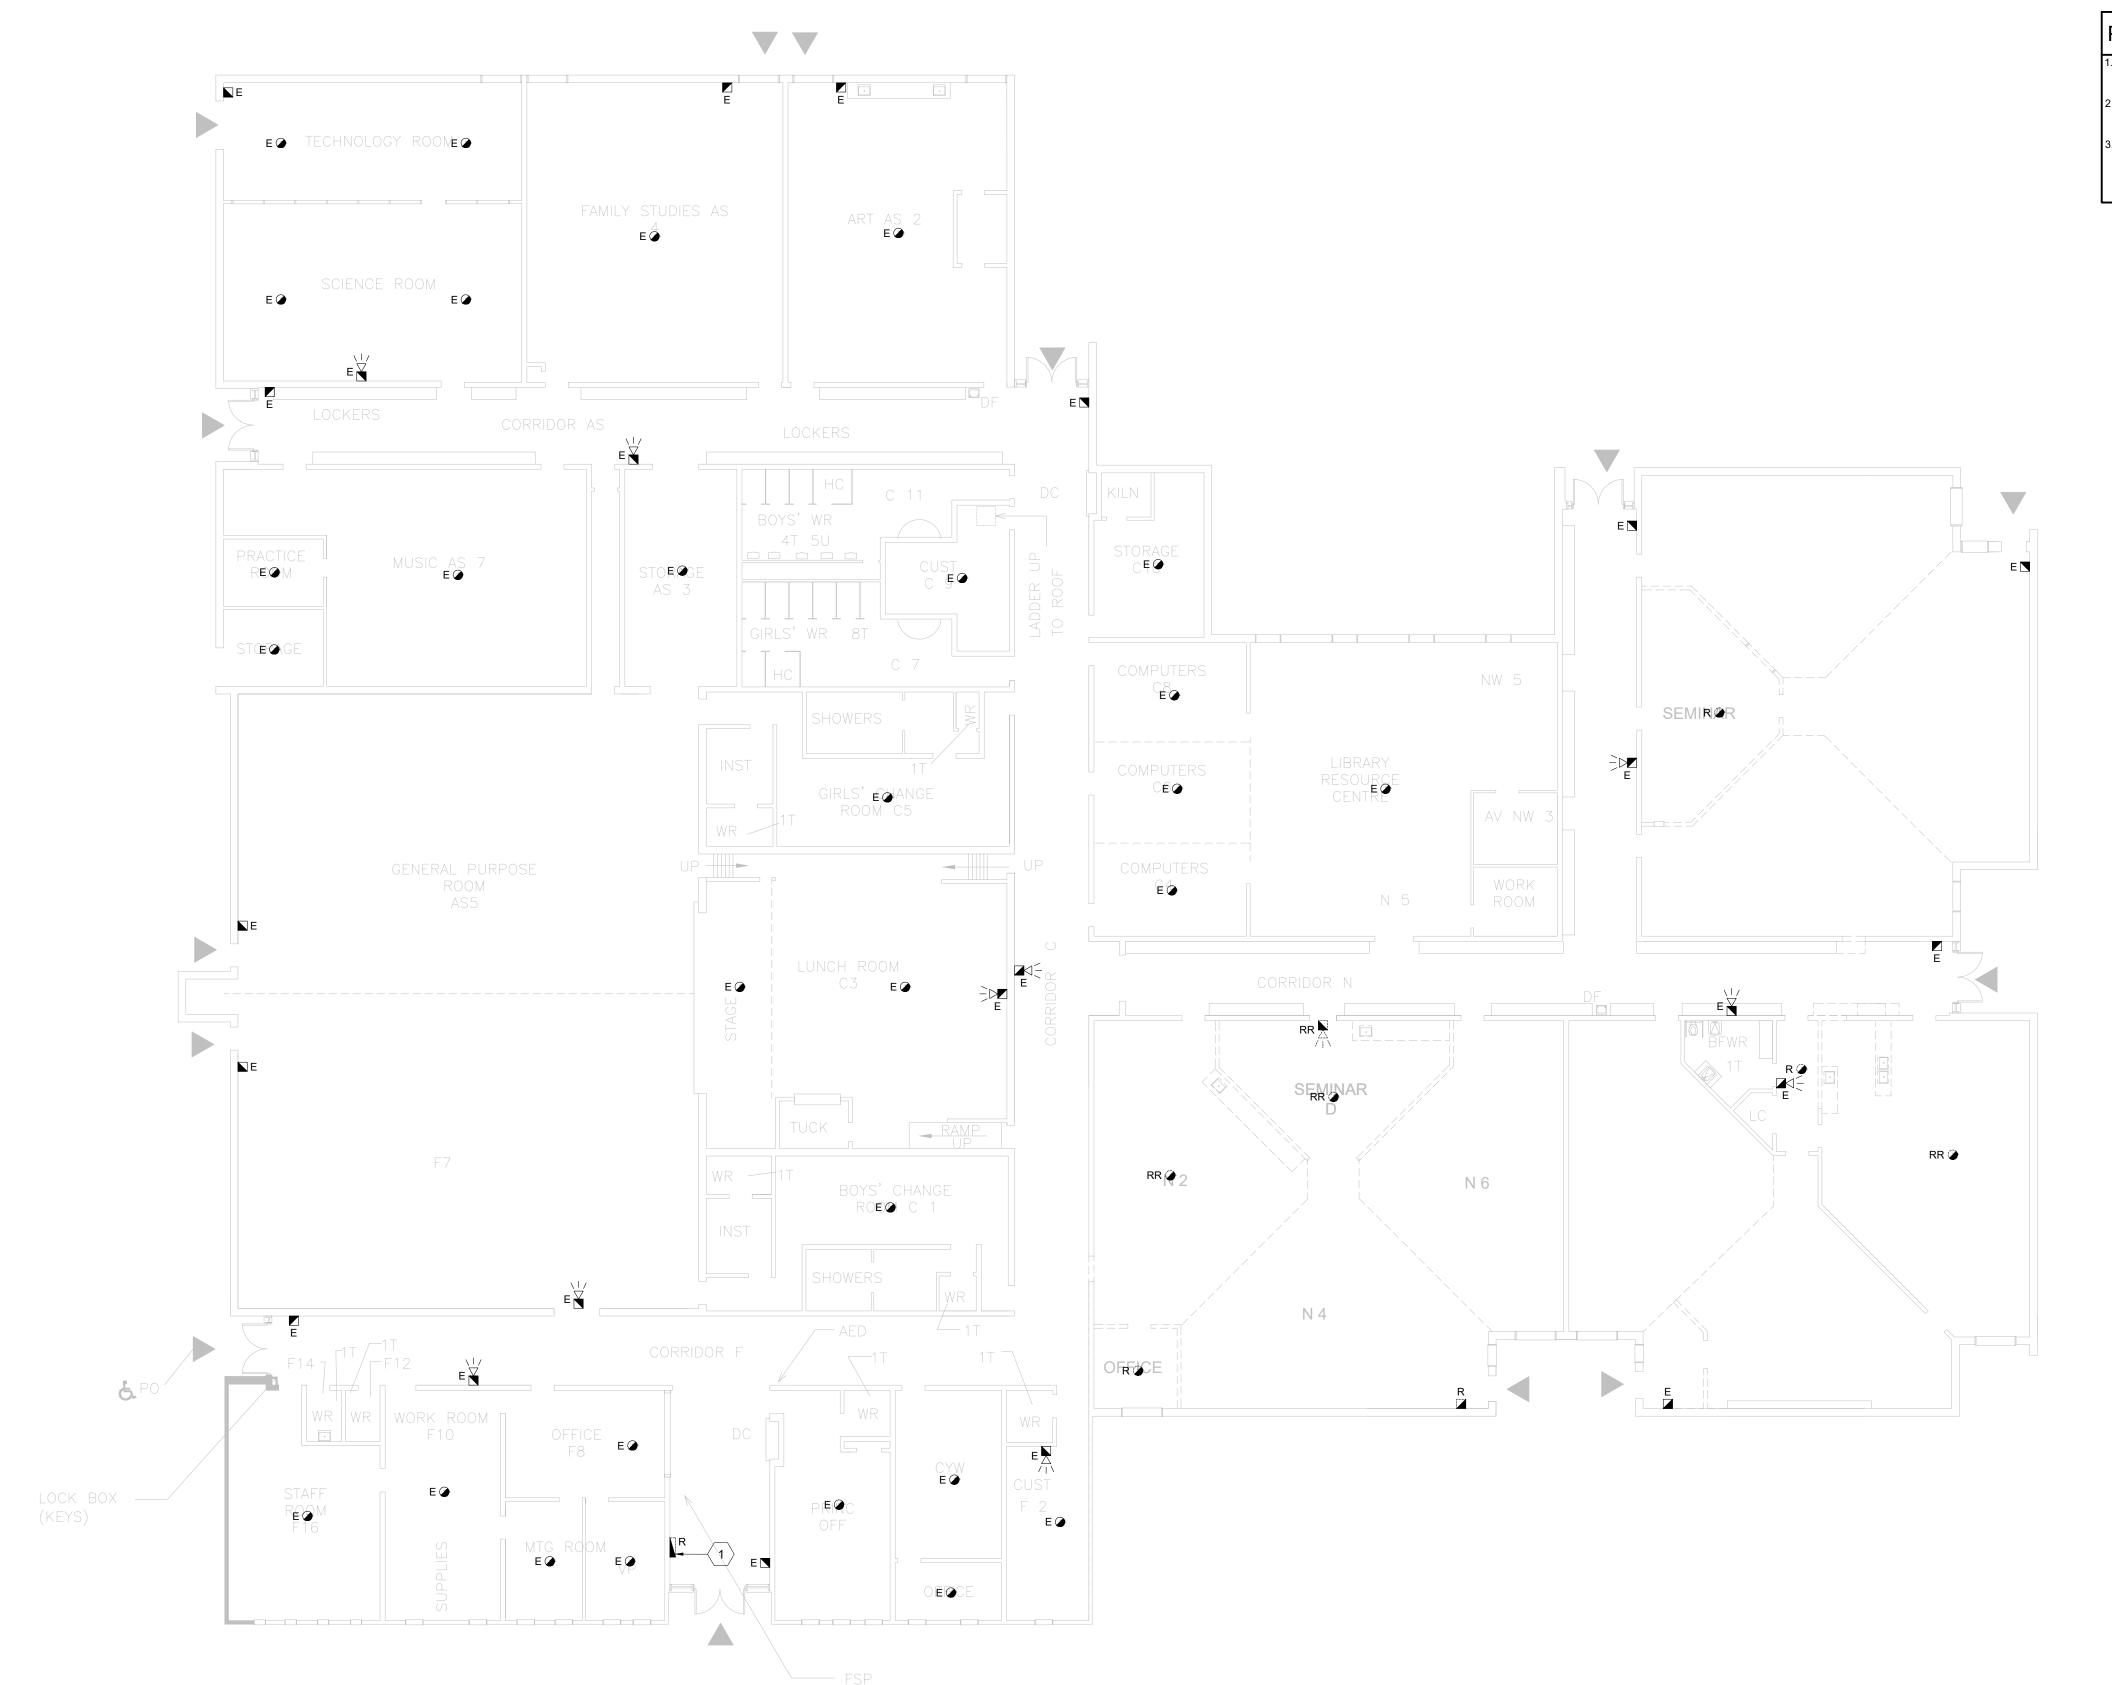

GENERAL NOTES

ALL EXISTING ALARM INITIATING AND SIGNALLING DEVICES ARE TO REMAIN AS EXISTING. REPLACEMENT OF THE EXISTING DEVICES IS NOT TO BE INCLUDED IN THE SCOPE OF WORK FOR THIS PROJECT.

EXISTING FIRE ALARM PASSIVE GRAPHIC TO REMAIN AS CURRENTLY INSTALLED ADJACENT TO EXISTING FIRE ALARM CONTROL PANEL. REPLACEMENT OF THIS EQUIPMENT IS NOT TO BE INCLUDED IN THE SCOPE OF WORK FOR THIS PROJECT

SHEET KEY NOTES

EXISTING FIRE ALARM CONTROL PANEL TO BE REMOVED AND REPLACED WITH NEW. REPLACEMENT OF PANEL IS DUE TOAND LACK OF AVAILABILITY OF SPARE PARTS FOR EXPANSION. ALL EXISTING ZONES TO BE RECONNECTED TO NEW PANEL COMPLETE. TEST AND VERIFY NEW PANEL UPON COMPLETION OF WORK.

PERMIT NOTES

- PROJECT IS BEING PERFORMED AS A "VOLUNTARY REPLACEMENT" UNDER THE RETROFIT REQUIREMENTS DESCRIBED IN PART 9 - RETROFIT, SECTION 9.6 OF THE 2007 ONTARIO FIRE CODE.
- REPLACEMENT OF FIRE ALARM PANEL, AS INDICATED IS BEING PERFORMED BASED ON THE REQUIREMENTS OF PART 11 - RENOVATION. REFER TO 2012 OBC, DIV A. 1.1.2.6.
- 2012 OBC DIV B. 11.3.1.1.(1) WHERE AN EXISTING BUILDING SYSTEM IS MATERIALLY ALTERED OR REPAIRED, THE PERFORMANCE LEVEL OF THE BUILDING AFTER THE MATERIAL ALTERNATION OR REPAIR SHALL BE AT LEAST EQUAL TO THE PERFORMANCE LEVEL OF THE BUILDING PRIOR TO THE MATERIAL ALTERATION OF




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PROJECT:

Park Manor Public School - Phase 2 Renovations

DRAWING TITLE:


FIRE ALARM DEMOLITION PLAN

PROJECT NO: ED-20-301 SCALE: DRAWN BY: CW

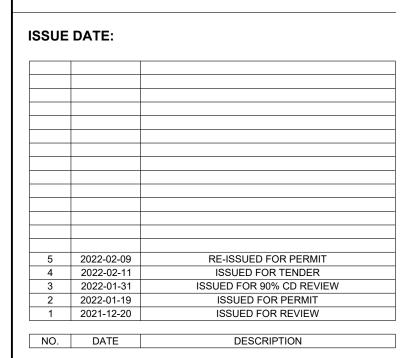REVIEWED BY: TWS

PROJECT NORTH:

DRAWING NO:

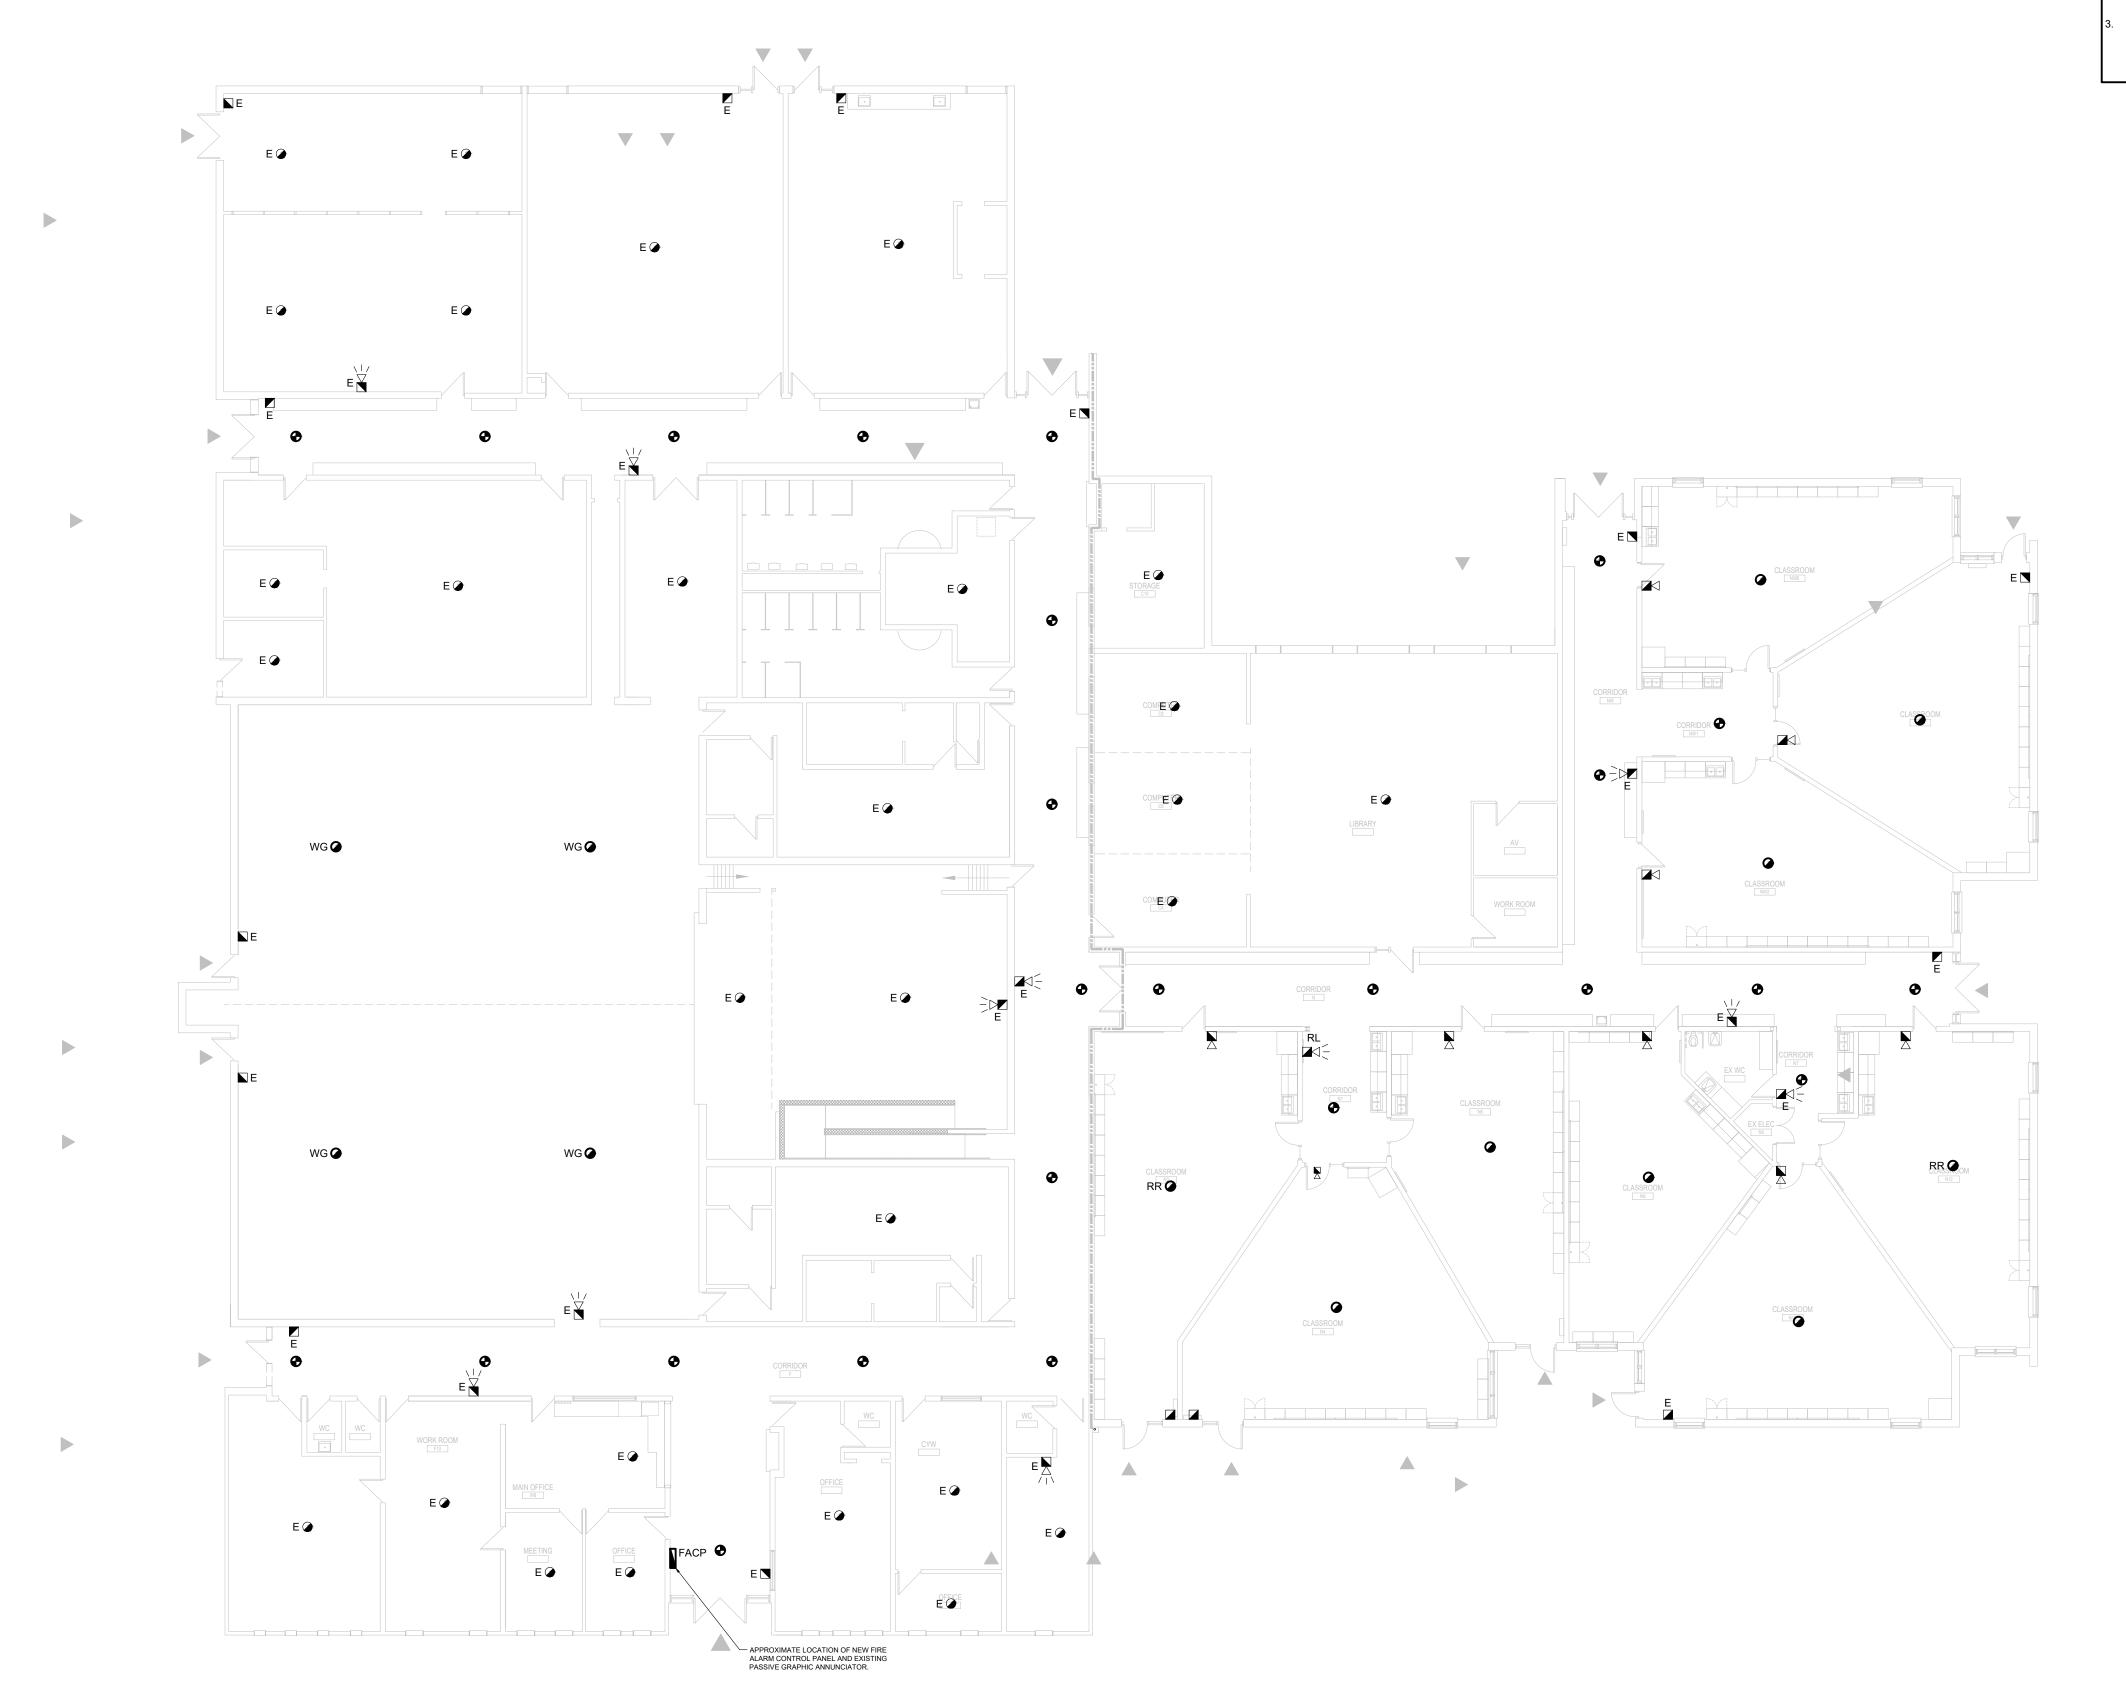

GENERAL NOTES

PROVIDE NEW FIRE ALARM INITIATING DEVICES AS INDICATED AND CONNECT INTO NEAREST EXISTING ALARM INITIATING ZONE. MODIFY EXISTING ZONE WIRING AS REQUIRED TO ACCOMMODATE NEW DEVICES

PROVIDE NEW FIRE ALARM SIGNALLING DEVICES AS INDICATED AND CONNECT INTO NEAREST EXISTING ALARM SIGNALLING ZONE. INCLUDE FOR PROVISION OF NEW BOOSTERS, ETC. AS REQUIRED TO CONNECT NEW DEVICES.

PERMIT NOTES

PROJECT IS BEING PERFORMED AS A "VOLUNTARY REPLACEMENT" UNDER THE RETROFIT REQUIREMENTS DESCRIBED IN PART 9 - RETROFIT, SECTION 9.6 OF THE 2007 ONTARIO FIRE CODE.

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DIV A. 1.1.2.6.

2012 OBC DIV B. 11.3.1.1.(1) WHERE AN EXISTING BUILDING SYSTEM IS MATERIALLY ALTERED OR REPAIRED, THE PERFORMANCE LEVEL OF THE BUILDING AFTER THE MATERIAL ALTERNATION OR REPAIR SHALL BE AT LEAST EQUAL TO THE PERFORMANCE LEVEL OF THE BUILDING PRIOR TO THE MATERIAL ALTERATION OR

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5	2022-02-09	RE-ISSUED FOR PERMIT
4	2022-02-11	ISSUED FOR TENDER
3	2022-01-31	ISSUED FOR 90% CD REVIEW
2	2022-01-19	ISSUED FOR PERMIT
1	2021-12-20	ISSUED FOR REVIEW

PROJECT:

Park Manor Public School - Phase 2 Renovations

DRAWING TITLE:

FIRE ALARM NEW WORK PLAN

PROJECT NO: ED-20-301
SCALE: 1:150
DRAWN BY: CW

REVIEWED BY: TWS

PROJECT NORTH:

DRAWING NO:

	SCHEDULE 26 06 50.16 - LIGHTING FIXTURE SCHEDULE							
SYMBOL	TYPE	DESCRIPTION	REFERENCE	REMARKS				
	L1	RECESSED 2' x 4' LED TROFFER STYLE LUMINAIRE COMPLETE WITH WHITE FINISH, AND ACRYLIC LENS.	COOPER LIGHTING SOLUTIONS 24EN SERIES CAT.#24EN-LD2-34-UNV-L840-CD1-U	120V 28W	3400 LUMEN 4000K	RECESSED T-BAR CEILING		
LIGHTING FIX 1. UNLESS NO LIGHTING), VI 2. WHERE AN 3. SUBMIT SH	OTED OTHI SCOR/VISI NINCOMPL							

SCHEDULE 26 06 50.23 - LIGHTING CONTROL DEVICE SCHEDULE								
SYMBOL	TYPE	DESCRIPTION	BASIS OF DESIGN MANUFACTURERS AND PRODUCT SERIES	CONTROL WIRING	VOLTAGE OUTPUT	MOUNTING	SPECIFICATION SPACES SERVED	REMARKS
Z1, Z2	UI-DIM-NV-X B	DIMMING WALL STATION, MULTI-BUTTON WALL INTERFACE CONTROL C/W ENGRAVED BUTTONS. BUTTONS: EACH ZONE CONTROLLED (SEE PLANS), DIM UP, DIM DOWN, ALL OFF, ALL ON 'X' DENOTES NUMBER OF CONTROLLED ZONES	ACUITY BRANDS CONTROLS/nLIGHT NPODM SERIES PHILIPS REVOLUTION SERIES DR2PA	DIGITAL	-	WALL	26 09 43	
- ©T	DT-W-2V	WALL MOUNT OCCUPANCY SENSOR, 24 V, DUAL TECHNOLOGY SENSOR, MIN 1200 SQ FT COVERAGE	PHILIPS OCCUSWITCH CLASSIC LRM2265 SERIES WATTSTOPPER DT-200 SERIES		24 V	WALL, +/- 12 FEET AFF	26 09 23	
(DT)	DT-C-2V	CEILING MOUNTED OCCUPANCY SENSOR, 24 V. DUAL TECHNOLOGY SENSOR.	LEGRAND/WATTSTOPPER DT-300 SERIES LUTRON LOS-CDT SERIES		24 V		26 09 23	

LIGHTING CONTROLS OF ONE MANUFACTURER THROUGH PROJECT TO ENSURE PRODUCT COMPATIBILITY.

2. ALTERNATE MANUFACTURERS: ACUITY BRANDS LIGHTING (SENORSWITCH, nLIGHT), COOPER LIGHTING SOLUTIONS, DOUGLAS LIGHTING CONTROLS, LUTRON, SIGNIFY (FORMERLY PHILIPS LIGHTING), WATTSTOPPER-LEGRAND. 3. DUAL TECHNOLOGY SENSORS: PASSIVE INFRARED/ULTRASONIC, OR PASSIVE INFRARED/MICROPHONIC, DEPENDING ON MANUFACTURER. MICROPHONIC SENSORS ACCEPTABLE IN LIEU OF ULTRASONIC.

4. POSITION CEILING MOUNTED OCCUPANCY SENSORS A MINIMUM 1200 mm (4'-0") FROM NEAREST AIR DIFFUSER, HVAC OUTLETS, HEATING BLOWERS, ETC.

5. CONFIRM INSTALLATION REQUIREMENTS, WIRING DIAGRAMS, ETC. WITH MANUFACTURER'S DETAILS. 6. SUBMIT SHOP DRAWINGS FOR CONSULTANT'S REVIEW PRIOR TO PLACING ANY ORDER.

7. CONFIRM FINISH COLOUR WITH CONSULTANT DURING SUBMITTAL REVIEW.

	SCHEDULE 26 06 50.19 - EMERGENCY LIGHTING AND EXIT SIGN SCHEDULE								
SYMBOL	TYPE	DESCRIPTION	MANUFACTURER AND PRODUCT SERIES	VOLTAGE	LAMPS	MOUNTING SE	PEC SECTION	REMARKS	
⊠ 1⊗	X1	EXTRUDED ALUMINUM PICTOGRAM EXIT SIGN, UNIVERSAL MOUNTING, FACTORY WHITE FINISH.	-LUMACELL LA SERIES -EMERGILITE EA SERIES -STANPRO RMXL SERIES -BEGHELLI QUADRA RM SERIES	SEE NOTE 2	3W LED	CEILING OR WALL, SURFACE	26 52 13.16	REFER TO FLOOR PLANS FOR MOUNTING ARRANGEMENT	
(2)	X2	SAME AS X1, DOUBLE FACE	-LUMACELL LA SERIES -EMERGILITE EA SERIES -STANPRO RMXL SERIES -BEGHELLI QUADRA RM SERIES	SEE NOTE 2	3W LED	CEILING OR WALL, SURFACE	26 52 13.16	REFER TO FLOOR PLANS FOR MOUNTING ARRANGEMENT	

EMERGENCY LIGHTING FIXTURE & EXIT SIGN SCHEDULE NOTES: . WHERE AN INCOMPLETE MODEL/CAT NO. IS LISTED, MANUFACTURERS/SUPPLIES MUST CONFIRM THE PROPOSED FIXTURE WITH THE CONSULTANT A MINIMUM OF ONE WEEK PRIOR TO TENDER CLOSE. 2. EXIT SIGNS SHALL BE CAPABLE OF UNIVERSAL 120/347V AC AND 6 TO 48V DC INPUT. BATTERY UNITS SHALL BE CAPABLE OF UNIVERSAL 120/347V AC INPUT.


3. FOR EXIT SIGNS, REFER TO ARROWS AND NUMBER OF SHADED FACES AS DIRECTED ON LIGHTING LAYOUT. WHERE ARROWS INDICATE TWO DIRECTIONS, PROVIDE TWO PICTOGRAM STYLE EXIT SIGNS.


4. SUBMIT SHOP DRAWINGS FOR CONSULTANT'S REVIEW PRIOR TO PLACING ANY ORDER. 5. ACCEPTABLE MANUFACTURERS AS NOTED IN SECTION 26 52 13.13 AND SECTION 26 52 13.16. [OR]


5. ACCEPTABLE MANUFACTURERS: AIMLITE, BEGHELLI, EMERGILITE, LUMACELL, STANPRO.

6. REMOTE HEADS CERTIFIED TO CSA C22.2 No. 141. 7. CBCB - "CENTRE BEAM CANDLE POWER."

8. CONFIRM RECOMMENDED SPACING WITH EMERGENCY LIGHTING MANUFACTURER PRIOR TO START OF ROUGH-IN.

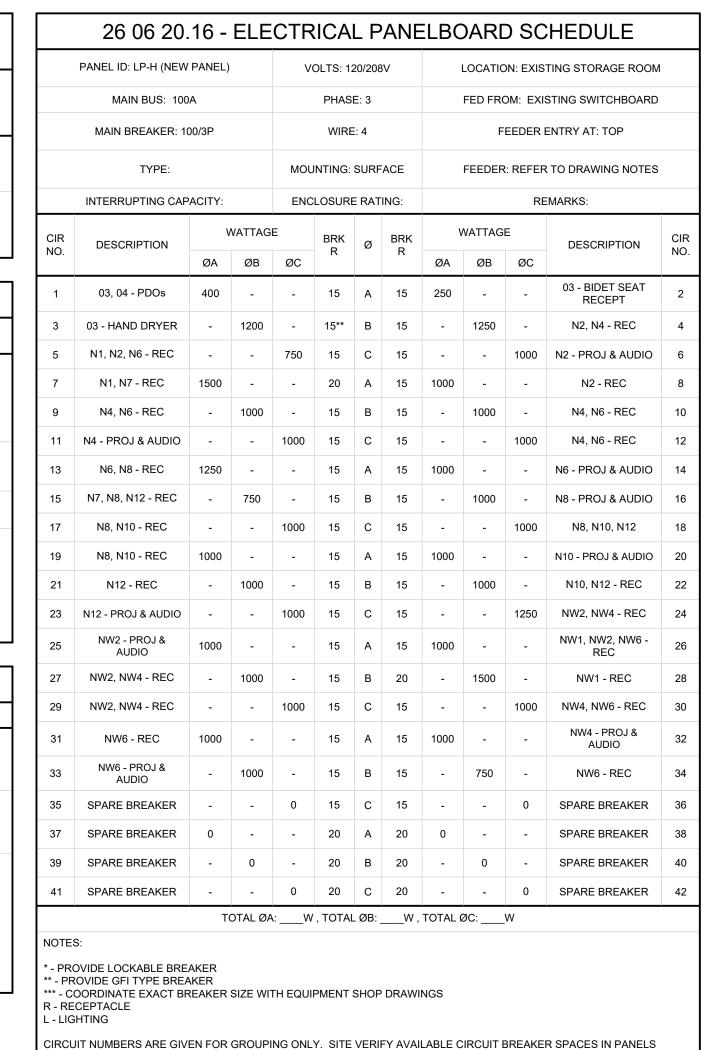

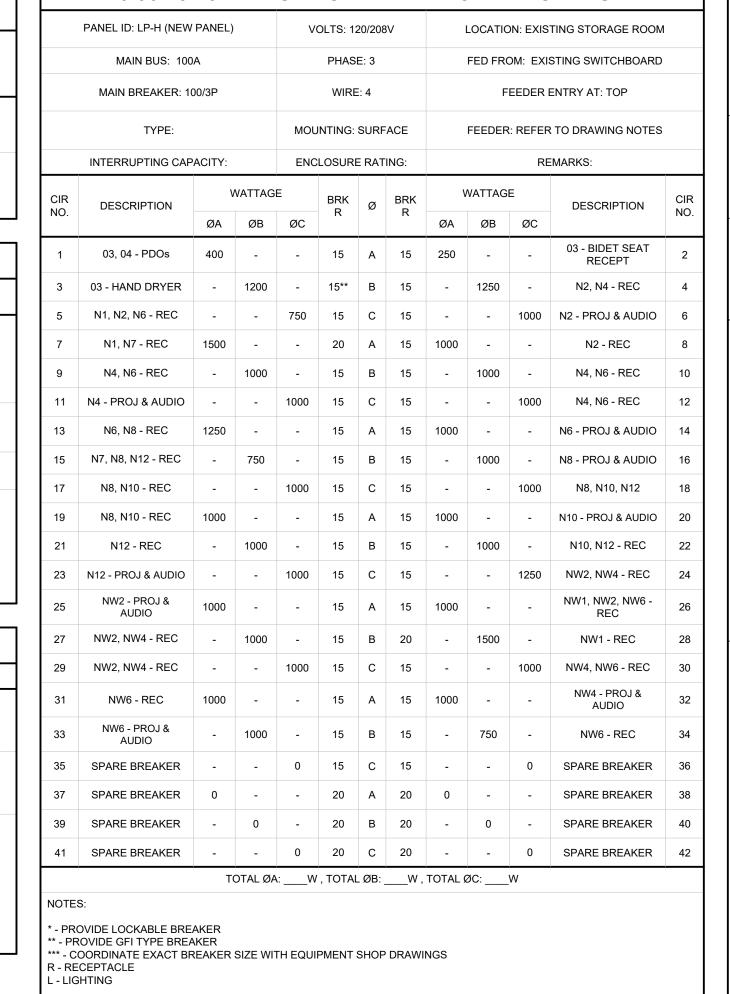

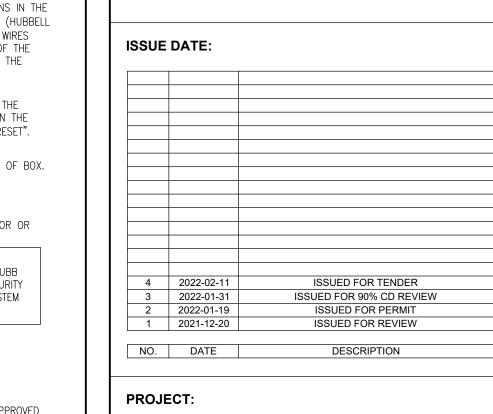

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Park Manor Public School - Phase 2 Renovations

DRAWING TITLE:


SCHEDULES & DETAILS -ELECTRICAL


PROJECT NO: ED-20-301 SCALE: NOT TO SCALE DRAWN BY: **REVIEWED BY: TWS**

PROJECT NORTH:

DRAWING NO:

E401

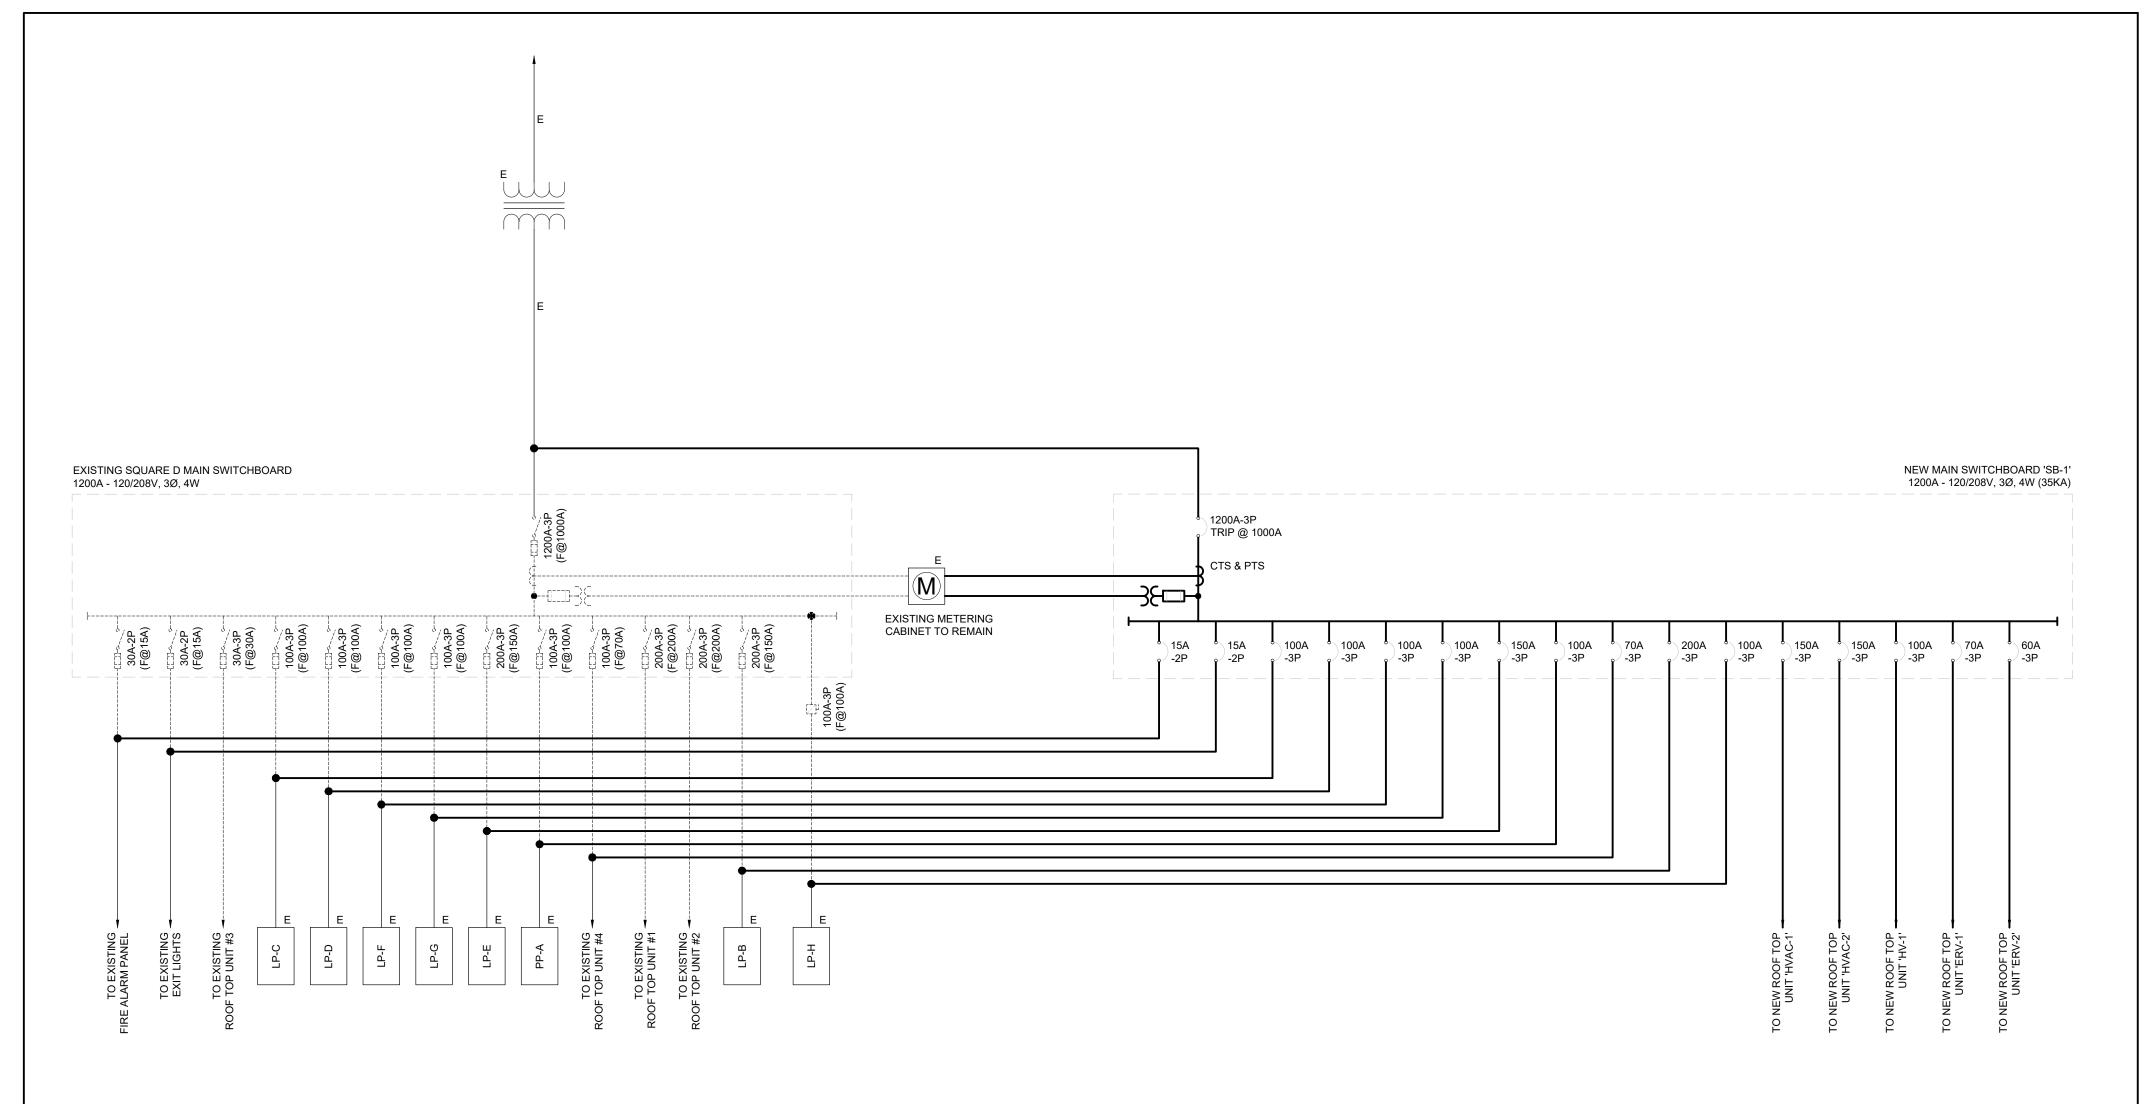

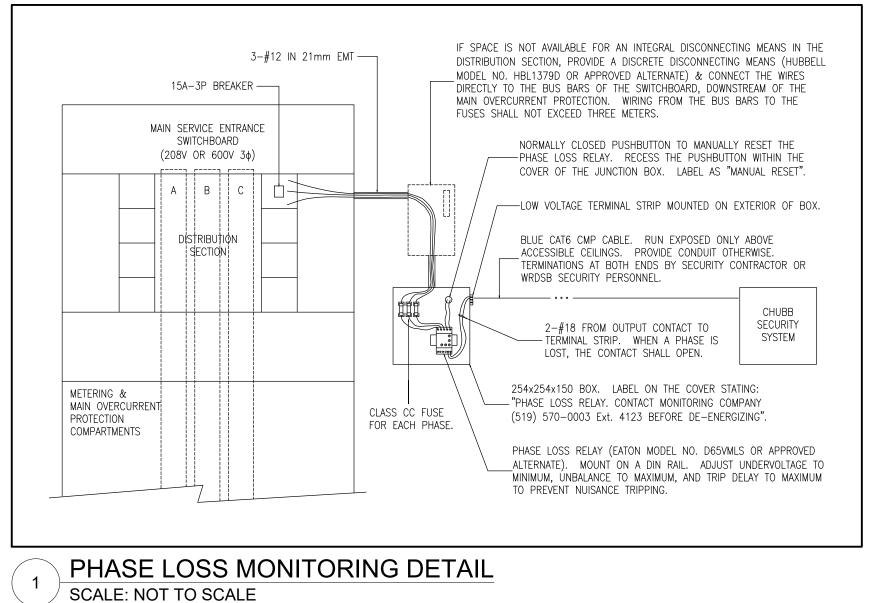

DURING TENDER WALKTHROUGH.

SINGLE LINE DIAGRAM SCALE: NOT TO SCALE