


Ontario Building Code Data Matrix Part 11 – Renovation of Existing Building					Building Code Reference ¹	Ontario Building Code Data Matrix (CONT'D)					Building Code Reference ¹
Name of project: Park Manor Public School		Firm Name and Address: LGA Architectural Partners Inc. 310 Spadina Ave., Suite 100B Toronto, ON M5T 2E8				11.11 Plumbing Fixture Requirements					3.7.4.
Location: 18 Mockingbird Drive Elmira, ON N3B 1T1		Certification of Practice Number: No. 5162				Ratio: M/F = 1/1 Except as otherwise noted					
11.00 Building Code Version: O_Reg. 332/12 Last Amendment O_Reg. 191/14		11.01 Project Type: <input type="checkbox"/> Addition <input checked="" type="checkbox"/> Renovation <input type="checkbox"/> Addition and renovation <input type="checkbox"/> Change of use Description: Basic interior renovation of existing classrooms and office space of existing public school.			[A] 1.1.2.	Floor Level/Area Occupant Load OBC Reference Fixtures Required Fixtures Provided					
11.02 Major Occupancy Classification: Group A, Division 2 Use Elementary School		3.1.2.1.(1)			- - - Existing Water closets to Remain Unchanged - - -						
11.03 Superimposed Major Occupancies: <input checked="" type="checkbox"/> No <input type="checkbox"/> Yes Description:		3.2.2.7.			11.12 Barrier-free Design: Yes _____ No _____					11.3.3.2.(2)	
11.04 Building Area (m2) Description: Basement Ground Floor (north half) Firewall in-between Ground Floor (south half) Total		Existing New Total			[A] 1.4.1.2.	11.13 Reduction in Performance Level: Structural: <input checked="" type="checkbox"/> No <input type="checkbox"/> Yes By increase in occupant load: <input checked="" type="checkbox"/> No <input type="checkbox"/> Yes By change of major occupancy: <input checked="" type="checkbox"/> No <input type="checkbox"/> Yes Plumbing: <input checked="" type="checkbox"/> No <input type="checkbox"/> Yes Sewage-systems: <input checked="" type="checkbox"/> No <input type="checkbox"/> Yes Extension of combustible construction: <input checked="" type="checkbox"/> No <input type="checkbox"/> Yes					11.4.2.1. 11.4.2.2. 11.4.2.3. 11.4.2.4. 11.4.2.5. 11.4.2.6.
11.05 Building Height 1 Storeys above grade 0 Storeys below grade		6.5 (m) Above grade			[A] 1.4.1.2. & 3.2.1.1.	11.14 Compensating Construction: Structural: <input checked="" type="checkbox"/> No <input type="checkbox"/> Yes Increase in occupant load: <input checked="" type="checkbox"/> No <input type="checkbox"/> Yes Change of major occupancy: <input checked="" type="checkbox"/> No <input type="checkbox"/> Yes Plumbing: <input checked="" type="checkbox"/> No <input type="checkbox"/> Yes Sewage systems: <input checked="" type="checkbox"/> No <input type="checkbox"/> Yes Extension of combustible construction: <input checked="" type="checkbox"/> No <input type="checkbox"/> Yes					11.4.3.1. 11.4.3.2. 11.4.3.3. 11.4.3.4. 11.4.3.5. 11.4.3.6. 11.4.3.7.
11.06 Number of Streets/Firefighter access 1		3.2.2.10. & 3.2.5.			11.15 Compliance Alternatives Proposed: <input checked="" type="checkbox"/> No <input type="checkbox"/> Yes					11.5.1.	
11.07 Building Size <input type="checkbox"/> Small <input type="checkbox"/> Medium <input checked="" type="checkbox"/> Large <input type="checkbox"/> > Large		T.11.2.1.1.B.-N.									
11.08 Existing Building Classification: Change in Major Occupancy: <input type="checkbox"/> Yes <input checked="" type="checkbox"/> Not Applicable (no change of major occupancy) Construction Index: N/A Hazard Index: N/A Importance Category: <input type="checkbox"/> Low <input type="checkbox"/> Normal <input type="checkbox"/> High <input type="checkbox"/> Post-disaster N/A		11.2.1.1. T 11.2.1.1A T 11.2.1.1B to N 4.2.1.(3), 5.2.2.1.(2)									
11.09 Renovation type: <input checked="" type="checkbox"/> Basic Renovation <input type="checkbox"/> Extensive Renovation		11.3.3.1. 11.3.3.2.									
11.10 Occupant Load Floor Level/Area Ground Floor		Occupancy Type A2, Division 2 Based On Design Occupant Load (Persons) No Change to Existing			3.1.17.	11.16 Notes:					11.5.1.

¹All references are to Division B of the OBC unless preceded by [A] for Division A and [C] for Division C.

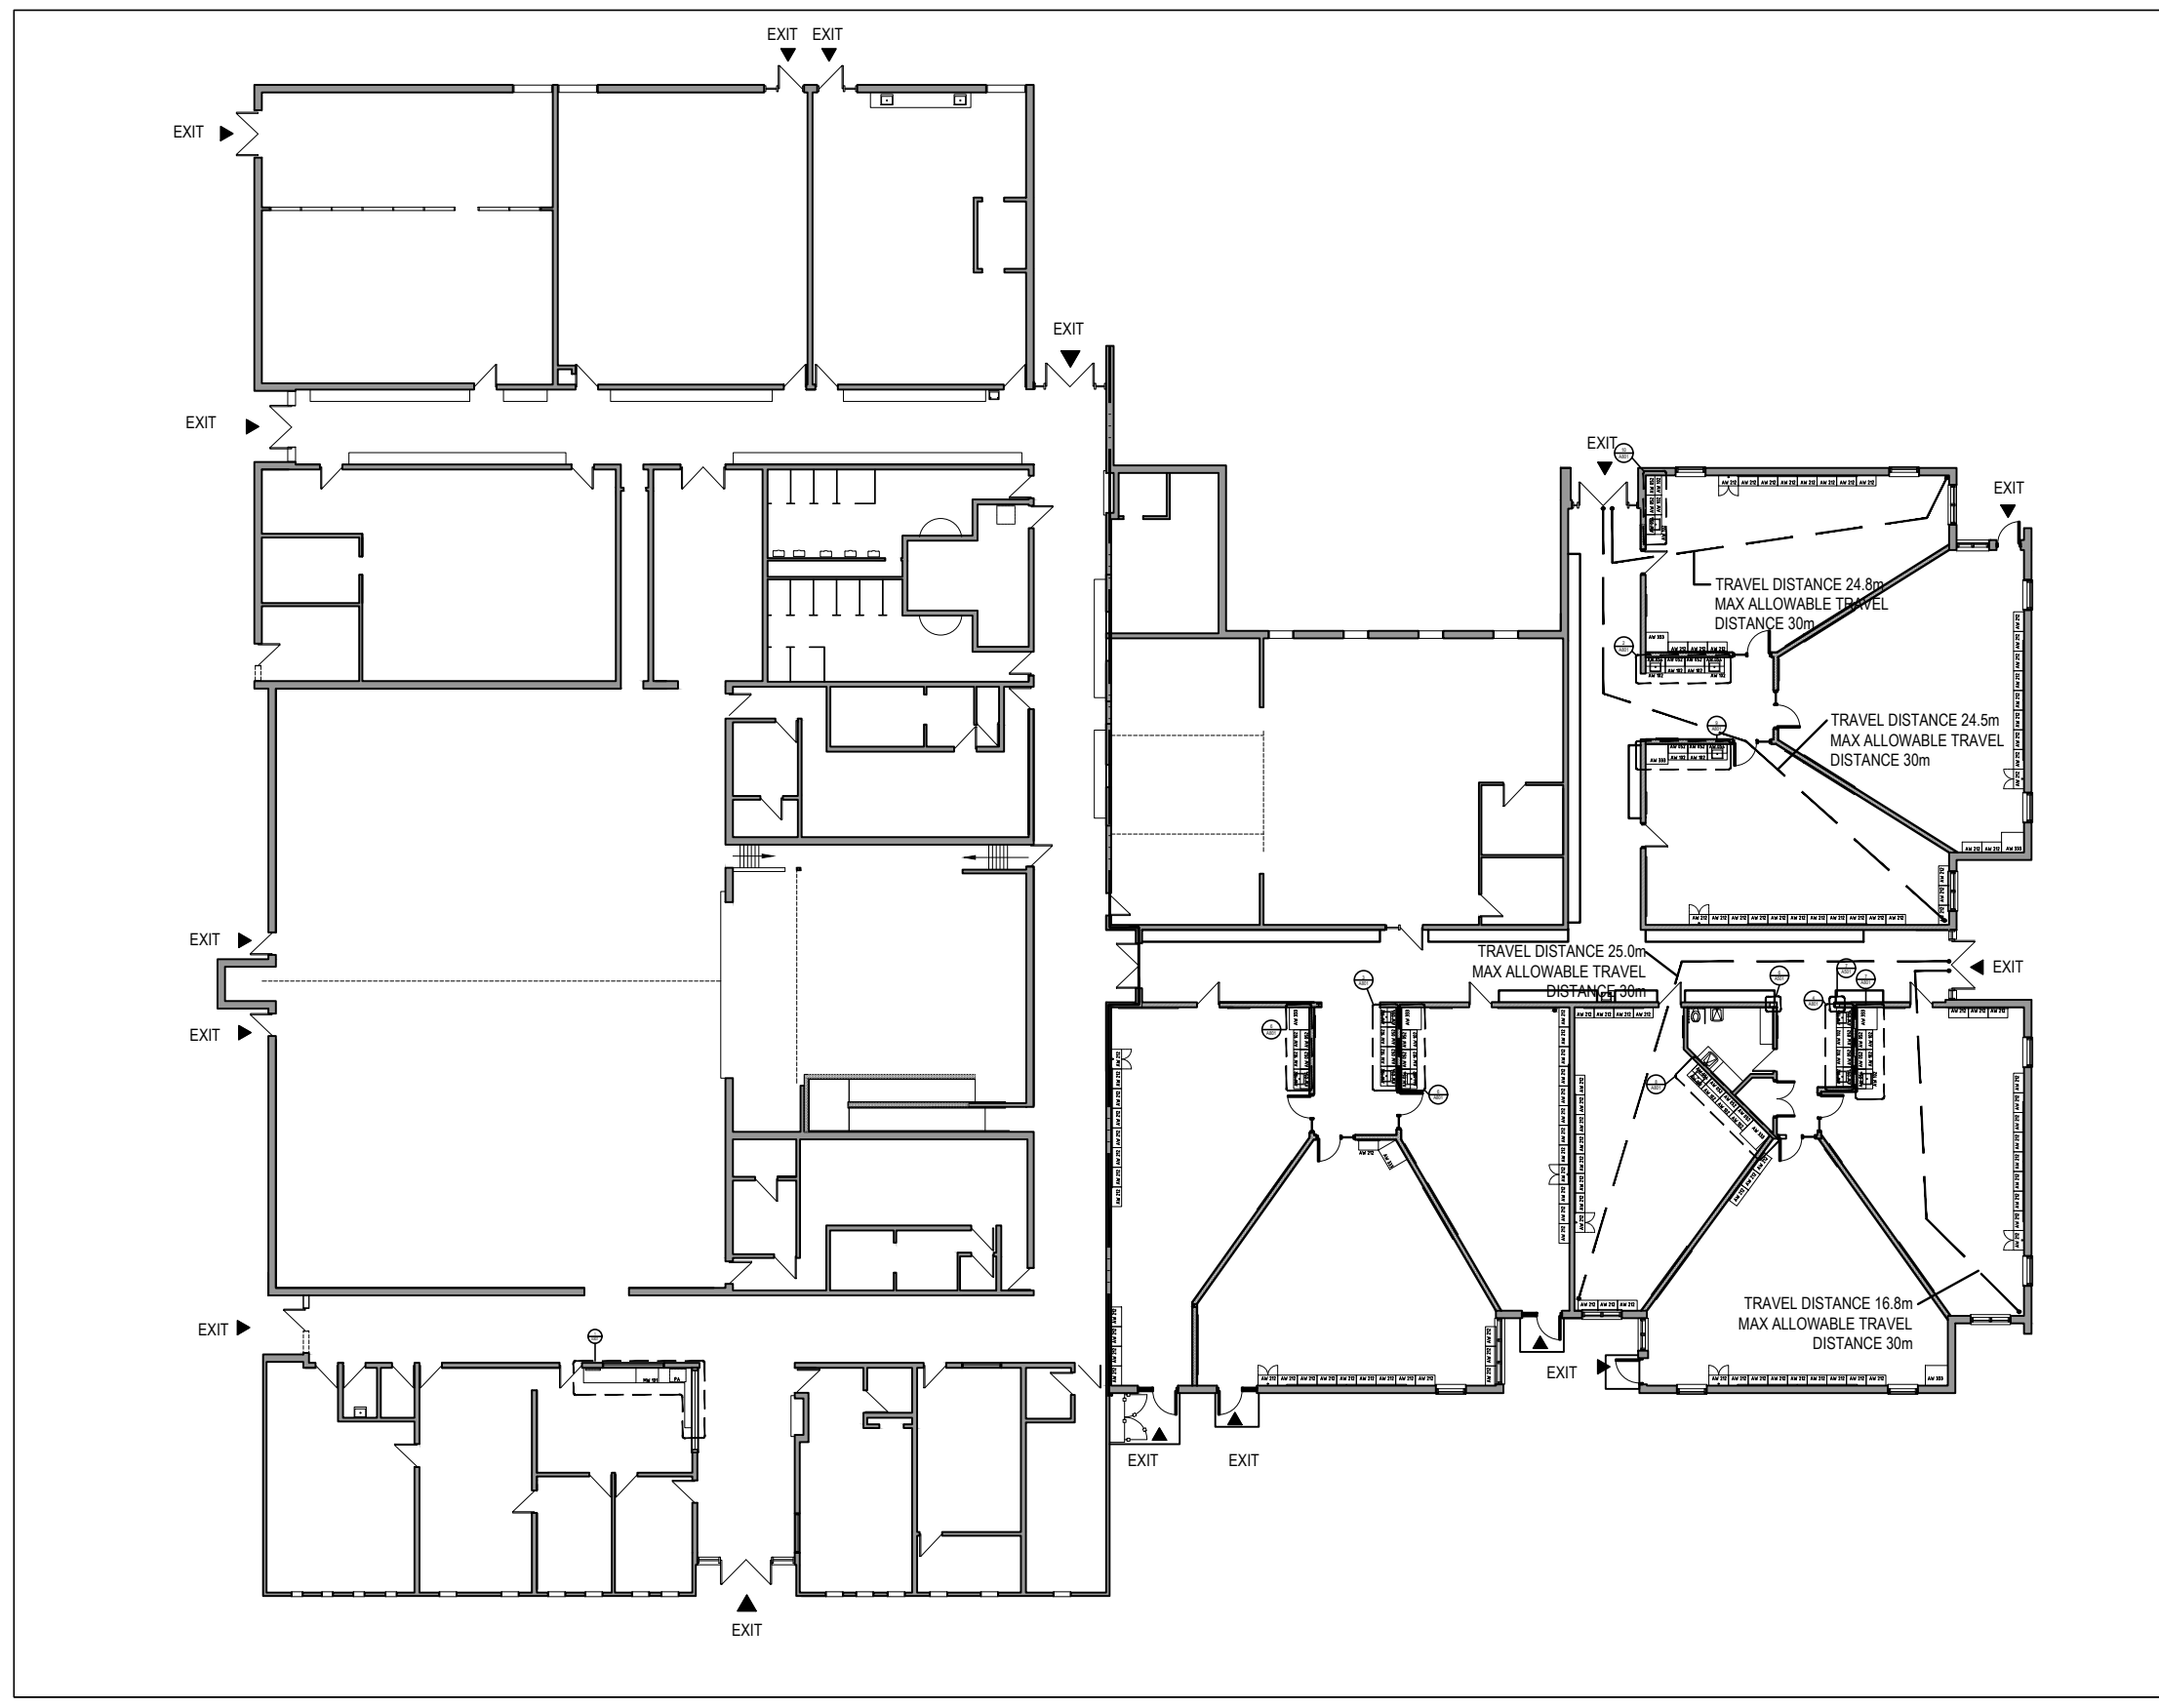

1 FIRE SEPARATION DRAWING - GROUND FLOOR
A001 1 : 300

FFR LEGEND	
	EX. 0 HOUR F.R.R.
	EX. 3/4 HOUR F.R.R.
	EX. 1 HOUR F.R.R.
	EX. 2 HOUR F.R.R.

310 Spadina Ave, Suite 100B
Toronto, Ontario, Canada M5T 2E8
T: 416 203 7600 F: 416 203 3342
lga-ap.com

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DO NOT SCALE DRAWINGS

ISSUE DATE:		
NO.	DATE	DESCRIPTION
03	2022-02-11	ISSUED FOR TENDER
02	2022-01-31	ISSUED FOR 90% CD REVIEW
01	2022-01-18	ISSUED FOR PERMIT

PROJECT:
Park Manor Public School - Phase 2 Interior and Window Enhancements

WRDSB Tender #7266-RW-22

DRAWING TITLE:
OBC MATRIX AND FIRE SEPARATION DRAWINGS

PROJECT NO: 21970
SCALE: AS NOTED
DRAWN BY: JG
REVIEWED BY: DS

DRAWING NO:
A001

GRAPHICS LEGEND

Table with 3 columns: TAGS, DRAWING TAGS, ASSEMBLY TAGS. Includes symbols for door tags, screen number tags, window unit tags, curtain wall unit tags, material finish tags, stair tags, detail numbers, section numbers, exterior/interior elevation numbers, grid bubbles, spot elevations, room tags with area, revision tags, and centrelines.

GENERAL NOTES

- 1. THE CONTRACTOR WILL VERIFY ALL DIMENSIONS FOR THE WORK AND SHALL REPORT ANY DISCREPANCIES TO THE ARCHITECT PRIOR TO COMMENCEMENT OF THE WORK.
2. DRAWINGS ARE NOT TO BE SCALED FOR CONSTRUCTION PURPOSES.
3. ALL DRAWINGS AND SPECIFICATIONS ARE THE PROPERTY OF LGA ARCHITECTURAL PARTNERS. ALL COPYRIGHT CONDITIONS ARE RESERVED BY THE ARCHITECT WITH RESPECT TO THESE DOCUMENTS.
4. NO CHANGES OR SUBSTITUTIONS SHALL BE MADE TO THE WORK DESCRIBED IN THESE DRAWINGS OR SPECIFICATIONS WITHOUT THE EXPRESS WRITTEN AUTHORIZATION OF THE ARCHITECT.
5. THE ARCHITECTURAL DRAWINGS SHALL BE READ IN CONJUNCTION WITH THE LANDSCAPE, STRUCTURAL, ELECTRICAL, MECHANICAL, CIVIL, GEOTECHNICAL, ENVIRONMENTAL CONSULTANTS DOCUMENTS.
6. THE CONTRACTORS SHALL ENSURE THAT MATERIALS AND WORKMANSHIP SHALL BE IN ACCORDANCE WITH CONTRACT DOCUMENTS.
7. THE CONTRACTORS SHALL ENSURE THAT THE LOCATIONS OF ALL UNDERGROUND SERVICES ARE IDENTIFIED PRIOR TO THE COMMENCEMENT OF WORK AND EXCAVATIONS.
8. ALL STRUCTURAL COMPONENTS TO BE TAKEN OFF THE STRUCTURAL DOCUMENTS. NO STRUCTURAL DESIGN INFORMATION SHALL BE INFERRED FROM THE ARCHITECTURAL DRAWINGS.
9. ALL MECHANICAL COMPONENTS TO BE TAKEN OFF THE MECHANICAL DOCUMENTS. NO MECHANICAL DESIGN INFORMATION SHALL BE INFERRED FROM THE ARCHITECTURAL DRAWINGS.
10. ALL ELECTRICAL COMPONENTS TO BE TAKEN OFF THE ELECTRICAL DOCUMENTS. NO ELECTRICAL DESIGN INFORMATION SHALL BE INFERRED FROM THE ARCHITECTURAL DRAWINGS.
11. ALL CIVIL COMPONENTS TO BE TAKEN OFF THE CIVIL DOCUMENTS. NO CIVIL DESIGN INFORMATION SHALL BE INFERRED FROM THE ARCHITECTURAL DRAWINGS.
12. ALL LANDSCAPE COMPONENTS TO BE TAKEN OFF THE LANDSCAPE DOCUMENTS. NO LANDSCAPE DESIGN INFORMATION SHALL BE INFERRED FROM THE ARCHITECTURAL DRAWINGS.

ARCHITECTURAL ABBREVIATIONS LEGEND

Table listing abbreviations and their corresponding terms. Includes categories like wall assembly tags, roof assembly tags, floor assembly tags, ceiling tags, fire extinguisher, floor finish, finished floor level, fire hydrant, fixed glass, fire hose cabinet, finished, face of, frosted glass, fire resistance rating, fire shutter, garbage bin, good one side, good two sides, gauge, galvanized, grab bar, gypsum, gypsum wall board, hosebib, hand dryer, hollow metal, hold open, horizontal, hour, hollow steel section, height, inside diameter, insulation, keylatch set, kickplate, light fixture, lockers, lever latch set, mechanical & electrical, maglock, masonry, material, maximum, moisture barrier, medium density fibreboard, mechanical, melamine, manufacturer, magnetic hold open, mirror, minimum, masonry opening, metal, not applicable, not in contract, number, not to scale, ontario building code, on centre, outside diameter, overhead, open to above, open to below, opening, opposite, open web steel joist, barrier free push button, panic hardware, property line, plastic laminate, privacy lockset, plywood, pressed steel frame, paint, painted, paper towel & waste receptacle, riser, radiator, reflected ceiling plan, roof drain, re-inforced, required, reverse, resilient flooring, recessed lighting, room, rough opening, right-of-way, removable panel, remove & replace, roof top unit, rain water leader, sealer, sanitary bin, sealed concrete, schedule, swipe card reader, solid core wood, soap dispenser, square feet, supplementary guidelines, sill height, similar, sliding doors, square meter(s), smoke seal, sanitary napkin disposal, slab on grade, specification, square, stainless steel, stainless steel frame, structural silicon glazing, solid surface, steel, sound transmission class, standard, stain grade, structural, supplementary, treads, thermally broken, to be determined, tempered glazing, thick, threshold, tile, tilt mirror, top of, toilet paper dispenser, transition strip, typical, towel bar, through wall flashing, underwriter's laboratory of canada, unless noted otherwise, underside, vertical, vapour barrier, veneer core, vinyl composite tile, verify in field, vapour permeable, vapour retarder, washer, wash, wall base, washroom, wood, wood veneer, wired glass, watermain, water resistant barrier, weatherstrip, window shade, white board.

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DO NOT SCALE DRAWINGS

ISSUE DATE:

Table with columns for NO., DATE, and DESCRIPTION. Shows issue dates from 03/2022 to 01/2021 with descriptions like ISSUED FOR TENDER, ISSUED FOR 90% CD REVIEW, ISSUED FOR PERMIT, UNLESS NOTED OTHERWISE, UNDERSIDE, VERTICAL, VAPOUR BARRIER, VENEER CORE, VINYL COMPOSITE TILE, VERIFY IN FIELD, VAPOUR PERMEABLE, VAPOUR RETARDER, WASHER WITH, WALL BASE, WASHROOM, WOOD, WOOD VENEER, WIRED GLASS, WATERMAIN, WATER RESISTANT BARRIER, WEATHERSTRIP, WINDOW SHADE, WHITE BOARD.

PROJECT:

Park Manor Public School - Phase 2 Interior and Window Enhancements

WRDSB Tender #7266-RW-22

DRAWING TITLE:

ANNOTATION LEGEND, ABBREVIATIONS, AND GENERAL NOTES

PROJECT NO: 21970
SCALE: N/A
DRAWN BY: JG
REVIEWED BY: DS




DRAWING NO:

A002

GLAZING SCHEDULE				
ABBREVIATION	DESCRIPTION	MANUFACTURER	PRODUCT	NOTES
G1	EXTERIOR, DOUBLE GLAZED, TG, LOW-E, TINTED GLASS	GUARDIAN GLASS	SN 54	OUTSIDE: TEMPERED GLASS WITH LOW-E COATING (U 0.29; SHGC 0.38) AIR SPACE: ARGON GAS, WARM EDGE SPACER WITH PORT AT TOP OF UNIT INSIDE: TEMPERED GLASS
G2	INTERIOR, TLG, NON RATED	-	-	MIN. 10mm TOTAL THICKNESS; TEMPERED AND LAMINATED VISION GLASS USED FOR INTERIOR SCREENS AND DOORS INCLUDE FOR CUSTOM VINYL VISION STRIPS FOR (50mm THICK AT 1500mm AFF)

WINDOW SCHEDULE											
WINDOW NO.	LOCATION			WINDOW TYPE	WINDOW SIZE			FRAME CONSTRUCTION		GLAZING TYPE	NOTES
	ROOM NAME	ROOM #			R.O. WIDTH	R.O. HEIGHT	THICKNESS	MATERIAL	FINISH		
W101	CLASSROOM	NW6	A	A	1220	2844	100	AL	AN	G1	SINGLE AWNING, DOUBLE FIXED, ROLLER SHADE
W102	CLASSROOM	NW6	A	A	1220	2844	100	AL	AN	G1	SINGLE AWNING, DOUBLE FIXED, ROLLER SHADE
W103	CLASSROOM	NW6	C	EX	EX	EX	100	AL	AN	G1	DOUBLE HUNG SASH, ROLLER SHADE
W104	CLASSROOM	NW4	D	EX	EX	EX	100	AL	AN	G1	DOUBLE HUNG SASH, ROLLER SHADE
W105	CLASSROOM	NW4	A	A	1220	2844	100	AL	AN	G1	SINGLE AWNING, DOUBLE FIXED, ROLLER SHADE
W106	CLASSROOM	NW4	A	A	1220	2844	100	AL	AN	G1	SINGLE AWNING, DOUBLE FIXED, ROLLER SHADE
W107	CLASSROOM	NW2	C	EX	EX	EX	100	AL	AN	G1	DOUBLE HUNG SASH, ROLLER SHADE
W108	CLASSROOM	N12	A	A	1220	2844	100	AL	AN	G1	SINGLE AWNING, DOUBLE FIXED, ROLLER SHADE
W109	CLASSROOM	N12	A	A	1220	2844	100	AL	AN	G1	SINGLE AWNING, DOUBLE FIXED, ROLLER SHADE
W110	CLASSROOM	N12	C	EX	EX	EX	100	AL	AN	G1	DOUBLE HUNG SASH, ROLLER SHADE
W111	CLASSROOM	N10	B	EX	EX	EX	100	AL	AN	G1	SINGLE AWNING, DOUBLE FIXED, ROLLER SHADE
W112	CLASSROOM	N10	B	EX	EX	EX	100	AL	AN	G1	SINGLE AWNING, DOUBLE FIXED, ROLLER SHADE
W113	CLASSROOM	N10	C	EX	EX	EX	100	AL	AN	G1	DOUBLE HUNG SASH, ROLLER SHADE
W114	CLASSROOM	N8	D	EX	EX	EX	100	AL	AN	G1	DOUBLE HUNG SASH, ROLLER SHADE
W115	CLASSROOM	N4	E	EX	EX	EX	100	AL	AN	G1	DOUBLE HUNG SASH, ROLLER SHADE
W116	CLASSROOM	N4	B	EX	EX	EX	100	AL	AN	G1	SINGLE AWNING, DOUBLE FIXED, ROLLER SHADE


NOTE: CONTRACTOR RESPONSIBLE FOR VERIFYING ALL DIMENSIONS PRIOR TO FABRICATION.

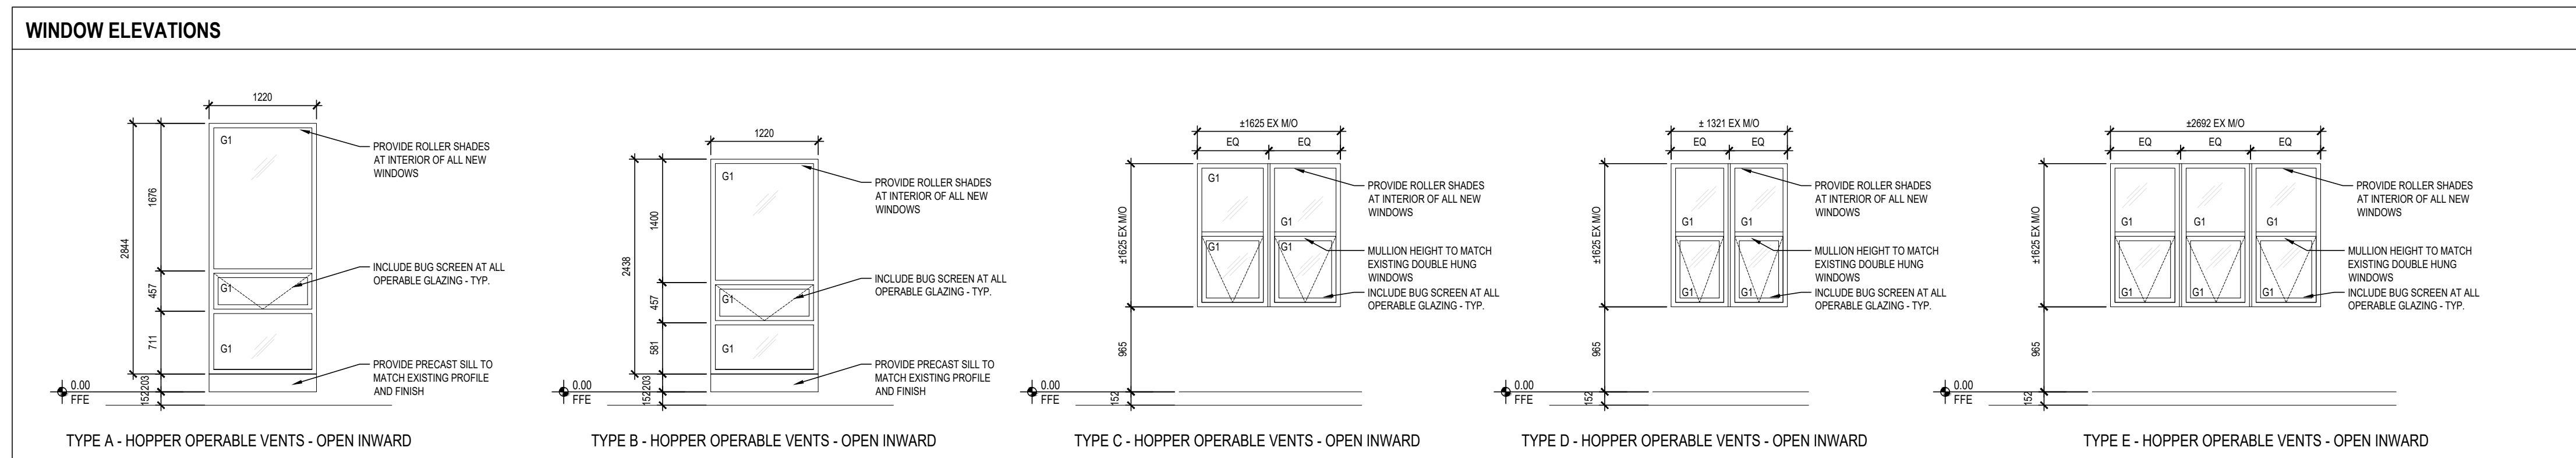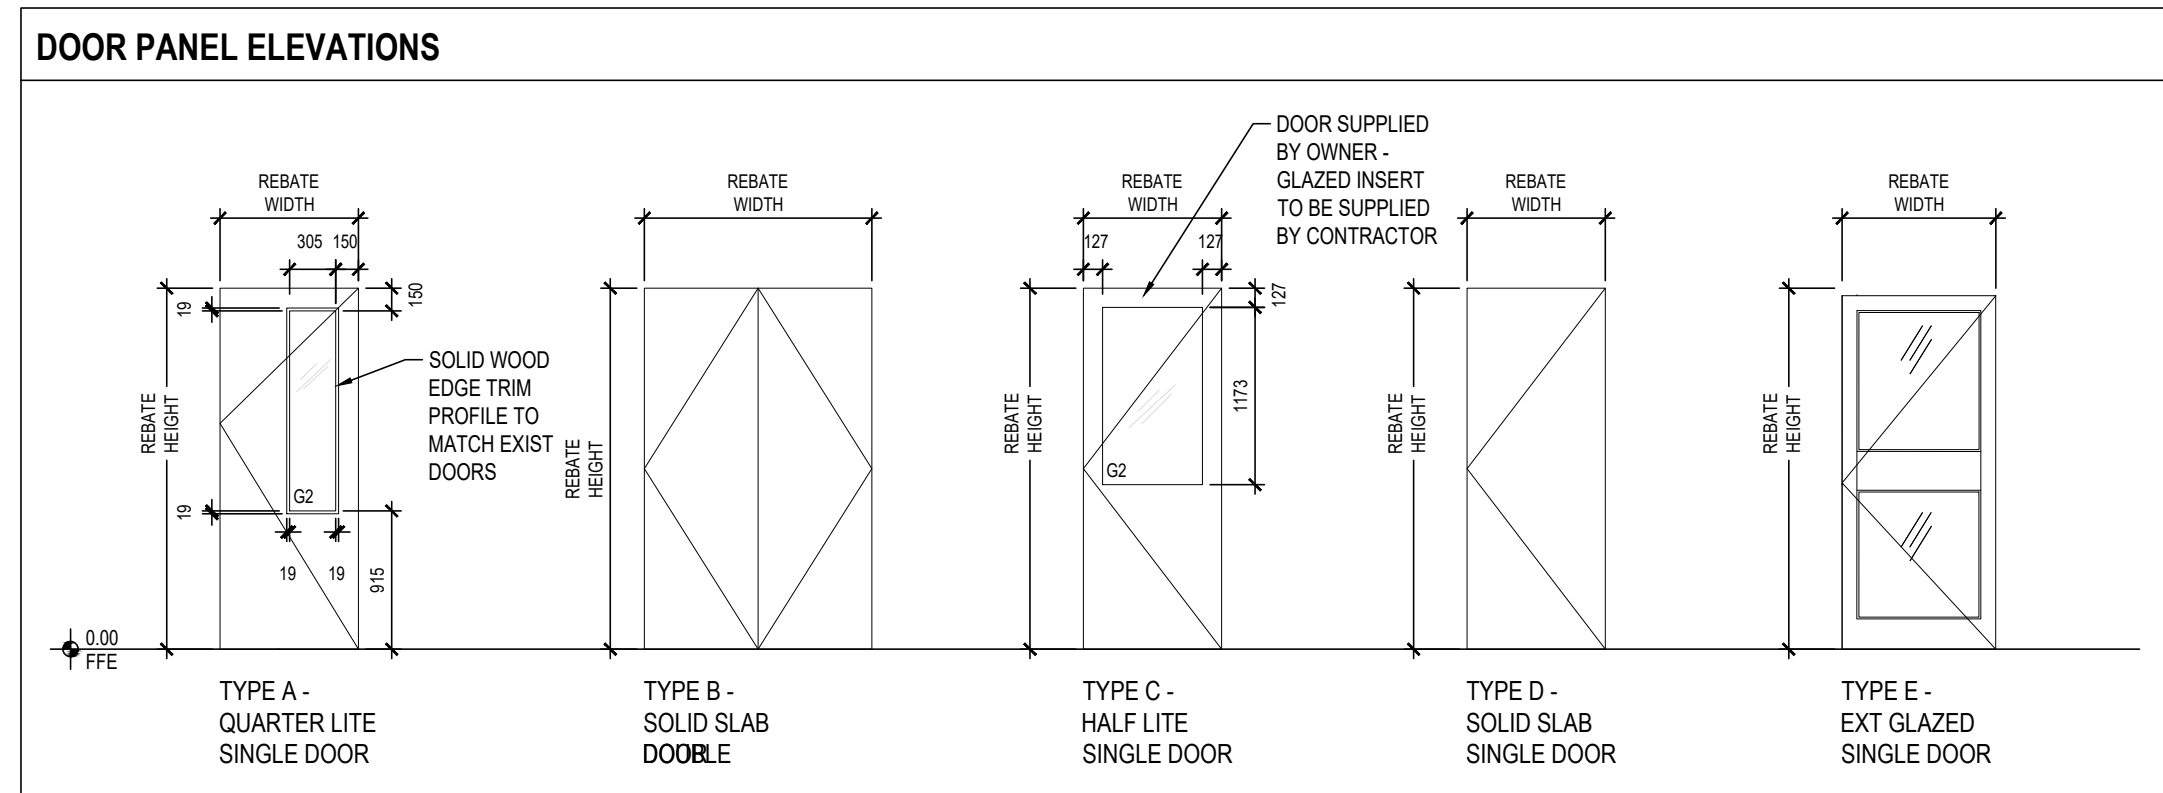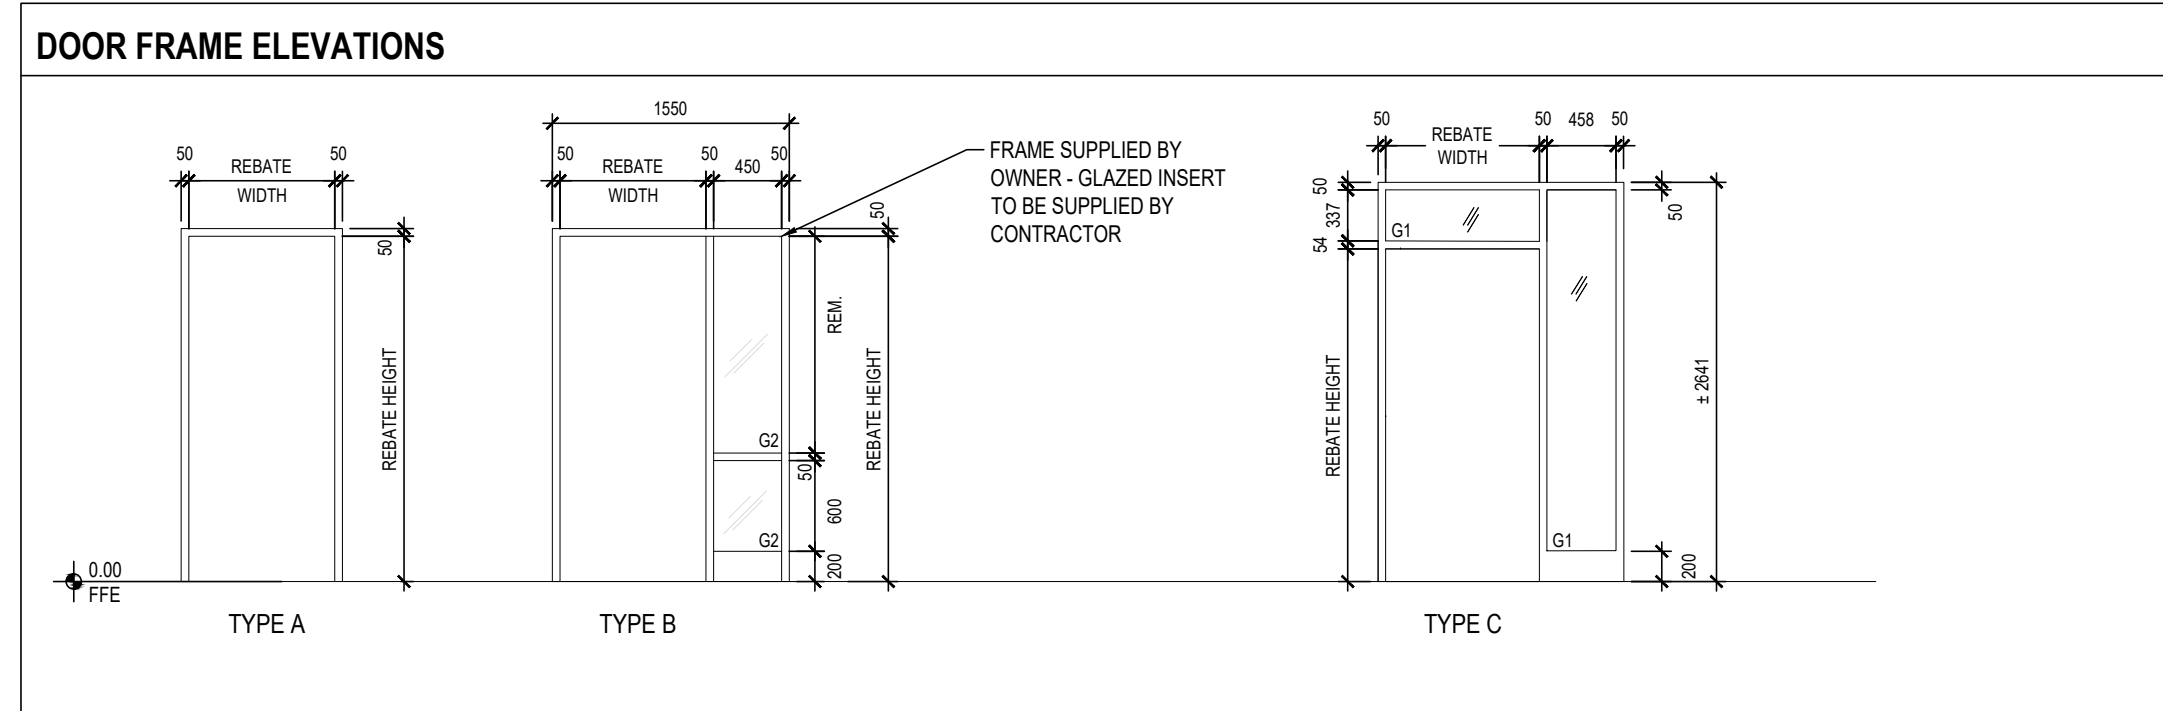

- ### WINDOW NOTES
- CONTRACTOR TO CONFIRM ALL FINISHES, LOCATIONS, AND NUMBERS AND NOTIFY CONSULTANT OF ANY DISCREPANCIES.
 - ALL EXTERIOR WINDOWS ARE TO BE INSULATED & HAVE THERMALLY BROKEN FRAMES. FILL FRAMES AND SPACE BETWEEN FRAMES AND ADJACENT MATERIALS WITH SPRAY FOAM INSULATION.
 - CONTRACTOR TO COORDINATE WINDOW WIDTHS AND DETAILS WITH ON-SITE CONDITIONS. CONTRACTOR TO PRODUCE SHOP DRAWINGS OF WINDOW ASSEMBLIES FOR ARCHITECTS REVIEW.
 - THE OPERABLE OPENING TO BE LIMITED TO 185MM. ENSURE THAT OPERABLE FRAME DOES NOT EXTEND PAST THE SURFACE OF THE WALL.
 - ALL GLAZING TO BE TEMPERED UNLESS OTHERWISE SPECIFIED.
 - ALL INTERIOR SILLS TO BE REPLACED. REFER TO WINDOW SCHEDULE AND SECTION DETAILS FOR MORE INFORMATION.

- ### HARDWARE LEGEND
- AO AUTOMATIC DOOR OPENER
 - CC CONCEALED CLOSER
 - CH COAT HOOK
 - CL CLOSER
 - CLF CLASSROOM LOCK FUNCTION
 - CM CENTRE MULLION
 - CS CARD SWIPE
 - DC DOOR CONTACT
 - DP DOOR PULL
 - DS DOOR STOP
 - ED PANIC BAR EXIT DEVICE
 - EHO ELECTRIC HOLD OPEN
 - EL ELECTRIC LATCH
 - ESC ELECTRIC SCREAMER
 - EST ELECTRIC STRIKE
 - HO HOLD OPEN, MAGNETIC
 - KP KICKPLATE, SS
 - L LATCH, LOCKSET
 - OFL OFFICE FUNCTION LOCKSET
 - PB PUSH BUTTON
 - PH PANIC HARDWARE
 - PHA PANIC HARDWARE W/ ALARM OVERRIDE
 - PP PUSH / PULL
 - PRV PRIVACY LOCKSET
 - S DOOR SIGNAGE
 - TH THRESHOLD
 - WS WEATHER STRIPPING

- ### LEGEND
- AL ALUMINUM
 - AN CLEAR ANODIZED
 - BA BATT INSULATION
 - HM HOLLOW METAL
 - PI POLYISO INSULATION
 - PN PAINT
 - SCW SOLID CORE WOOD
 - ST STAIN
 - CF CLEAR FINISH
 - WD WOOD
 - TG TEMPERED GLASS
 - TLG TEMPERED LAMINATED GLASS
 - FRG FIRE RATED GLASS

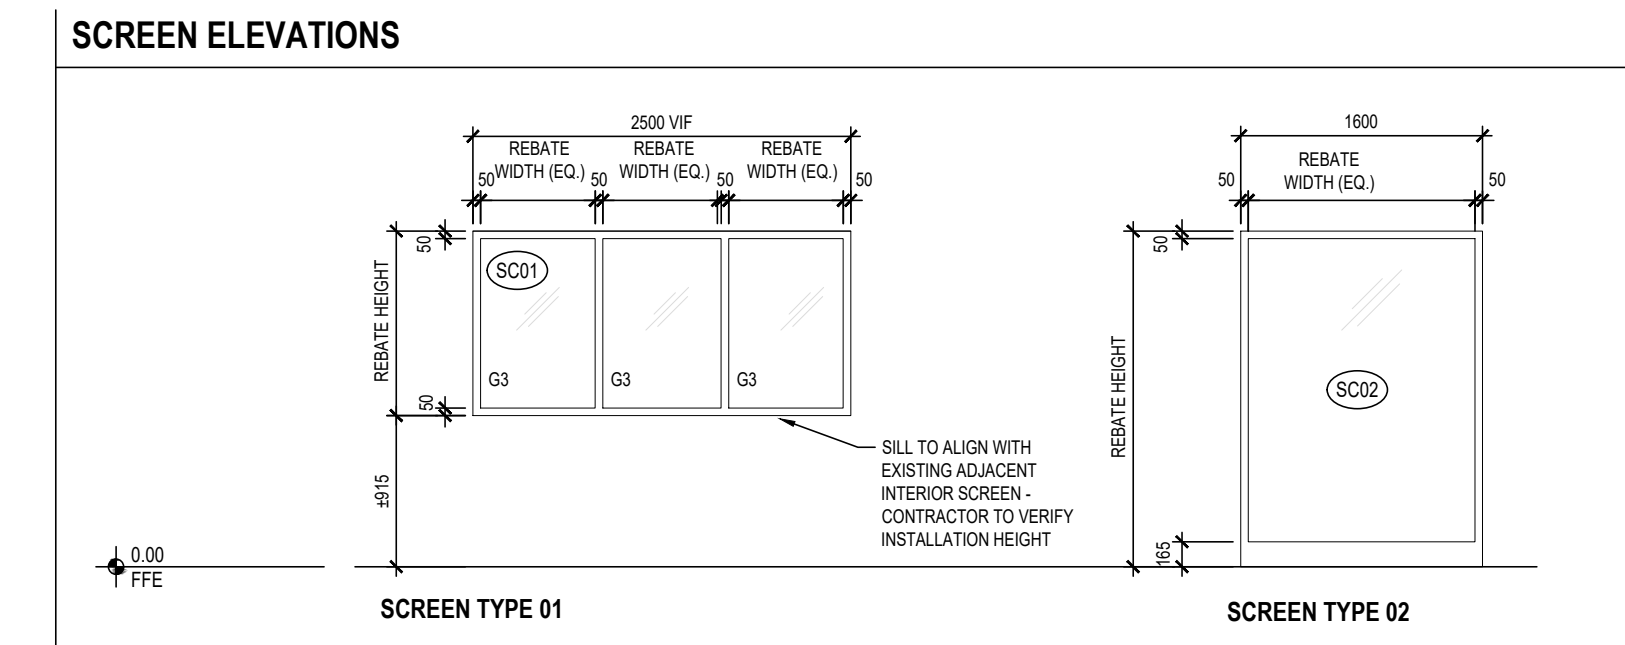



SCREEN SCHEDULE									
SCREEN NO.	LOCATION		SCREEN SIZE			FRAME CONSTRUCTION		GLAZING TYPE	FIRE RATING
	ROOM NAME	ROOM #	REBATE WIDTH	REBATE HEIGHT	THICKNESS	MATERIAL	FINISH		
SC01	RECEPTION/ADMIN OFFICE	W8	2500	1285	45	WD-1	CF	G3	-
SC02	CYW		1600	2200	45	WD-1	CF	G2	-
SC02	VP OFFICE		1600	2200	45	WD-1	CF	G2	-

NOTE: CONTRACTOR RESPONSIBLE FOR VERIFYING ALL DIMENSIONS PRIOR TO FABRICATION.

DOOR SCHEDULE																
DOOR NO.	FROM ROOM:		TO ROOM:		DOOR SIZE			PANEL CONSTRUCTION			FRAME CONSTRUCTION			GLAZING TYPE	FIRE RATING	HARDWARE
	ROOM NAME	ROOM #	ROOM NAME	ROOM #	REBATE WIDTH	REBATE HEIGHT	THICKNESS	TYPE	MATERIAL	FINISH	TYPE	MATERIAL	FINISH			
DN2	CORRIDOR	N1	CLASSROOM	N2	EX	EX	EX	C	HM	PT	B	HM	PT	G2	-	SEE NOTE 1, CLF, KP, PP, HO, DS
DN2a	CLASSROOM	N1	EXTERIOR		965	EX M/O	51	E	AL	PT	C	AL	PT	G1	-	CLOSER, KP, TH, WS, THERMALLY BROKEN, BLANK PANEL AT EXT. LOCK
DN4	CORRIDOR	N1	CLASSROOM	N4	EX	EX	EX	C	HM	PT	B	HM	PT	G2	-	SEE NOTE 1, CLF, KP, PP, HO, DS
DN4a	CLASSROOM	N4	EXTERIOR		965	EX M/O	51	E	AL	PT	C	AL	PT	G1	-	CLOSER, KP, TH, WS, THERMALLY BROKEN, BLANK PANEL AT EXT. LOCK
DN6	CORRIDOR	N1	CLASSROOM	N6	EX	EX	EX	C	HM	PT	B	HM	PT	G2	-	SEE NOTE 1, CLF, KP, PP, HO, DS
DN6a	CLASSROOM	N4	EXTERIOR		EX M/O	EX M/O	51	E	AL	PT	C	AL	PT	G1	-	CLOSER, KP, TH, WS, THERMALLY BROKEN, BLANK PANEL AT EXT. LOCK
DN9	CORRIDOR	N7	ELECTRICAL	N9	EX	EX	45	B	HM	PT	A	HM	PT	-	-	KP, S, DP, CM, STORAGE LOCK
DN10	CORRIDOR	N7	CLASSROOM	N10	EX	EX	EX	C	HM	PT	B	HM	PT	G2	-	SEE NOTE 1, CLF, KP, PP, HO, DS
DN10a	CLASSROOM	N10	EXTERIOR		EX M/O	EX M/O	51	C	AL	PT	A	AL	PT	G1	-	CLOSER, KP, TH, WS, THERMALLY BROKEN, BLANK PANEL AT EXT. LOCK
DN12	CORRIDOR	N7	CLASSROOM	N10	EX	EX	EX	C	HM	PT	B	HM	PT	G2	-	SEE NOTE 1, CLF, KP, PP, HO, DS
DNW2	CORRIDOR	NW1	CLASSROOM	NW2	950	2285	EX	C	HM	PT	B	HM	PT	G2	-	SEE NOTE 1, CLF, KP, PP, HO, DS
DNW2a	CORRIDOR	NW	CLASSROOM	NW2	EX	EX	45	A	SCW	EX	A	HM	PT	G2	-	REINSTALL SALVAGED DOOR IN NEW FRAME, CLF, KP, DS, HO
DNW4	CORRIDOR	NW1	CLASSROOM	NW4	950	2285	EX	C	HM	PT	B	HM	PT	G2	-	SEE NOTE 1, CLF, KP, PP, HO, DS
DNW4a	CLASSROOM	NW4	EXTERIOR		EX M/O	EX M/O	51	C	AL	PT	A	AL	PT	G1	-	CLOSER, KP, TH, WS, THERMALLY BROKEN, BLANK PANEL AT EXT. LOCK
DNW6	CORRIDOR	NW1	CLASSROOM	NW6	950	2285	EX	C	HM	PT	B	HM	PT	G2	-	SEE NOTE 1, CLF, KP, PP, HO, DS
DNW6a	CORRIDOR	NW	CLASSROOM	NW6	EX	EX	45	A	SCW	EX	A	HM	PT	G2	-	REINSTALL SALVAGED DOOR IN NEW FRAME, CLF, KP, DS, HO

NOTE 1: CLIENT SUPPLIED DOOR AND FRAME. **HARDWARE, GLAZING, PAINTING, AND INSTALLATION** ONLY OF DOORS AND FRAMES TO BE PROVIDED AS PART OF THIS CONTRACT.

NOTE 2: CONTRACTOR RESPONSIBLE FOR VERIFYING ALL DIMENSIONS PRIOR TO FABRICATION.

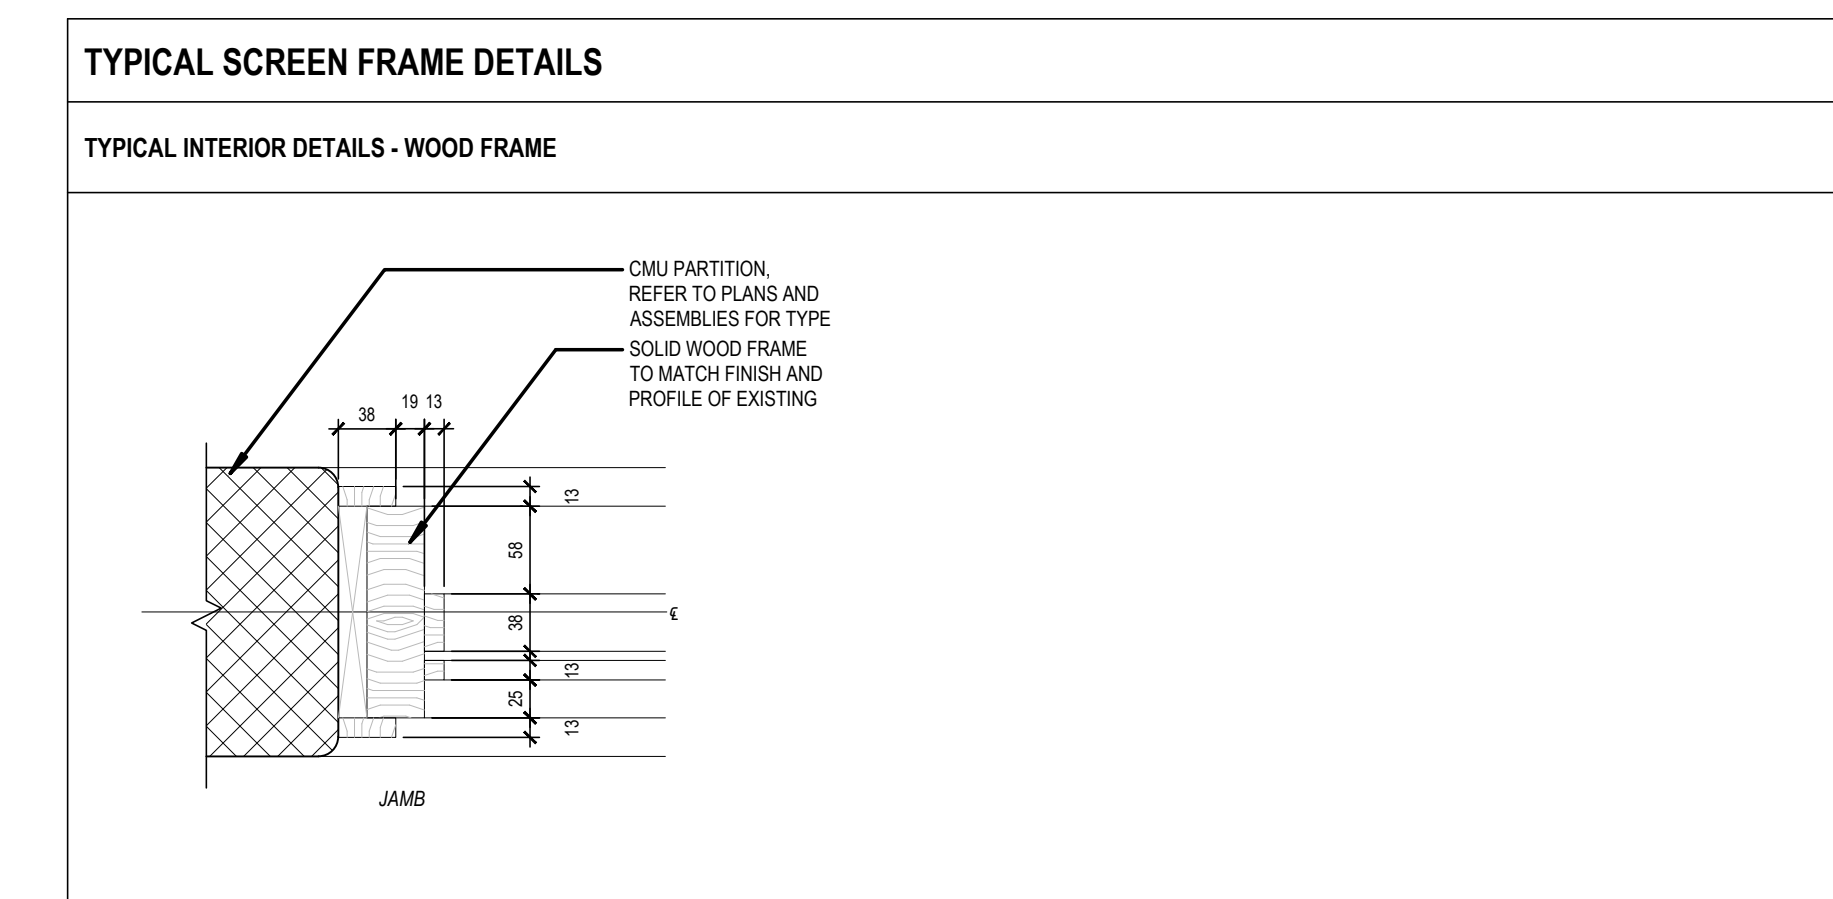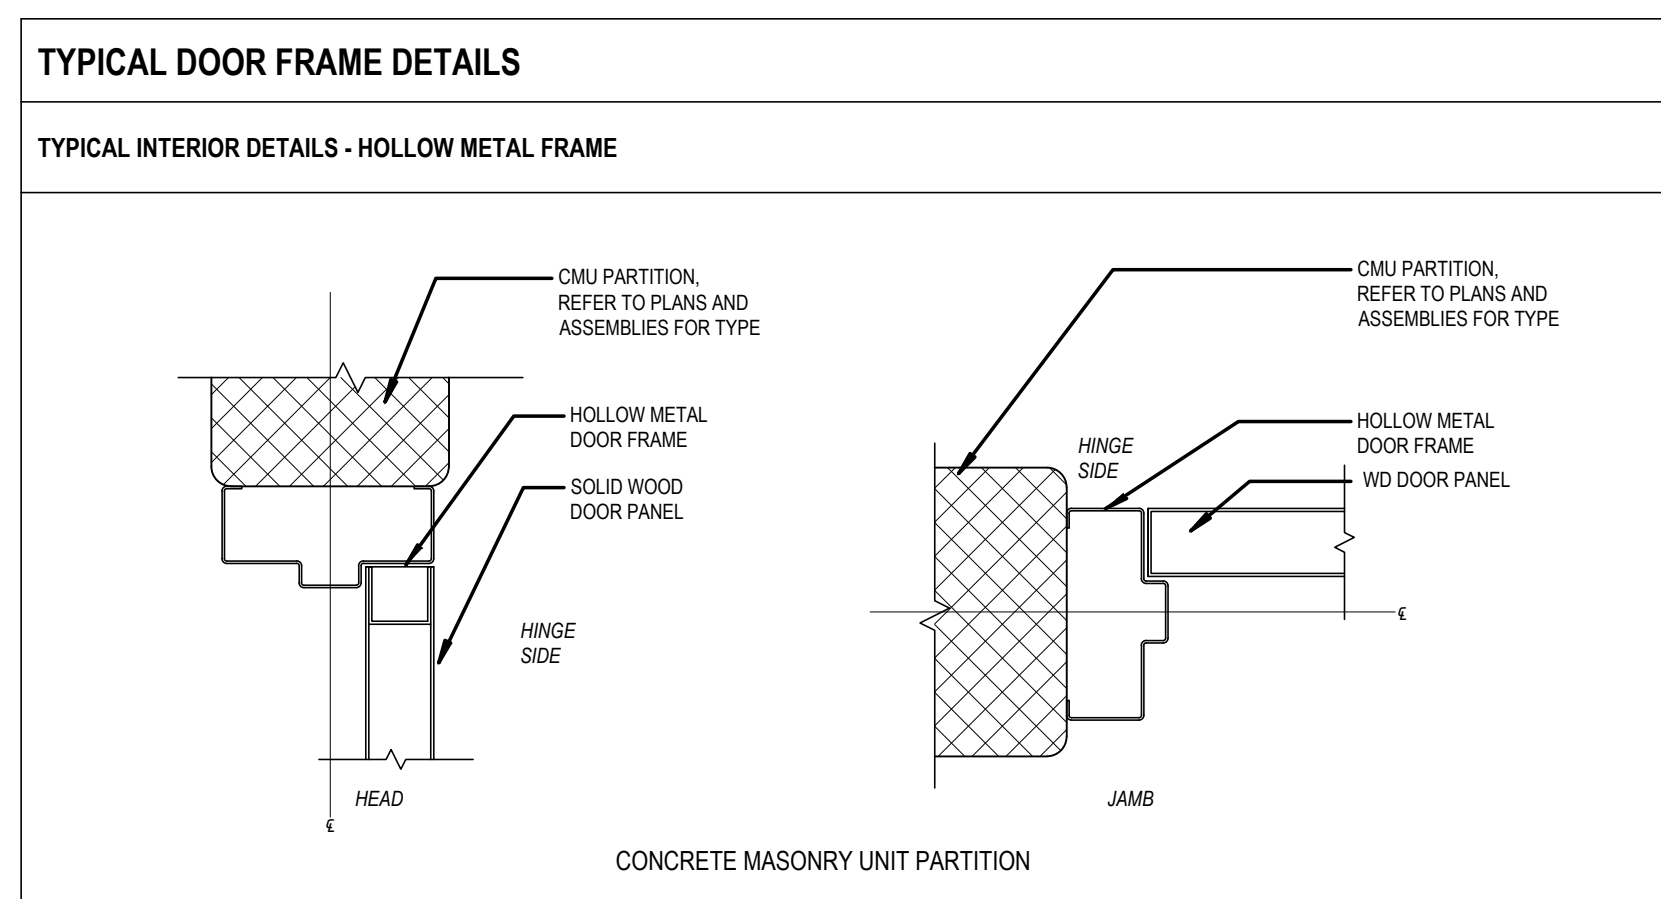

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DO NOT SCALE DRAWINGS

NO.	DATE	DESCRIPTION
05	2022-02-11	ISSUED FOR TENDER
04	2022-01-31	ISSUED FOR 90% CD REVIEW
03	2022-01-18	ISSUED FOR PERMIT
02	2022-01-17	ISSUED FOR CLIENT REVIEW
01	2022-01-11	ISSUED FOR COORDINATION

PROJECT:
Park Manor Public School - Phase 2 Interior and Window Enhancements

WRDSB Tender #7266-RW-22

DRAWING TITLE:
SCHEDULES

PROJECT NO: 21970
 SCALE: N/A
 DRAWN BY: JG
 REVIEWED BY: DS

DRAWING NO:
A003

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DO NOT SCALE DRAWINGS

ASSEMBLIES SCHEDULE						
F - FLOOR ASSEMBLIES						
TYPE	DIAGRAM	DESCRIPTION	ASSEMBLY-SPECIFIC NOTES	PERFORMANCE		
				CATEGORY	REQUIRED	PROVIDED
F1		EXISTING CAST-IN-PLACE CONCRETE SLAB VAR FLOOR FINISH AND UNDERLAY REFER TO FINISH PLANS & SCHEDULE EXISTING FLOOR SLAB	EXISTING TO REMAIN	FRR	-	-
				STC RATING	-	-
P - INTERIOR PARTITION AND FURRING ASSEMBLIES						
FOR ALL ASSEMBLIES IN THE CONTRACT DOCUMENTS WITH A DESIGNATED LISTING FROM A TESTING AUTHORITY (E.G. ULC) IT IS THE FULL RESPONSIBILITY OF THE TRADE CONTRACTOR AND/OR CONSTRUCTION MANAGER TO INDEPENDENTLY RESEARCH, PROVIDE, AND CONSTRUCT THE COMPLETE PUBLISHED ASSEMBLY AS DESCRIBED BY THE ASSOCIATED TESTING AUTHORITIES. THE DESCRIPTION OF THE ASSEMBLIES IN THE CONTRACT DOCUMENTS ARE NOTED "AS BASIS OF DESIGN" AND MAY NOT REPRESENT THE FULL CRITERIA AS DEFINED BY THE TESTING AUTHORITY.						
TYPE	DIAGRAM	DESCRIPTION	ASSEMBLY-SPECIFIC NOTES	PERFORMANCE		
				CATEGORY	REQUIRED	PROVIDED
P1		190mm NON-LOADBEARING CMU - TYP. PAINT FINISH 190mm CMU HOLLOW BLOCK, NORMAL WEIGHT TYPE "N" REFER TO STRUCTURAL PAINT FINISH	<ul style="list-style-type: none"> REFER TO STRUCTURAL DRAWINGS FOR LATERAL SUPPORT CONNECTIONS AND DETAILS AND LINTEL SUPPORT DETAILS TYPICAL HORIZONTAL AND VERTICAL MORTAR JOINT SPACING TO BE 10mm UNLESS NOTED OTHERWISE PROVIDE BULLNOSE BLOCK AT ALL EXPOSED CORNER, JAMB, AND HEAD CONDITIONS U.N.O. PARTITION TO EXTEND TO UIS OF EXST STRUCTURE U.N.O. 	FRR	-	1.5 HR
				STC RATING	-	-
P1a		190mm NON-LOADBEARING CMU W/FINISH 1 CERAMIC TILE 190mm CMU HOLLOW BLOCK, NORMAL WEIGHT TYPE "N" REFER TO STRUCTURAL PAINT FINISH	<ul style="list-style-type: none"> REFER TO STRUCTURAL DRAWINGS FOR LATERAL SUPPORT CONNECTIONS AND DETAILS AND LINTEL SUPPORT DETAILS TYPICAL HORIZONTAL AND VERTICAL MORTAR JOINT SPACING TO BE 10mm UNLESS NOTED OTHERWISE PROVIDE BULLNOSE BLOCK AT ALL EXPOSED CORNER, JAMB, AND HEAD CONDITIONS U.N.O. PARTITION TO EXTEND TO UIS OF EXST STRUCTURE U.N.O. 	FRR	-	1.5 HR
				STC RATING	-	-
P1b		190mm NON-LOADBEARING CMU W/FINISH 2 CERAMIC TILE 190mm CMU HOLLOW BLOCK, NORMAL WEIGHT TYPE "N" REFER TO STRUCTURAL CERAMIC TILE	<ul style="list-style-type: none"> REFER TO STRUCTURAL DRAWINGS FOR LATERAL SUPPORT CONNECTIONS AND DETAILS AND LINTEL SUPPORT DETAILS TYPICAL HORIZONTAL AND VERTICAL MORTAR JOINT SPACING TO BE 10mm UNLESS NOTED OTHERWISE PROVIDE BULLNOSE BLOCK AT ALL EXPOSED CORNER, JAMB, AND HEAD CONDITIONS U.N.O. PARTITION TO EXTEND TO UIS OF EXST STRUCTURE U.N.O. 	FRR	-	1.5 HR
				STC RATING	-	-
P2		102mm NON-LOADBEARING STEEL STUDS WITH 16mm GB (BOTH SIDES) 16mm GB-1 GYPSUM BOARD MUDDED AND TAPED 92mm NON-LOADBEARING STEEL STUD FRAMING @ 406mm O.C. 89mm INS-03 BATT INSULATION 16mm GB-1 GYPSUM BOARD MUDDED AND TAPED	<ul style="list-style-type: none"> PARTITION TYPE TO BE CONSTRUCTED FROM TOP OF EXISTING 8" CMU PARTITION TO UIS OF EXISTING ROOF STRUCTURE. ALIGN F/O NEW PARTITION WITH CORRIDOR SIDE OF EX CMU PARTITION BELOW. TOP AND BOTTOM OF PARTITION TO BE CALKED WITH ACOUSTIC SEALANT. EX. PARTITION BELOW SHOWN DASHED 	FRR	-	-
				STC RATING	-	-
W - WALL ASSEMBLIES						
TYPE	DIAGRAM	DESCRIPTION	ASSEMBLY-SPECIFIC NOTES	PERFORMANCE		
				CATEGORY	REQUIRED	PROVIDED
W1		NEW STANDING SEAM METAL SIDING ON CMU 38mm STANDING SEAM STEEL SIDING ON THERMALLY BROKEN CLIPS (M3) 76mm ROCKWOOL RIGID INSULATION R-12 SELF-ADHESIVE VAPOUR PERMEABLE AIR BARRIER 190mm CONC BLOCK PAINT FINISH	<ul style="list-style-type: none"> PARTITION TYPE TO BE CONSTRUCTED ARE AREA OF REMOVED DOOR OPENING. ALIGN F/O NEW WALL WITH F/O ADJ. WALL 	FRR	-	-
				STC RATING	-	-

ASSEMBLIES SCHEDULE (CONTINUED)						
C - SUSPENDED CEILING ASSEMBLIES						
TYPE	DIAGRAM	DESCRIPTION	ASSEMBLY-SPECIFIC NOTES	PERFORMANCE		
				CATEGORY	REQUIRED	PROVIDED
C1		SUSPENDED LAY-IN ACOUSTICAL TILE CEILING WITH SUPPORT GRID SYSTEM (DRY AREAS) VAR MAIN BEAM AND CROSS TEE ACOUSTICAL TILE GRID SYSTEM SUPPORT FRAMING AS REQUIRED C/W WIRE TIE SUPPORTS AT-1 LAY-IN ACOUSTICAL TILE (610 x 1220mm) 19mm	NOTE: ALL ACOUSTICAL TILE GRID SYSTEM SUPPORT FRAMING AND WIRE TIE HANGERS TO BE HOT-DIPPED GALVANIZED. NOTE: WIRE TIE HANGERS ARE NOT TO BE FASTENED BACK TO METAL ROOF DECKING. CONTRACTOR TO PROVIDE ADDITIONAL FRAMING AS REQUIRED TO SUPPORT CEILING ASSEMBLY AND ASSOCIATED FIXTURES. NOTE: REFER TO RCP FOR LOCATIONS AND INSTALLATION HEIGHT	FRR	-	-
				STC RATING	-	-

ASSEMBLY GENERAL NOTES						
1.	REFER TO FIRE SEPARATION DRAWINGS FOR REQUIRED FIRE SEPARATION RATINGS. THE CONTRACTOR IS TO ENSURE THE CONTINUITY OF ALL FIRE SEPARATIONS AS REQUIRED.					
2.	THE CONTRACTOR IS TO PROVIDE ULC-LISTED FIRESTOP SYSTEMS AS REQUIRED FOR ALL BUILDING SERVICE PENETRATIONS THROUGH RATED ASSEMBLIES. REFER TO MECHANICAL AND ELECTRICAL DRAWINGS.					
3.	THE CONTRACTOR IS TO PROVIDE ULC-LISTED FIRESTOP SYSTEMS AS REQUIRED FOR ALL RATED PARTITION ASSEMBLY CONDITIONS.					
4.	ALL WALLS WITHOUT A WALL TAG ARE TO BE CONSTRUCTED AS PARTITION TYPE P1, UNLESS NOTED OTHERWISE.					
5.	UNLESS NOTED OTHERWISE, ALL PARTITION AND FURRING ASSEMBLIES ARE TO EXTEND FROM STRUCTURAL DECK/SLAB TO UIS OF STRUCTURAL DECK/SLAB ABOVE.					
6.	HEIGHT LIMITS FOR NON-LOADBEARING INTERIOR AND EXTERIOR CONCRETE/CMU MASONRY IS TO CONFORM TO CBC 9.20.10.1. REFER TO STRUCTURAL DRAWINGS FOR REINFORCING, LINTELS, AND LATERAL SUPPORT.					
7.	HEIGHT LIMITS OF INTERIOR AND FURRING PARTITION STEEL STUD FRAMING IS TO CONFORM TO CBC 9.24.2.1, OR STEEL STUD SUPPLIER HEIGHT TABLES.					
8.	THE CONTRACTOR IS TO PROVIDE ENGINEERED SHOP DRAWINGS, SIGNED AND SEALED BY A P.ENG LICENSED WITHIN THE PROVINCE OF ONTARIO FOR ALL STEEL STUD FRAMING DENOTED AS "WIND-BEARING" OR "STRUCTURAL".					
9.	THE CONTRACTOR IS TO PROVIDE ENGINEERED SHOP DRAWINGS, SIGNED AND SEALED BY A STRUCTURAL P.ENG LICENSED WITHIN THE PROVINCE OF ONTARIO FOR ALL EXTERIOR CLADDING PANEL SYSTEMS, INCLUDING ALL ASSOCIATED SUPPORT FRAMING AND CONNECTIONS.					
10.	THE CONTRACTOR IS TO PROVIDE STRUCTURAL STUD FRAMING AS REQUIRED TO SUPPORT ALL EXTERIOR CURTAINWALL, STOREFRONT GLAZING AND PUNCH WINDOW SYSTEMS. IN ADDITION TO ALL INTERIOR SCREENS, IT IS THE RESPONSIBILITY OF THE CONTRACTOR TO COORDINATE STUD SPACING AND CONFIGURATION AS REQUIRED TO MEET CURTAINWALL, STOREFRONT, PUNCH WINDOW, AND INTERIOR SCREEN SUPPLIER REQUIREMENTS.					
11.	PROVIDE CEMENT BOARD IN LIEU OF GYPSUM BOARD AT ALL ASSEMBLIES TO RECEIVE TILE FINISHES. REFER TO FINISH PLANS.					
12.	IN AREAS WITH HIGH VAPOUR CONTENT (IE. JANITOR ROOMS AND WASHROOMS) PROVIDE MOULD-RESISTANT GYPSUM BOARD IN LIEU OF REGULAR GYPSUM BOARD WHERE PAINT FINISHES ARE INDICATED. REFER TO FINISH PLANS.					
13.	PROVIDE FLEXIBLE BONDED WATERPROOFING AND VAPOUR RETARDER MEMBRANE AT ALL SHOWER AREAS RECEIVING TILE (FLOORS AND WALLS).					
14.	PROVIDE CONT. ACOUSTICAL SEALANT (BOTH SIDES) AT TOP AND BOTTOM OF ALL INTERIOR STUD AND GYPSUM BOARD PARTITIONS. PROVIDE ULC-LISTED SEALANT AT ALL RATED PARTITIONS AS REQUIRED. REFER TO FIRE SEPARATION DRAWINGS.					
15.	ACCESS PANELS LOCATED WITHIN SUSPENDED GYPSUM BOARD CEILING ASSEMBLIES ARE TO BE PAINTED OUT TO MATCH THE SURROUNDING CEILING FINISH. PROVIDE ULC-LISTED ACCESS PANEL WHERE PANEL IS LOCATED IN A RATED CEILING. REFER TO FIRE SEPARATION DRAWINGS.					
16.	ACCESS PANELS LOCATED WITHIN EXTERIOR SOFFITS ARE TO BE PAINTED OUT TO MATCH THE SURROUNDING SOFFIT FINISH.					
17.	UNLESS NOTED OTHERWISE, ASSEMBLIES ABOVE DOORS, WINDOWS, EXTERIOR OPENINGS AND INTERIOR SCREENS IS TO BE THE SAME AS THE TYPE DENOTED ON EITHER SIDE.					
18.	PROVIDE 19mm PLYWOOD BLOCKING AS REQUIRED FOR ALL GRAB-BARS AND WALL MOUNTED ACCESSORIES. REFER TO FINISH PLANS AND INTERIOR ELEVATIONS.					
19.	ALL R AND RSI VALUES SHOWN ARE NOMINAL. REFER TO PROJECT MANUAL FOR FULL LISTING OF INSULATION TYPES AND WEATHER BARRIER TYPES.					

WEATHER BARRIER AND FLASHING LEGEND	
AWP-1	AIR AND WATER BARRIER, VAPOUR PERMEABLE
AWV-1	AIR, WATER, AND VAPOUR BARRIER
MR-1	MODIFIED BUILT-UP ROOFING MEMBRANE
FDP-1	FOUNDATION DAMPPROOFING MEMBRANE
MTF-#	METAL FLASHING (# DENOTES TYPE)
STS-1	SILICONE TRANSITION SYSTEM
TRM-1	TRANSITION MEMBRANE
TWF-1	THRU-WALL FLEXIBLE FLASHING MEMBRANE
VCB-1	VAPOUR CONTROL BARRIER, SLABS (15 MIL)
VCB-2	VAPOUR CONTROL BARRIER, WALLS (6 MIL)
VCB-3	VAPOUR CONTROL AND AIR BARRIER, ROOF DECKS (SELF-ADHERED)

GYPSUM BOARD AND SHEATHING LEGEND	
GB-1	16mm GYPSUM BOARD
GB-2	16mm TYPE "X" GYPSUM BOARD
GB-3	16mm TYPE "X" GYPSUM BOARD, ABUSE RESISTANT
GB-4	16mm TYPE "X" GYPSUM BOARD, MOULD RESISTANT
GB-5	16mm TYPE "X" GYPSUM BOARD, ABUSE AND MOULD RESISTANT
GB-6	16mm TYPE "X" GYPSUM BOARD, HIGH-IMPACT AND MOULD RESISTANT
GB-7	25mm SHAFTWALL LINER PANEL
CB-1	16mm CEMENT BOARD
TB-1	16mm TILE BACKER BOARD
EG-1	EXTERIOR GRADE GYPSUM SHEATHING
EP-1	EXTERIOR GRADE PLYWOOD SHEATHING

INSULATION LEGEND	
INS-1	MINERAL FIBRE BOARD INSULATION
INS-2	MINERAL FIBRE BATT INSULATION
INS-3	MINERAL FIBRE ACOUSTICAL BATT INSULATION
INS-4	EXTRUDED POLYSTYRENE BOARD INSULATION
INS-5	EXTRUDED POLYSTYRENE BOARD INSULATION (HIGH-DENSITY)
INS-6	EXTRUDED POLYSTYRENE BOARD INSULATION (CONCRETE-FACED)
INS-7	POLYISOCYANURATE ROOFING INSULATION
INS-8	POLYISOCYANURATE ROOFING INSULATION, TAPERED (2% SLOPE)
INS-9	ROOFING INSULATION COVERBOARD

ISSUE DATE:		
NO.	DATE	DESCRIPTION
05	2022-02-11	ISSUED FOR TENDER
04	2022-01-31	ISSUED FOR 90% CD REVIEW
03	2022-01-18	ISSUED FOR PERMIT
02	2022-01-17	ISSUED FOR CLIENT REVIEW
01	2022-01-11	ISSUED FOR COORDINATION

PROJECT:
Park Manor Public School - Phase 2 Interior and Window Enhancements

WRDSB Tender #7266-RW-22

DRAWING TITLE:
ASSEMBLIES AND LEGENDS


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SCALE: N/A
DRAWN BY: DS
REVIEWED BY: DS


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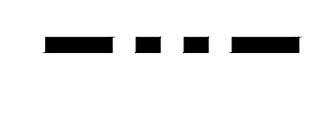
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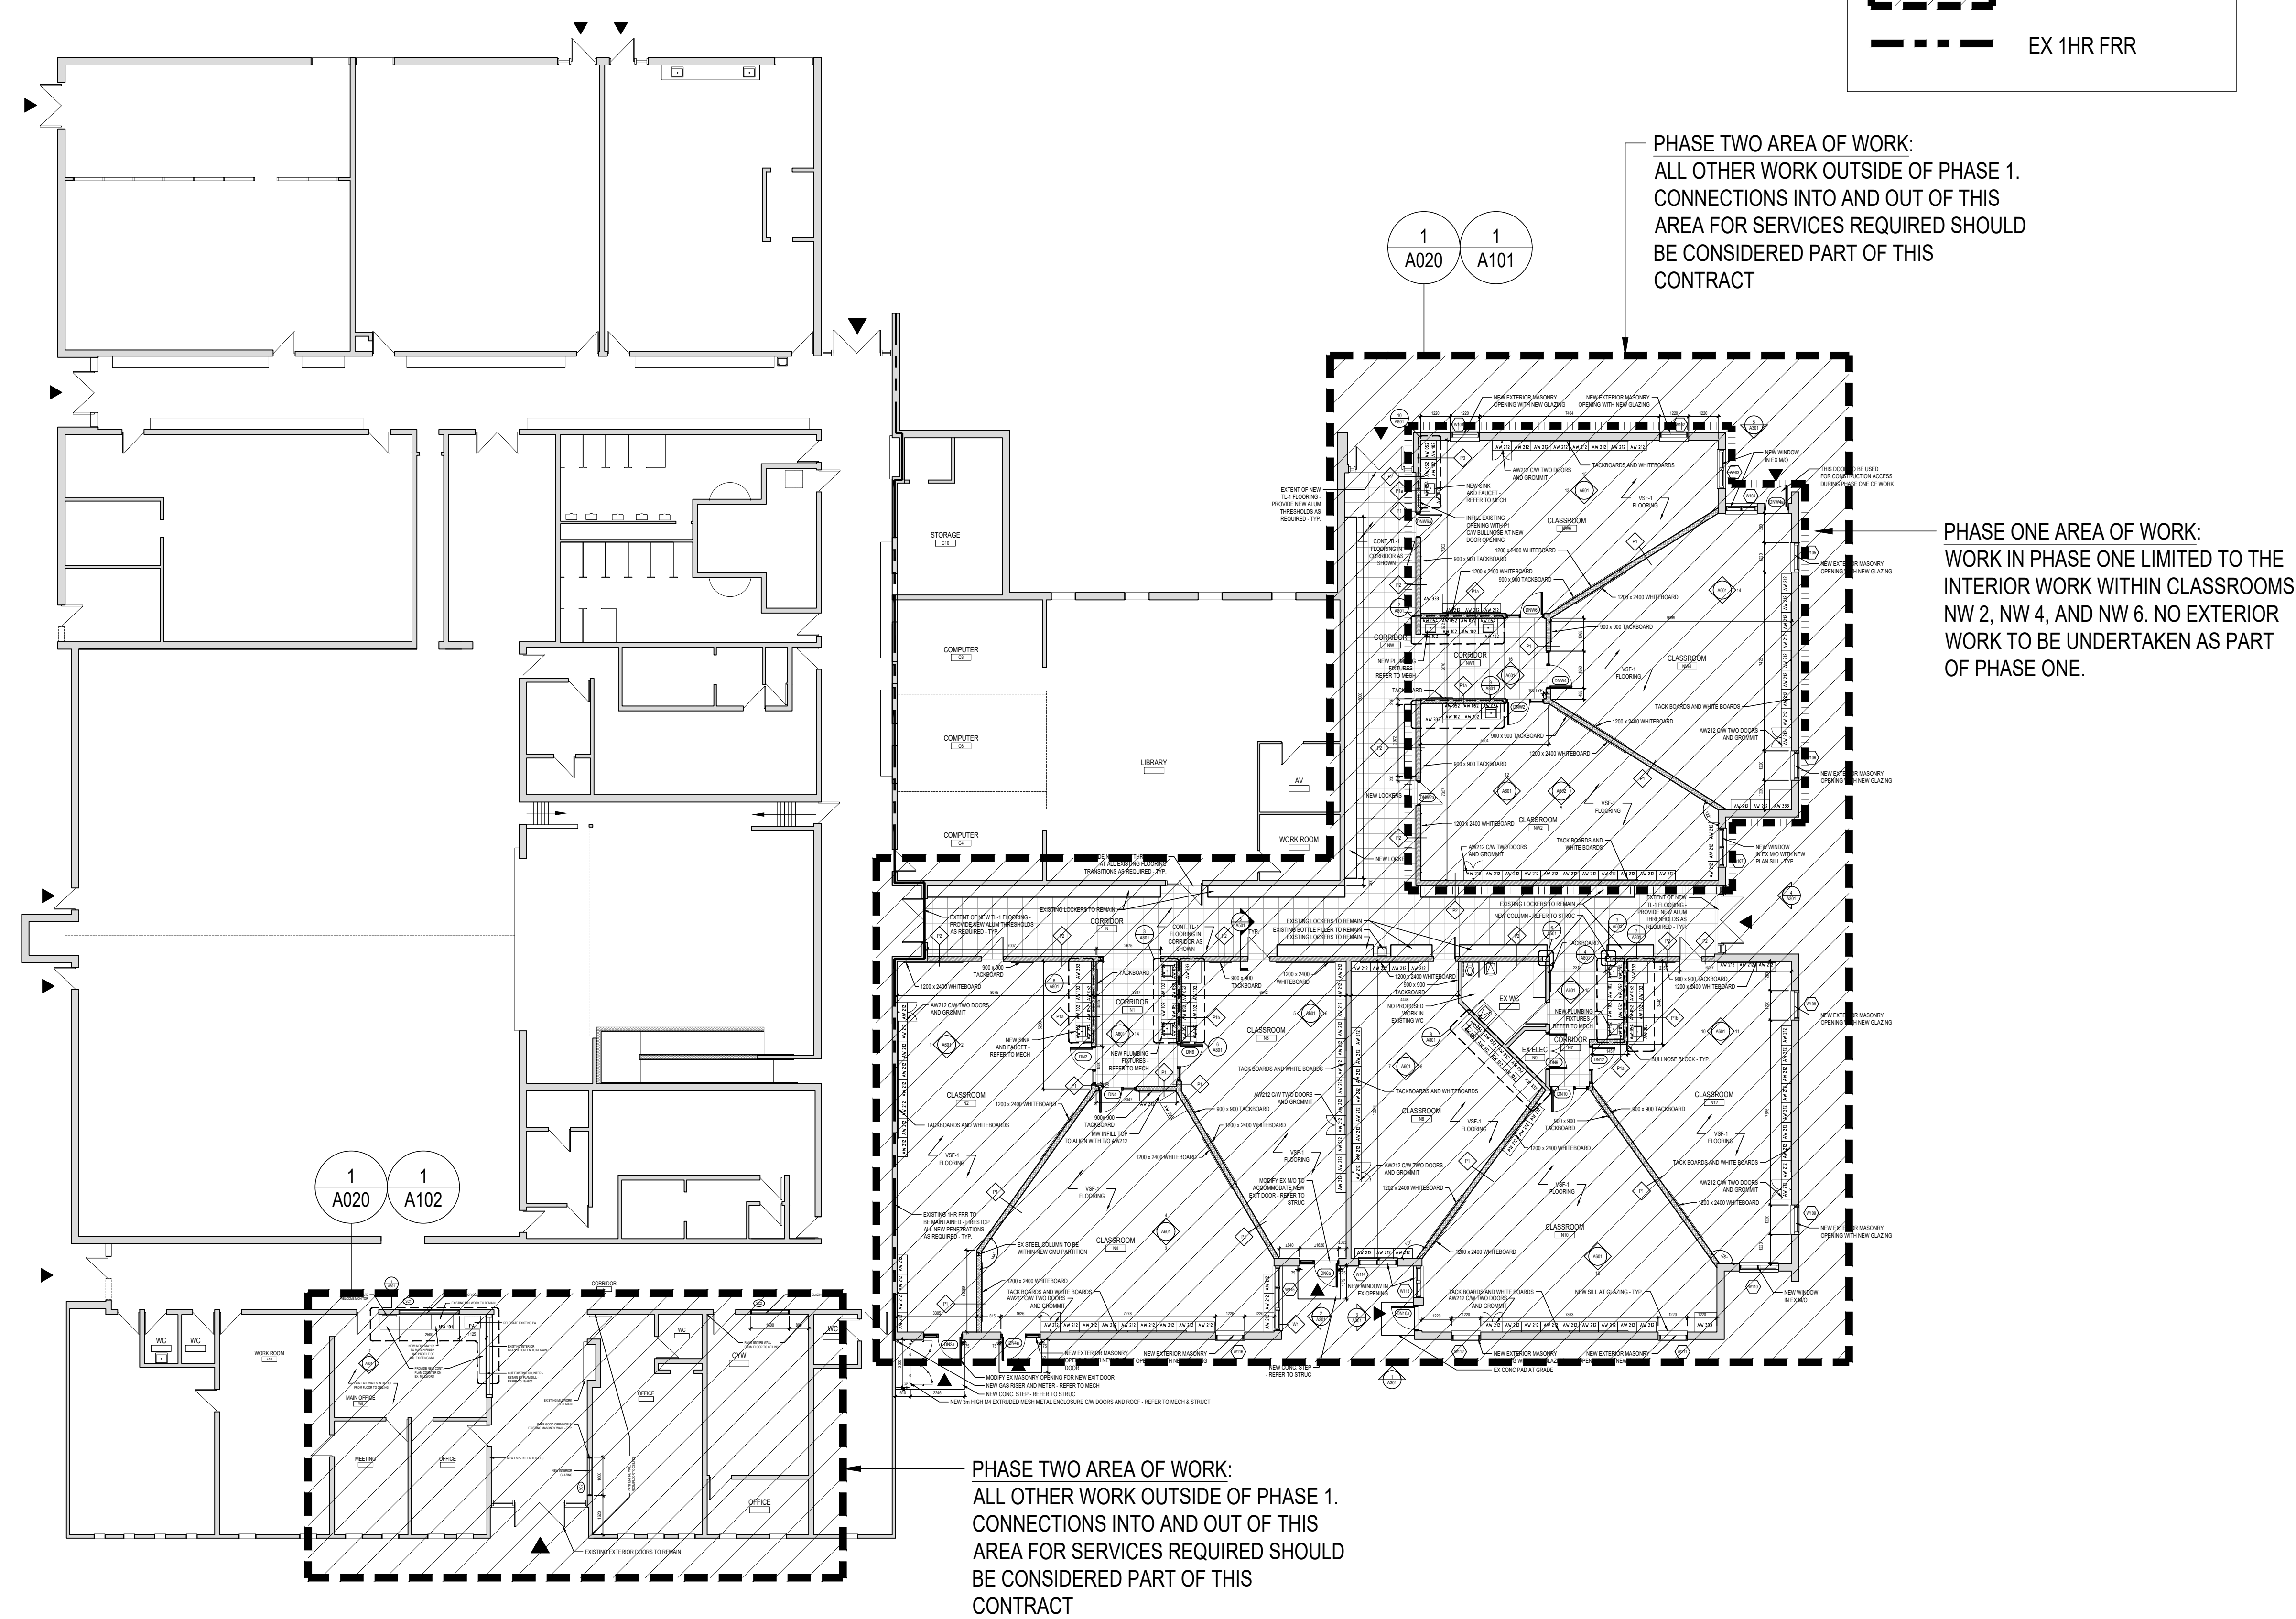
DO NOT SCALE DRAWINGS

PLAN LEGEND

 PHASE ONE AREA OF WORK : JUNE 1

 PHASE TWO AREA OF WORK : JULY 1

 EX 1HR FRR

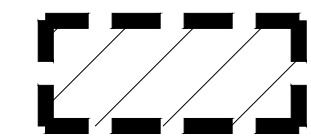

ISSUE DATE:


NO.	DATE	DESCRIPTION
07	2022-02-11	ISSUED FOR TENDER
06	2022-01-31	ISSUED FOR 90% CD REVIEW
05	2022-01-18	ISSUED FOR PERMIT
04	2022-01-17	ISSUED FOR CLIENT REVIEW
03	2022-01-11	ISSUED FOR COORDINATION
02	2021-12-20	ISSUED FOR 100% LDD
01	2021-12-09	ISSUED FOR COORDINATION

PROJECT:
 Park Manor Public School - Phase 2 Interior and Window Enhancements

WRDSB Tender #7266-RW-22

DRAWING TITLE:
 GROUND FLOOR PLAN - AREAS OF WORK


PROJECT NO: 21970
SCALE: 1:150
DRAWN BY: JG
REVIEWED BY: DS

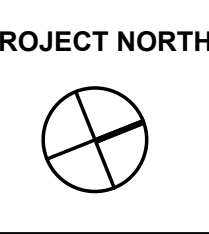

DRAWING NO:
A006

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DO NOT SCALE DRAWINGS

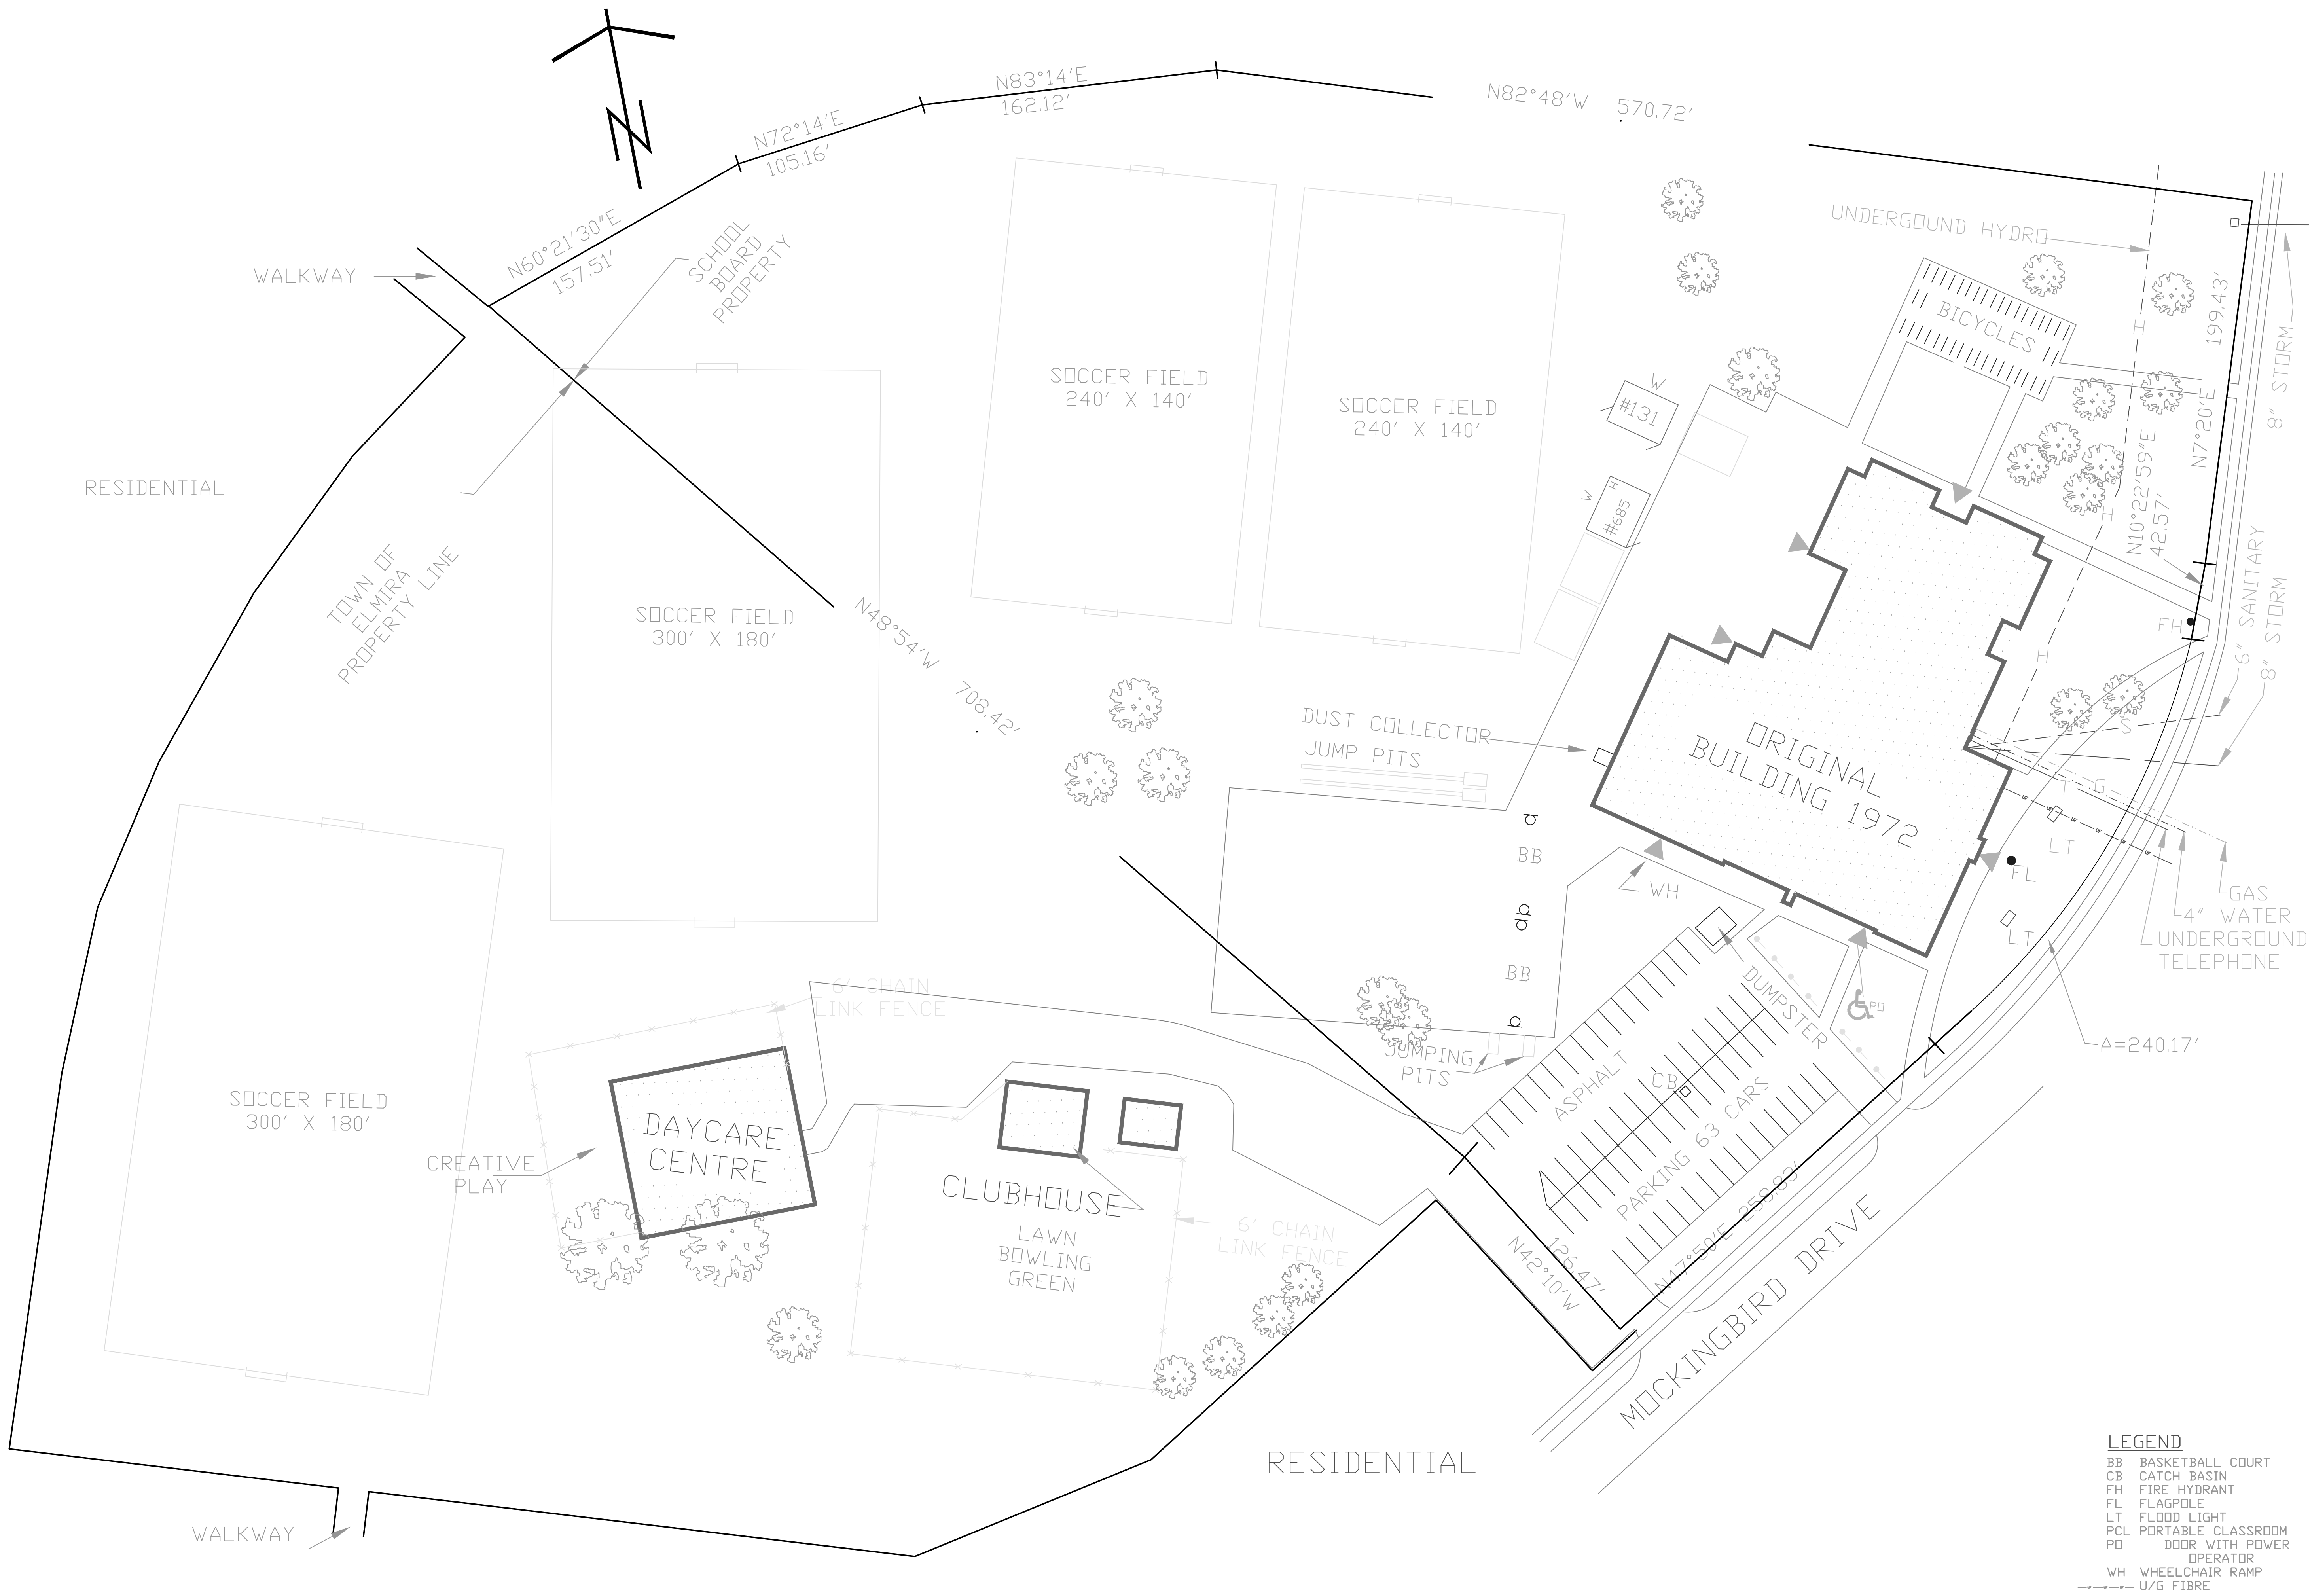

- LEGEND**
- BB BASKETBALL COURT
 - CB CATCH BASIN
 - FH FIRE HYDRANT
 - FL FLAGPOLE
 - LT FLOOD LIGHT
 - PCL PORTABLE CLASSROOM
 - PD DOOR WITH POWER OPERATOR
 - WH WHEELCHAIR RAMP
 - U/G FIBRE

WRDSB PROPERTY : 8.83 ACRES
 TOWN OF ELMIRA PROPERTY : 7.65 ACRES

NOTE: NO SITE WORK PROPOSED, NO CHANGE TO BUILDING FOOTPRINT

ISSUE DATE:

NO.	DATE	DESCRIPTION
03	2022-02-11	ISSUED FOR TENDER
02	2022-01-31	ISSUED FOR 90% CD REVIEW
01	2022-01-18	ISSUED FOR PERMIT

PROJECT:

**Park Manor Public School - Phase 2
 Interior and Window Enhancements**

WRDSB Tender #7266-RW-22

DRAWING TITLE:

SITE PLAN

PROJECT NO: 21970
SCALE: N/A
DRAWN BY: JG
REVIEWED BY: DS

DRAWING NO:
A010

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DO NOT SCALE DRAWINGS


PLAN LEGEND	
	EXISTING WALL TO REMAIN
	EXISTING WALL/ ELEMENT TO BE DEMOLISHED
	EXISTING 1 HR FRR TO REMAIN
	EXISTING DOOR TO REMAIN
	EXISTING DOOR TO BE DEMOLISHED

NOTES ON DESIGNATED SUBSTANCES:

1. ABATEMENT OF ALL DESIGNATED SUBSTANCES WITHIN AREAS OF WORK AS IDENTIFIED BY THE SITE REPORT DATED FEB. 1, 2010 TO BE CONSIDERED PART OF THE CONTRACT. FOR ALL DESIGNATED SUBSTANCES FOUND WITHIN THE AREA OF WORK AND NOT NOTED IN THE AFOREMENTIONED REPORT, REFER TO THE CASH ALLOWANCES OUTLINED IN THE SPECIFICATION.
2. IN NO WAY SHOULD THE CONTRACTOR ASSUME IT OTHERWISE TO BE 100% FREE OF DESIGNATED SUBSTANCES AND AS SUCH THE CONTRACTOR SHOULD TAKE EVERY PRECAUTION WHEN WORKING IN THE BUILDING.
3. IF THE CONTRACTOR ENCOUNTERS TOXIC OR HAZARDOUS SUBSTANCES, OR HAS REASONABLE GROUNDS TO BELIEVE THAT TOXIC OR HAZARDOUS SUBSTANCES ARE PRESENT, THE CONTRACTOR SHALL TAKE ALL REASONABLE STEPS, INCLUDING STOPPING THE WORK, TO ENSURE THAT NO PERSONS EXPOSURE TO ANY TOXIC OR HAZARDOUS SUBSTANCES EXCEEDS ANY APPLICABLE TIME WEIGHTED LEVELS PRESCRIBED BY APPLICABLE LEGISLATION AT THE PLACE OF THE WORK AND IMMEDIATELY REPORT THE CIRCUMSTANCES TO THE OWNER IN WRITING.

GENERAL DEMOLITION NOTES:

1. CONTRACTOR TO REVIEW AND FOLLOW "H.S.P." (HEALTH AND SAFETY PROCEDURES) AS DICTATED IN THE SPECIFICATION BEFORE BEGINNING ANY WORK.
2. INFORMATION SHOWN ON THE DEMOLITION DRAWINGS IS BASED ON INFORMATION AVAILABLE FROM EXISTING BUILDING DRAWINGS AND A LIMITED VISUAL INSPECTION.
3. CONTRACTOR TO CHECK ALL DRAWINGS AGAINST ACTUAL CONDITIONS ON SITE AND REPORT ANY DISCREPANCIES TO THE ARCHITECT PRIOR TO PROCEEDING WITH THE WORK.
4. ALL DIMENSIONS ARE TO BE DETERMINED USING THE PROPOSED CONTRACT DOCUMENTS. NO DIMENSIONS ARE TO BE INFERRED FROM THE DEMOLITION DRAWINGS.
5. CONTRACTOR TO MAKE GOOD ALL WALLS, CEILINGS AND FLOORING TO REMAIN THAT ARE AFFECTED BY DEMOLITION. WHERE EXISTING SURFACES ARE DISTURBED MAKE GOOD EXISTING SURFACE ON ENTIRE PLANE OR SURFACE BACK TO NEAREST CORNER OR CHANGE IN MATERIAL.
6. CONTRACTOR TO SUPPLY AND INSTALL ALL NECESSARY HOARDING TAPPS, ETC TO PROTECT WORK AND MAINTAIN A DUST FREE ENVIRONMENT IN SURROUNDING AREAS.
7. CONTRACTOR TO MAKE GOOD ALL JUNCTIONS BETWEEN EXISTING STRUCTURES IDENTIFIED TO BE REMOVED AND EXISTING STRUCTURES IDENTIFIED TO REMAIN.
8. REMOVE & DISPOSE OF ALL EXISTING CEILING FINISHES AND SUPPORT SYSTEMS FOR CLARITY OF BRAININGS CEILING IS NOT DASHED IN DEMOLITION DRAWINGS, HOWEVER THEY MUST BE REMOVED AS NOTED HERE. REMOVAL OF EXISTING CEILING FINISHES SHALL INCLUDE ALL CEILING LAYERS, MATERIALS, SUPPORT SYSTEMS, MECHANICAL AND ELECTRICAL, AND ABANDONED DEBRIS IN THE CEILING SPACE. REMOVE ALL DOUBLE CEILINGS, WHERE OLDER CEILING REMAINS OBSCURED BY EXISTING CEILING.
9. REMOVE & DISPOSE OF ALL ABANDONED SERVICES - FIXTURES, EQUIPMENT, CONDUITS, PIPE, WIRING, ETC. (INTERIOR AND EXTERIOR) IN AREAS OF WORK.
10. REMOVE & DISPOSE OF ALL EXISTING MILLWORK, FURNITURE, LOOSE MISCELLANEOUS ARTICLES AND EQUIPMENT IN AREAS OF WORK UNLESS OTHERWISE NOTED.
11. REMOVE & DISPOSE ALL EXISTING SIGNAGE WITHIN AREAS OF WORK UNLESS OTHERWISE NOTED.
12. DEMOLISH ALL EXISTING ELEMENTS SHOWN HERE AS WELL AS ANY EXISTING ELEMENT WHERE DEMOLITION OF THE ELEMENT IS REQUIRED TO ACCOMMODATE THE NEW WORK.
13. REMOVE ALL MECHANICAL SYSTEMS, FIXTURES, EQUIPMENT, PIPING, CONDUIT, DUCTWORK, ETC. UNLESS NOTED IN AREA OF WORK.
14. THIS IS NOT AN EXHAUSTIVE LIST. TO BE READ WITH ALL DRAWINGS AND SPECIFICATIONS INCLUDING BUT NOT LIMITED TO DEMOLITION DRAWINGS AND SPEC SECTIONS).
15. REFER TO SPECIFICATIONS FOR ADDITIONAL REQUIREMENTS.
16. PARK MANOR WILL REMAIN OPERATIONAL THROUGHOUT THE DURATION OF PHASE ONE WORK. CONTRACTOR IS REQUIRED TO FULLY PROTECT STUDENTS FROM DUST & DEBRIS, NOISE TO ACCEPTABLE LIMITS. PROTECTION FROM WEATHER INCLUDING COLD AND PRECIPITATION, PROTECTION MEASURES WILL BE THE FULL RESPONSIBILITY OF THE CONTRACTOR. THE CONTRACTOR IS TO WALK THE PERIMETER OF THE SITE EACH MORNING UPON ARRIVAL AND AT THE END OF DAY TO INSPECT CONDITIONS. THE CONTRACTOR IS RESPONSIBLE TO ENSURE THAT EMERGENCY EXITS AND EGRESS FROM OCCUPIED STUDENT SPACES REMAIN UNOBSTRUCTED AND MEET BUILDING CODE AND EGRESS REQUIREMENTS BY AUTHORITIES HAVING JURISDICTION. IF IN DOUBT, DISCUSS WITH THE CONSULTANTS. IF EMERGENCY EXITS CANNOT BE MAINTAINED TO CODE, THE CONTRACTOR WILL BE REQUIRED TO REVIEW THE SITUATION WITH AUTHORITIES AND PROVIDE ANY ADDITIONAL REQUIREMENT AUTHORITIES RECOMMEND, INCLUDING A FIRE WATCH.

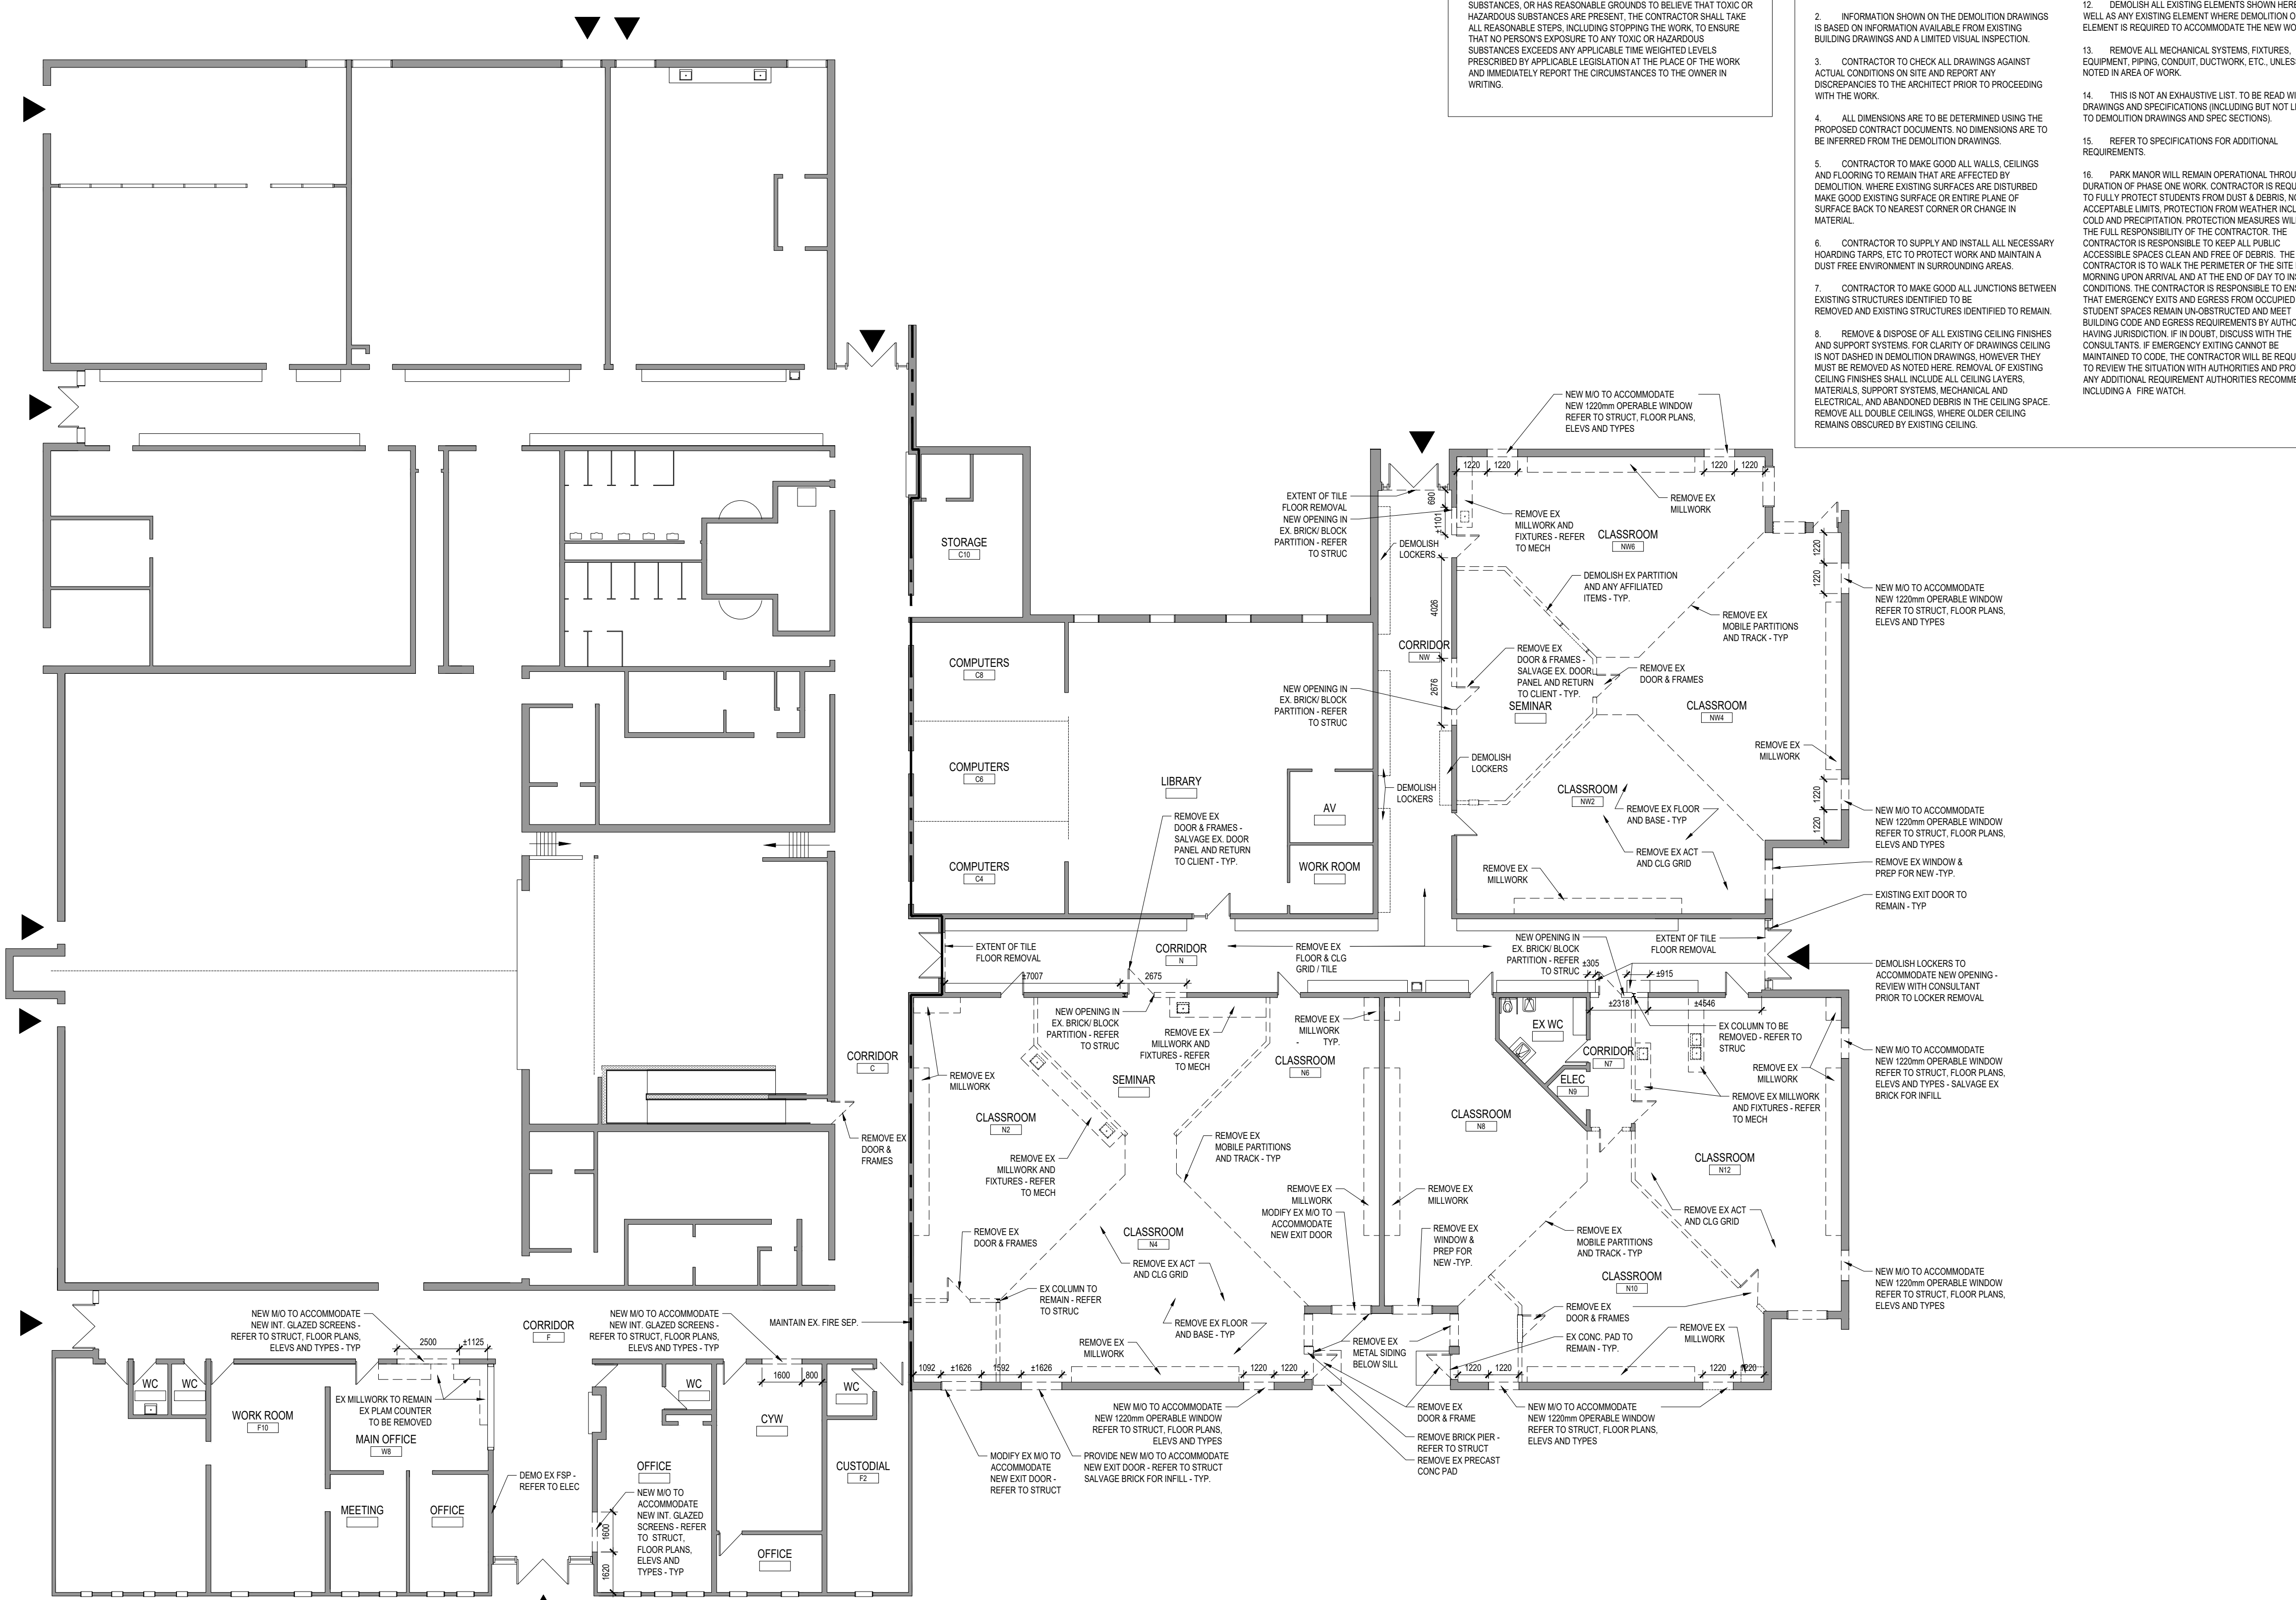

1 GROUND FLOOR - DEMOLITION PLAN
A020 1:150

ISSUE DATE:

NO.	DATE	DESCRIPTION
07	2022-02-11	ISSUED FOR TENDER
06	2022-01-31	ISSUED FOR 90% CD REVIEW
05	2022-01-18	ISSUED FOR PERMIT
04	2022-01-17	ISSUED FOR CLIENT REVIEW
03	2022-01-11	ISSUED FOR COORDINATION
02	2021-12-20	ISSUED FOR 100% DD
01	2021-12-09	ISSUED FOR COORDINATION

PROJECT:
Park Manor Public School - Phase 2 Interior and Window Enhancements

WRDSB Tender #7266-RW-22


DRAWING TITLE:
GROUND FLOOR PLAN - DEMOLITION

PROJECT NO: 21970	PROJECT NORTH:
SCALE: 1:150	
DRAWN BY: JG	
REVIEWED BY: DS	

DRAWING NO:
A020

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DO NOT SCALE DRAWINGS

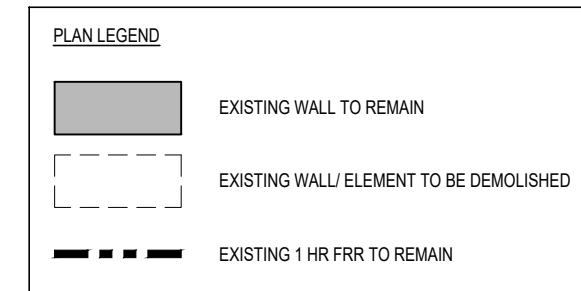


NOTES ON DESIGNATED SUBSTANCES:

- THE SCOPE OF WORK DOES NOT ENTAIL THE REMOVAL OF DESIGNATED SUBSTANCES.
- IN NO WAY SHOULD THE CONTRACTOR ASSUME IT OTHERWISE TO BE 100% FREE OF DESIGNATED SUBSTANCES AND AS SUCH THE CONTRACTOR SHOULD TAKE EVERY PRECAUTION WHEN WORKING IN THE BUILDING.
- IF THE CONTRACTOR ENCOUNTERS TOXIC OR HAZARDOUS SUBSTANCES, OR HAS REASONABLE GROUNDS TO BELIEVE THAT TOXIC OR HAZARDOUS SUBSTANCES ARE PRESENT, THE CONTRACTOR SHALL TAKE ALL REASONABLE STEPS, INCLUDING STOPPING THE WORK, TO ENSURE THAT NO PERSONS EXPOSURE TO ANY TOXIC OR HAZARDOUS SUBSTANCES EXCEEDS ANY APPLICABLE TIME WEIGHTED LEVELS PRESCRIBED BY APPLICABLE LEGISLATION AT THE PLACE OF THE WORK AND IMMEDIATELY REPORT THE CIRCUMSTANCES TO THE OWNER IN WRITING.

GENERAL DEMOLITION NOTES:

- THE DEMOLITION DRAWINGS ILLUSTRATE A GENERAL SCOPE OF WORK. IT IS THE FULL RESPONSIBILITY OF THE CONTRACTOR TO DETERMINE THE FULL SCOPE OF DEMOLITION REQUIRED USING EXISTING CONDITIONS AND THE COMPLETE CONTRACT DOCUMENT SETS INCLUSIVE OF ALL DISCIPLINES INCLUDING BUT NOT LIMITED TO ARCHITECTURAL, STRUCTURAL, MECHANICAL, AND ELECTRICAL TO ACHIEVE THE FINAL SCOPE OF WORK.
- CONTRACTOR TO REVIEW AND FOLLOW "H.A.S.P." (HEALTH AND SAFETY PROCEDURES) AS DICTATED IN THE SPECIFICATION BEFORE BEGINNING ANY WORK.
 - INFORMATION SHOWN ON THE DEMOLITION DRAWINGS IS BASED ON INFORMATION AVAILABLE FROM EXISTING BUILDING DRAWINGS AND A LIMITED VISUAL INSPECTION.
 - CONTRACTOR TO CHECK ALL DRAWINGS AGAINST ACTUAL CONDITIONS ON SITE AND REPORT ANY DISCREPANCIES TO THE ARCHITECT PRIOR TO PROCEEDING WITH THE WORK.
 - ALL DIMENSIONS ARE TO BE DETERMINED USING THE PROPOSED CONTRACT DOCUMENTS. NO DIMENSIONS ARE TO BE INFERRED FROM THE DEMOLITION DRAWINGS.
 - CONTRACTOR TO MAKE GOOD ALL WALLS, CEILINGS AND FLOORING TO REMAIN THAT ARE AFFECTED BY DEMOLITION. WHERE EXISTING SURFACES ARE DISTURBED MAKE GOOD EXISTING SURFACE OR ENTIRE PLANE OF SURFACE BACK TO NEAREST CORNER OR CHANGE IN MATERIAL.
 - CONTRACTOR TO SUPPLY AND INSTALL ALL NECESSARY HOARDING TARPS, ETC TO PROTECT WORK AND MAINTAIN A DUST FREE ENVIRONMENT IN SURROUNDING AREAS.
 - CONTRACTOR TO MAKE GOOD ALL JUNCTIONS BETWEEN EXISTING STRUCTURES IDENTIFIED TO BE REMOVED AND EXISTING STRUCTURES IDENTIFIED TO REMAIN.
 - REMOVE & DISPOSE OF ALL EXISTING CEILING FINISHES AND SUPPORT SYSTEMS. FOR CLARITY OF DRAWINGS CEILING IS NOT DASHED IN DEMOLITION DRAWINGS, HOWEVER THEY MUST BE REMOVED AS NOTED HERE. REMOVAL OF EXISTING CEILING FINISHES SHALL INCLUDE ALL CEILING LAYERS, MATERIALS, SUPPORT SYSTEMS, MECHANICAL AND ELECTRICAL, AND ABANDONED DEBRIS IN THE CEILING SPACE. REMOVE ALL DOUBLE CEILINGS, WHERE OLDER CEILING REMAINS OBSCURED BY EXISTING CEILING.
 - REMOVE & DISPOSE OF ALL ABANDONED SERVICES - FIXTURES, EQUIPMENT, CONDUITS, PIPE, WIRING, ETC. INTERIOR AND EXTERIOR, IN AREAS OF WORK.
 - REMOVE & DISPOSE OF ALL EXISTING MILLWORK, FURNITURE, LOOSE MISCELLANEOUS ARTICLES AND EQUIPMENT IN AREAS OF WORK UNLESS OTHERWISE NOTED.
 - REMOVE & DISPOSE ALL EXISTING SIGNAGE WITHIN AREAS OF WORK UNLESS OTHERWISE NOTED.
 - DEMOLISH ALL EXISTING ELEMENTS SHOWN HERE AS WELL AS ANY EXISTING ELEMENT WHERE DEMOLITION OF THE ELEMENT IS REQUIRED TO ACCOMMODATE THE NEW WORK.
 - REMOVE ALL MECHANICAL SYSTEMS, FIXTURES, EQUIPMENT, PIPING, CONDUIT, DUCTWORK, ETC. UNLESS NOTED IN AREA OF WORK.
 - THIS IS NOT AN EXHAUSTIVE LIST. TO BE READ WITH ALL DRAWINGS AND SPECIFICATIONS (INCLUDING BUT NOT LIMITED TO DEMOLITION DRAWINGS AND SPEC SECTIONS).
 - REFER TO SPECIFICATIONS FOR ADDITIONAL REQUIREMENTS.
 - PARK MANOR WILL REMAIN OPERATIONAL THROUGH THE DURATION OF PHASE ONE WORK. CONTRACTOR IS REQUIRED TO FULLY PROTECT STUDENTS FROM DUST & DEBRIS, NOISE TO ACCEPTABLE LIMITS, PROTECTION FROM WEATHER INCLUDING COLD AND PRECIPITATION. PROTECTION MEASURES WILL BE THE FULL RESPONSIBILITY OF THE CONTRACTOR. THE CONTRACTOR IS RESPONSIBLE TO KEEP ALL PUBLIC ACCESSIBLE SPACES CLEAN AND FREE OF DEBRIS. THE CONTRACTOR IS TO WALK THE PERIMETER OF THE SITE EACH MORNING UPON ARRIVAL, AND AT THE END OF DAY TO INSPECT CONDITIONS. THE CONTRACTOR IS RESPONSIBLE TO ENSURE THAT EMERGENCY EXITS AND EGRESS FROM OCCUPIED STUDENT SPACES REMAIN UNOBSTRUCTED AND MEET BUILDING CODE AND EGRESS REQUIREMENTS BY AUTHORITIES HAVING JURISDICTION. IF IN DOUBT, DISCUSS WITH THE CONSULTANTS. IF EMERGENCY EXITING CANNOT BE MAINTAINED TO CODE, THE CONTRACTOR WILL BE REQUIRED TO REVIEW THE SITUATION WITH AUTHORITIES AND PROVIDE ANY ADDITIONAL REQUIREMENT AUTHORITIES RECOMMEND, INCLUDING A FIRE WATCH.

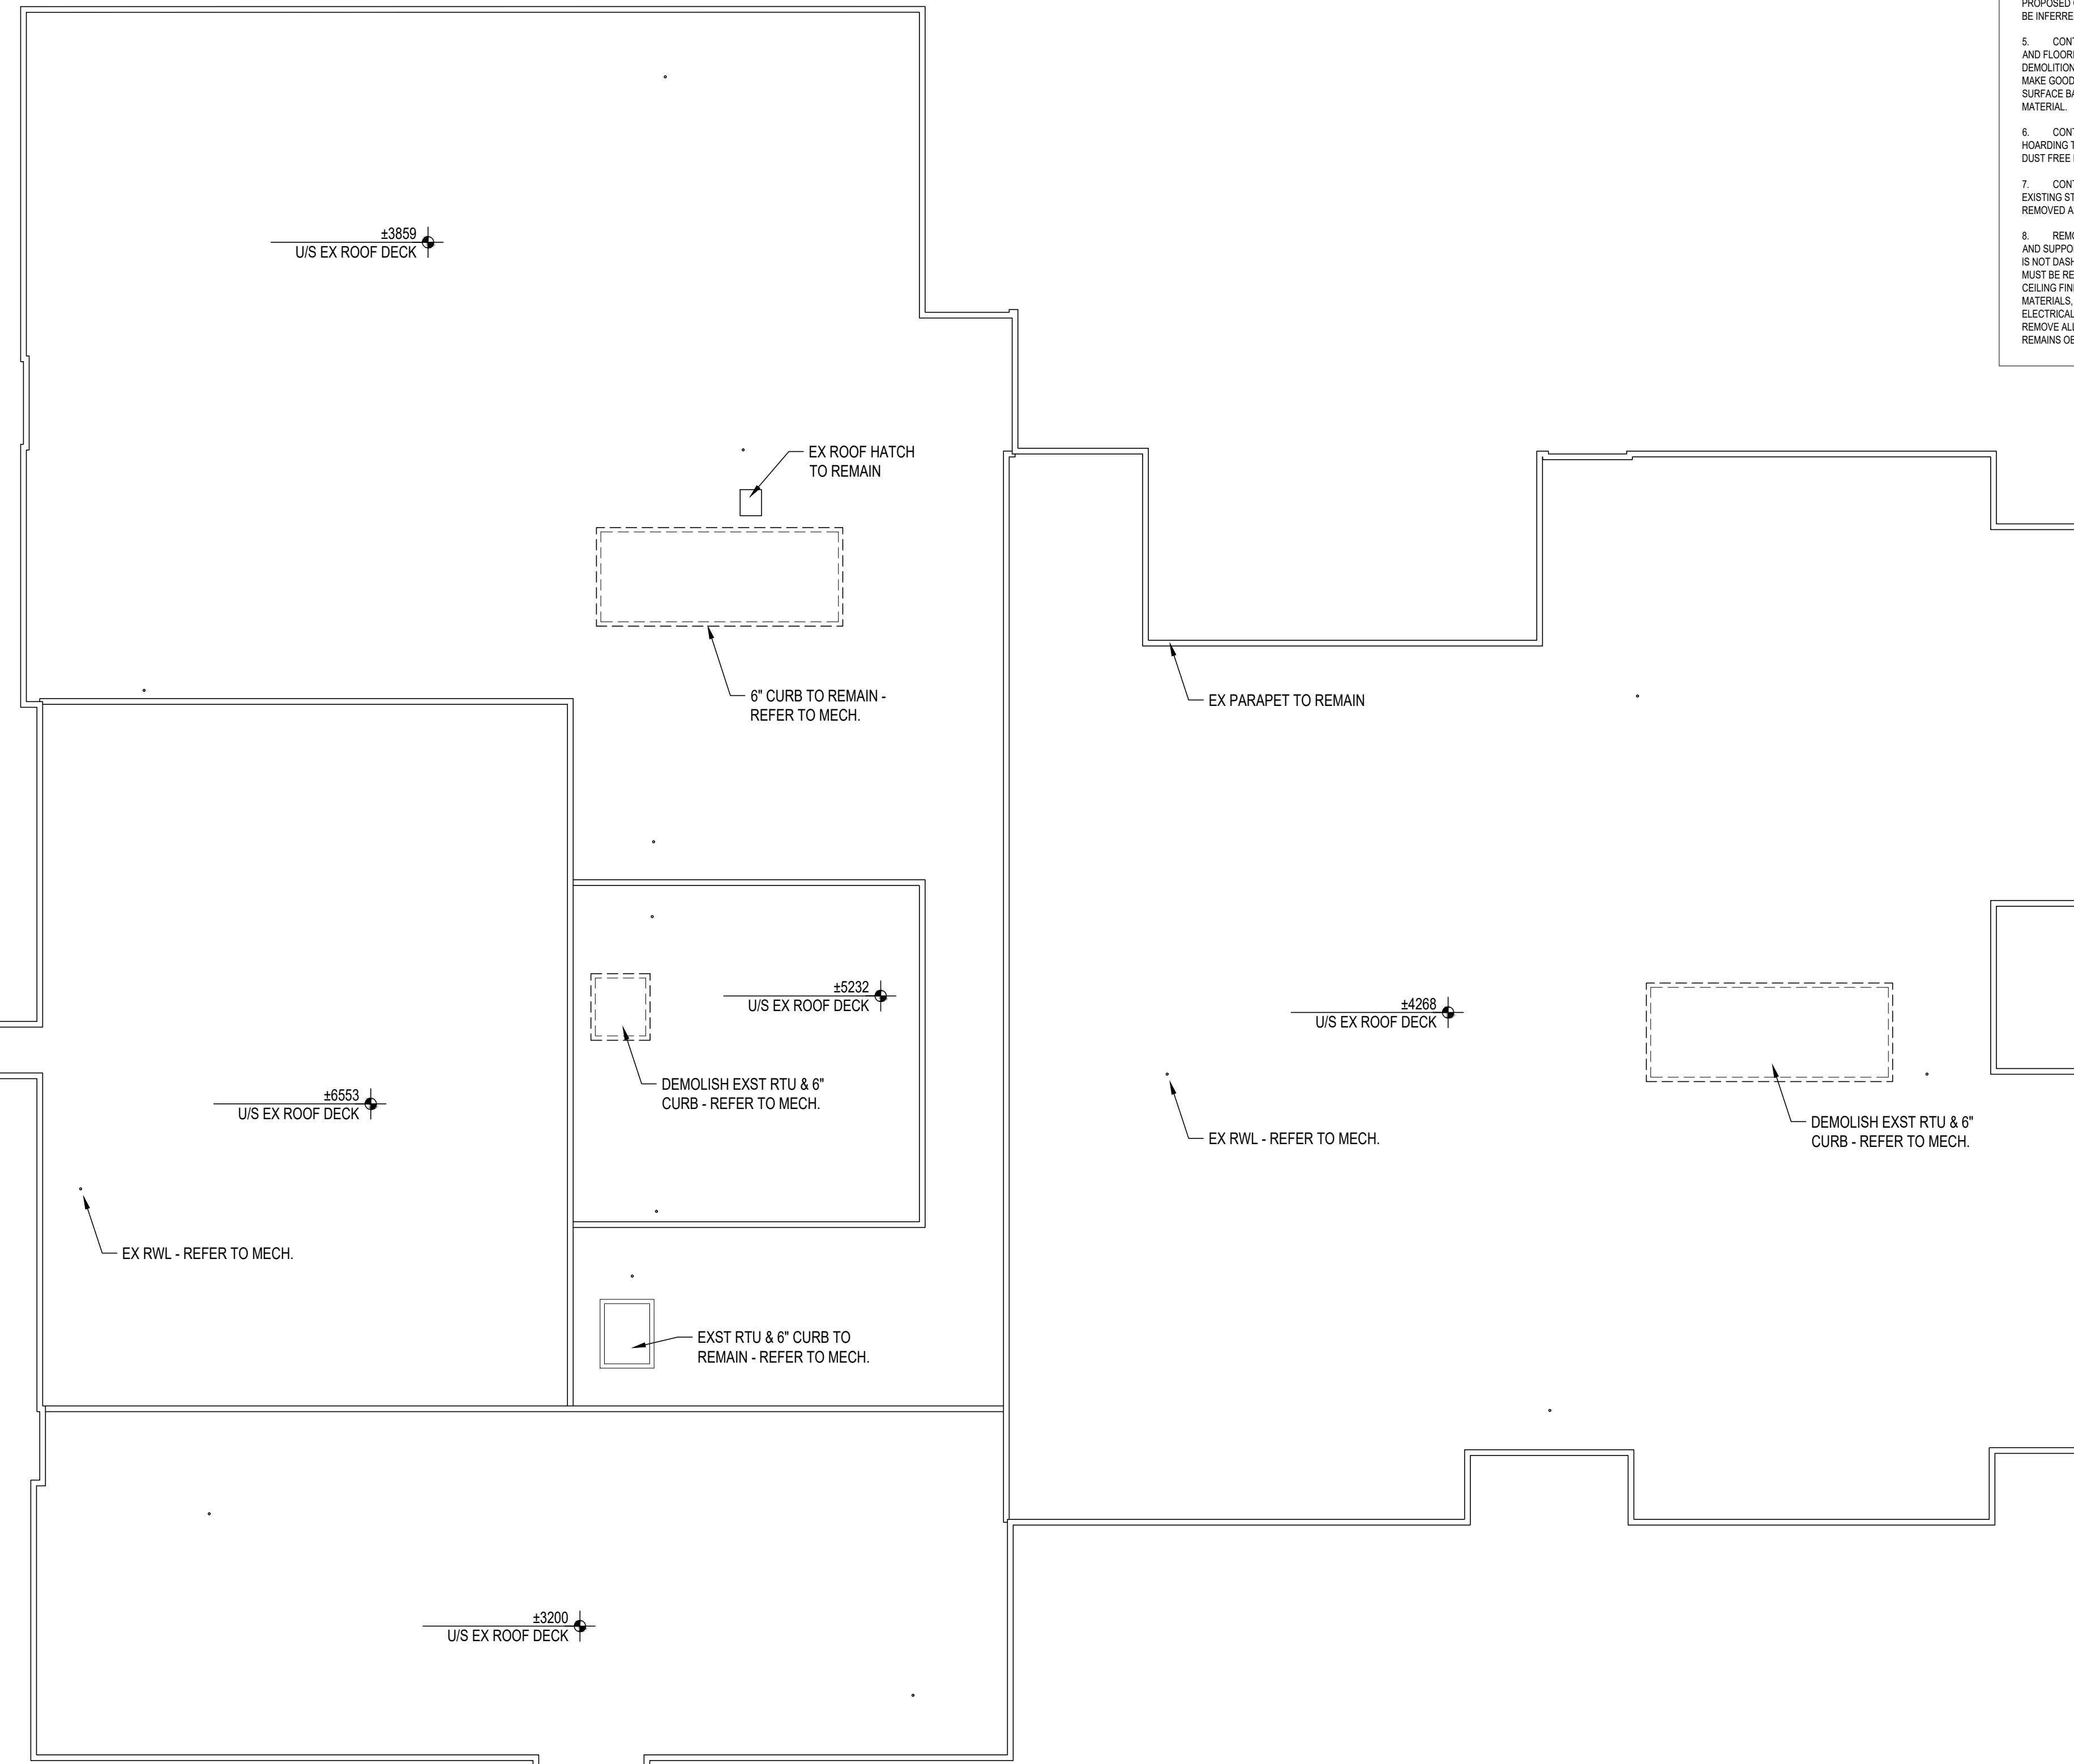

ISSUE DATE:

NO.	DATE	DESCRIPTION
04	2022-02-11	ISSUED FOR TENDER
03	2022-01-31	ISSUED FOR 90% CD REVIEW
02	2022-01-18	ISSUED FOR PERMIT
01	2022-01-17	ISSUED FOR CLIENT REVIEW

PROJECT:


Park Manor Public School - Phase 2 Interior and Window Enhancements

WRDSB Tender #7266-RW-22

DRAWING TITLE:

ROOF PLAN - DEMOLITION

PROJECT NO: 21970
SCALE: 1:150
DRAWN BY: DS
REVIEWED BY: DS

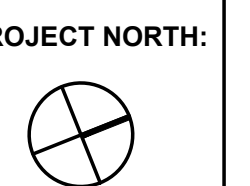

DRAWING NO:

A021

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DO NOT SCALE DRAWINGS

PLAN LEGEND	
	EXISTING WALL TO REMAIN
	NEW CMU PARTITION - REFER TO ASSEMBLIES
	EXISTING WALL/ P2 - REFER TO ASSEMBLIES
	EXISTING 1 HR FRR TO REMAIN
	EXISTING DOOR
	NEW DOOR

ISSUE DATE:

NO.	DATE	DESCRIPTION
08	2022-02-11	ISSUED FOR TENDER
07	2022-01-31	ISSUED FOR 90% CD REVIEW
06	2022-01-18	ISSUED FOR PERMIT
05	2022-01-17	ISSUED FOR CLIENT REVIEW
04	2022-01-07	ISSUED FOR COORDINATION
03	2022-01-06	ISSUED FOR CLIENT REVIEW
02	2021-12-20	ISSUED FOR 100% CD
01	2021-12-09	ISSUED FOR COORDINATION

PROJECT:

Park Manor Public School - Phase 2 Interior and Window Enhancements

WRDSB Tender #7266-RW-22

DRAWING TITLE:

GROUND FLOOR PLAN - PARTIAL PROPOSED


PROJECT NO: 21970
 SCALE: 1:75
 DRAWN BY: DS
 REVIEWED BY: DS

PROJECT NORTH:




DRAWING NO:

A101

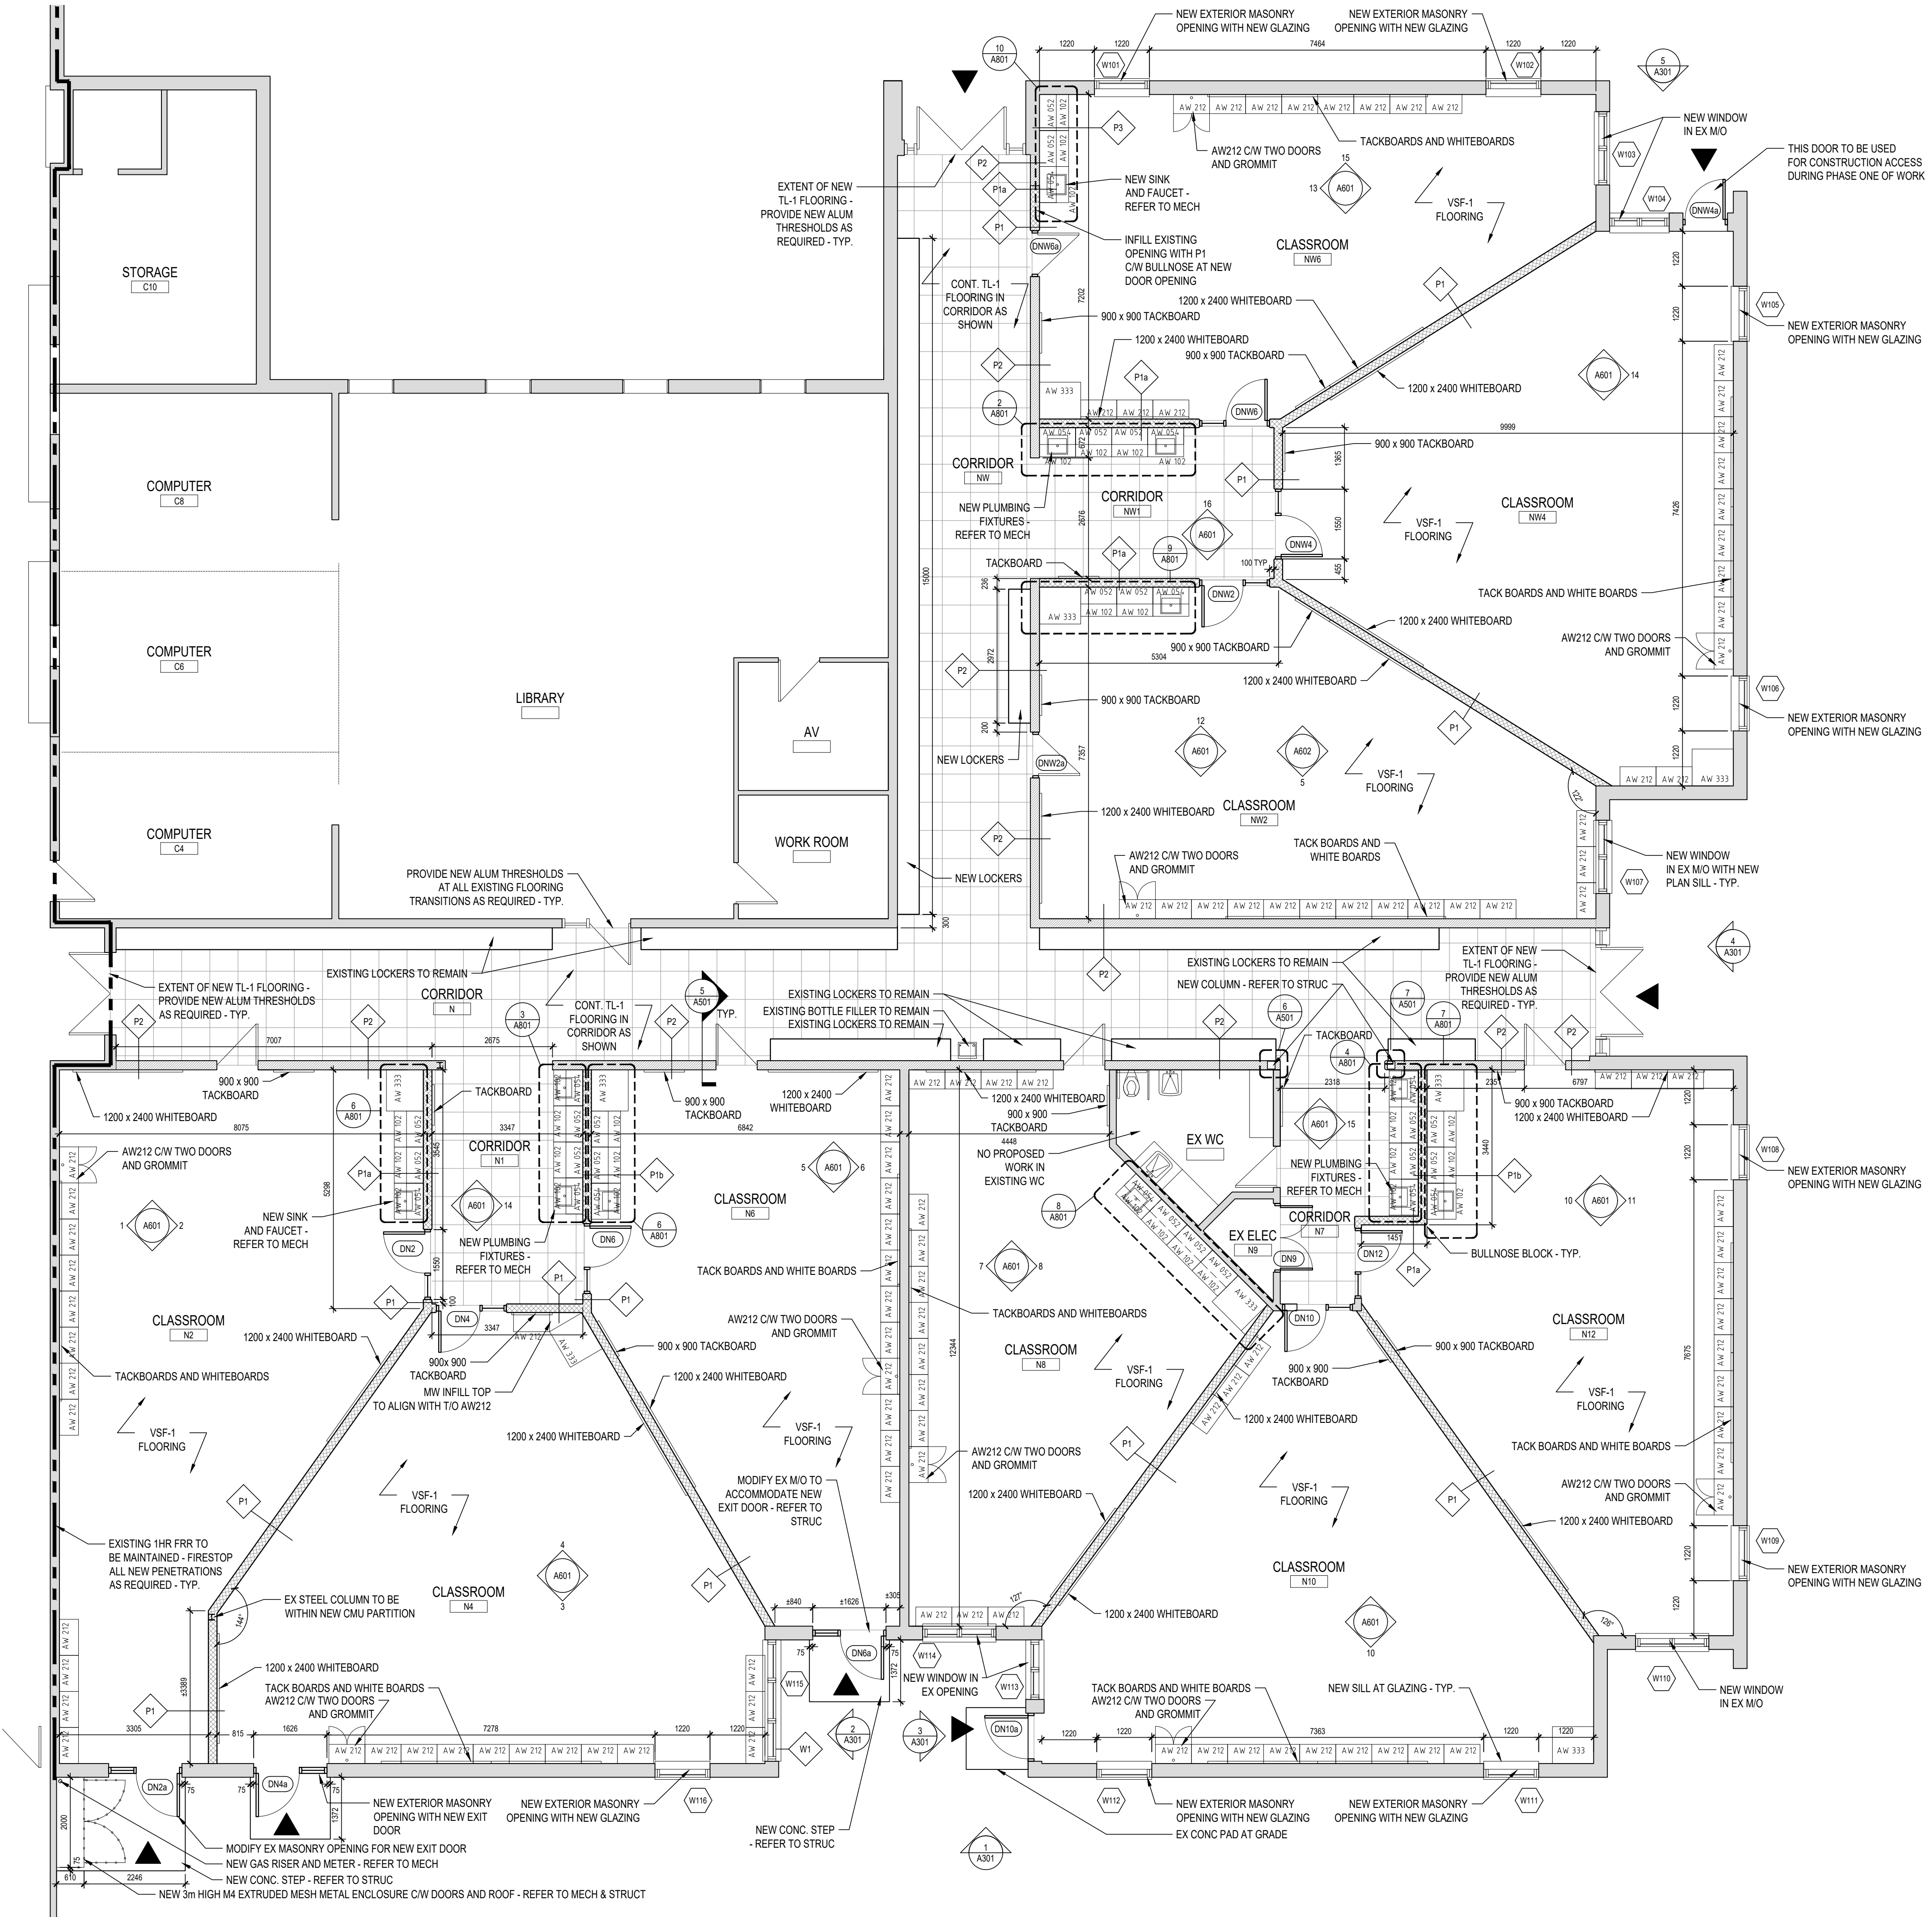

1 GROUND FLOOR - PROPOSED CLASSROOM PLAN
 A101 1 : 75

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 DO NOT SCALE DRAWINGS

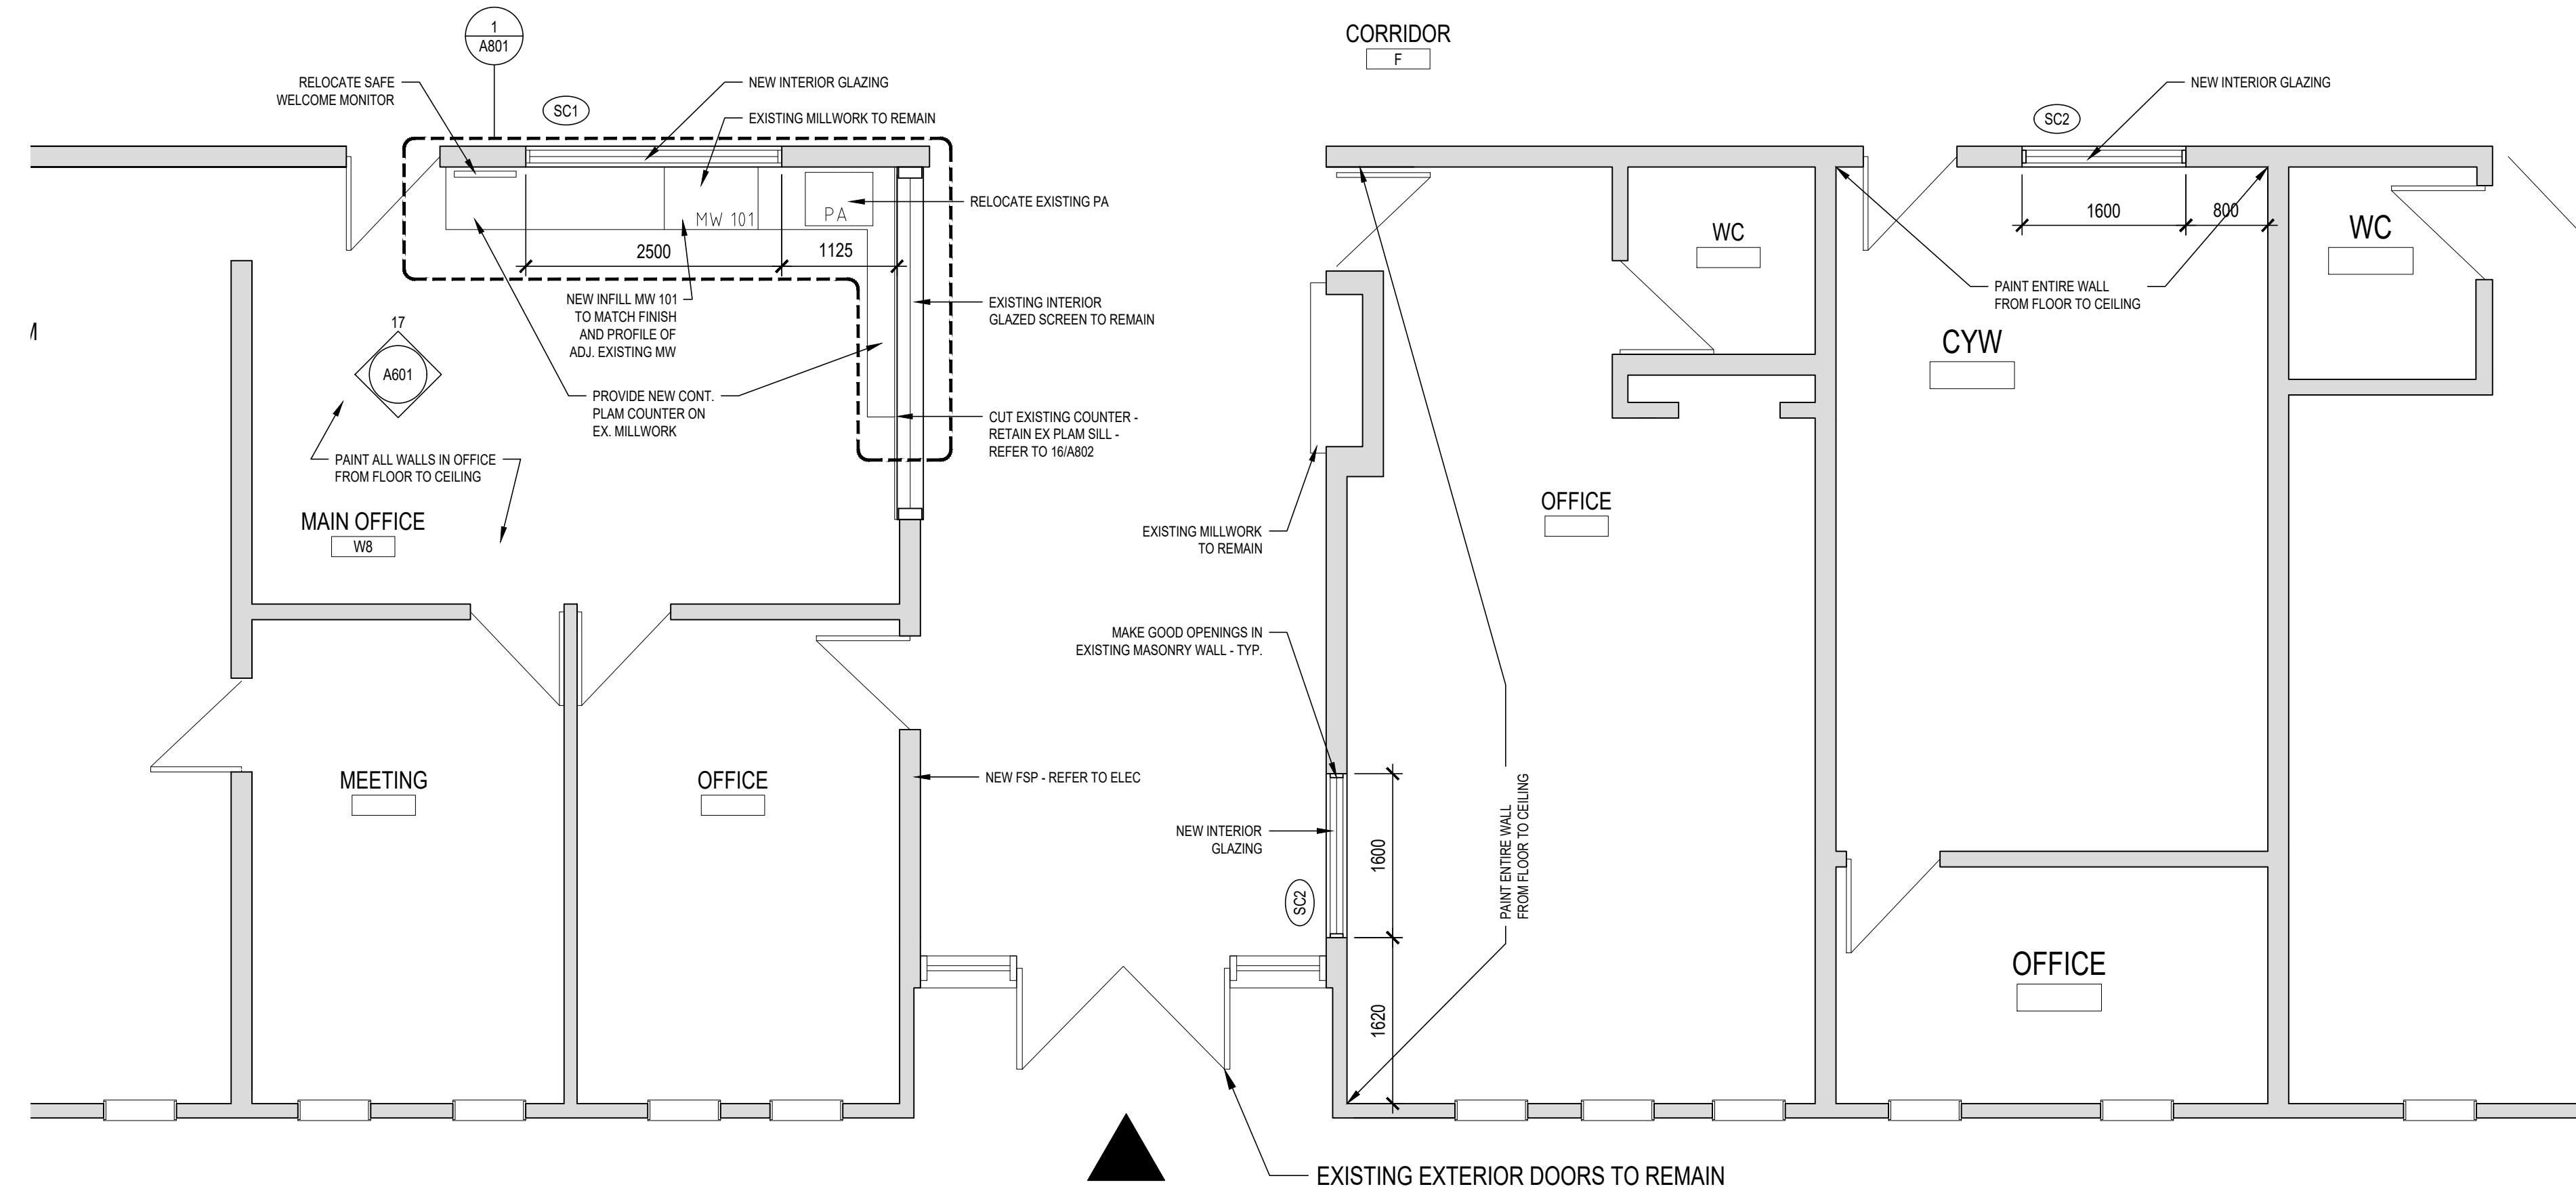

1 GROUND FLOOR - PROPOSED OFFICE PLAN
 A102 1 : 50

ISSUE DATE:

07	2022-02-11	ISSUED FOR TENDER
06	2022-01-31	ISSUED FOR 90% CD REVIEW
05	2022-01-18	ISSUED FOR PERMIT
04	2022-01-17	ISSUED FOR CLIENT REVIEW
03	2022-01-06	ISSUED FOR CLIENT REVIEW
02	2021-12-20	ISSUED FOR 100% CD
01	2021-12-09	ISSUED FOR COORDINATION
NO.	DATE	DESCRIPTION

PROJECT:


Park Manor Public School - Phase 2
 Interior and Window Enhancements

WRDSB Tender #7266-RW-22

DRAWING TITLE:

GROUND FLOOR
 PLAN - PARTIAL
 PROPOSED

PROJECT NO: 21970
 SCALE: 1:50
 DRAWN BY: JG
 REVIEWED BY: DS

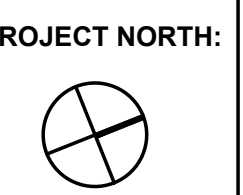


DRAWING NO:

A102

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DO NOT SCALE DRAWINGS

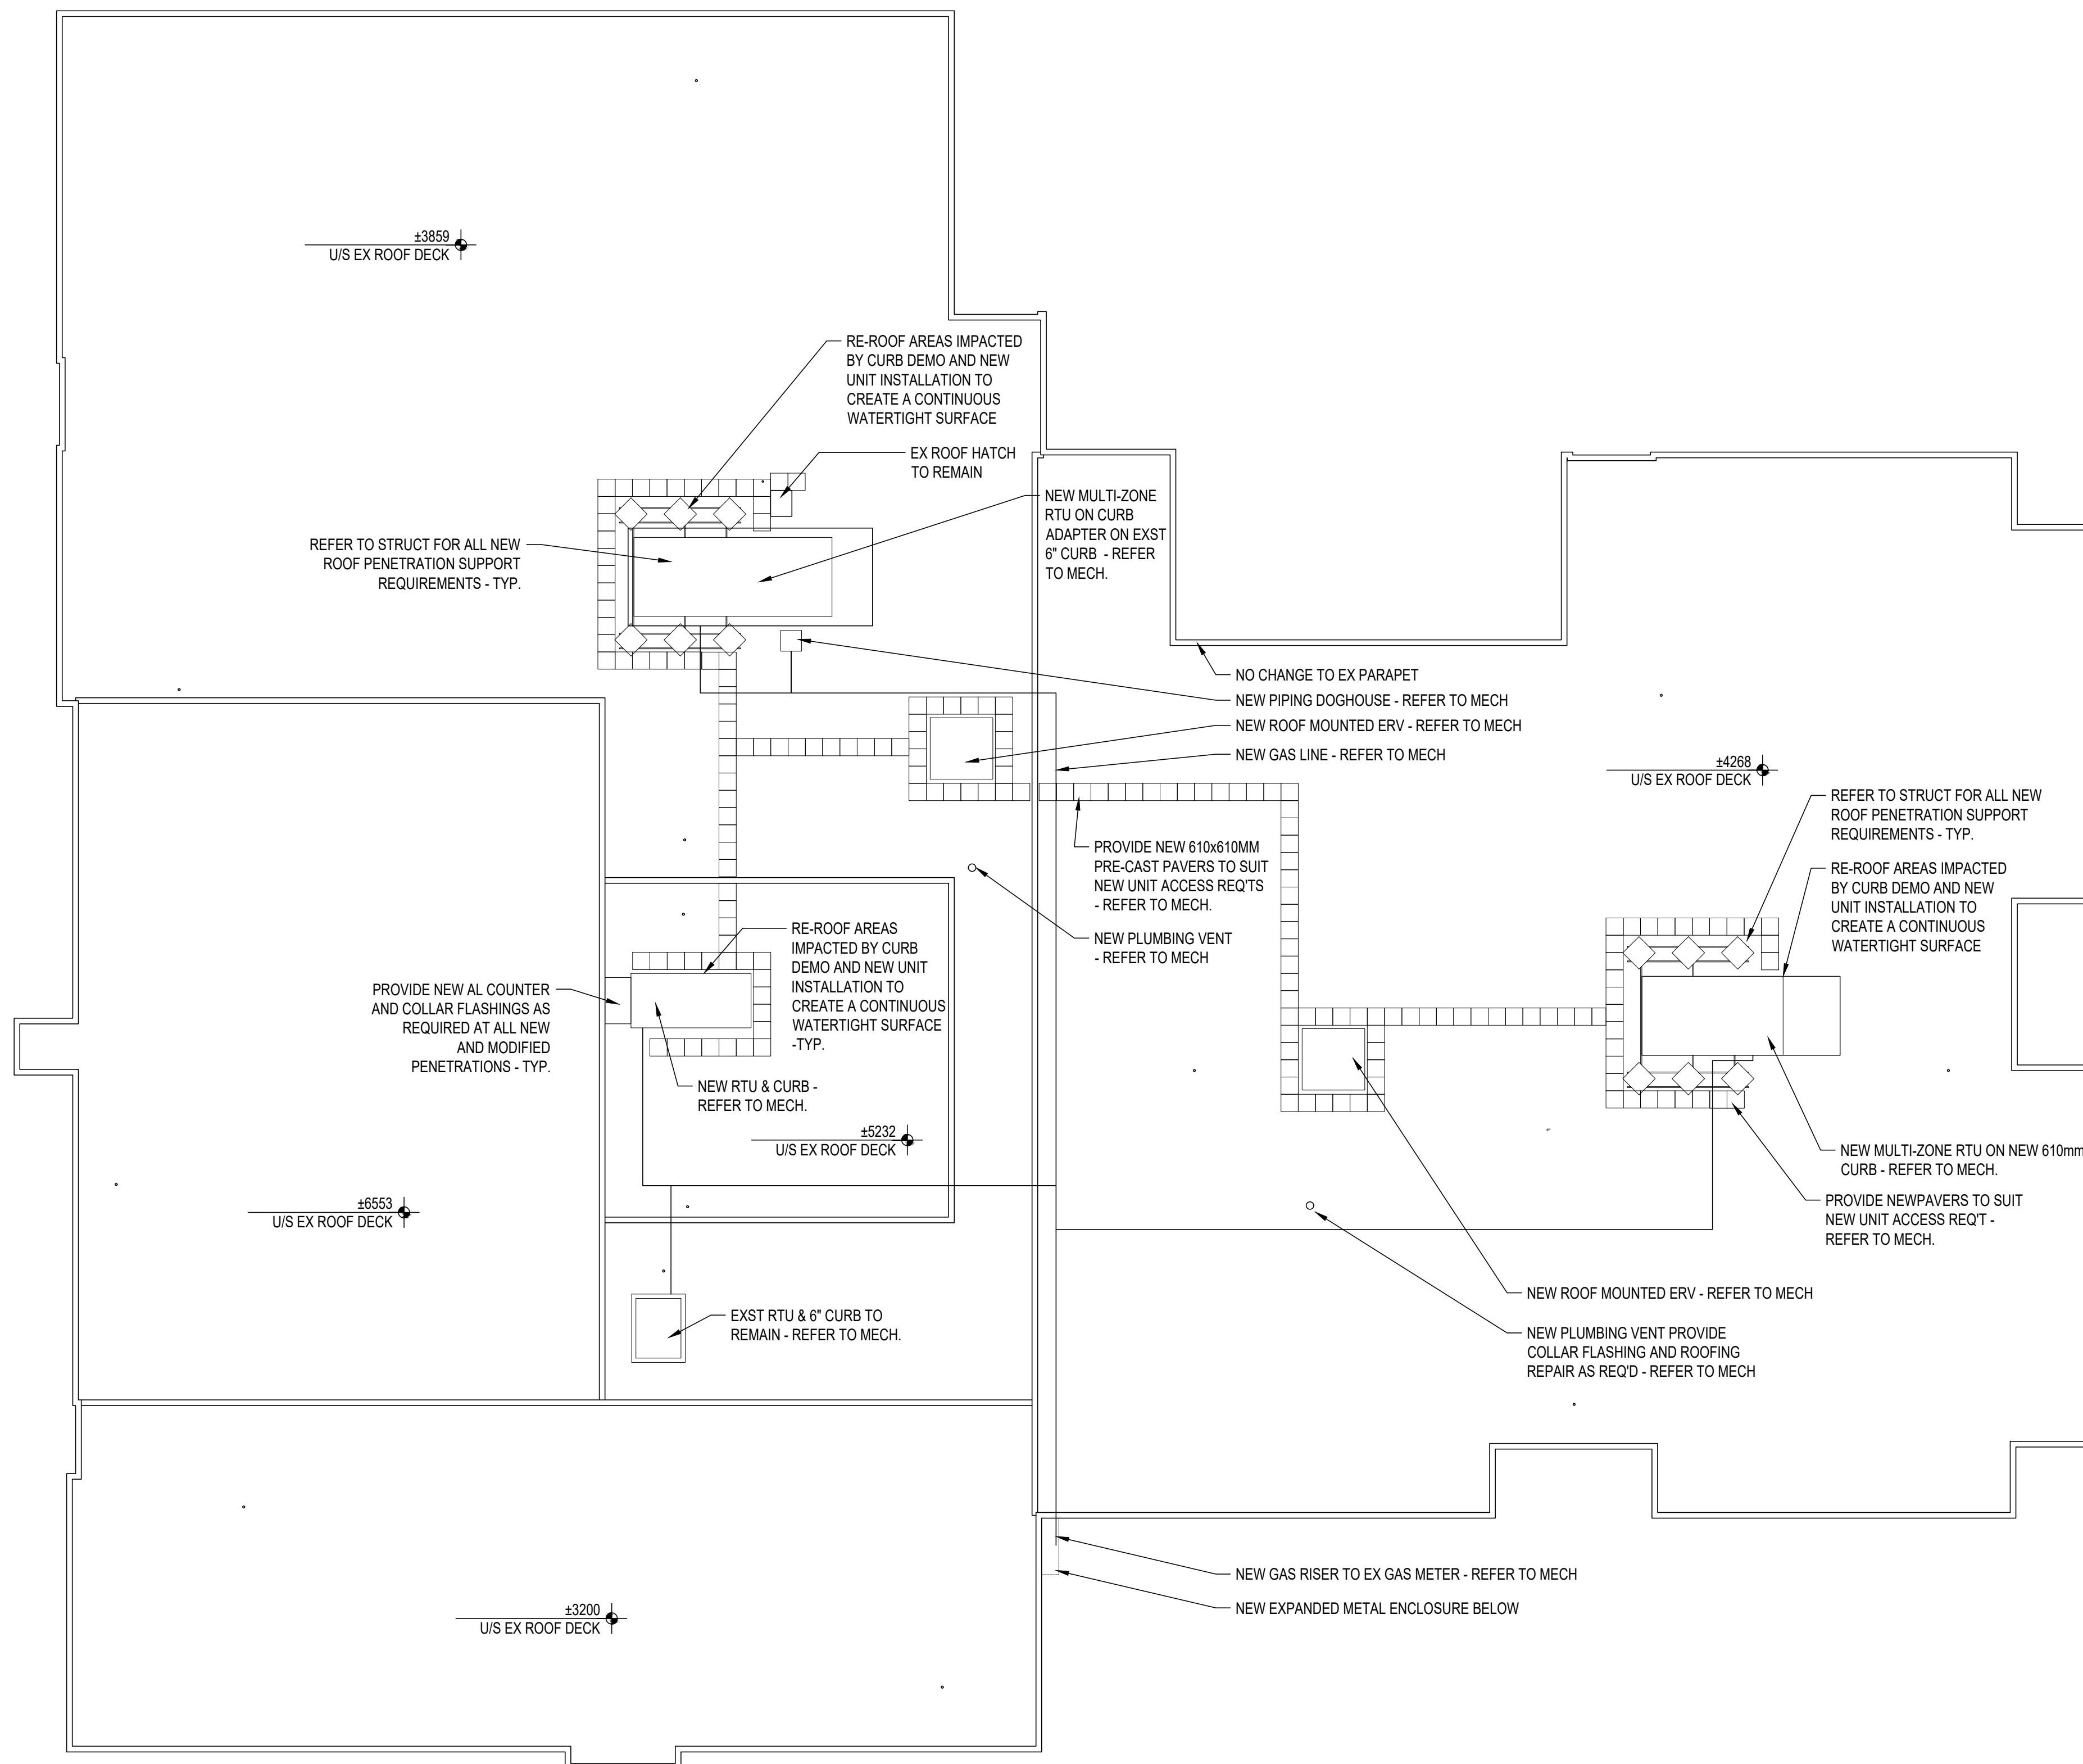

ISSUE DATE:

NO.	DATE	DESCRIPTION
04	2022-02-11	ISSUED FOR TENDER
03	2022-01-31	ISSUED FOR 90% CD REVIEW
02	2022-01-18	ISSUED FOR PERMIT
01	2022-01-17	ISSUED FOR CLIENT REVIEW

PROJECT:

Park Manor Public School - Phase 2 Interior and Window Enhancements


WRDSB Tender #7266-RW-22

DRAWING TITLE:

ROOF PLAN - PROPOSED

PROJECT NO: 21970
 SCALE: 1:150
 DRAWN BY: JG
 REVIEWED BY: DS

PROJECT NORTH:

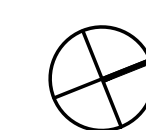

DRAWING NO:

A103

RCP NOTES:


1. ARCHITECTURAL RCP IS INTENDED TO ILLUSTRATE LIGHTING LOCATIONS AND CEILING HEIGHT (TO BE VERIFIED IN FIELD) / FINISHES. REFER TO ELECTRICAL FOR SPECIFICATIONS, TO CONFORM QUANTITIES AND OTHER RELATED ITEMS.
2. REFER TO MECHANICAL / ELECTRICAL FOR RELATED ITEMS INCLUDING BUT NOT LIMITED TO TRANSFER DUCTS, SPECIFICATIONS AND CONTROLS.
3. WHERE POSSIBLE, ALIGN ITEMS IN CEILING. REVIEW AND COORDINATE W/ CONSULTANTS ON SITE PRIOR TO COMMENCING WORK.
4. ALL DIMENSIONS SHOWN ARE +/- CONTRACTOR TO VERIFY ALL DIMENSIONS ON SITE AND SHALL REPORT ANY DISCREPANCIES TO ARCHITECT.
5. DRAWINGS ARE NOT TO BE SCALED FOR CONSTRUCTION PURPOSES.
6. CONTRACTOR TO VERIFY AND MAINTAIN ALL EXISTING FIRE SEPARATIONS. ALL NEW ASSOCIATED ITEMS TO BE RATED AS REQ'D

CEILING FINISHES LEGEND:

- EXISTING TO REMAIN (EX)
- 2" x 2" SUSPENDED ACOUSTIC CEILING TILE (LAY-IN ACT) (C1)

RCP LEGEND:

- CEILING SUPPLY AIR DIFFUSER (REFER TO MECHANICAL)
- CEILING EXHAUST / RETURN GRILLE (REFER TO MECHANICAL)
- CEILING EXHAUST / RETURN GRILLE (REFER TO MECHANICAL)
- RECESSED LINEAR LUMINAIRE (REFER TO ELECTRICAL)

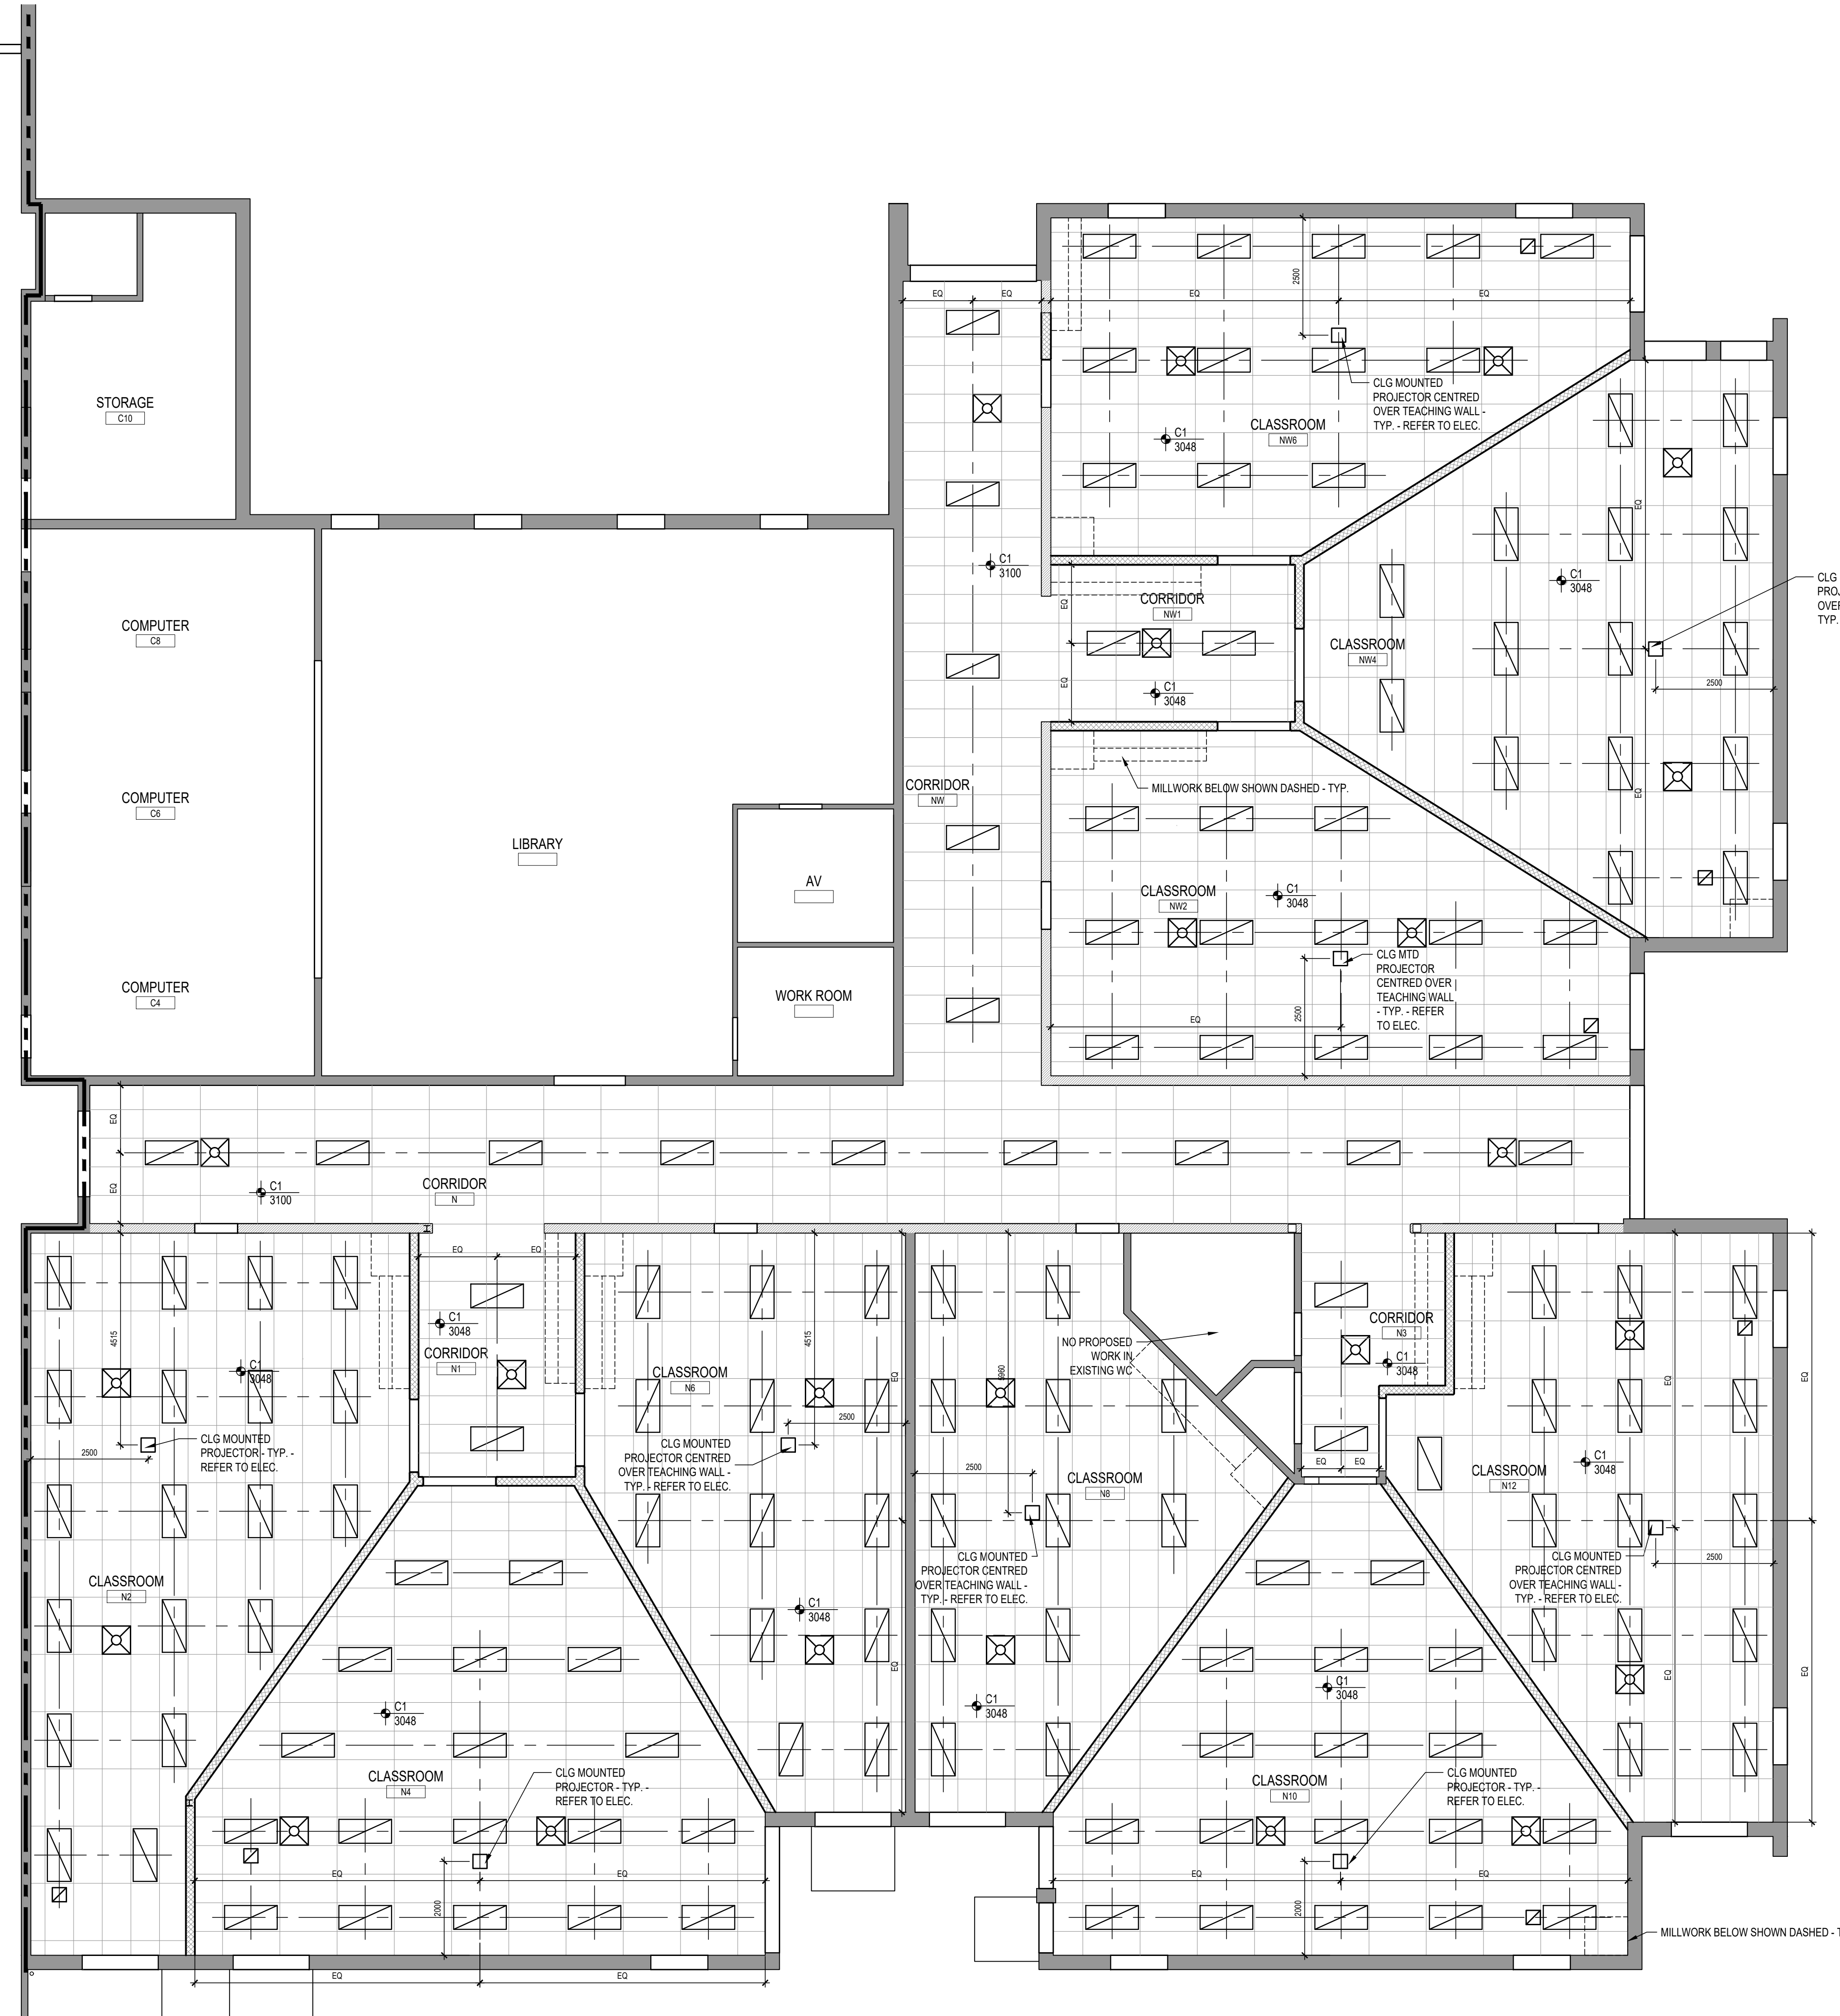

ISSUE DATE:

NO.	DATE	DESCRIPTION
07	2022-02-11	ISSUED FOR TENDER
06	2022-01-31	ISSUED FOR 90% CD REVIEW
05	2022-01-18	ISSUED FOR PERMIT
04	2022-01-17	ISSUED FOR CLIENT REVIEW
03	2022-01-11	ISSUED FOR COORDINATION
02	2021-12-20	ISSUED FOR 100% DD
01	2021-12-09	ISSUED FOR COORDINATION

PROJECT:

Park Manor Public School - Phase 2 Interior and Window Enhancements

WRDSB Tender #7266-RW-22

DRAWING TITLE:

PARTIAL GROUND FLOOR REFLECTED CEILING PLAN - PROPOSED

PROJECT NO: 21970
 SCALE: 1:75
 DRAWN BY: MY
 REVIEWED BY: DS




DRAWING NO:


A201

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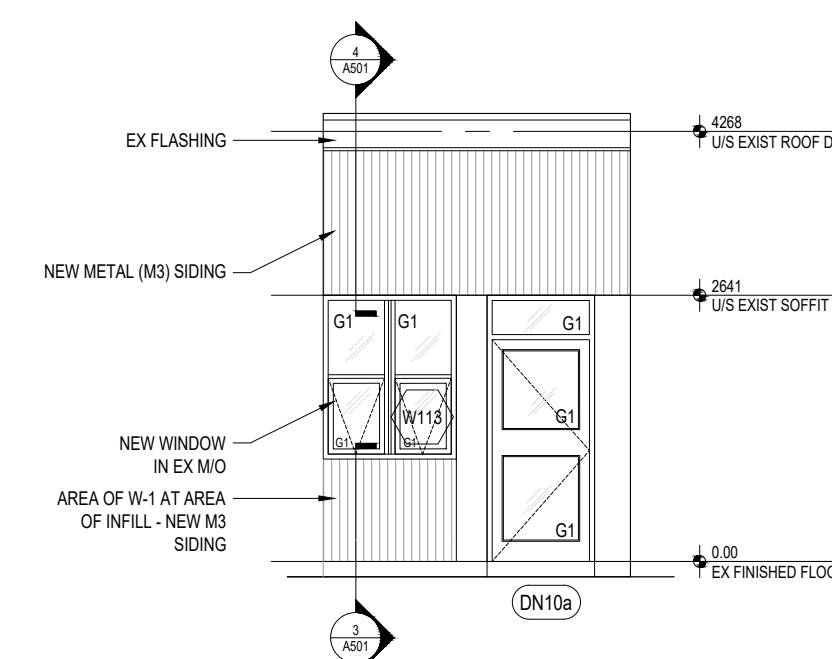
DO NOT SCALE DRAWINGS

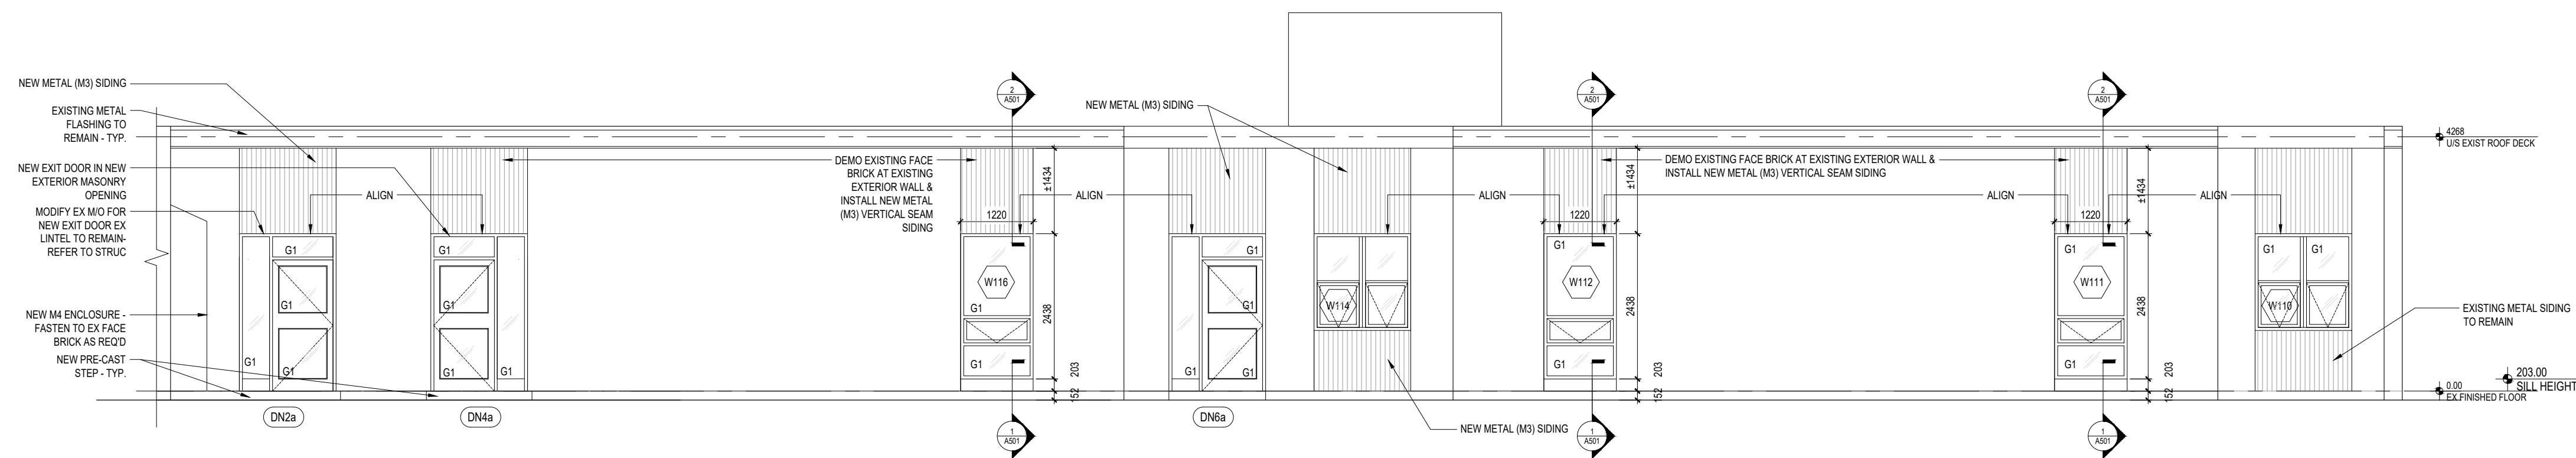


1 PARTIAL EAST ELEVATION
A301 1 : 75

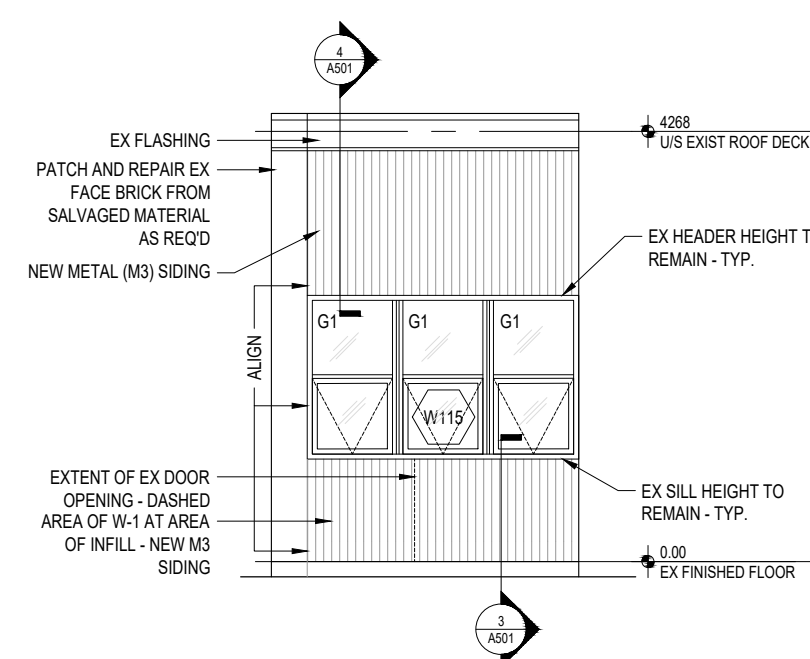


2 PARTIAL NORTH ELEVATION
A301 1 : 75



3 PARTIAL SOUTH ELEVATION
A301 1 : 75

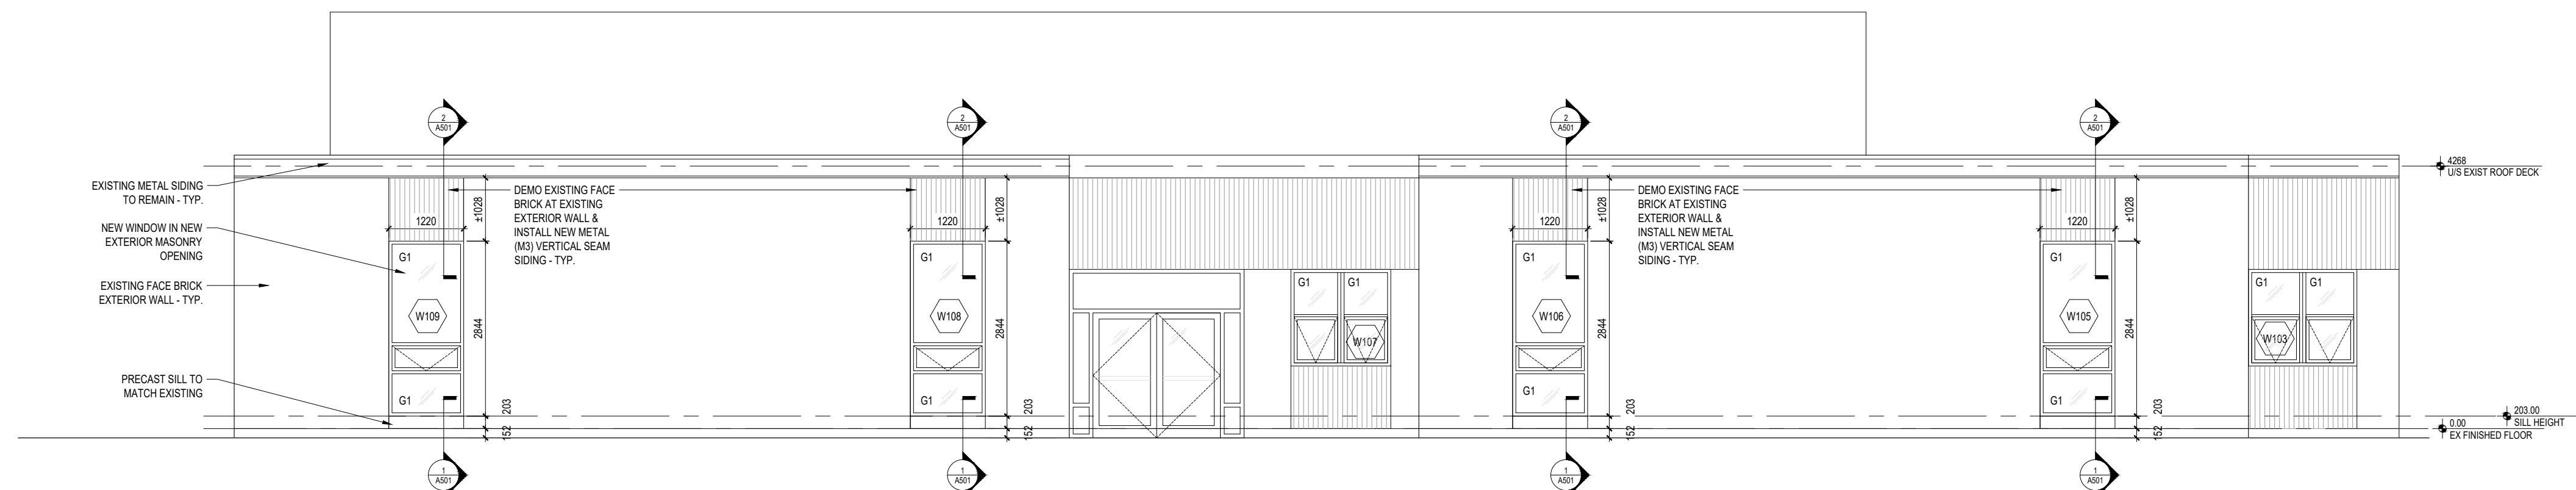

4 PARTIAL NORTH ELEVATION
A301 1 : 75

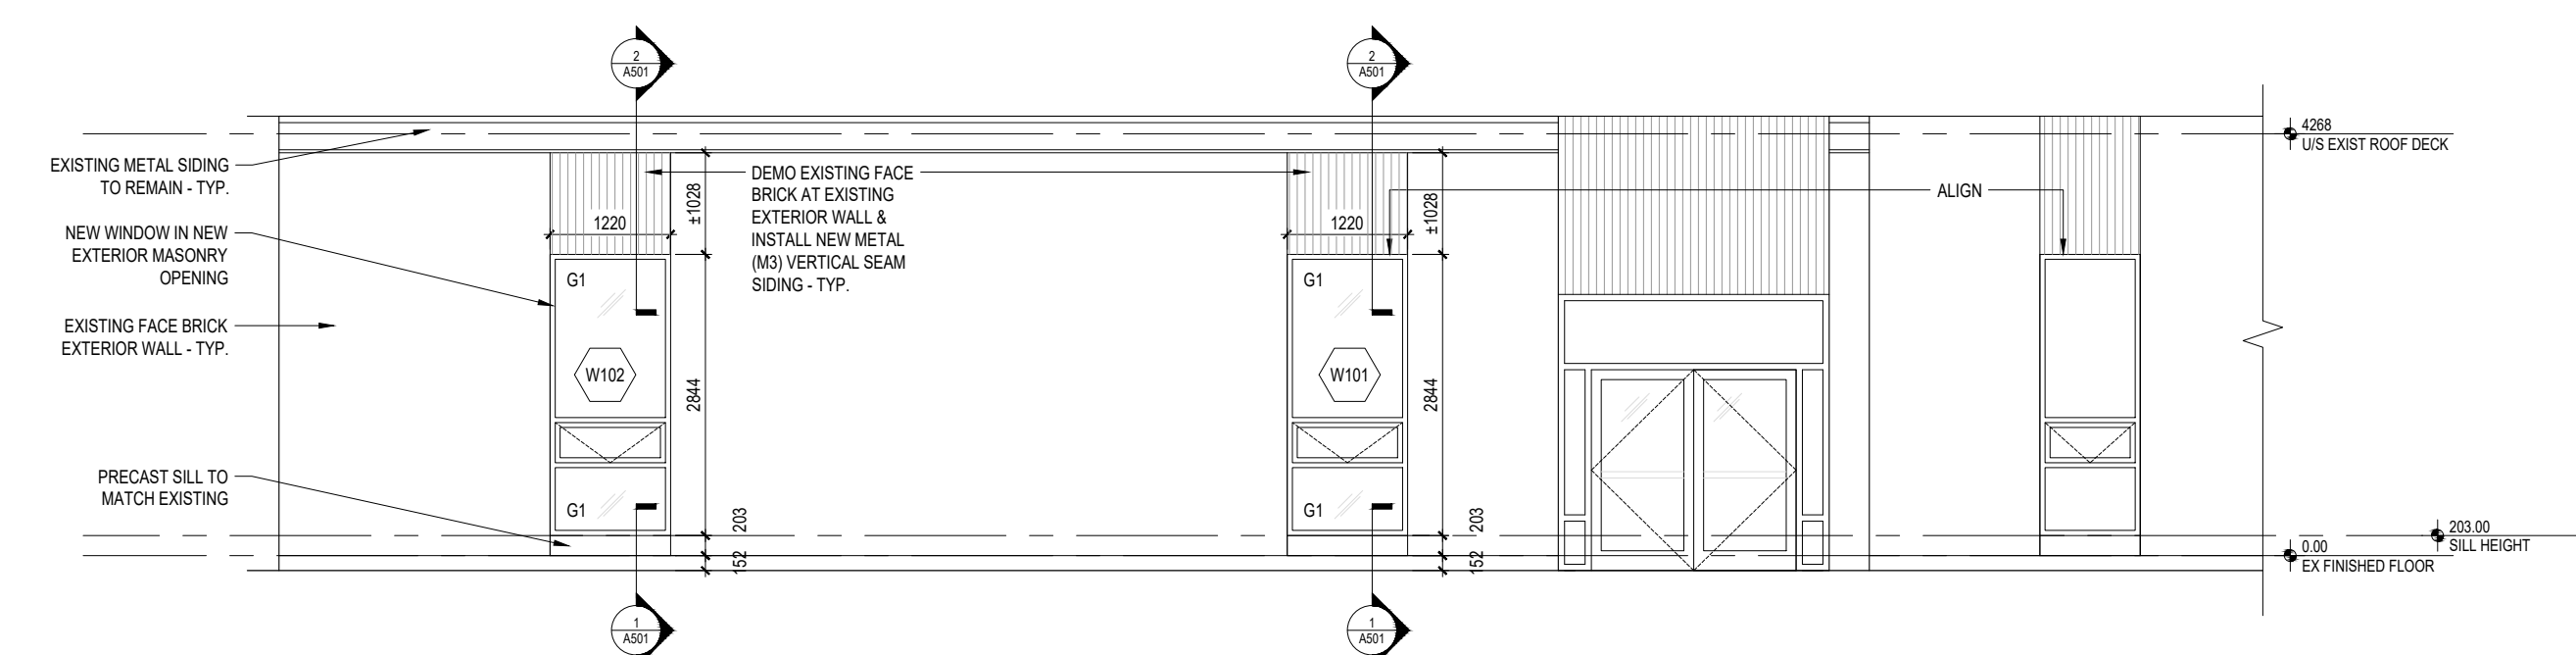

5 PARTIAL WEST ELEVATION
A301 1 : 75

ISSUE DATE:

NO.	DATE	DESCRIPTION
04	2022-02-11	ISSUED FOR TENDER
03	2022-01-31	ISSUED FOR 90% CD REVIEW
02	2022-01-18	ISSUED FOR PERMIT
01	2022-01-17	ISSUED FOR CLIENT REVIEW

PROJECT:

Park Manor Public School - Phase 2
Interior and Window Enhancements

WRDSB Tender #7266-RW-22

DRAWING TITLE:


PARTIAL EXTERIOR ELEVATIONS - PROPOSED

PROJECT NO: 21970
SCALE: 1:75
DRAWN BY: DS
REVIEWED BY: DS


DRAWING NO:

A301


NOTE: This drawing is the property of the architect and may not be reproduced or used without the expressed consent of the architect. The contractor shall be responsible for checking and verifying all levels and dimensions and shall report all discrepancies to the architect and obtain clarification prior to commencing work. Not for construction unless stamped by the architect and issued for such purpose.
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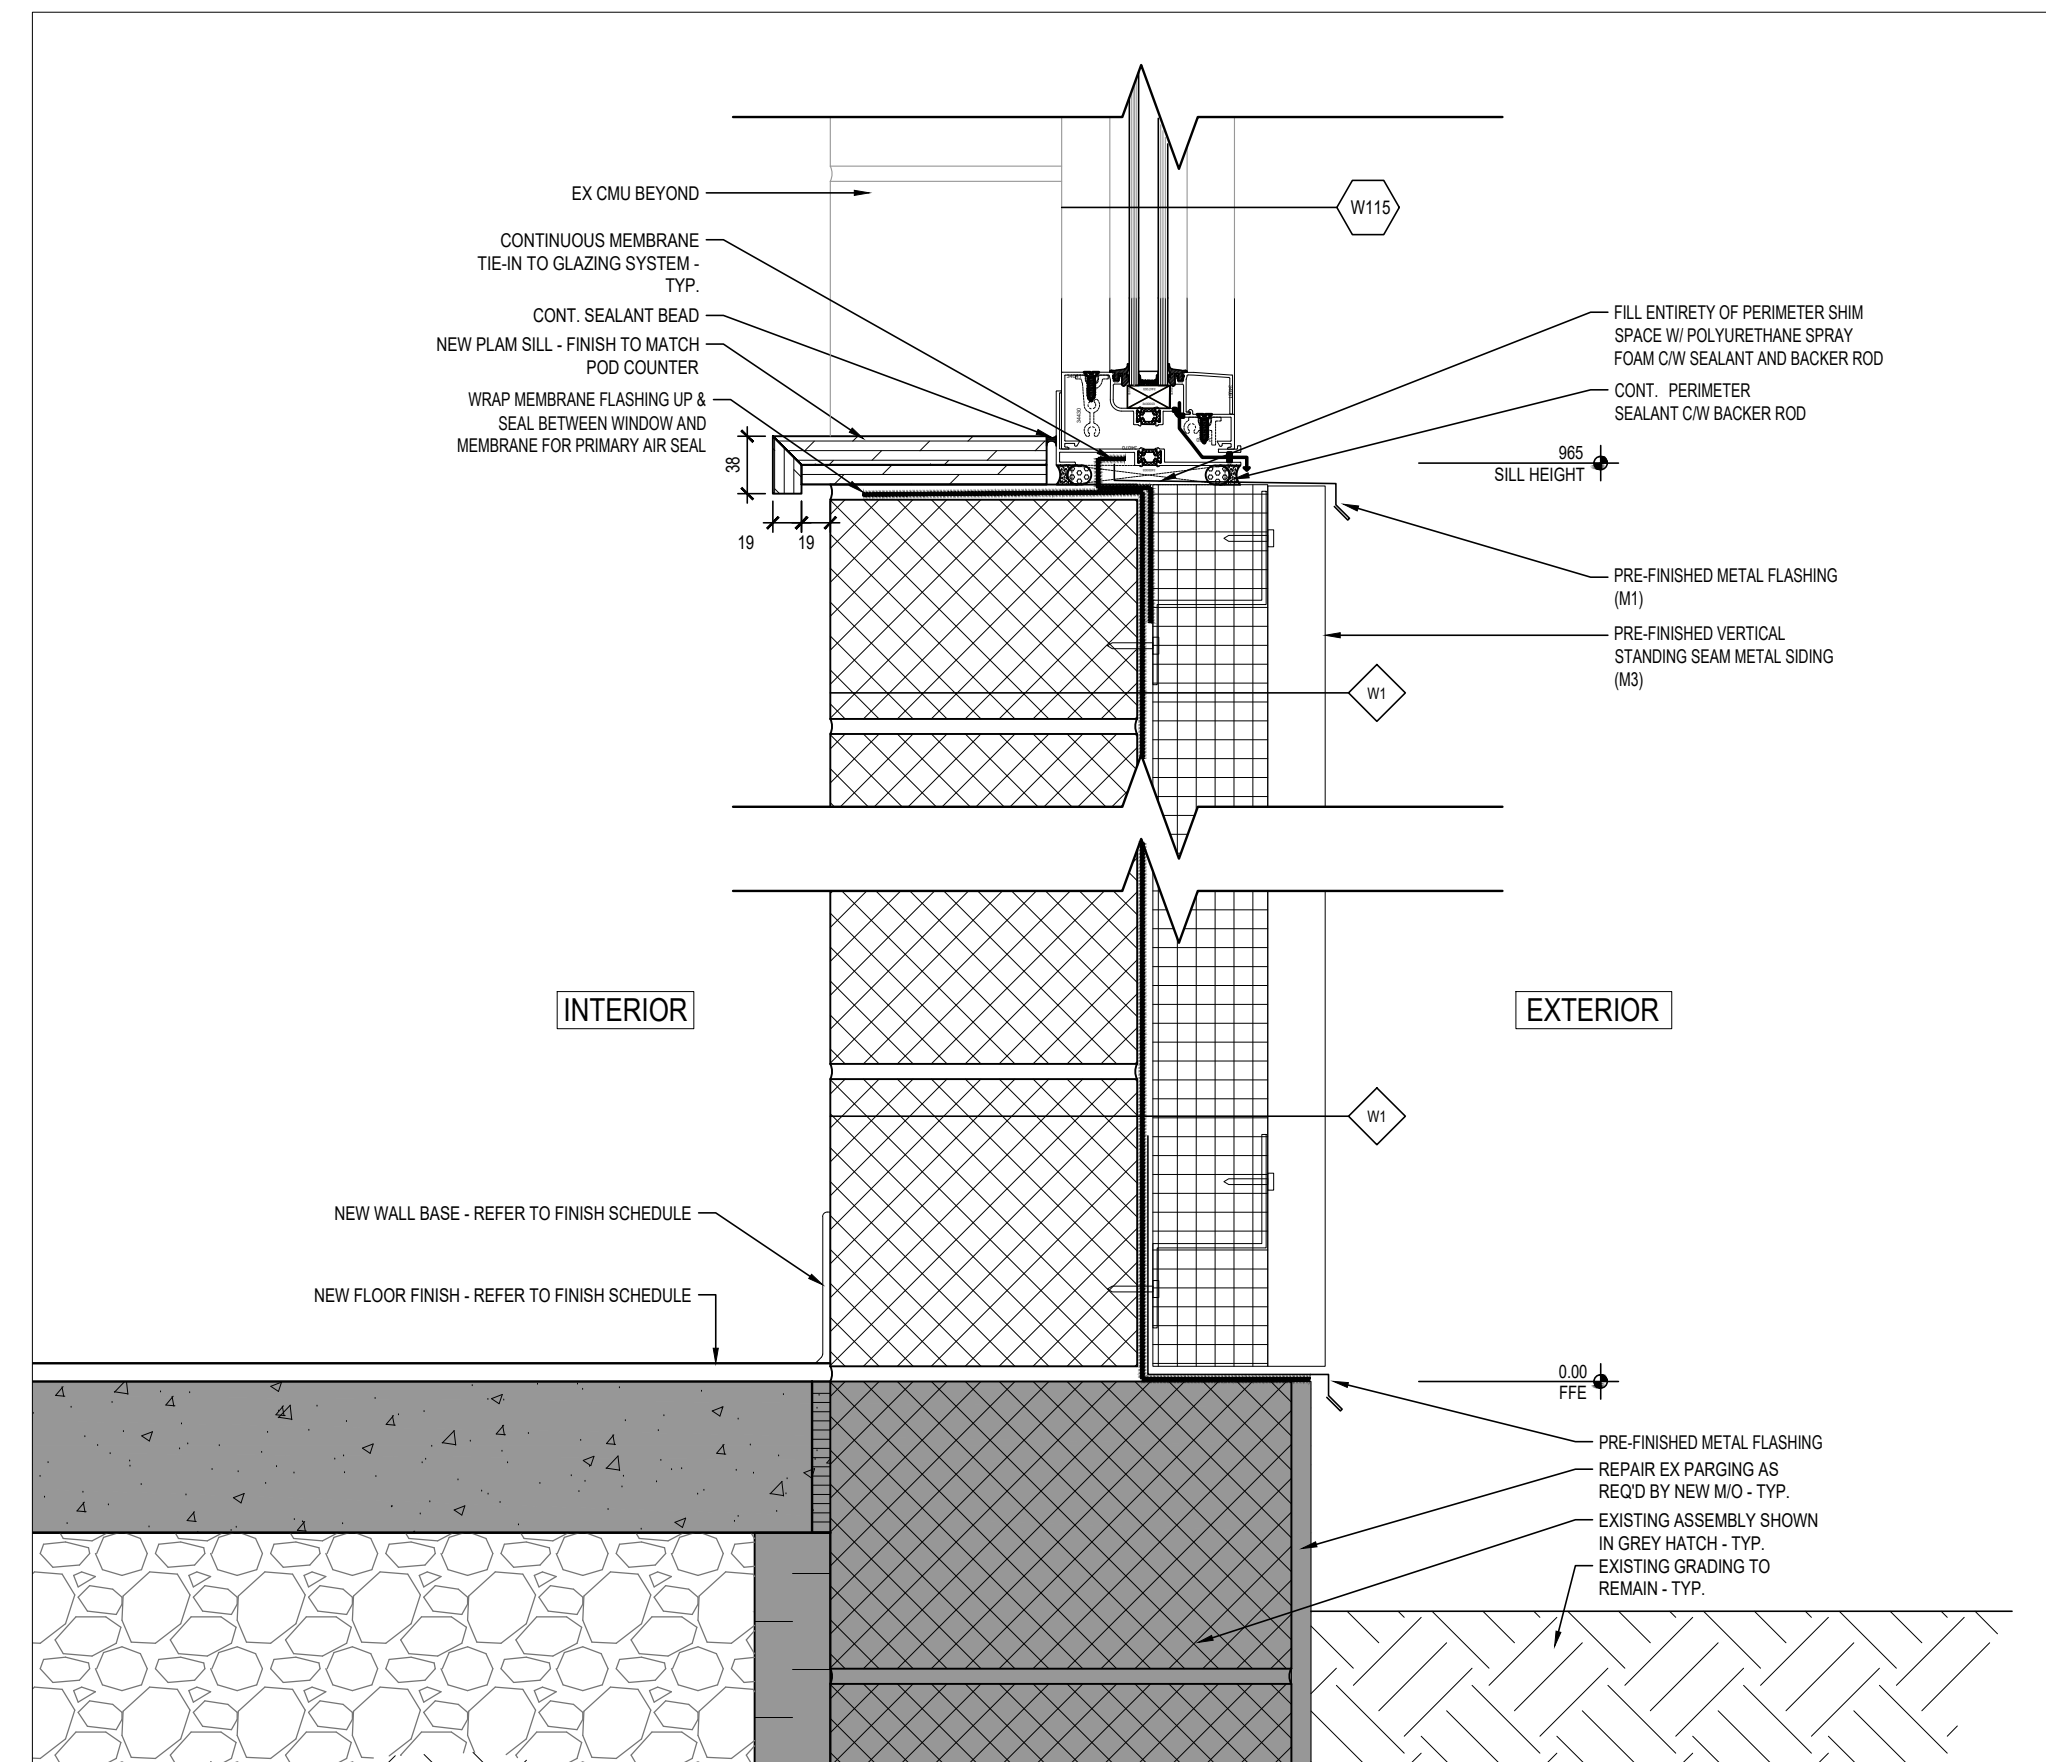
2 SECTION DETAIL AT HEADER OF NEW M/O
 A501 1 : 5

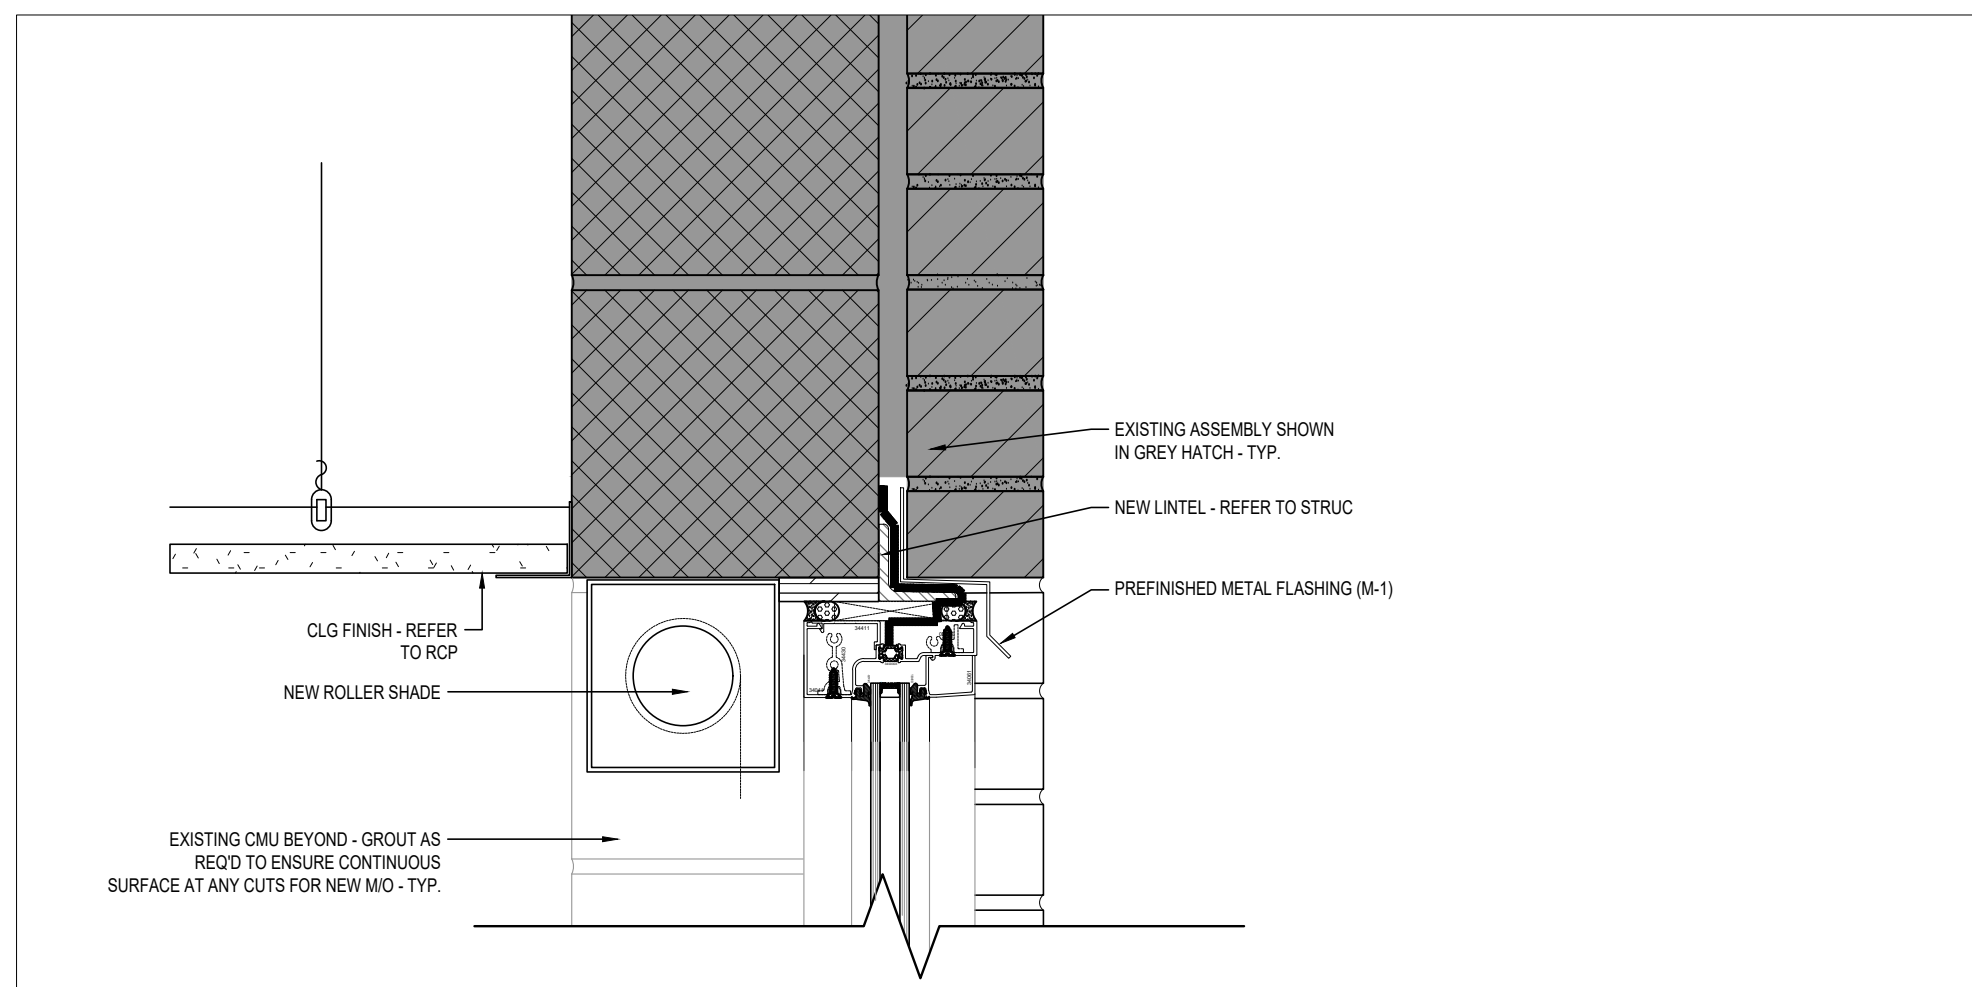


4 SECTION DETAIL AT HEADER OF NEW M/O
 A501 1 : 5

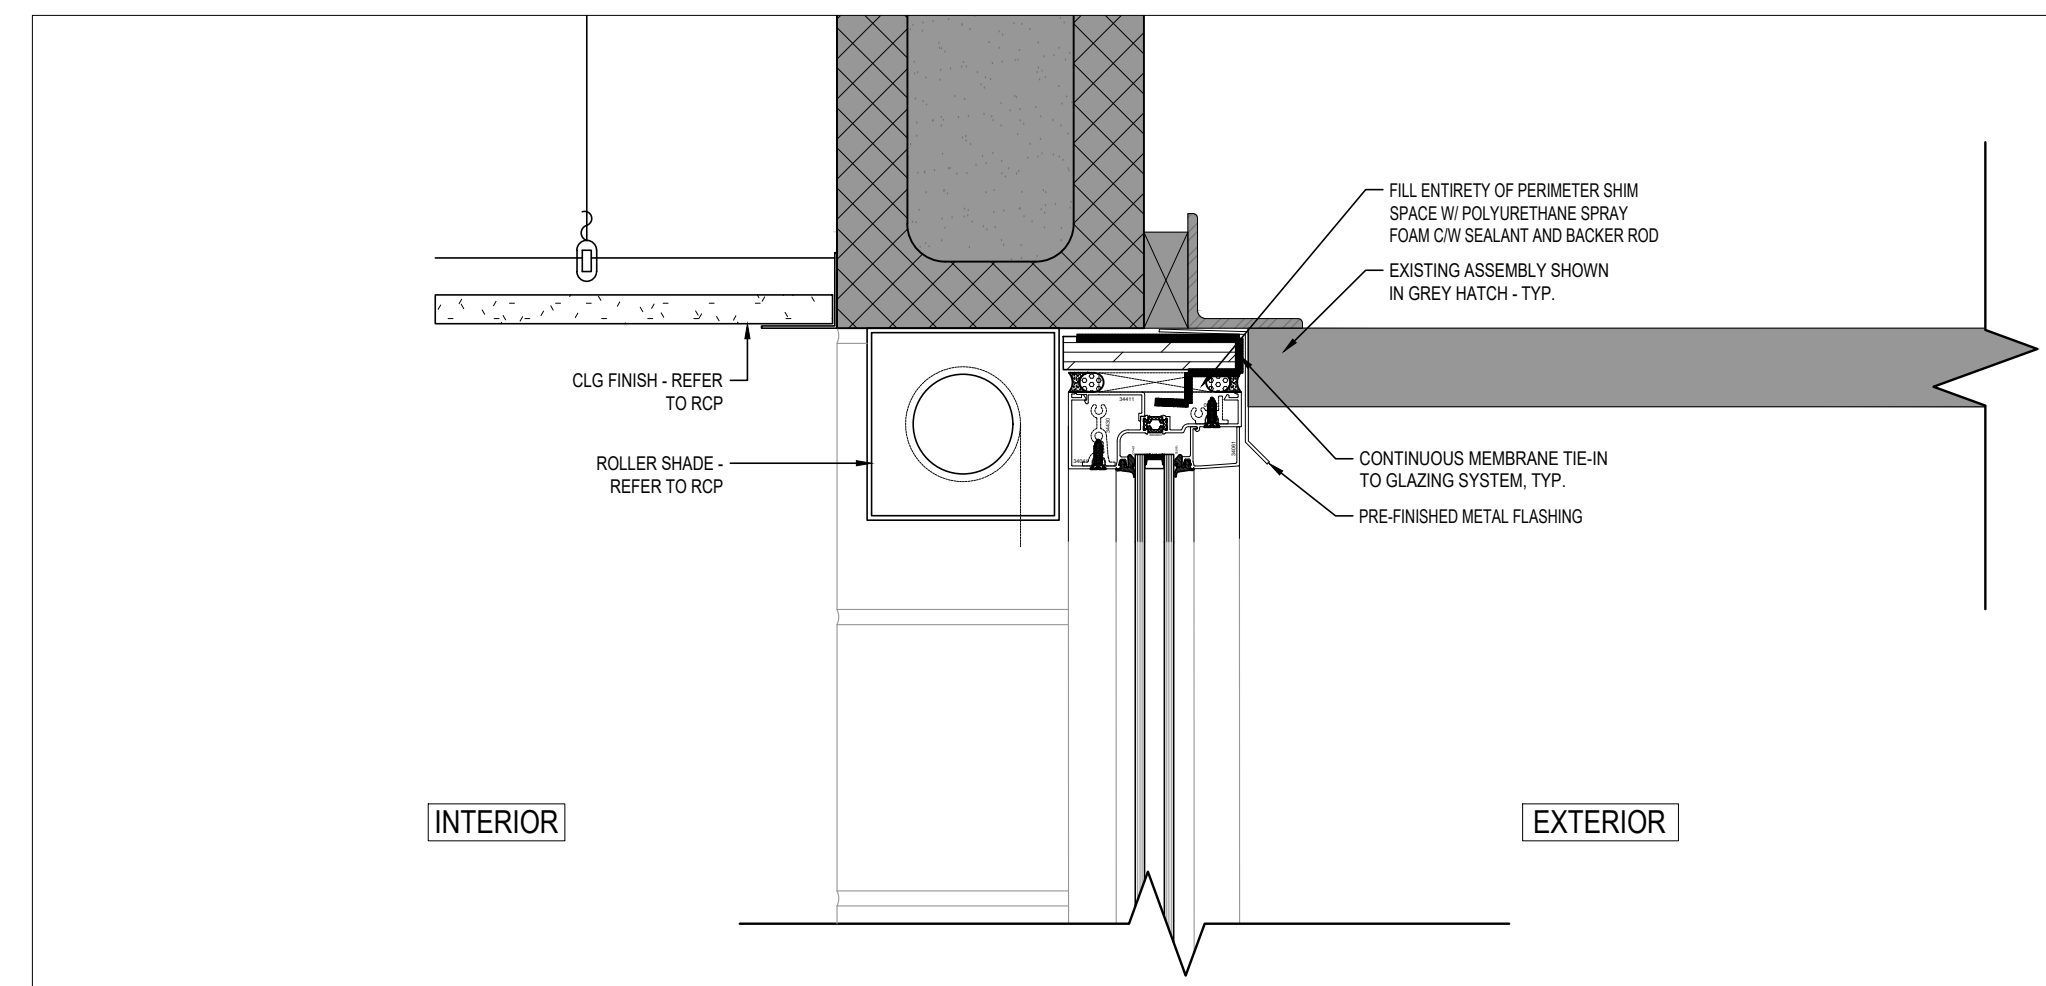


1 SECTION DETAIL AT SILL OF NEW M/O
 A501 1 : 5

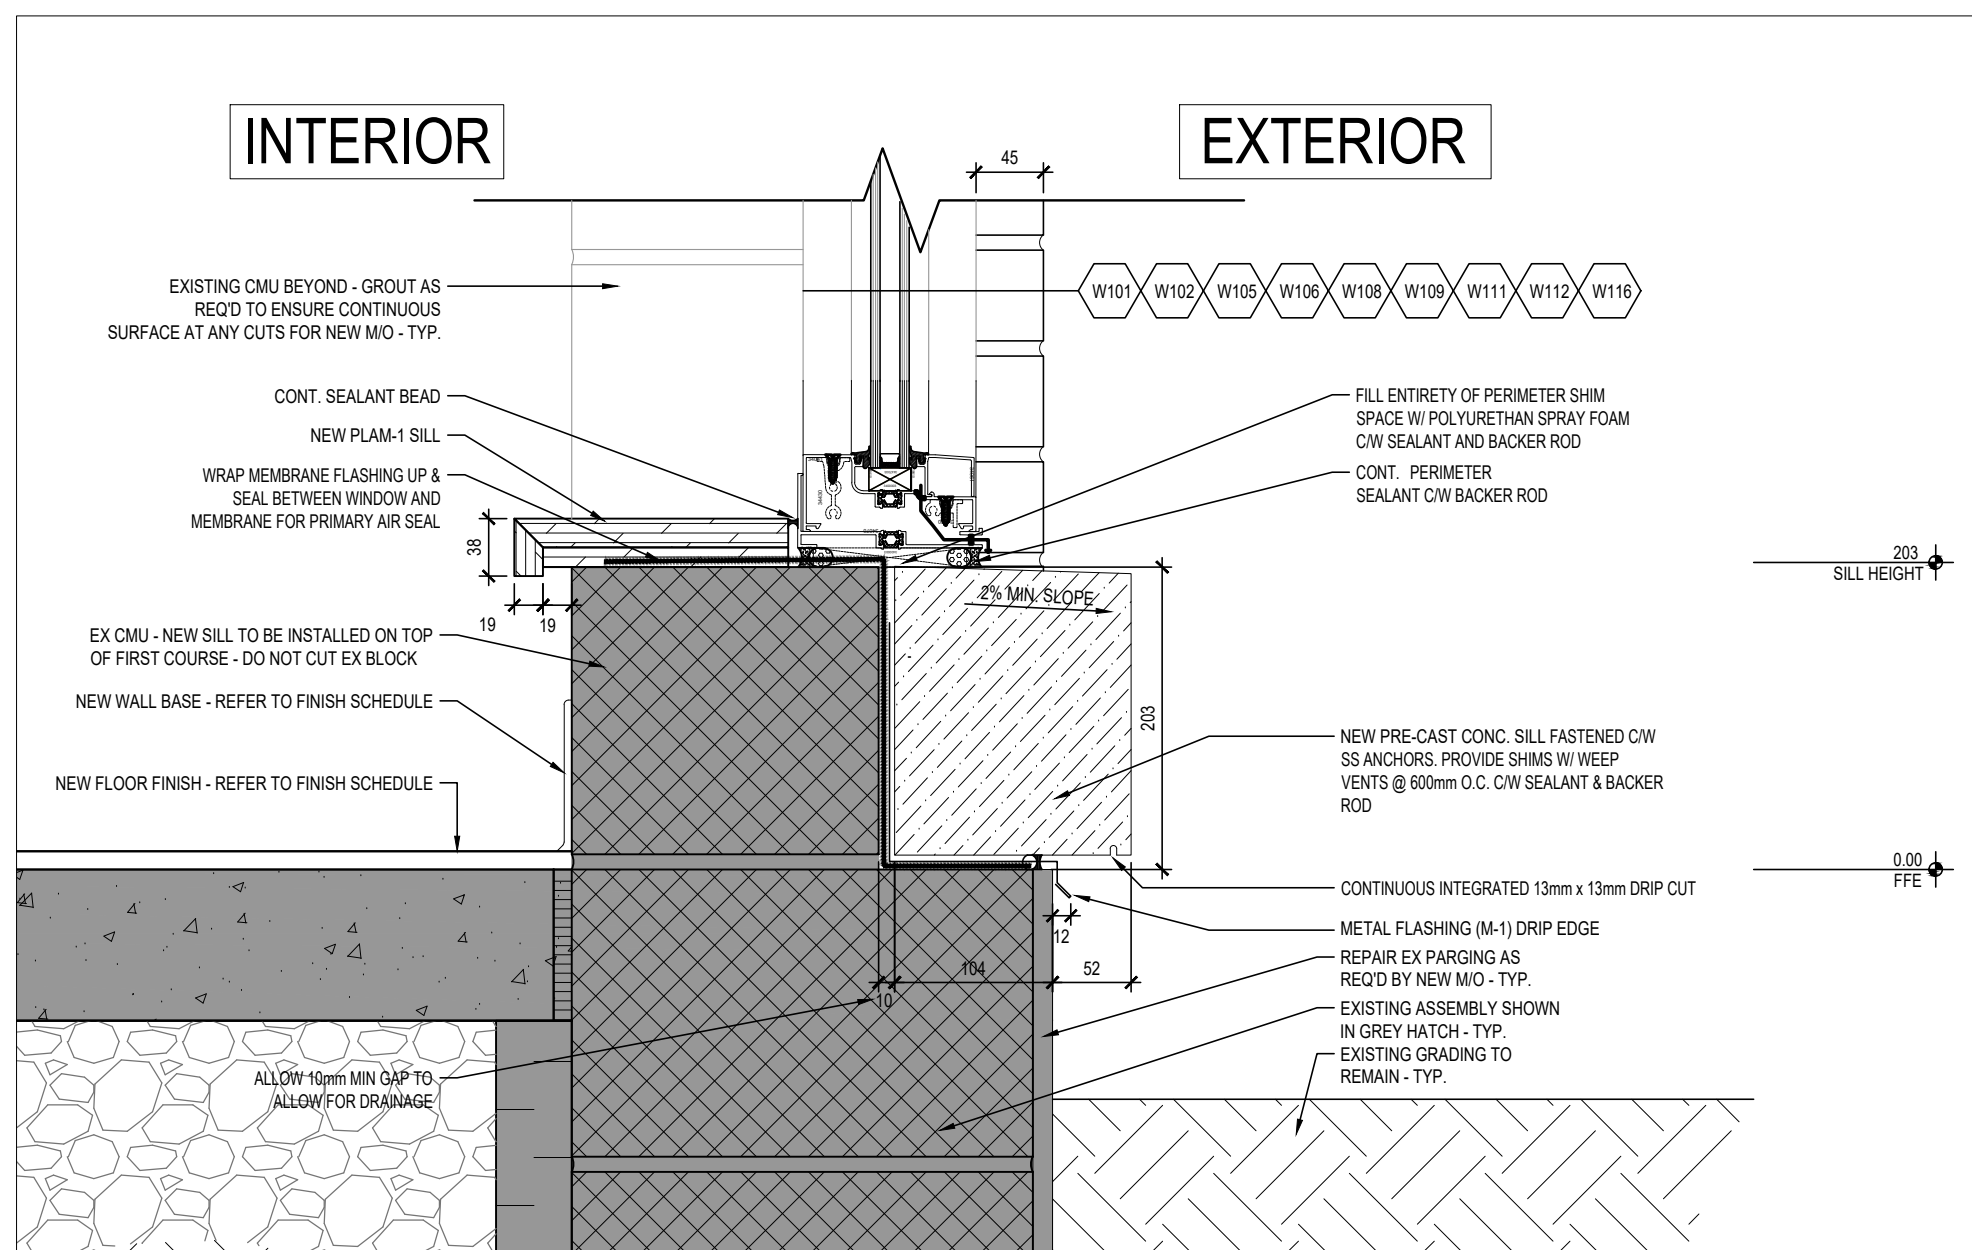


3 SECTION DETAIL AT SILL OF NEW M/O
 A501 1 : 5

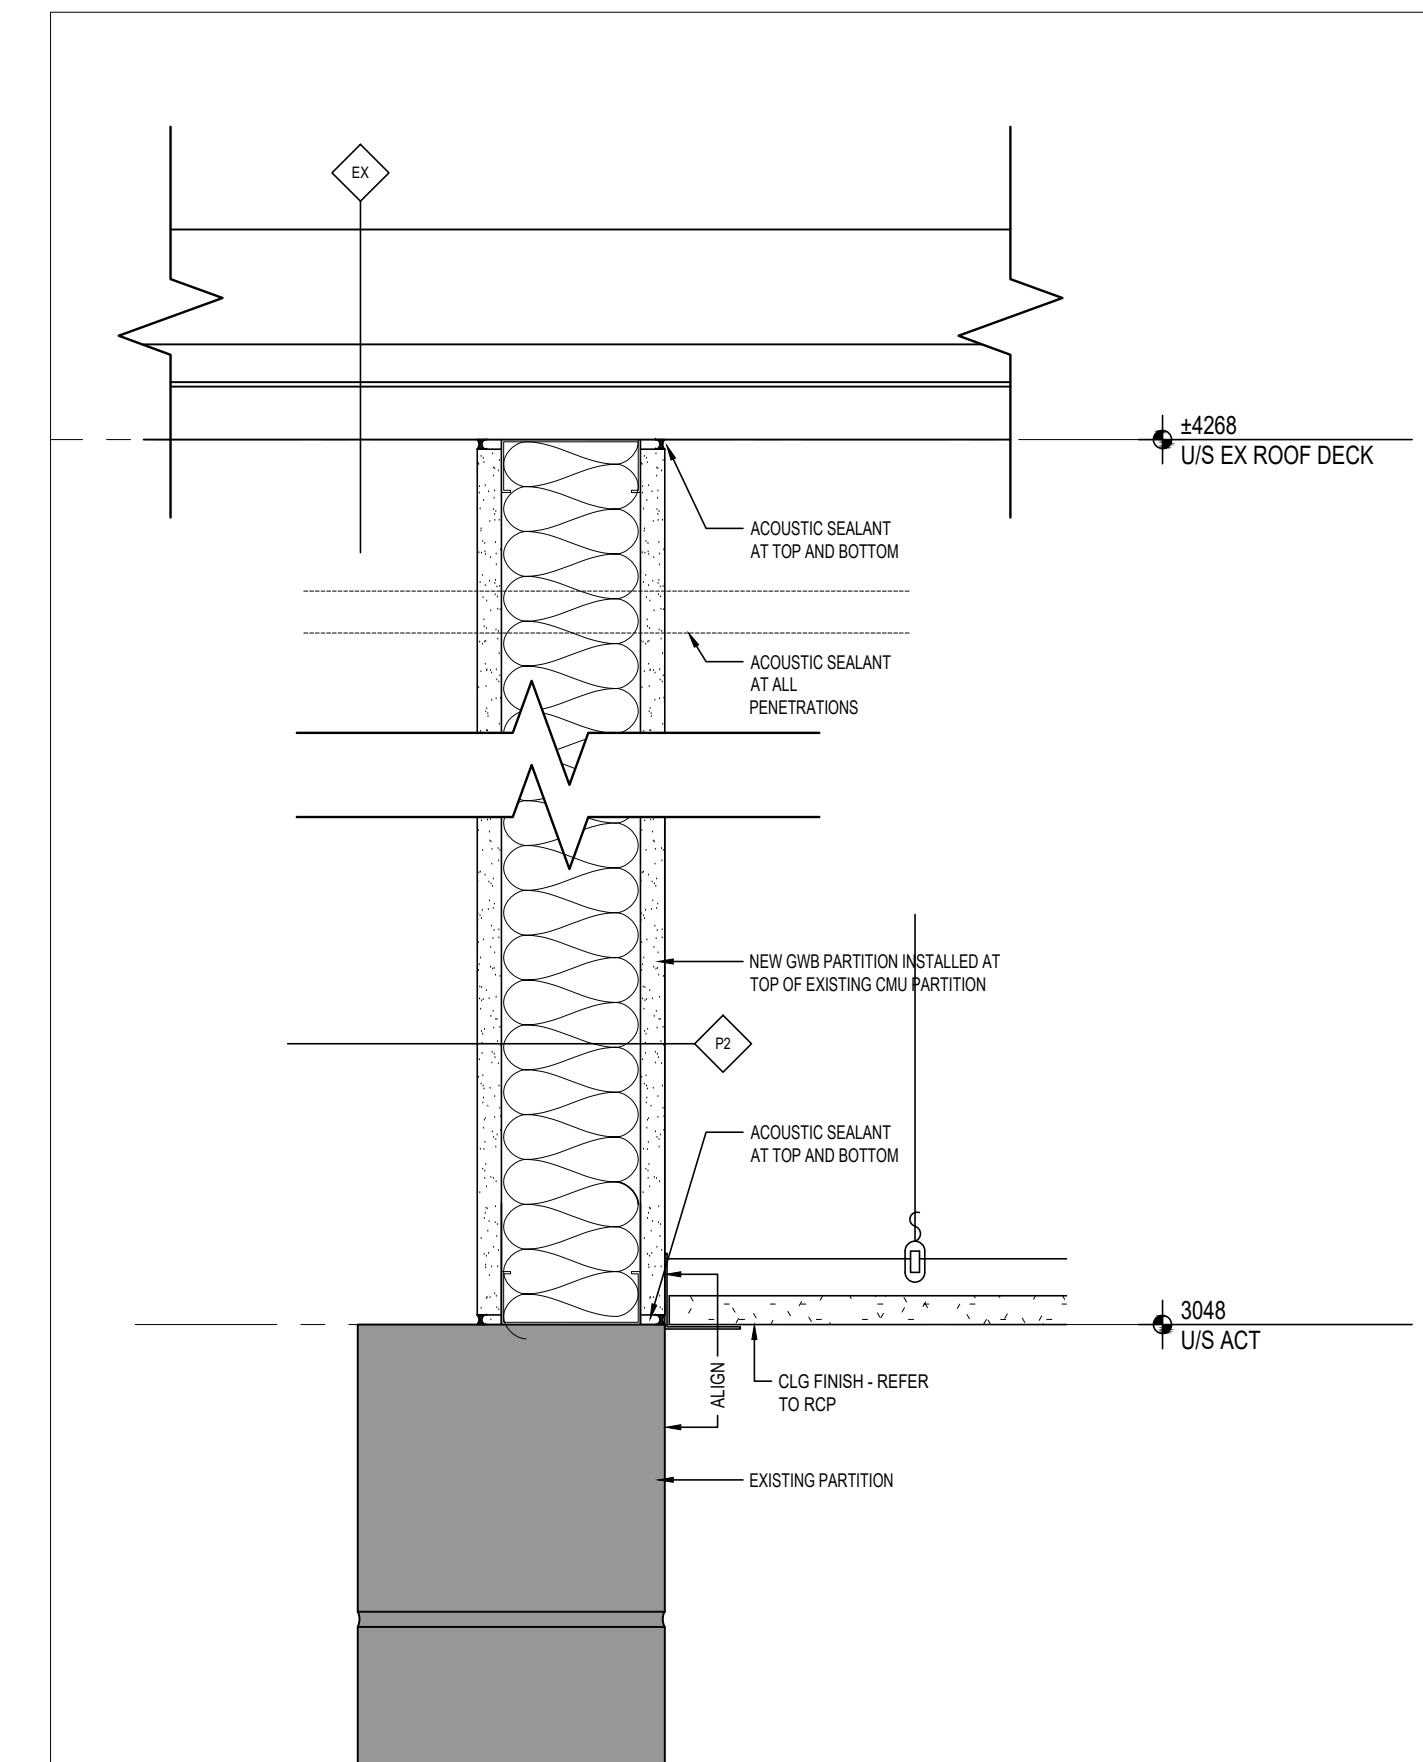

5 SECTION DETAIL AT P2 - TYP.
 A501 1 : 5

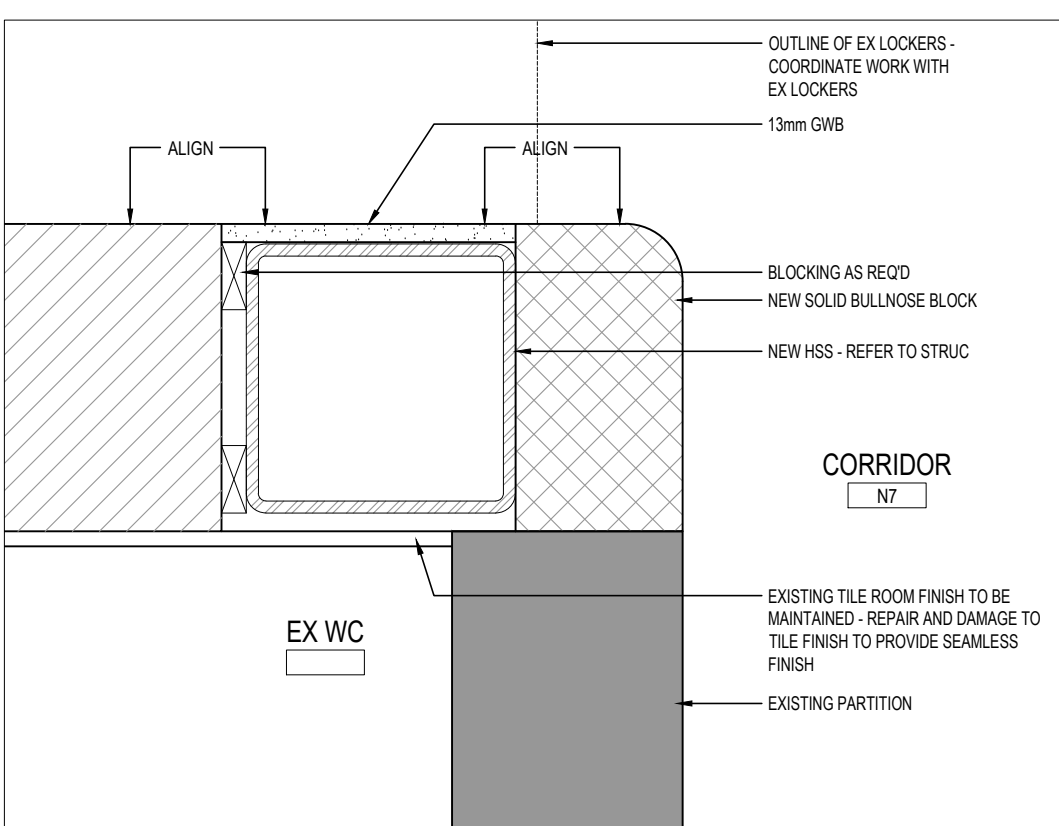

6 PLAN DETAIL AT NEW HSS
 A501 1 : 5

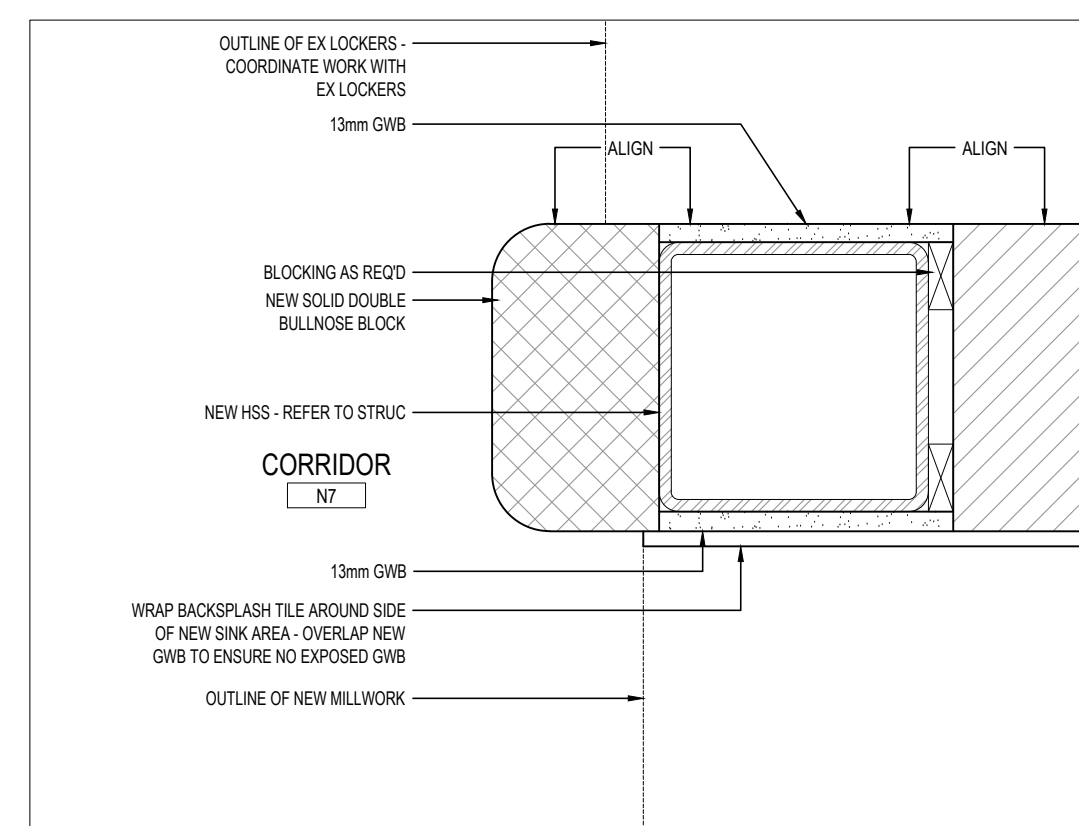

7 PLAN DETAIL AT NEW HSS
 A501 1 : 5

ISSUE DATE:

NO.	DATE	DESCRIPTION
03	2022-02-11	ISSUED FOR TENDER
02	2022-01-31	ISSUED FOR 90% CD REVIEW
01	2022-01-18	ISSUED FOR PERMIT

PROJECT:

Park Manor Public School - Phase 2
 Interior and Window Enhancements

WRDSB Tender #7266-RW-22


DRAWING TITLE:

EXTERIOR DETAILS

PROJECT NO: 21970
 SCALE: AS NOTED
 DRAWN BY: DS
 REVIEWED BY: DS

DRAWING NO:

A501

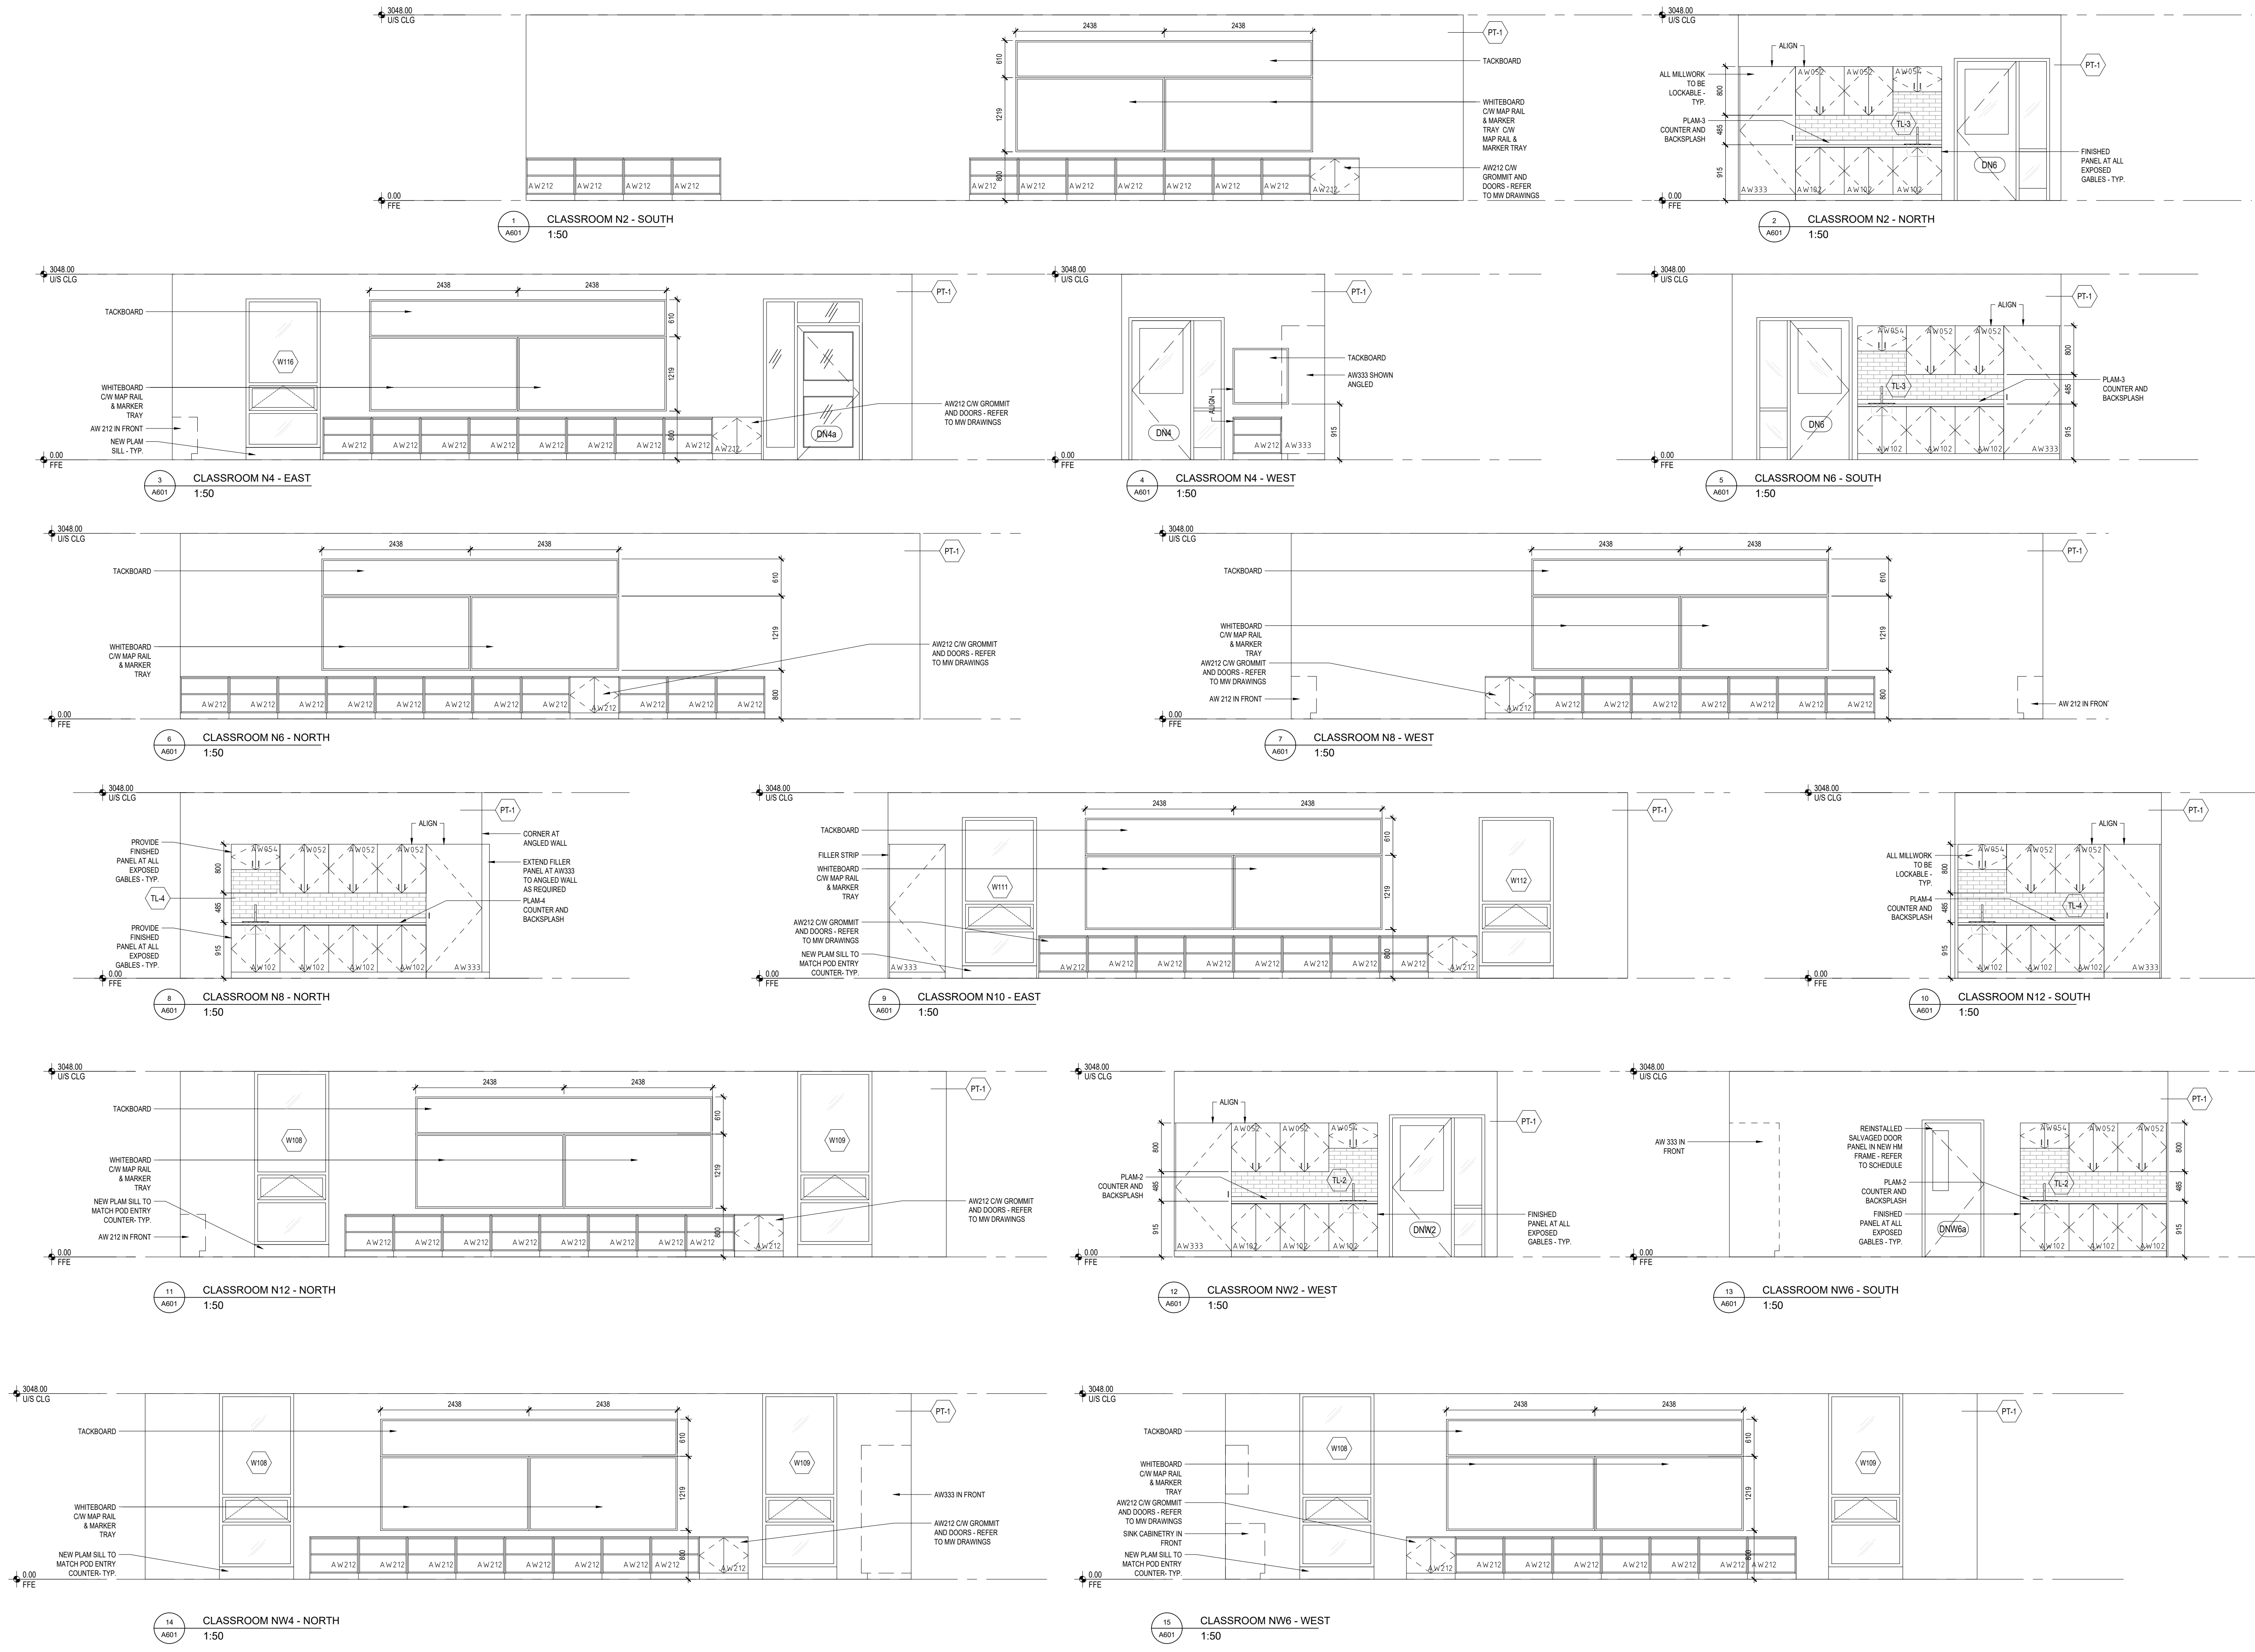

ISSUE DATE:

NO.	DATE	DESCRIPTION
02	2022-03-11	ISSUED FOR TENDER
01	2022-01-31	ISSUED FOR 90% CD REVIEW

PROJECT:
Park Manor Public School - Phase 2 Interior and Window Enhancements

WRDSB Tender #7266-RW-22

DRAWING TITLE:
INTERIOR ELEVATIONS - PROPOSED




PROJECT NO: 21970
 SCALE: 1:50
 DRAWN BY: DS
 REVIEWED BY: DS

DRAWING NO:

A601

NOTE: This drawing is the property of the architect and may not be reproduced or used without the expressed consent of the architect. The contractor shall be responsible for checking and verifying all levels and dimensions and shall report all discrepancies to the architect and obtain clarification prior to commencing work. Not for construction unless stamped by the architect and issued for such purpose.

DO NOT SCALE DRAWINGS

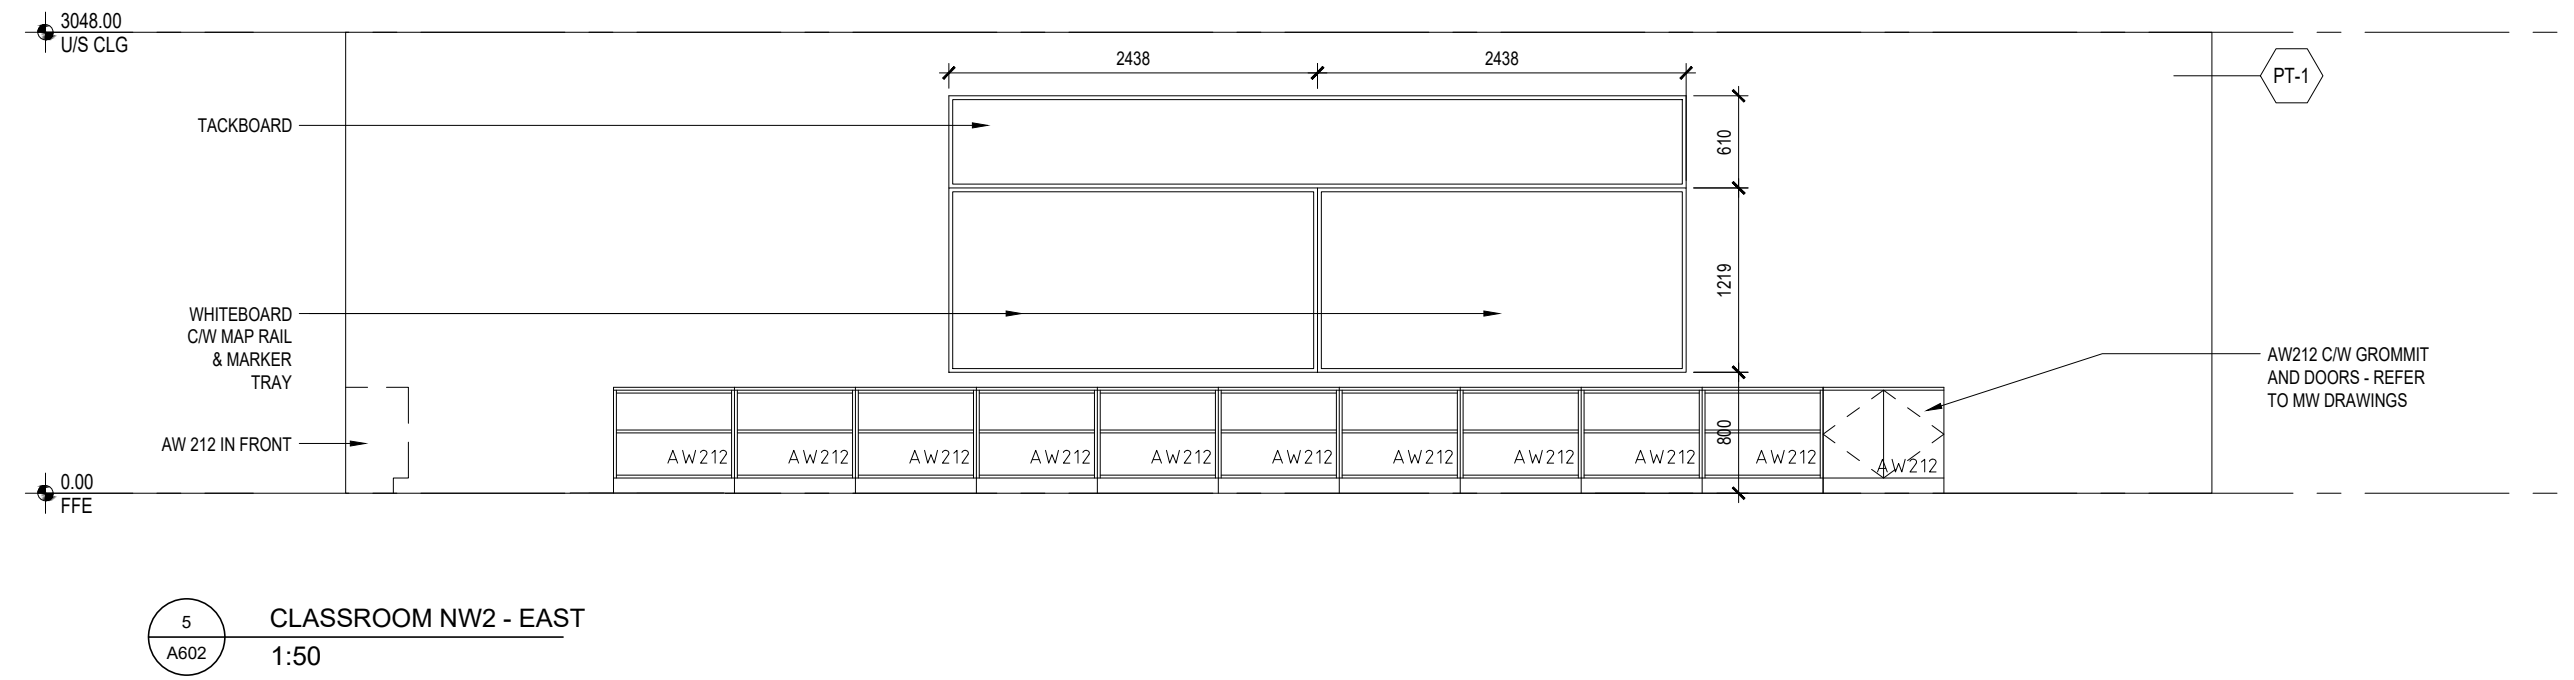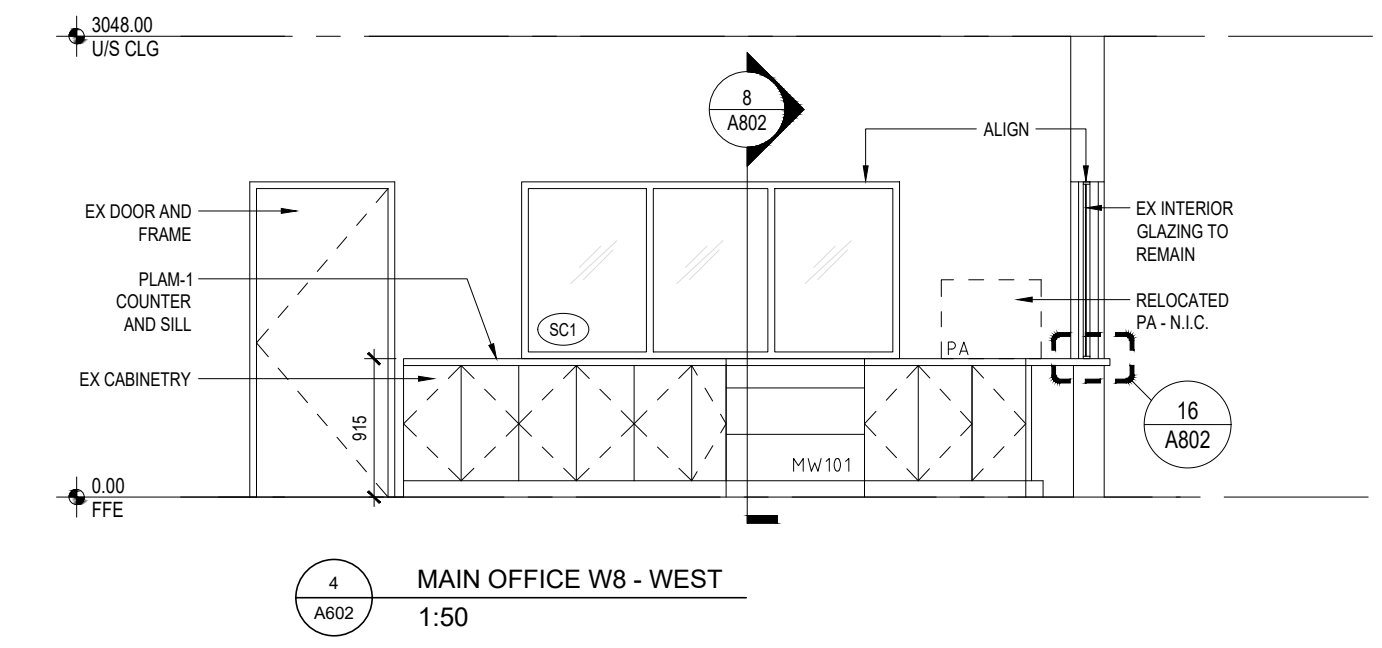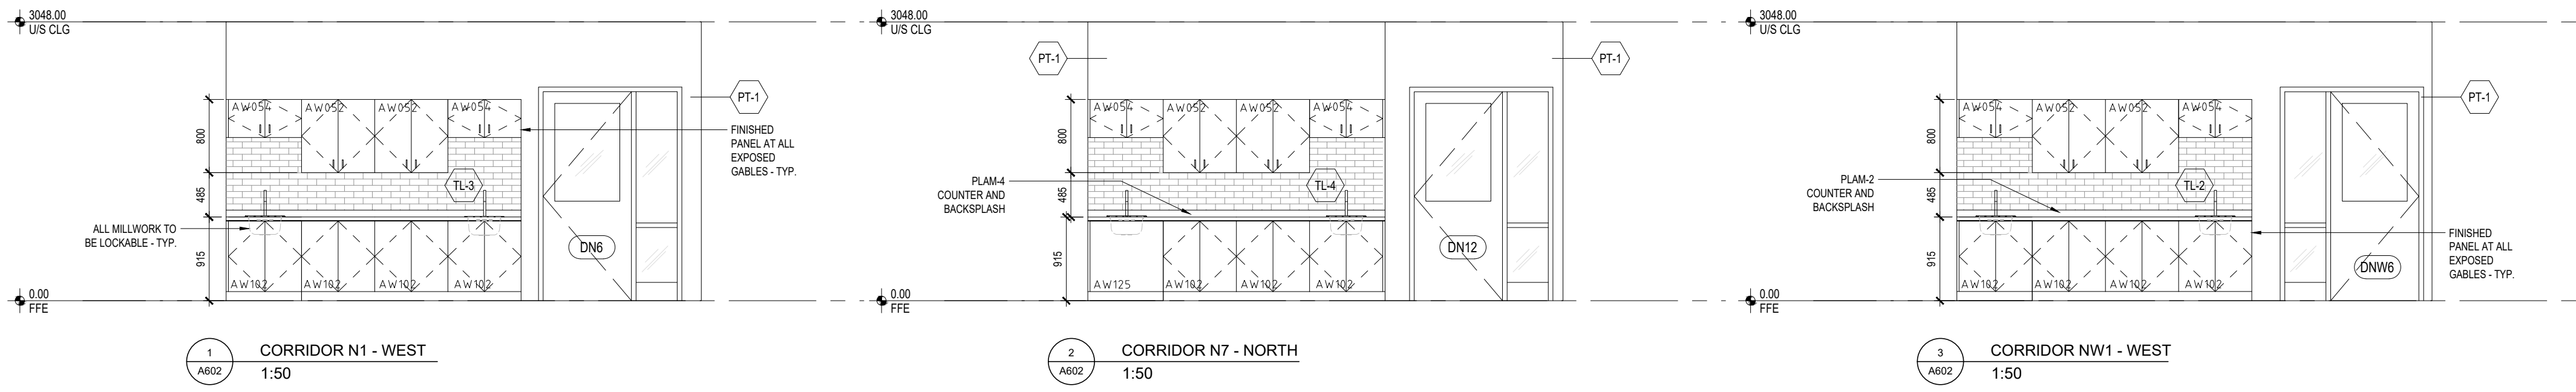

ISSUE DATE:

NO.	DATE	DESCRIPTION
02	2022-02-11	ISSUED FOR TENDER
01	2022-01-31	ISSUED FOR 90% CD REVIEW

PROJECT:

Park Manor Public School - Phase 2 Interior and Window Enhancements

WRDSB Tender #7266-RW-22

DRAWING TITLE:

INTERIOR ELEVATIONS - PROPOSED


PROJECT NO: 21970
 SCALE: 1:50
 DRAWN BY: DS
 REVIEWED BY: DS

DRAWING NO:


A602

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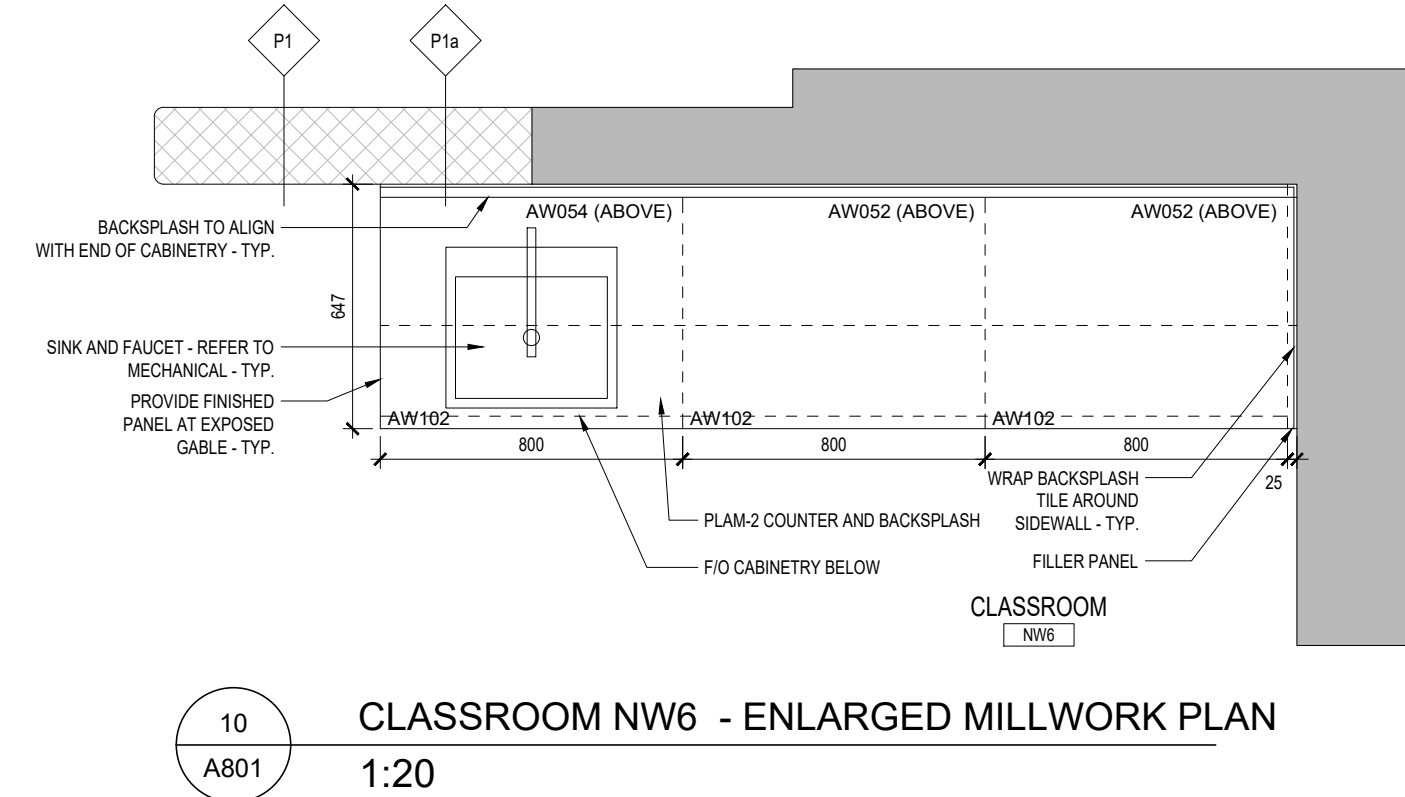
DO NOT SCALE DRAWINGS

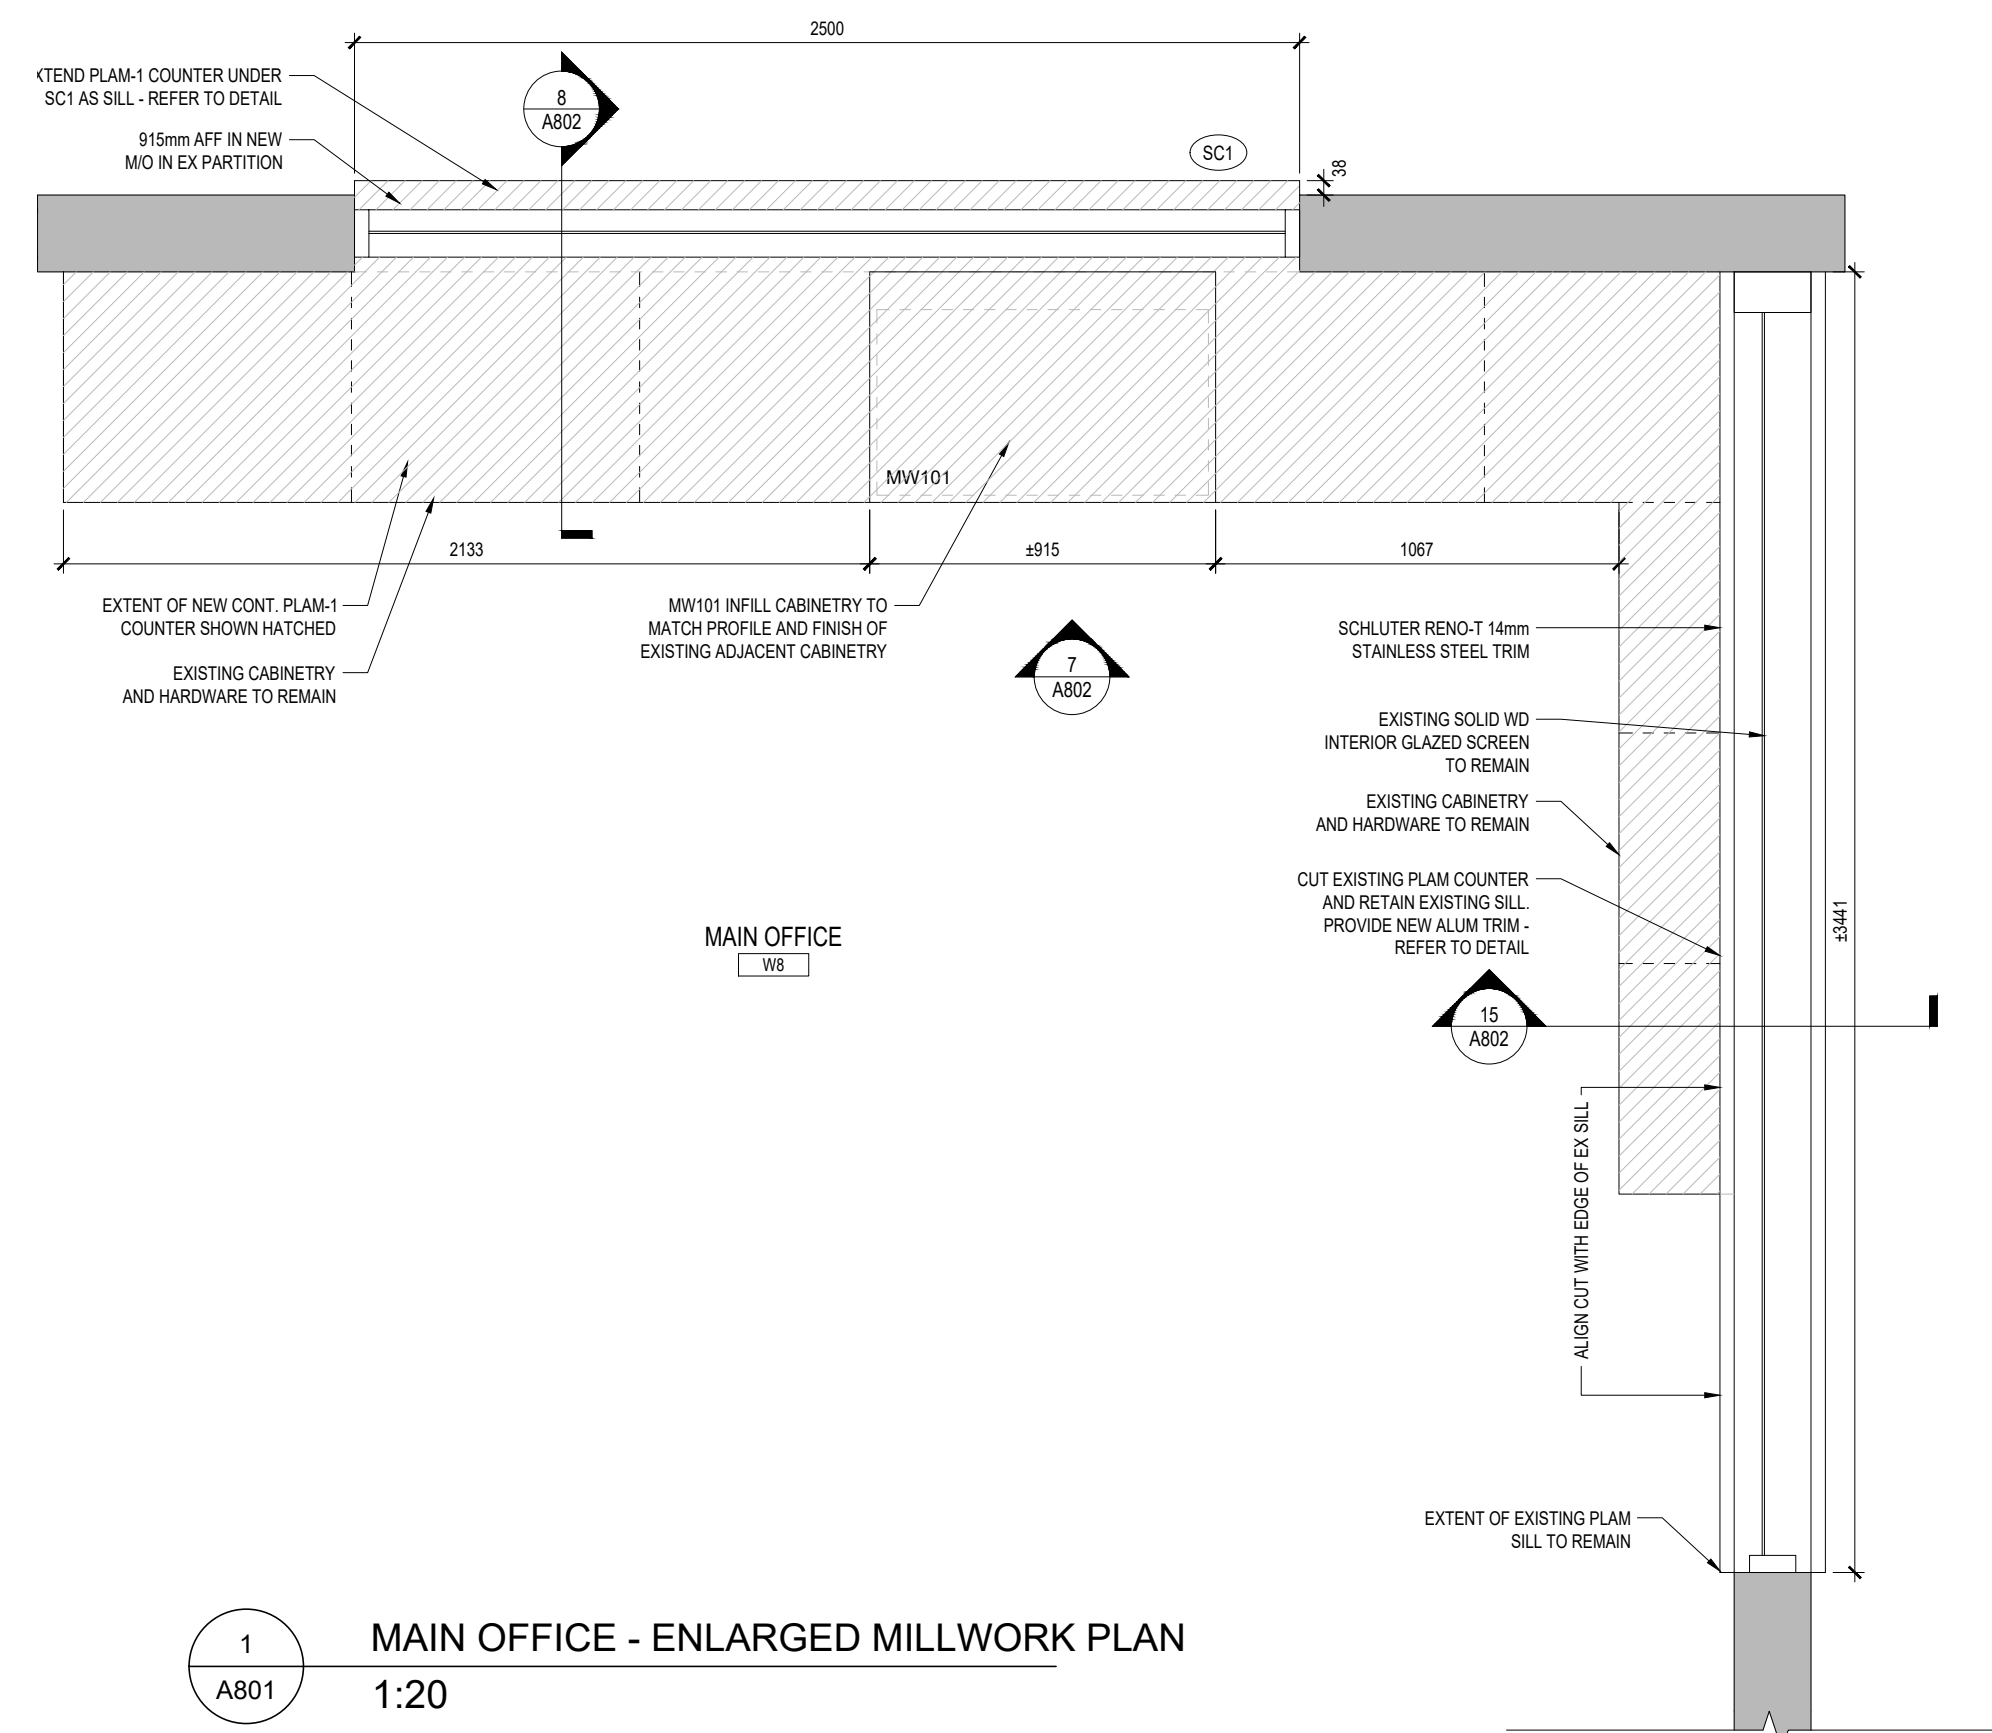


1
 A801
MAIN OFFICE - ENLARGED MILLWORK PLAN
 1:20

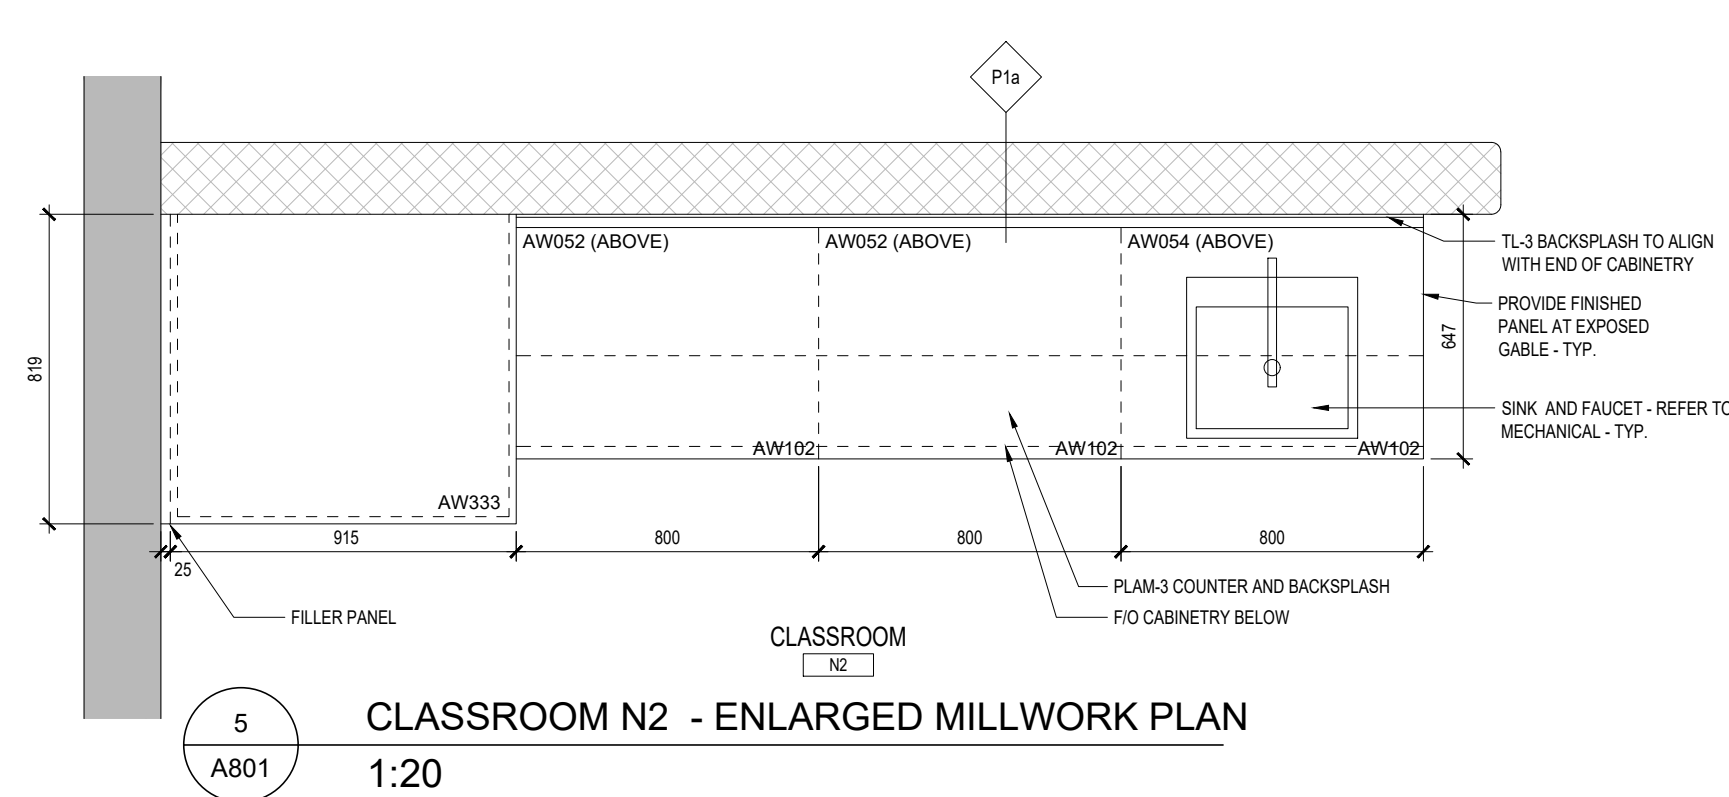


5
 A801
CLASSROOM N2 - ENLARGED MILLWORK PLAN
 1:20




10
 A801
CLASSROOM NW6 - ENLARGED MILLWORK PLAN
 1:20

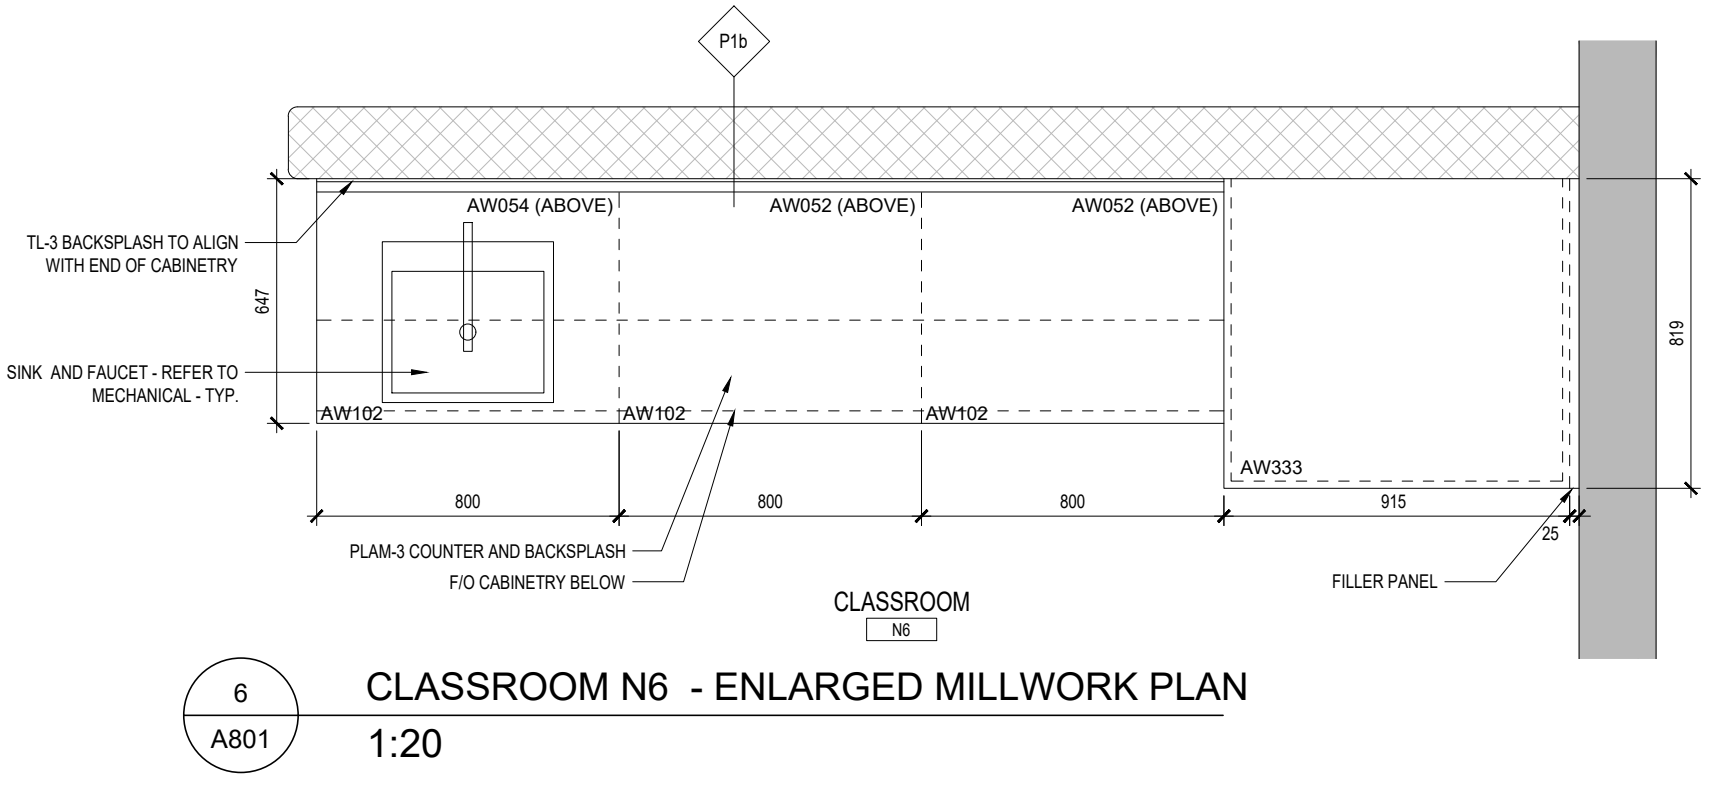


6
 A801
CLASSROOM N6 - ENLARGED MILLWORK PLAN
 1:20

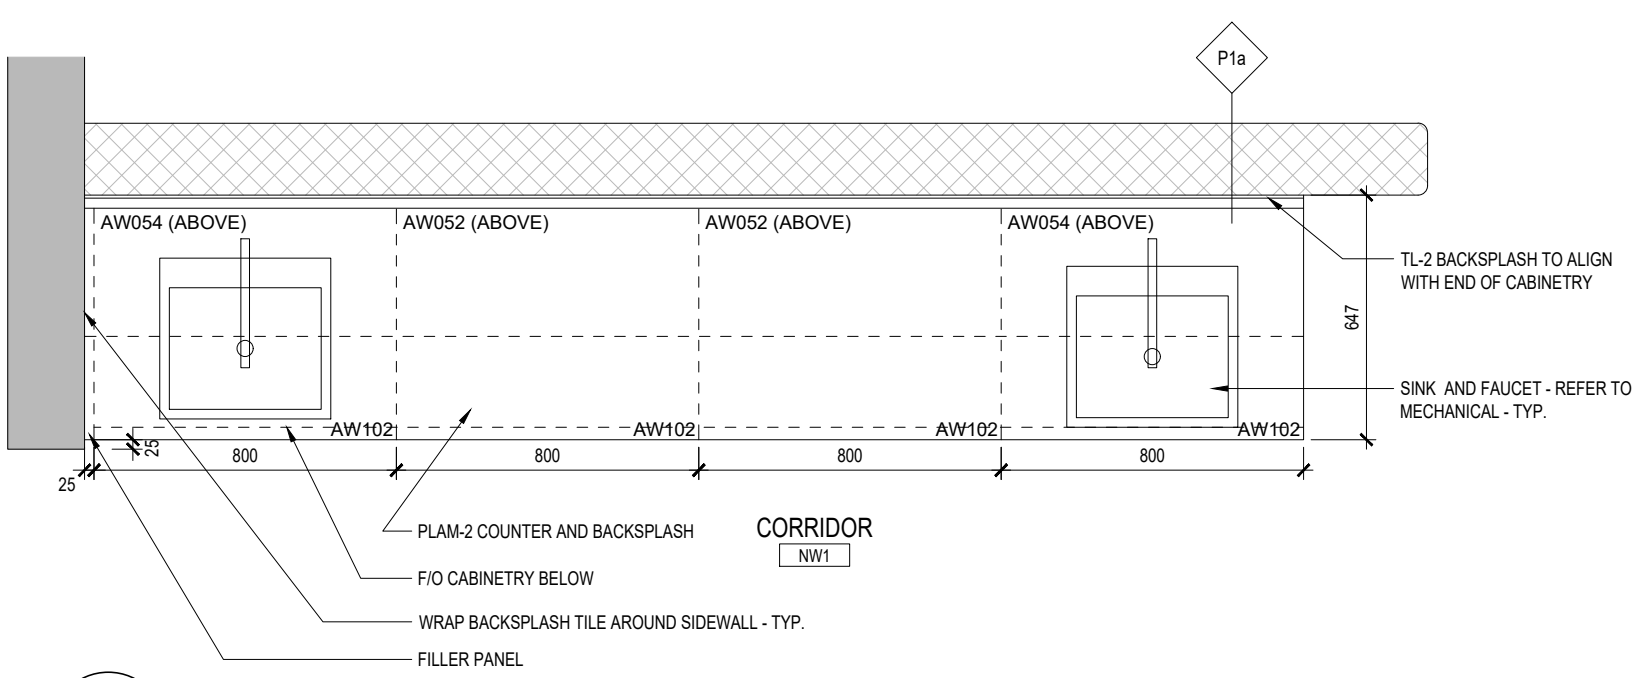


2
 A801
CORRIDOR NW1 - ENLARGED MILLWORK PLAN
 1:20

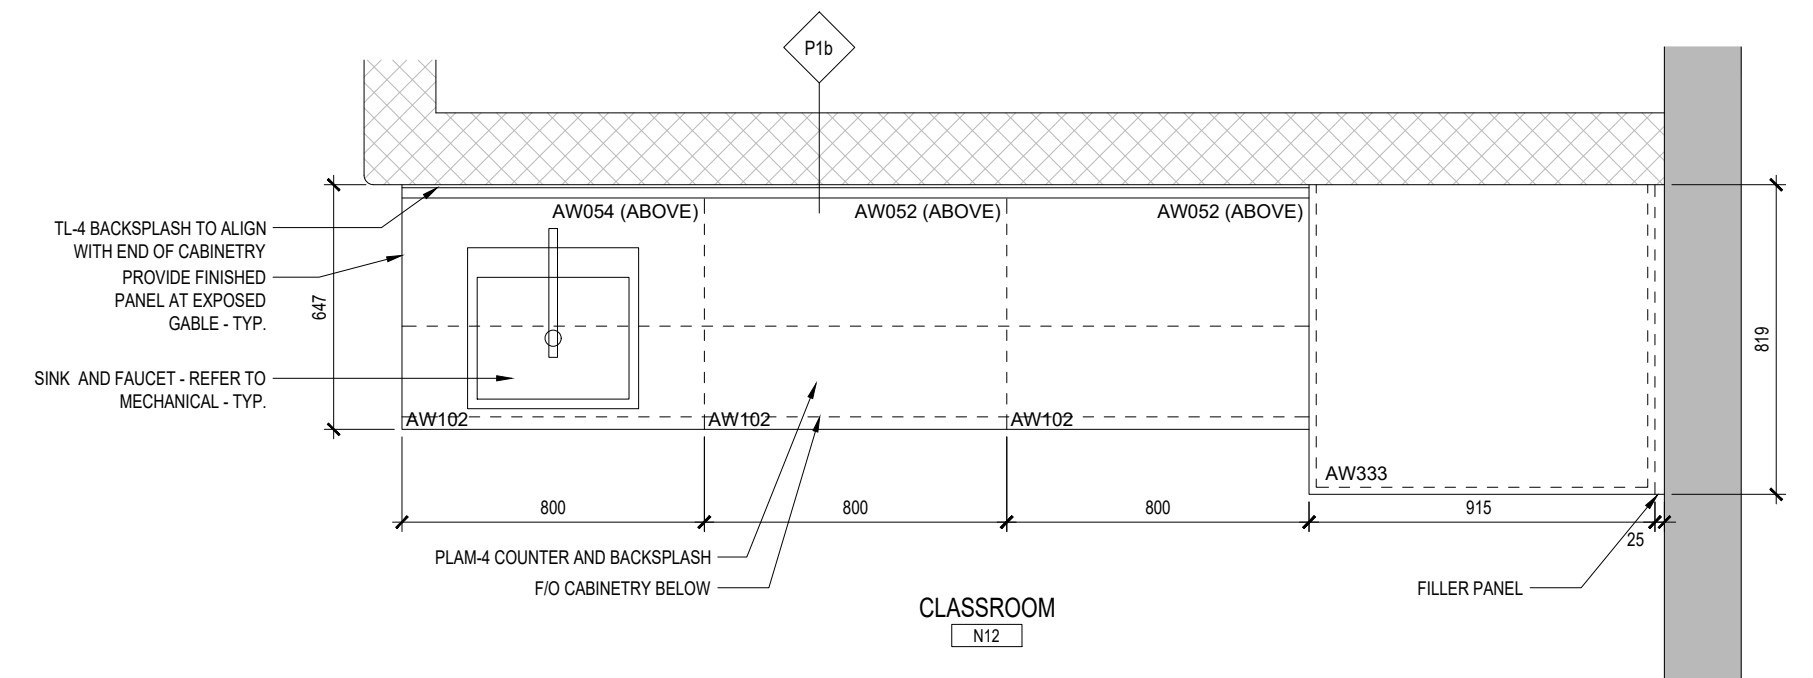


7
 A801
CLASSROOM N12 - ENLARGED MILLWORK PLAN
 1:20

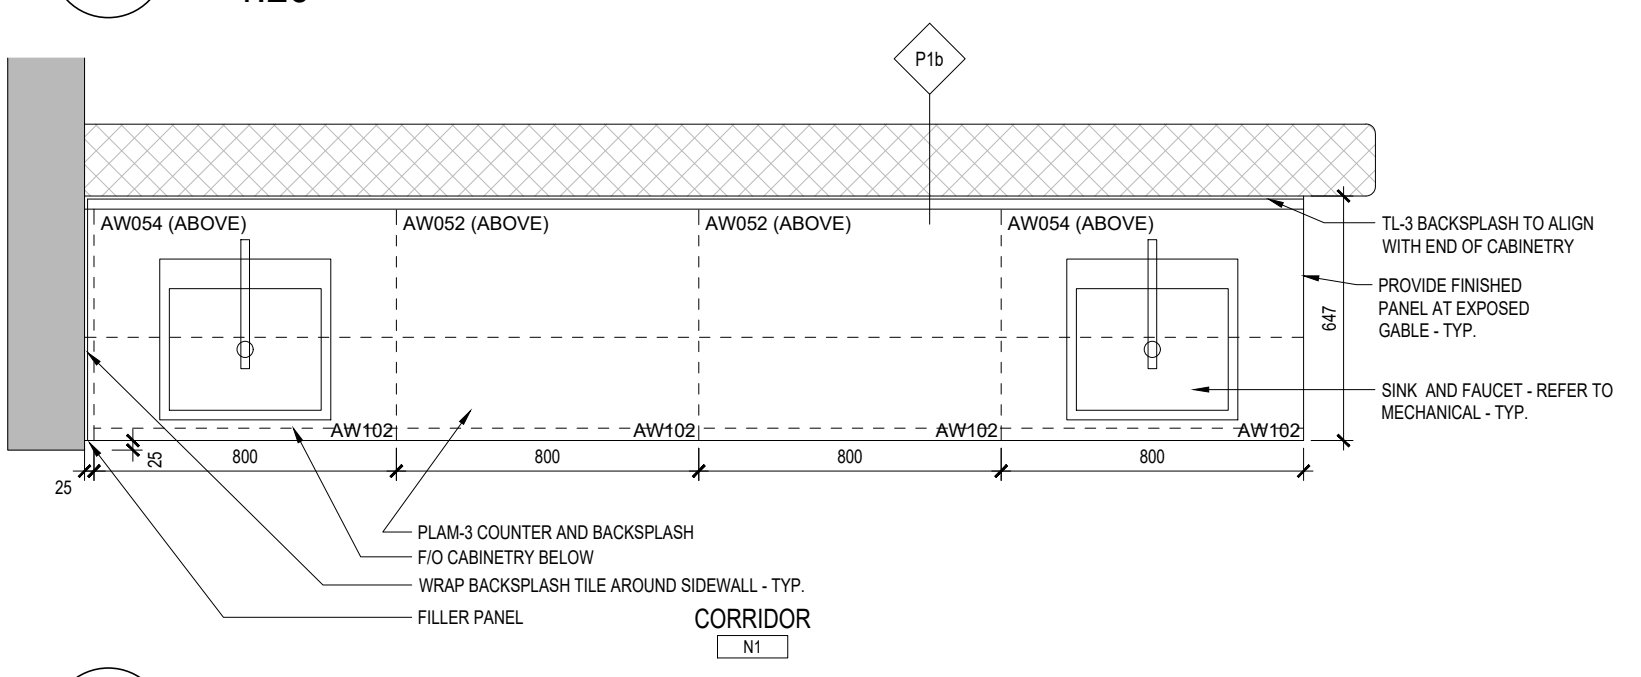


3
 A801
CORRIDOR N1 - ENLARGED MILLWORK PLAN
 1:20

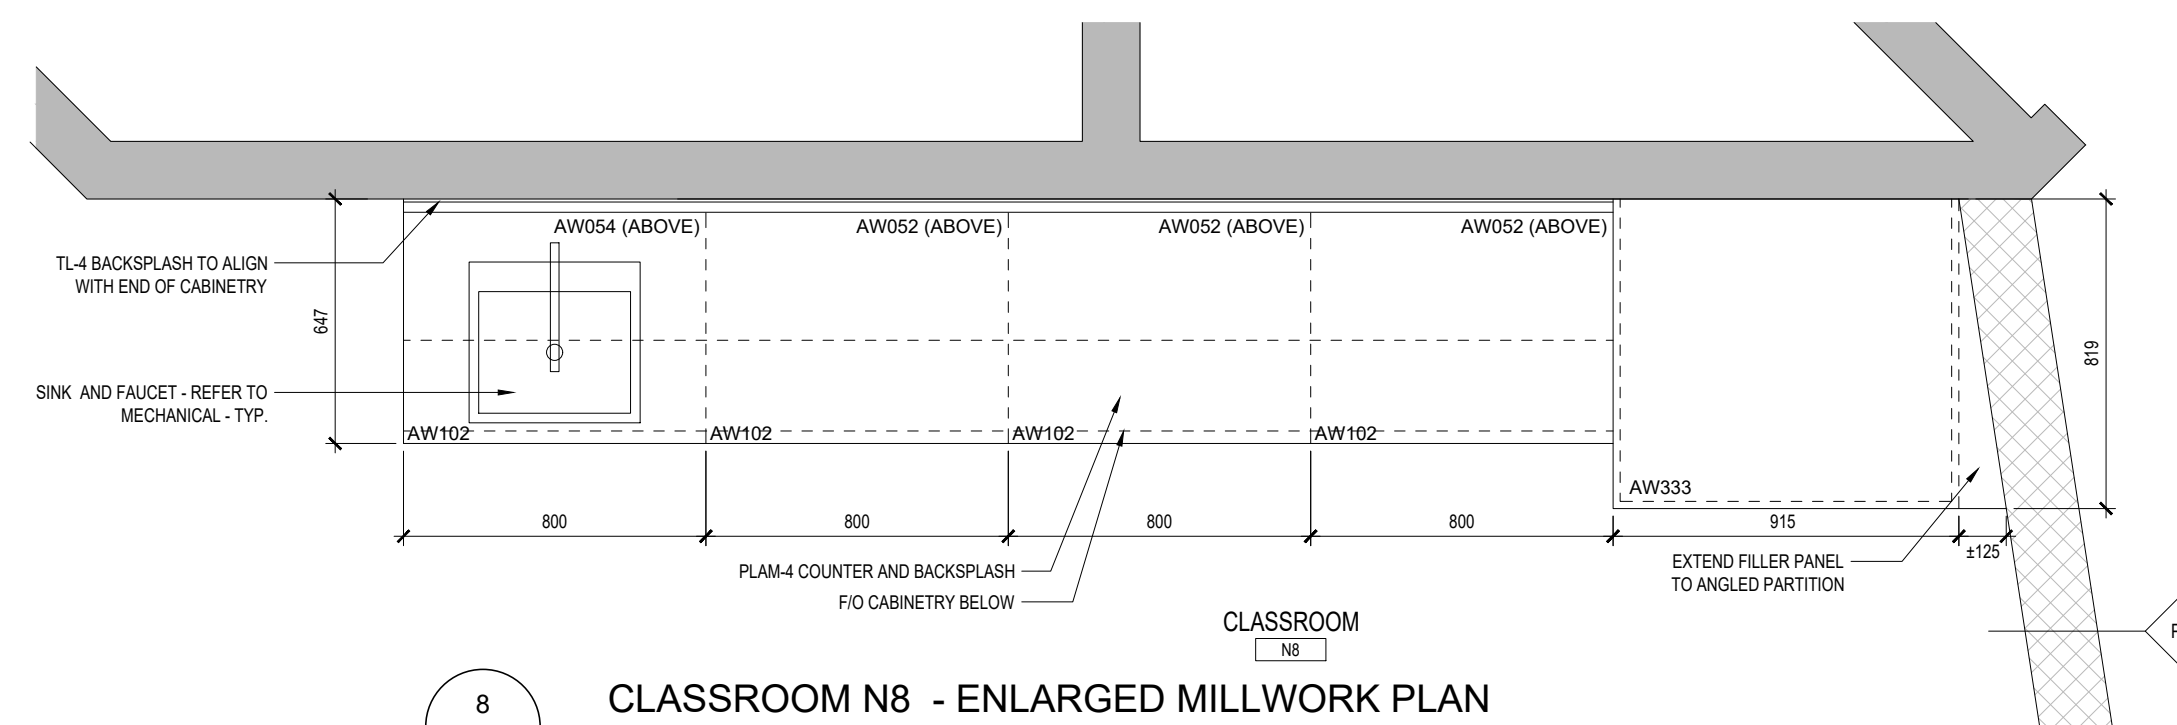

8
 A801
CLASSROOM N8 - ENLARGED MILLWORK PLAN
 1:20

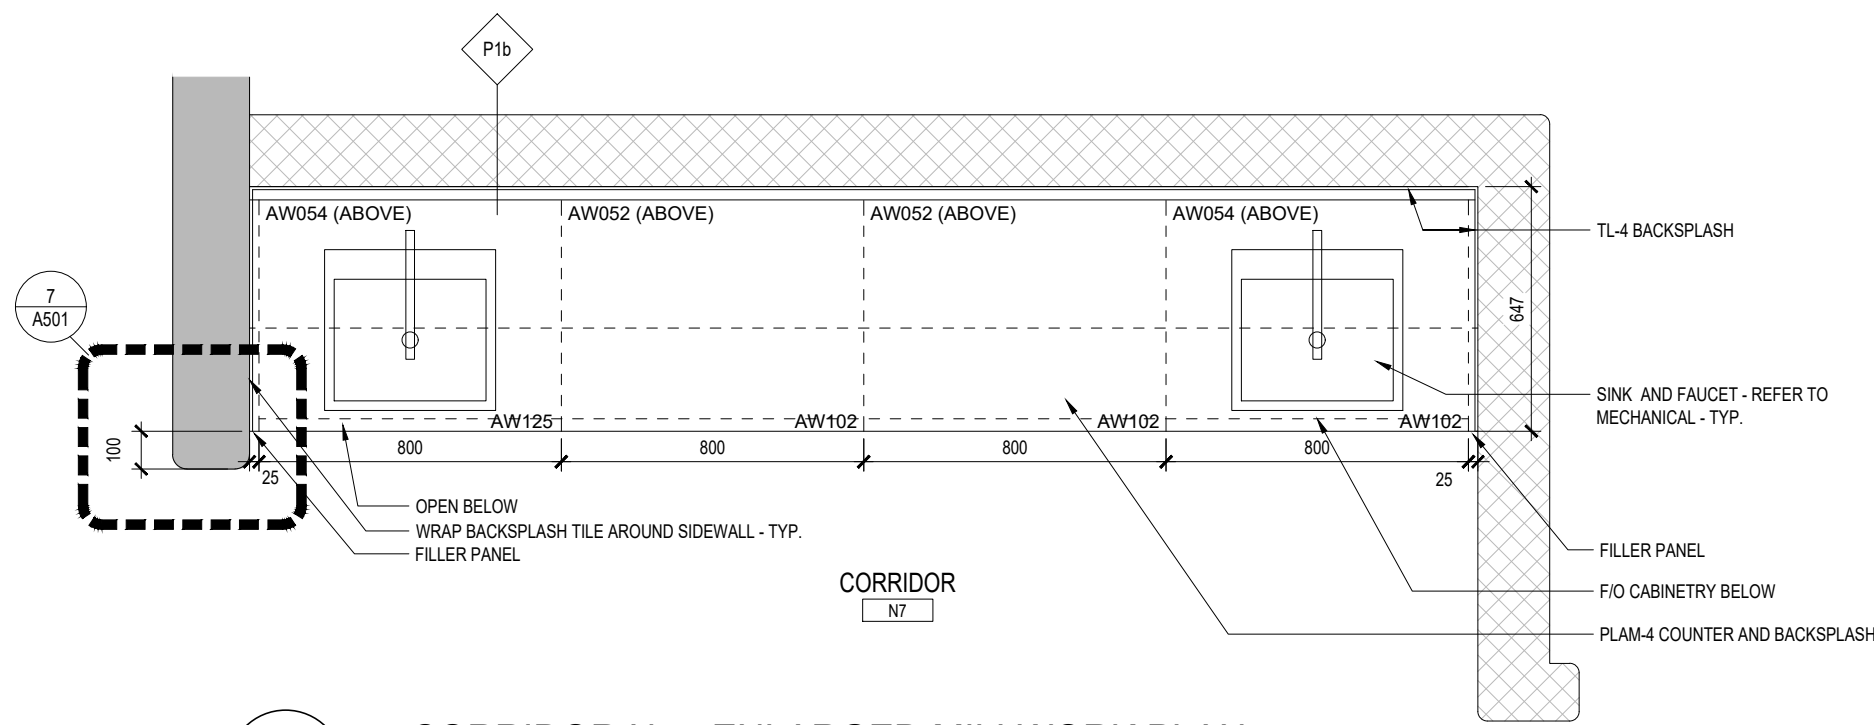

4
 A801
CORRIDOR N7 - ENLARGED MILLWORK PLAN
 1:20

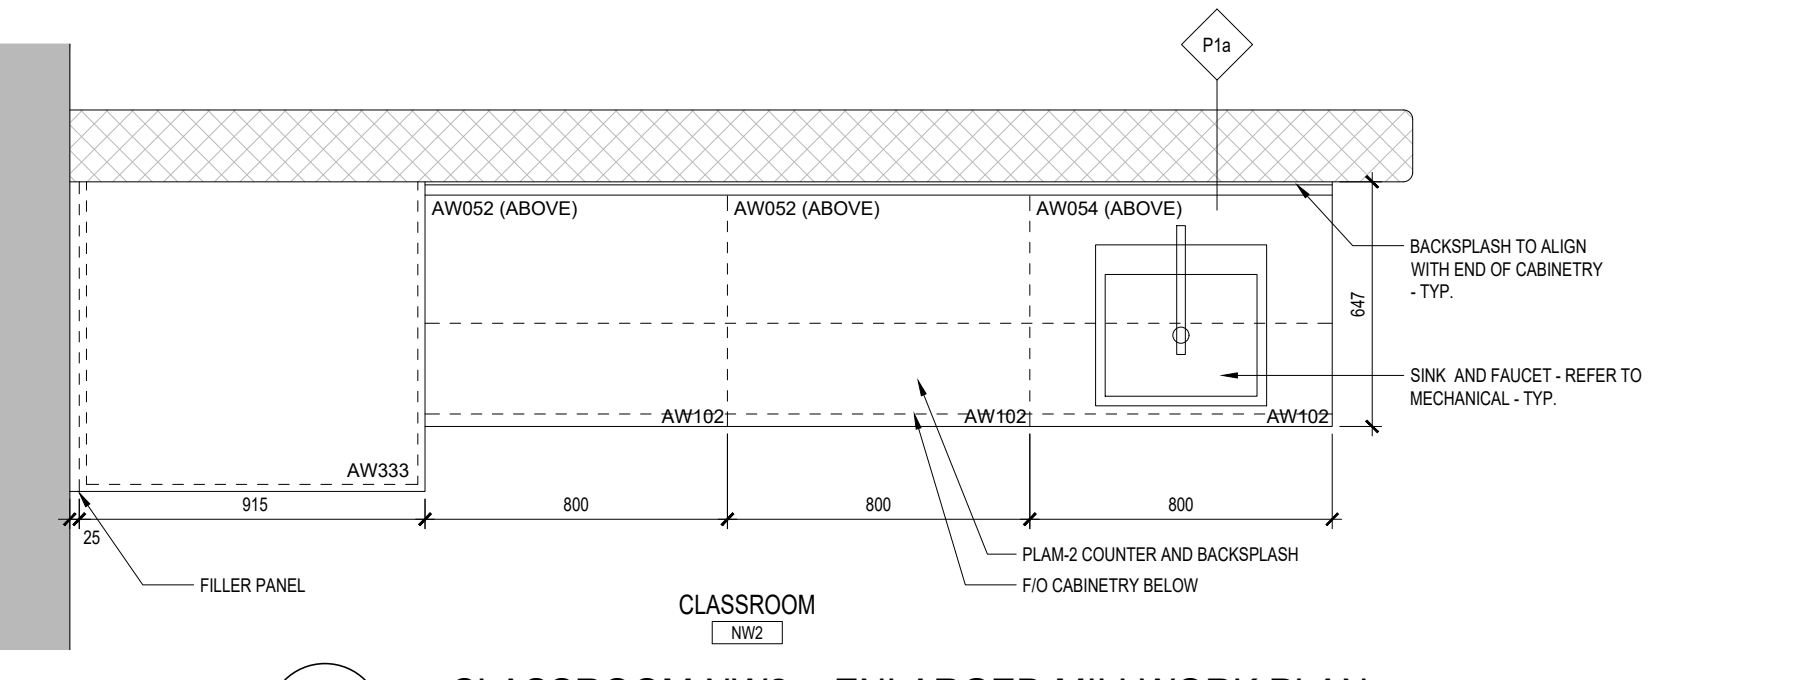

9
 A801
CLASSROOM NW2 - ENLARGED MILLWORK PLAN
 1:20

MILLWORK MATERIALS LEGEND

2	100mm HIGH RUBBER BASE TOE KICK ON 19 VENEER CORE PLYWOOD
4	19mm PLASTIC LAMINATE PANEL DRAWER FRONT c/w 3mm PVC EDGES. REFER TO SPEC FOR DRAWER SLIDERS AND DRAWER CONSTRUCTION (METABOX)
7	POST FORMED PLASTIC LAMINATE COUNTERTOP c/w 76mm HIGH BACKSPLASH ON STOCK
11	STAINLESS STEEL SINK
15	19mm MELAMINE ADJUSTABLE SHELF WITH 3mm PVC EDGES
16	19mm MELAMINE BACK c/w 3mm PVC EDGE WHERE EXPOSED
17	19mm MELAMINE TOP, BOTTOM c/w 3mm PVC EDGE
22	19mm MELAMINE FIXED SHELF c/w 3mm PVC EDGE
23	19mm PLASTIC LAMINATE DOOR c/w 3mm PVC EDGE ON ALL EXPOSED EDGES
24	19mm PLASTIC LAMINATE PANEL c/w 3mm PVC EDGE ON ALL EXPOSED EDGES
28	PLASTIC LAMINATE ON 19mm PLYWOOD

ISSUE DATE:

NO.	DATE	DESCRIPTION
02	2022-02-11	ISSUED FOR TENDER
01	2022-01-31	ISSUED FOR 90% CD REVIEW

PROJECT:

Park Manor Public School - Phase 2 Interior and Window Enhancements

WRDSB Tender #7266-RW-22

DRAWING TITLE:

ENLARGED MILLWORK PLANS




PROJECT NO: 21970
SCALE: AS NOTED
DRAWN BY: DS
REVIEWED BY: DS

DRAWING NO:

A801

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DO NOT SCALE DRAWINGS

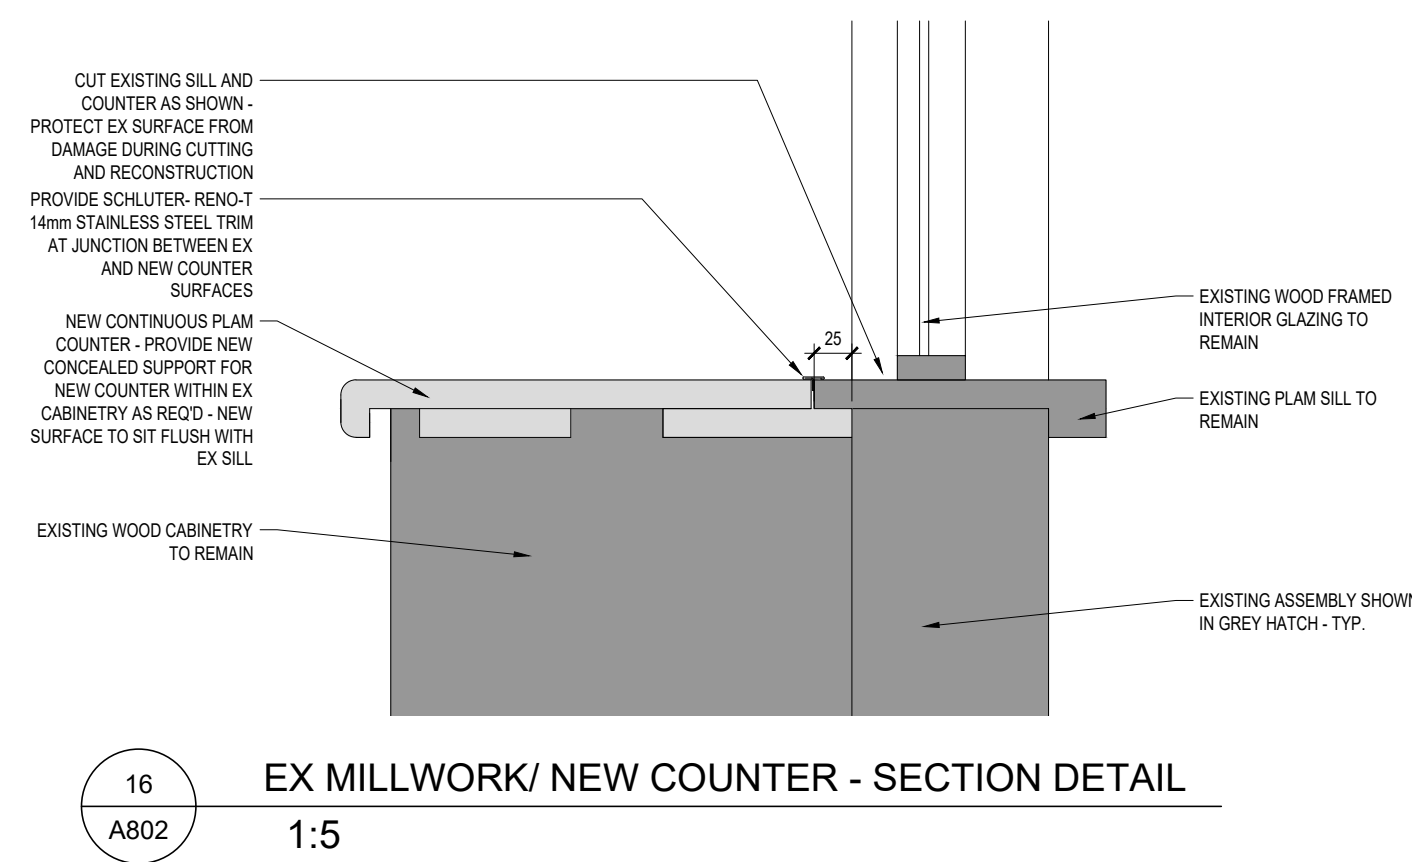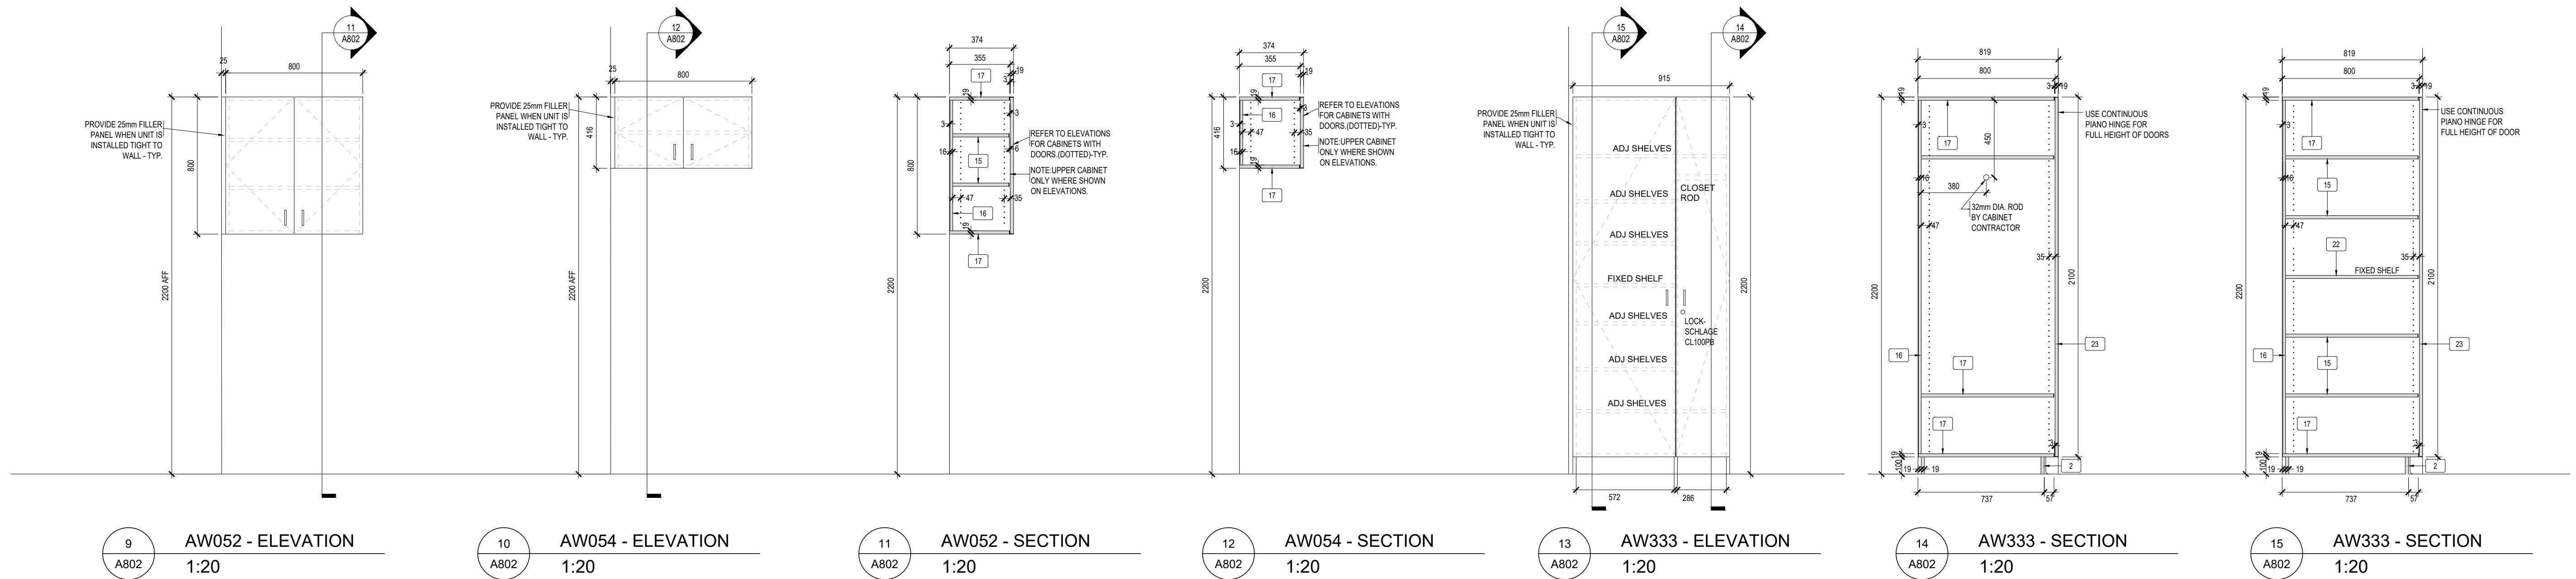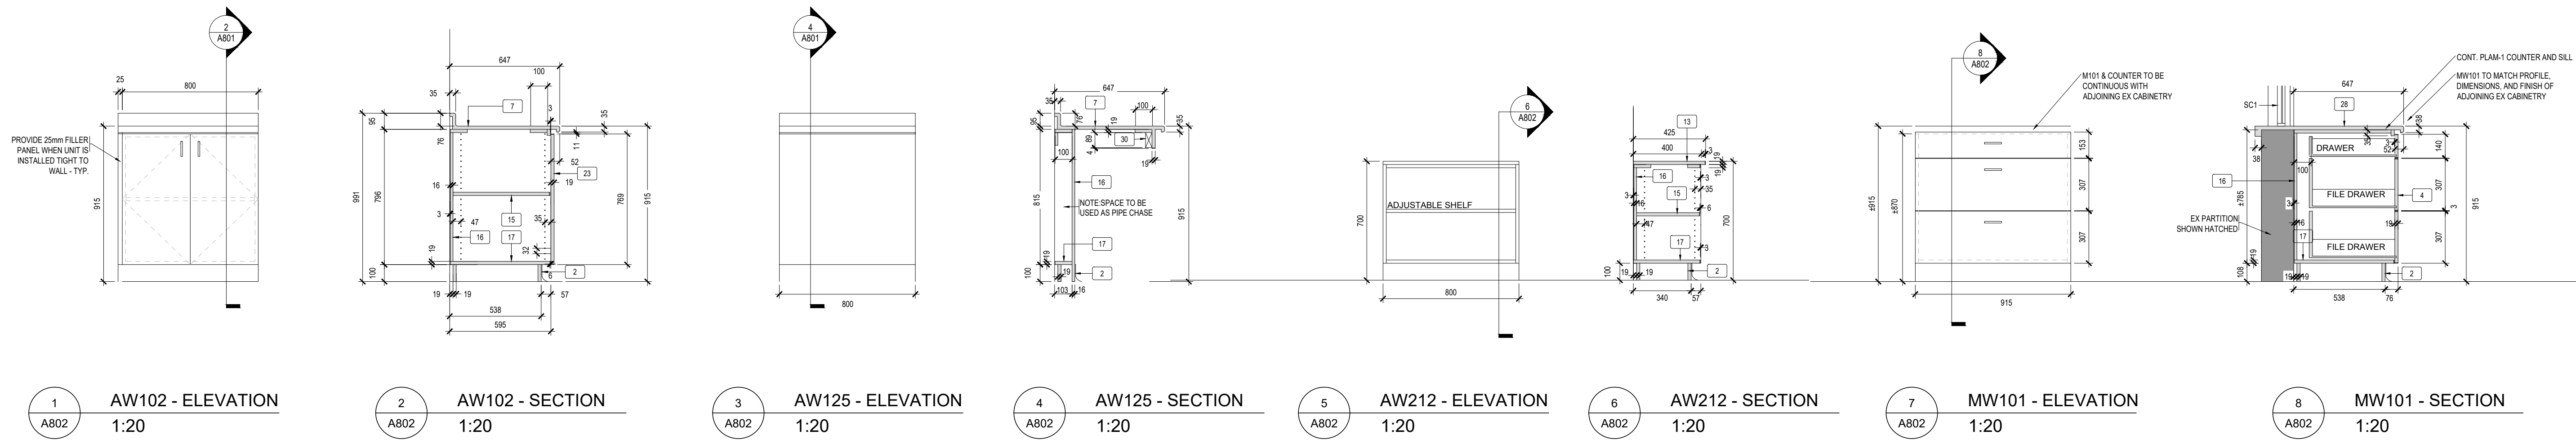

MILLWORK MATERIALS LEGEND

2	100mm HIGH RUBBER BASE TOE KICK ON 19 VENEER CORE PLYWOOD
4	19mm PLASTIC LAMINATE PANEL DRAWER FRONT c/w 3mm PVC EDGES. REFER TO SPEC FOR DRAWER SLIDERS AND DRAWER CONSTRUCTION (METABOX)
7	POST FORMED PLASTIC LAMINATE COUNTERTOP c/w 76mm HIGH BACKSPLASH ON STOCK
11	STAINLESS STEEL SINK
15	19mm MELAMINE ADJUSTABLE SHELF WITH 3mm PVC EDGES
16	19mm MELAMINE BACK c/w 3mm PVC EDGE WHERE EXPOSED
17	19mm MELAMINE TOP, BOTTOM c/w 3mm PVC EDGE
22	19mm MELAMINE FIXED SHELF c/w 3mm PVC EDGE
23	19mm PLASTIC LAMINATE DOOR c/w 3mm PVC EDGE ON ALL EXPOSED EDGES
24	19mm PLASTIC LAMINATE PANEL c/w 3mm PVC EDGE ON ALL EXPOSED EDGES
28	PLASTIC LAMINATE ON 19mm PLYWOOD

ISSUE DATE:

NO.	DATE	DESCRIPTION
02	2022-03-11	ISSUED FOR TENDER
01	2022-01-31	ISSUED FOR 90% CD REVIEW

PROJECT:

Park Manor Public School - Phase 2 Interior and Window Enhancements

WRDSB Tender #7266-RW-22

DRAWING TITLE:

MILLWORK DETAILS

PROJECT NO: 21970
SCALE: AS NOTED
DRAWN BY: DS
REVIEWED BY: DS

DRAWING NO:

A802