FIRM NAME: LOCATION: 150 Belleview Avenue WORKSHOP ARCHITECTURE Kitchener, ON 6 SOUSA MENDES ST Toronto, ON M6P 0A8 tel. 416.901.8055 fax 416.849.0383 NAME OF PROJECT: Project Area: 480 M<sup>2</sup> Interior Renovations & HVAC Upgrades **OBC REFERENCE** References are to Division B unless noted ONTARIO'S 2012 BUILDING CODE DATA MATRIX PARTS 3 & 9 [A] for Division A or [C] for Division C PROJECT DESCRIPTION: □ NEW ☑ PART 11 ☑ PART 3 □ PART 9 □ ADDITION 11.1 TO 11.4 1.1.2. [A] 1.1.2 [A] & 9.10.1.3 □ CHANGE OF USE 2 MAJOR OCCUPANCY(S): A2 9.10.2 3.1.2.1(1) 3 BUILDING AREA (M²) NEW TOTAL no change 1.4.1.2.[A] 1.4.1.2.[A] 4 GROSS AREA **EXISTING** NEW TOTAL no change 1.4.1.2.[A] 1.4.1.2.[A] BELOW GRADE 0 5 NUMBER OF STOREYS ABOVE GRADE 1.4.1.2 [A] & 3.2.1. 1.4.1.2 [A]&9.10.4 6 NUMBER OF STREETS / FIRE FIGHTER ACCESS 1 (EXISTING UNCHANGED) 3.2.2.10 & 3.2.5 9.10.20 7 BUILDING CLASSIFICATION 9.10.2. 3.2.2.25 (Existing Non-conforming) 3.2.2.20-.83 8 SPRINKLER SYSTEM (PROPOSED) 

ENTIRE BUILDING 

SELECTED COMPARTMENTS 3.2.2.20-.83 9.10.8.2. ☐ IN LIEU OF ROOF RATING 3.2.1.5 □ BASEMENT 3.2.2.17 ☐ SELECTED FLOOR AREAS INDEX INDEX 9 STANDPIPE REQUIRED □YES ☑ NO 3.2.9 10 FIRE ALARM REQUIRED 3.2.4 9.10.18 11 WATER/SERVICE/SUPPLY IS ADEQUATE 3.2.5.7 12 HIGH BUILDING □YES ☑NO 3.2.6 N/A 13 CONSTRUCTION RESTRICTIONS ☑ COMBUSTIBLE  $\square$  NON-COMBUSTIBLE  $\square$  BOTH 3.2.2.20-.83 9.10.6 PERMITTED REQUIRED **ACTUAL CONSTRUCTION** COMBUSTIBLE □ NON-COMBUSTIBLE ☑ BOTH 9.10.4.1 14 MEZZANINE(S) AREA M<sup>2</sup> 3.2.1.1.(3)-(8) 15 OCCUPANT LOAD BASED ON ☐ M.SQ./PERSON 3.1.17 9.9.1.3 240 students OCCUPANCY: A2 18 staff 258 PERSONS UNCHANGED 16 BARRIER-FREE DESIGN ☑ YES □ NO (EXPLAIN) 17 HAZARDOUS SUBSTANCES □ YES NO 3.3.1.2. & 3.3.1.19 9.10.1.3(4) 3.2.2.20-.83 & 3.2.1.4 9.10.8 18 REQUIRED HORIZONTAL ASSEMBLIES LISTED DESIGN NO. OR DESCRIPTION (SG-2) FRR (HOURS) RESISTANCE FLOORS 45 MIN existing no change RATING ROOF 45 MIN existing no change NO CHANGE (FRR) MEZZANINE N/A LISTED DESIGN NO. FRR OF SUPPORTING MEMBERS NO CHANGE OR DESCRIPTION (SG-2) FLOORS no change HOURS ROOF no change HOURS MEZZANINE N/A HOURS 19 SPATIAL SEPARATION - CONSTRUCTION OF EXTERIOR WALLS NA 3.2.3 9.10.14 20 OTHER-DESCRIBE Existing non-conforming items:

Existing Corridor walls are not constructed as fire separations with FRR of 45min as required by 3.3.2.5 (2) & 3.4.2.4 (2). New HVAC

ductwork will be equipped with fire dampers and new penetrations firestopped in accordance with these clauses

Building area exceeds area for building classification 3.2.2.25.

NAME OF PRACTICE: **WORKSHOP** Architecture 6 Sousa Mendes Street Toronto, ON M6P 0A8 phone: 416.901.8055 NAME OF PROJECT: Smithson PS HVAC Upgrades &

HVAC upgrades in classrooms, washrooms, corridors and vestibules Admin/Staff Area Renovations

LOCATION: 150 Belleview Avenue Kitchener, ON

in west wing & central lobby of school with minor interior renovations Interior renovations to reconfigure main office to include health room, barrier-free wc and expanded office area. Renovation to existing staff work room, staff wc and custodial area.

Conversion of existing classroom in to Special Education Room. Demolition of existing redundant vestibule and boiler room chimney.

Ontario Building Code Data Matrix – Part 11 – Renovation of Existing Building							
11.1	Existing Building classification:	Describe Existing Use: Construction Index: Existing Hazard Index: Hazard Index for Proposed use: Not Applicable (no change	A2 - Elementary School of major occupancy)	11.2.1 T 11.2.1.1A T 11.2.1.1B to N			
11.2	Alteration to Existing Building is:	Basic Renovation Extensive Renovation	<b>x</b>	11.3.3.1 11.3.3.2			
11.3	Reduction in Performance Level:	Structural:  By Increase in occupant load:  By change of major occupancy:  Plumbing:  Sewage-system:	X       No       ☐ Yes         X       No       ☐ Yes         X       No       ☐ Yes         X       No       ☐ Yes         X       No       ☐ Yes	11.4.2 11.4.2.1 11.4.2.2 11.4.2.3 11.4.2.4 11.4.2.5			
11.4	Compensating Construction:	Structural: Increase in occupant load: Change of major occupancy: Plumbing: Sewage system:	X       No       ☐ Yes         X       No       ☐ Yes         X       No       ☐ Yes         X       No       ☐ Yes         X       No       ☐ Yes	11.4.3 11.4.3.2 11.4.3.3 11.4.3.4 11.4.3.5 11.4.3.6			
11.5	Compliance Alternatives Proposed:	X No ☐ Yes		11.5.1			

**ARCHITECTURAL** 

Cover Sheet


Demolition Plans

Demolition RCP

Proposed Plans & Schedules

**PROJECT DESCRIPTION:** 


2 Site - Detail Plan 1:200

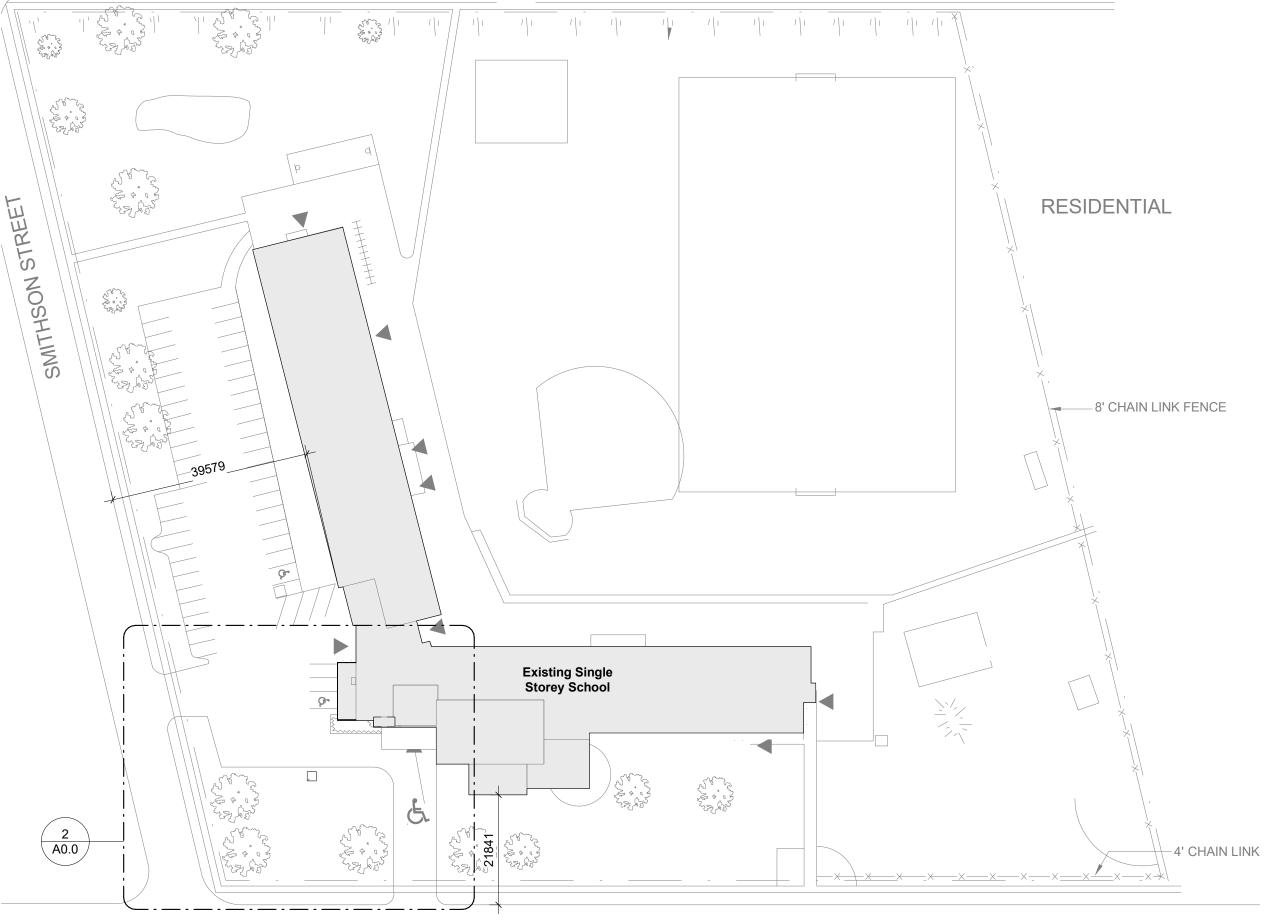

**BELLEVIEW STREET** 

LOT SIZE: 8.00 AC (3.237 ha)

SHERWOOD AVENUE

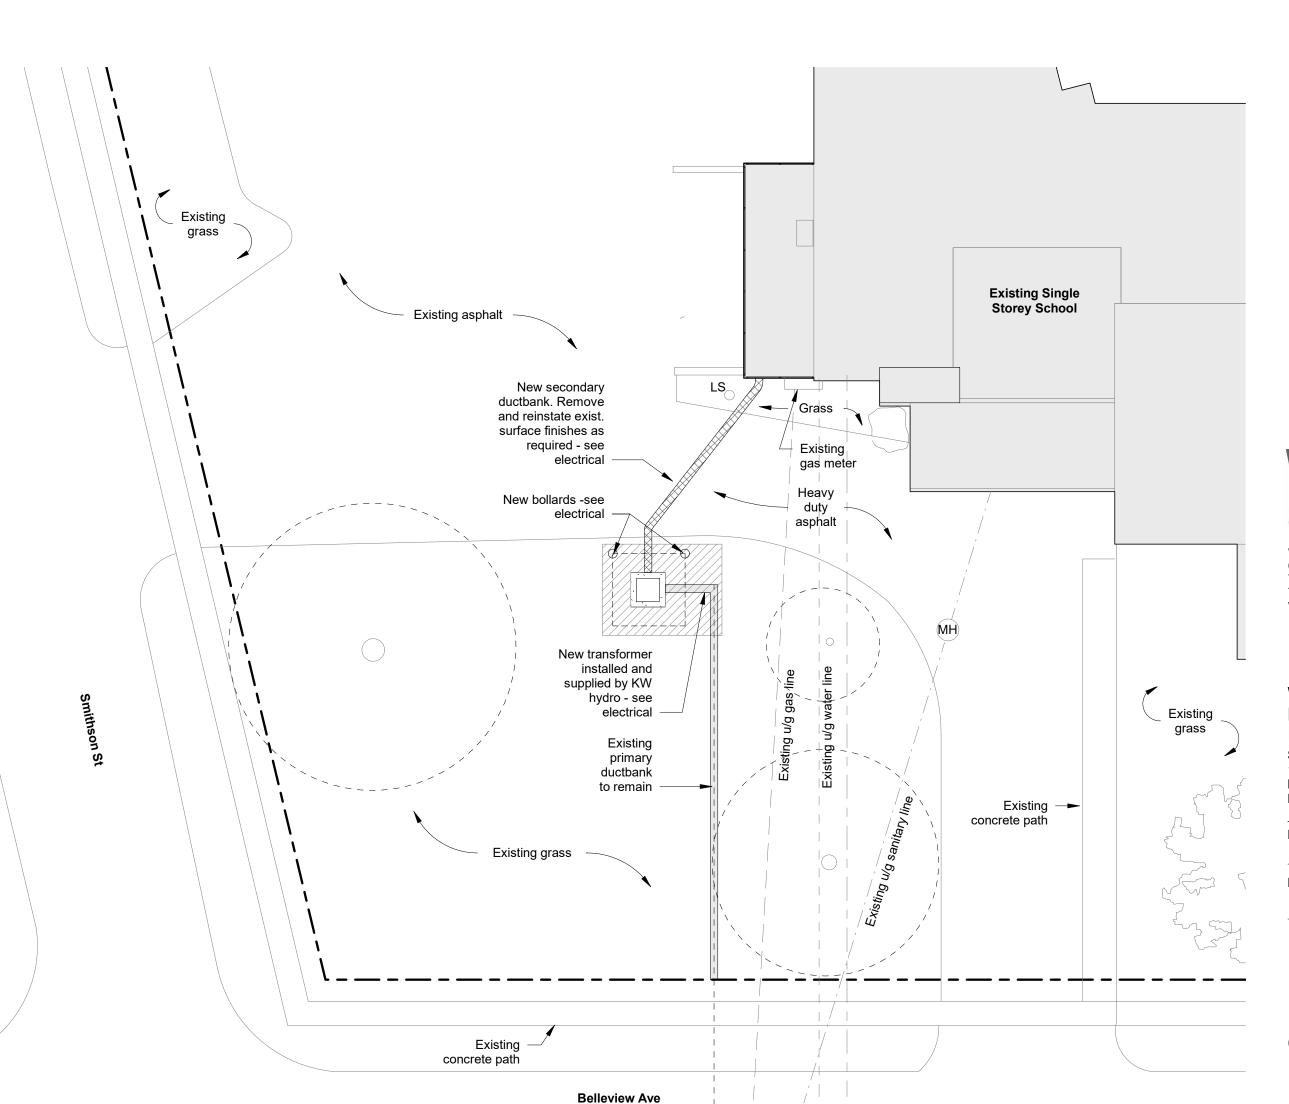

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Issued for Schematic Design 04 Dec 2020 26 Feb 2021 2 50% Review Issued for 90% Review 03 Dec 2021 Issued for Review 21 Jan 2022 04 Feb 2022 Issued for Permit Issued for Tender 15 Feb 2022

Life Safety Plan Legend

Travel Distance Max Allowable = 30m

Shaded area indicates scope of work

Not In Contract (N.I.C.)

— - — 0.45HR FRR




## WORKSHOP architecture


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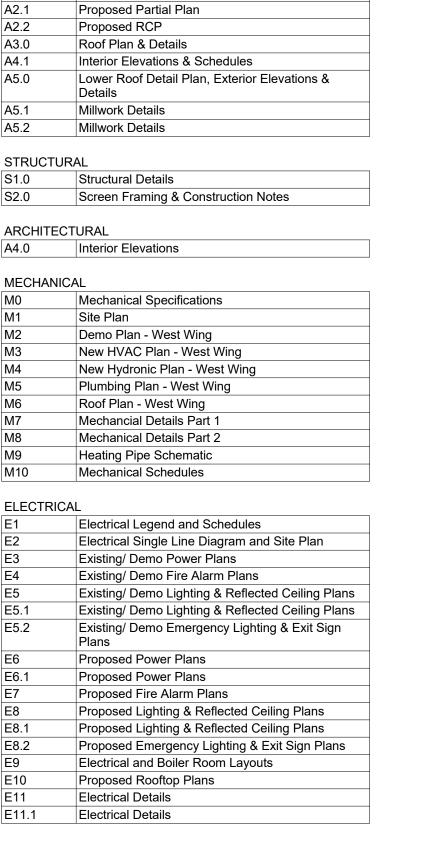
WRDSB Smithson Public School -**HVAC & Electrical Upgrades,** Interior Renovations Smithson Public School 150 Belleview Ave Kitchener ON N2B 1G7

PROJECT CODE SCALE: As indicated 20\_28 STATUS: DATE: Permit/Tender December 2021


**Cover Sheet** 



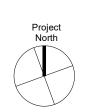


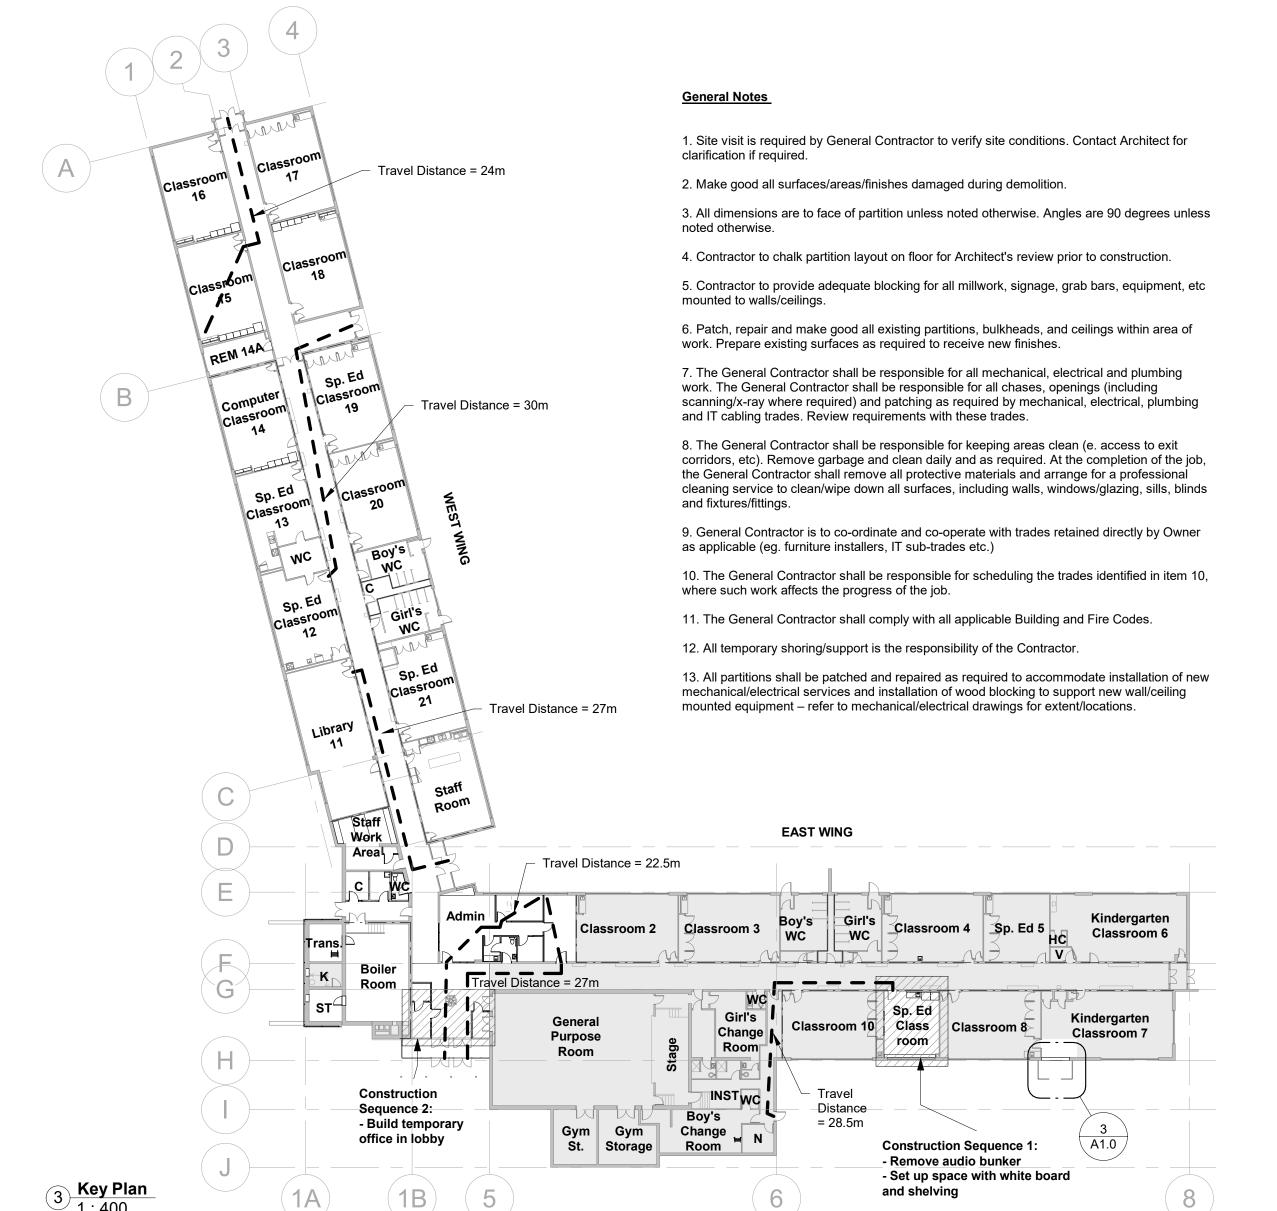

**Sheet Name** 

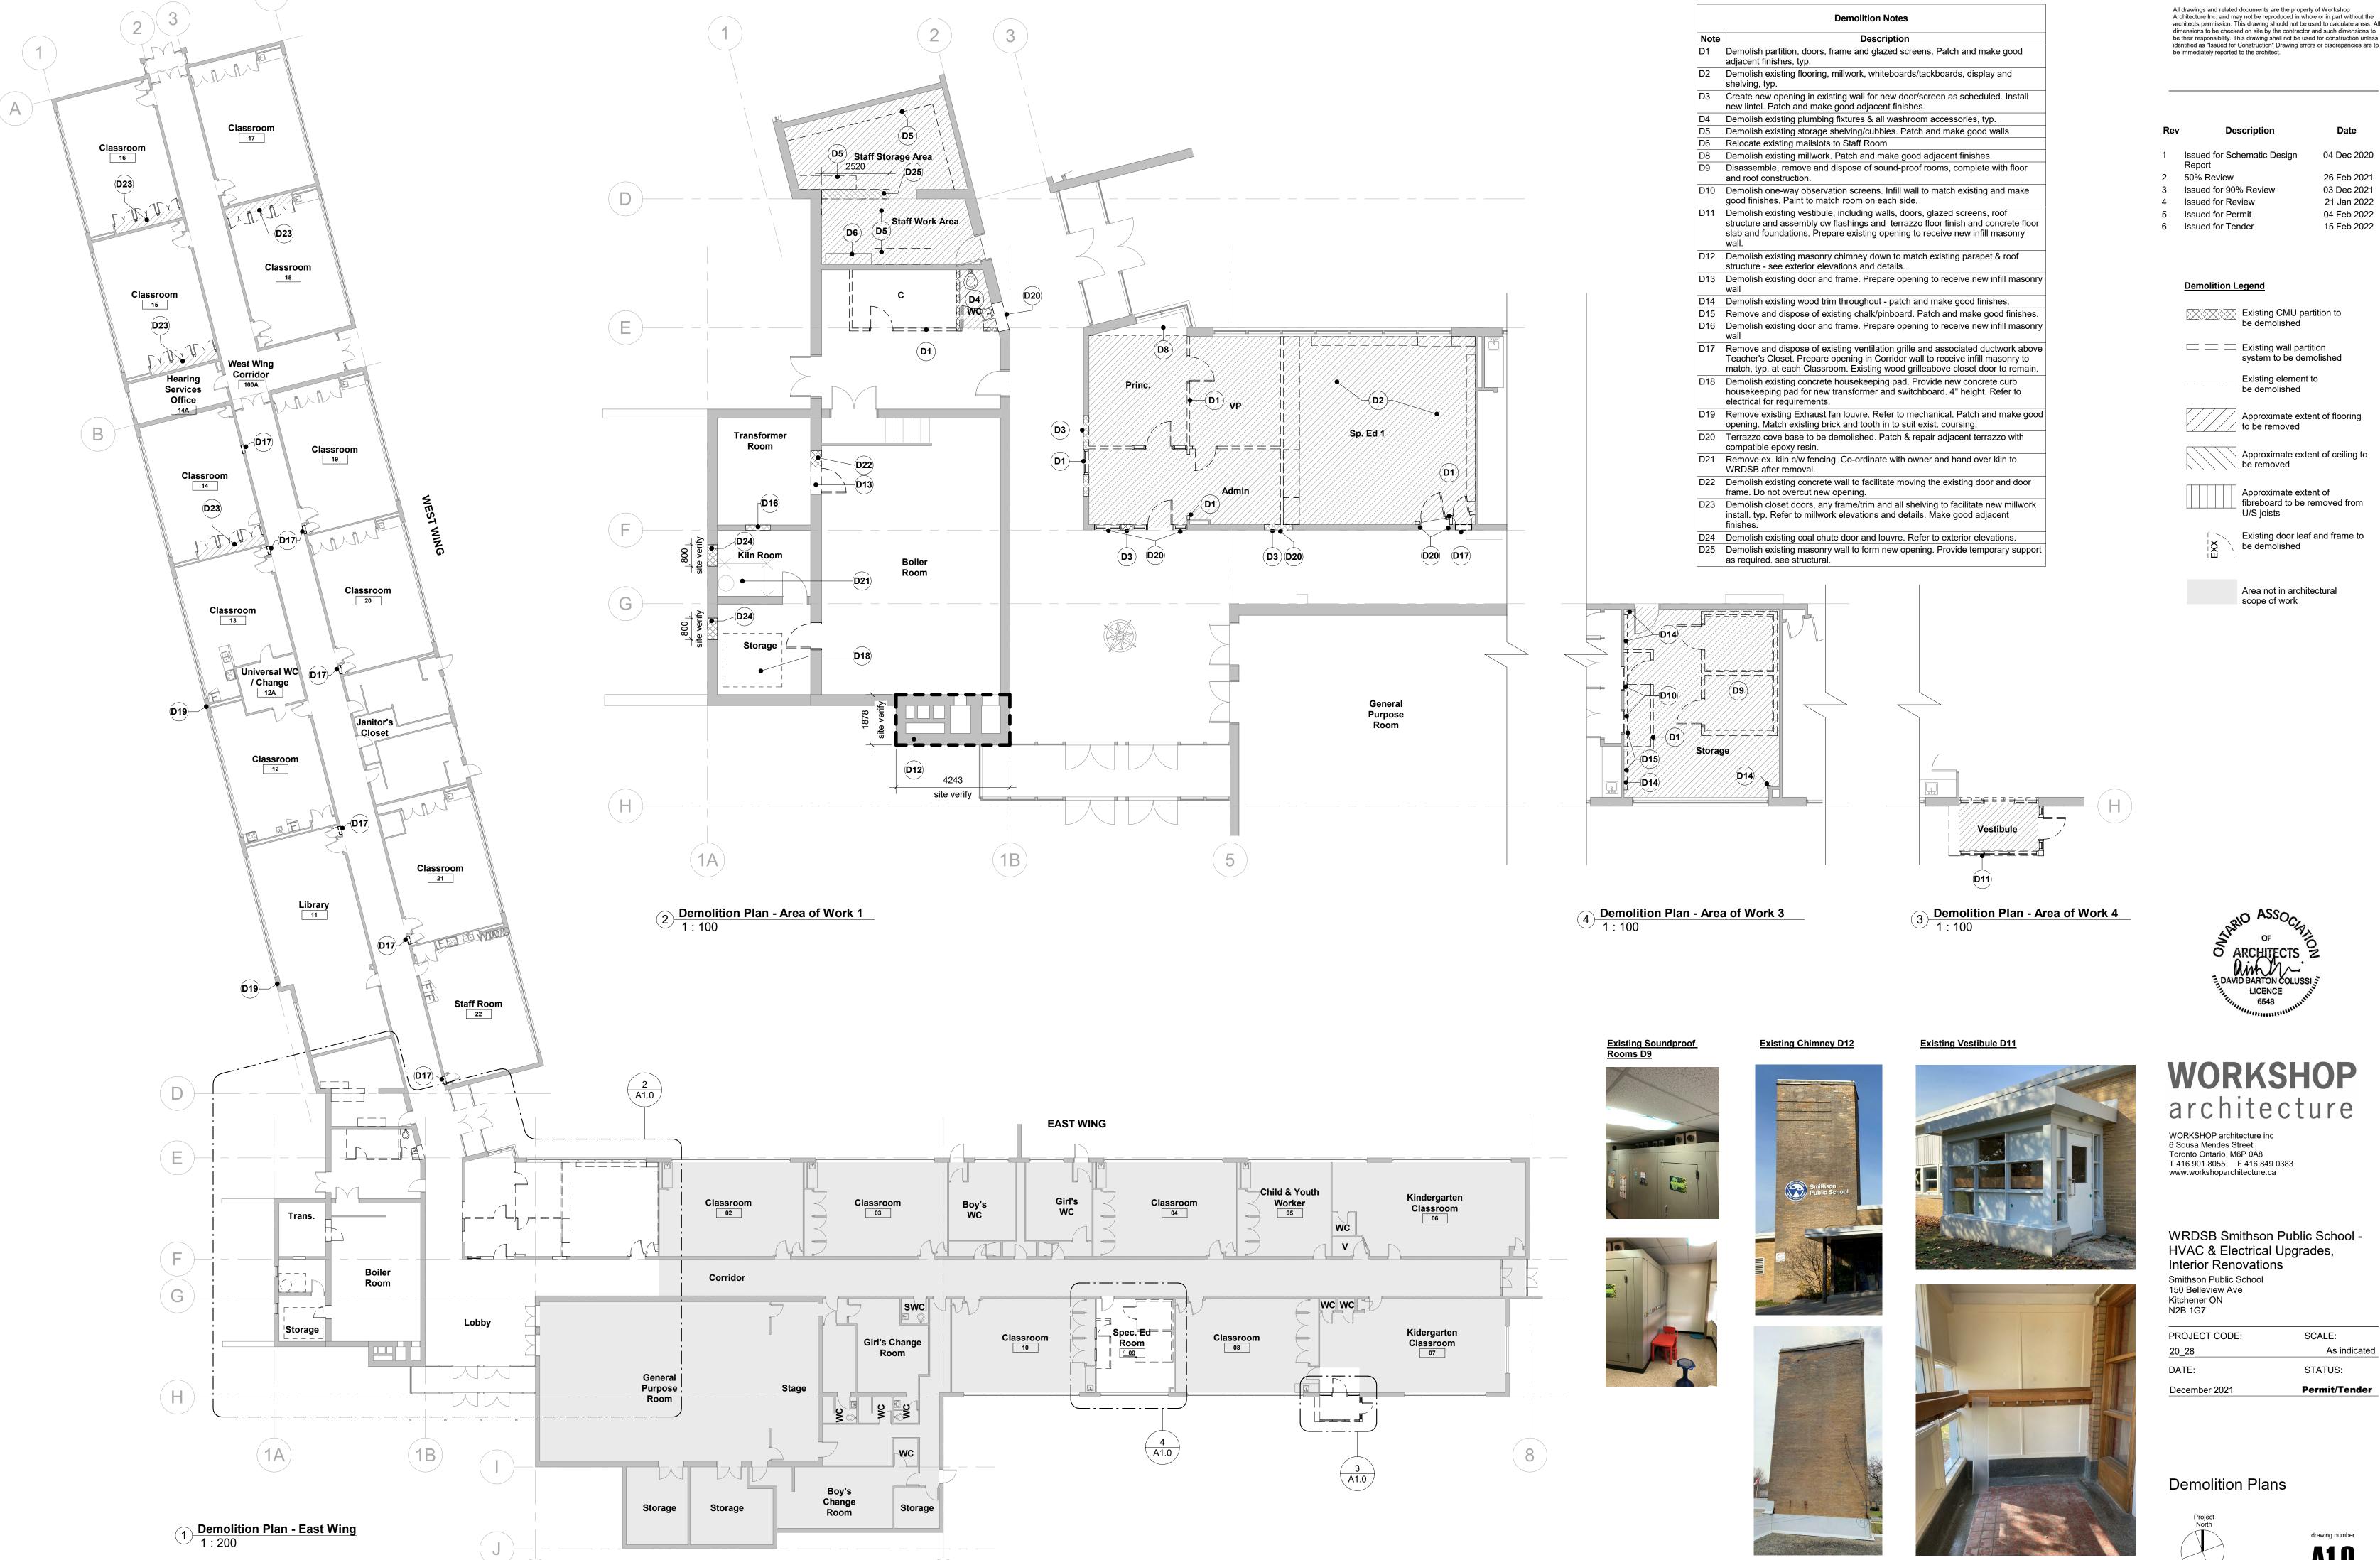


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Classroom

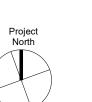Corridor

Universal WC / Change

Classroom

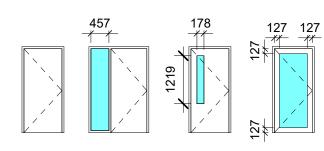16

Library

Classroom

(18)

Classroom

A2.2

Classroom

16

(19)

(A4.1)

MW14

**17**)

(A4.1)

Hearing

Services

Office

Classroom

MW12

(A4.1)

MW13

NOTE: All glazing to be tempered NOTE: All fire rated assemblies to be FRG NOTE: All HM frames to be 2" profile

Door A Door B Door C Door DD

_	<u> </u>		3456			
_	EQ	EQ	EQ	as scheduled		
,	1 /	<i>'</i>	1 /	1	1 ]	
	TGL	TGL	TGL	TGL		
	TGL	TGL	914 600		as scheduled	3000
	Glazed so	creen 1		Back painted w. GWB on off door operator to be cut to su	fice wiri	side to conce ing. Glass

3000

EQ

(TGL)

EQ

TGL

EQ

TGL

## **ASSEMBLY SCHEDULE**

## NOTES:

1. USE WATER RESISTANT DRYWALL IN ALL WET AREAS - REFER TO SPECIFICATION 09250

2. PROVIDE CONTINUOUS PLYWOOD BLOCKING ALL MILLWORK CABINETS, SUSPENDED ITEMS, TELEVISIONS ETC.

3. ALL INTERNAL PARTITIONS EXTEND TO U/S DECK ABOVE UNLESS NOTED OTHERWISE.

4. PROVIDE FIRE RESISTANCE RATINGS AS INDICATED ON DRAWINGS

## **INTERIOR PARTITIONS**

1 LAYER 16mm TYPE X GYPSUM WALLBOARD 92mm STEEL STUDS ACOUSTICAL FIRE BATT INSULATION 1 LAYER 16mm TYPE X GYPSUM WALLBOARD TO U/S OF DECK



	WA - Room Finish Schedule						
Room Name	Room No.	Wall Finish	Floor Finish	Base Finish	Ceiling Finish	Comments	
Library	11				EXIST/ACT		
Classroom	12				EXIST/ACT		
Universal WC / Change	12A				EXIST		
Classroom	13				EXIST/ACT		
Classroom	14				EXIST/ACT		
Hearing Services Office	14A				EXIST/ACT		
Classroom	15				EXIST/ACT		
Classroom	16				EXIST/ACT		
Classroom	17				EXIST/ACT		
Classroom	18				EXIST/ACT		
Classroom	19				EXIST/ACT		
Classroom	20				EXIST/ACT		
Classroom	21				EXIST/ACT		
Staff Room	22				EXIST/ACT		
Lobby	100				FAB		
West Wing Corridor	100A				ACT		
Reception/Admin	101	PT	POR/CPT	POR/RB	ACT		
Health Room	102	PT	POR	RB	ACT		
Principal's Office	103	PT	CPT	RB	ACT		
Meeting Room	104	PT	CPT	RB	ACT		
Office	105	PT	CPT	RB	ACT		
BF WC	106	CER	POR	-	ACT		
Staff WC	107	CER	POR	-	GWB		
Custodial Closet	108	PT	EXIST	RB	EXIST		
Custodial Office	109	PT	POR	POR	ACT		
Staff Work Room	110	PT	RES	RB	PT EXIST		
IT Closet	110A	PT	RES	RB	-		
Electrical Room	111						

	General Notes				
Note	Description				
1	Provide new concrete curb housekeeping pad. height 4". painted safety yellow. co-ordinate exact style with mechanical trade.				
2	Flush mount floor monument. Refer to electrical for requirements.				
3	New convector unit. Refer to mechanical for requirements. Make good all floor and wall finishes after installation.				
4	Infill exterior wall to match existing brick.				
5	Provide top soil and sod to match existing.				
6	Exterior galvanized metal screen - see elevations. Refer to structural.				
7	Infill exterior wall opening to match existing concrete block and brick assembly.				
8	Infill existing door opening in conrete wall with block up to to jamb of new door opening. Provide new door frame. Remove existing door, store and reuse in new frame.				
9	New forced floor heater. Refer to mechanical for requirements. Make good all floor and wall finishes after installation.				
10	For new beam and lintel type and section, see structural .				
11	Transition between POR floor finish and CPT floor finish in the offices and meeting room. Provide aluminum transition, refer to specification.				
12	Provide floor drain, see mechanical.				
13	Provide new mop sink c/w side mount faucet on new wall, see mechanical.				
14	Provide wall mounted TV. Coordinate exact location and mounting height with WRDSB.				
15	Provide wall mounted TV mounted on the corridor wall, to the right of white board, on open wall space. Elevation height - Match top of White boards/doors.				
16	Provide wall mounted TV mounted below the current projector screen(to be removed). Two millwork book cases to be relocated to left side to replace unit with Tree.				
17	Provide wall mounted TV. Coordinate exact location and mounting height with WRDSB. Relocate existing white board. Coordinate with WRDSB.				
18	Provide wall mounted TV. Coordinate exact location and mounting height with WRDSB. Remove white boards or tack boards and hand over to WRDSB.				
19	Provide new white board. New white boards are part of cash allowance for supply. Refer to specification and coordinate with WRDSB.				
20	Provide wall mounted TV. Coordinate exact location and mounting height with WRDSB. Modify & add white boards to fill all chalk board area along front of room. HDMI/Data drop to be in the corner to the left. This room has several wall mounted speakers as part of an older soundfield system. Contractor to remove and hand over to the school.				
21	Provide temporary administration offices during constraction and prior to Demo Phase. Windows, doors, door frame and hardware will be provided from WRDSB. Coordinate exact location and duration at construction start up meeting. All partitions are PW-1 unconnected height of 10'-0" with PT finish and rubber baseboards. No ceiling. Temporary Office install is part of Cash Allowance.				
22	Enlarge existing opening in concrete roof slab to suit new roof access hatch - see structural.				

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04 Dec 2020 1 Issued for Schematic Design 2 50% Review 26 Feb 2021 Issued for 90% Review 03 Dec 2021 21 Jan 2022 Issued for Review 04 Feb 2022 Issued for Permit 15 Feb 2022 6 Issued for Tender

Acoustic Ceiling Tile

## Materials Legend

ALUM Aluminum CER Ceramic Tile CPT Carpet EPO Epoxy Paint EXIST Existing EXP Exposed FAB Fabric Faced Acoustic Core Composite Ceiling Panel FGL Frosted Glass F1 Glazing Surface Film GWB Gypsum Wallboard MIR MDF MDF Baseboard PLY Fire Rated Plywood POR Porcelain Tile PLAM Plastic Laminate PT Paint Finish QTZ Quartz RB Rubber Base RES Resilient Sheet Flooring SO SS ST TGL Solid Polymer Fabrications Stainless Steel Natural Stone Tempered Glass WB Dry Erase Whiteboard

Solid Wood


Wood Stain

WD

Existing partition to remain

New partition as scheduled

## Symbols Legend

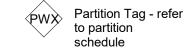


SX Glazed Screen tag - refer to

schedule New Door tag - refer to schedule

MW1 Millwork Tag

GWB
1' - 0"
Ceiling Material
Height above
Finished Floor

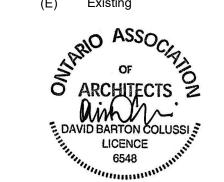

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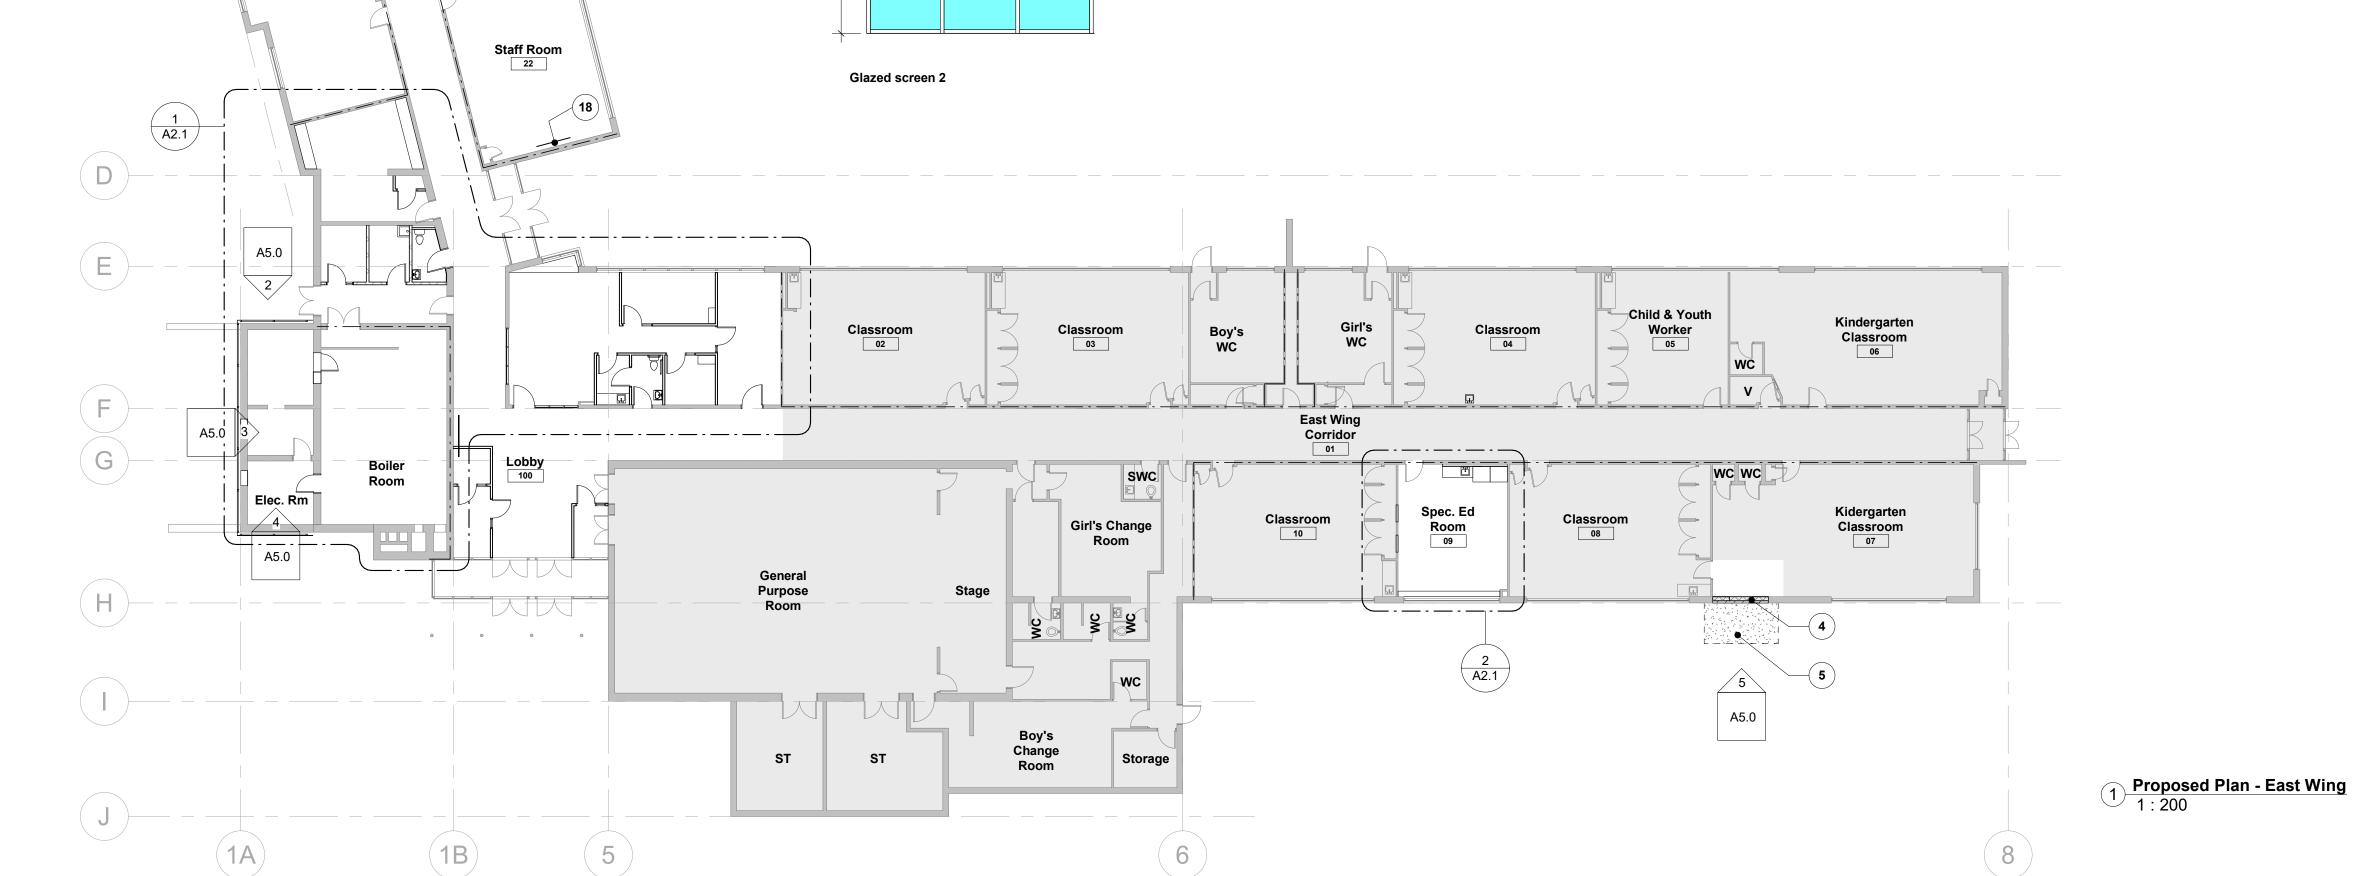
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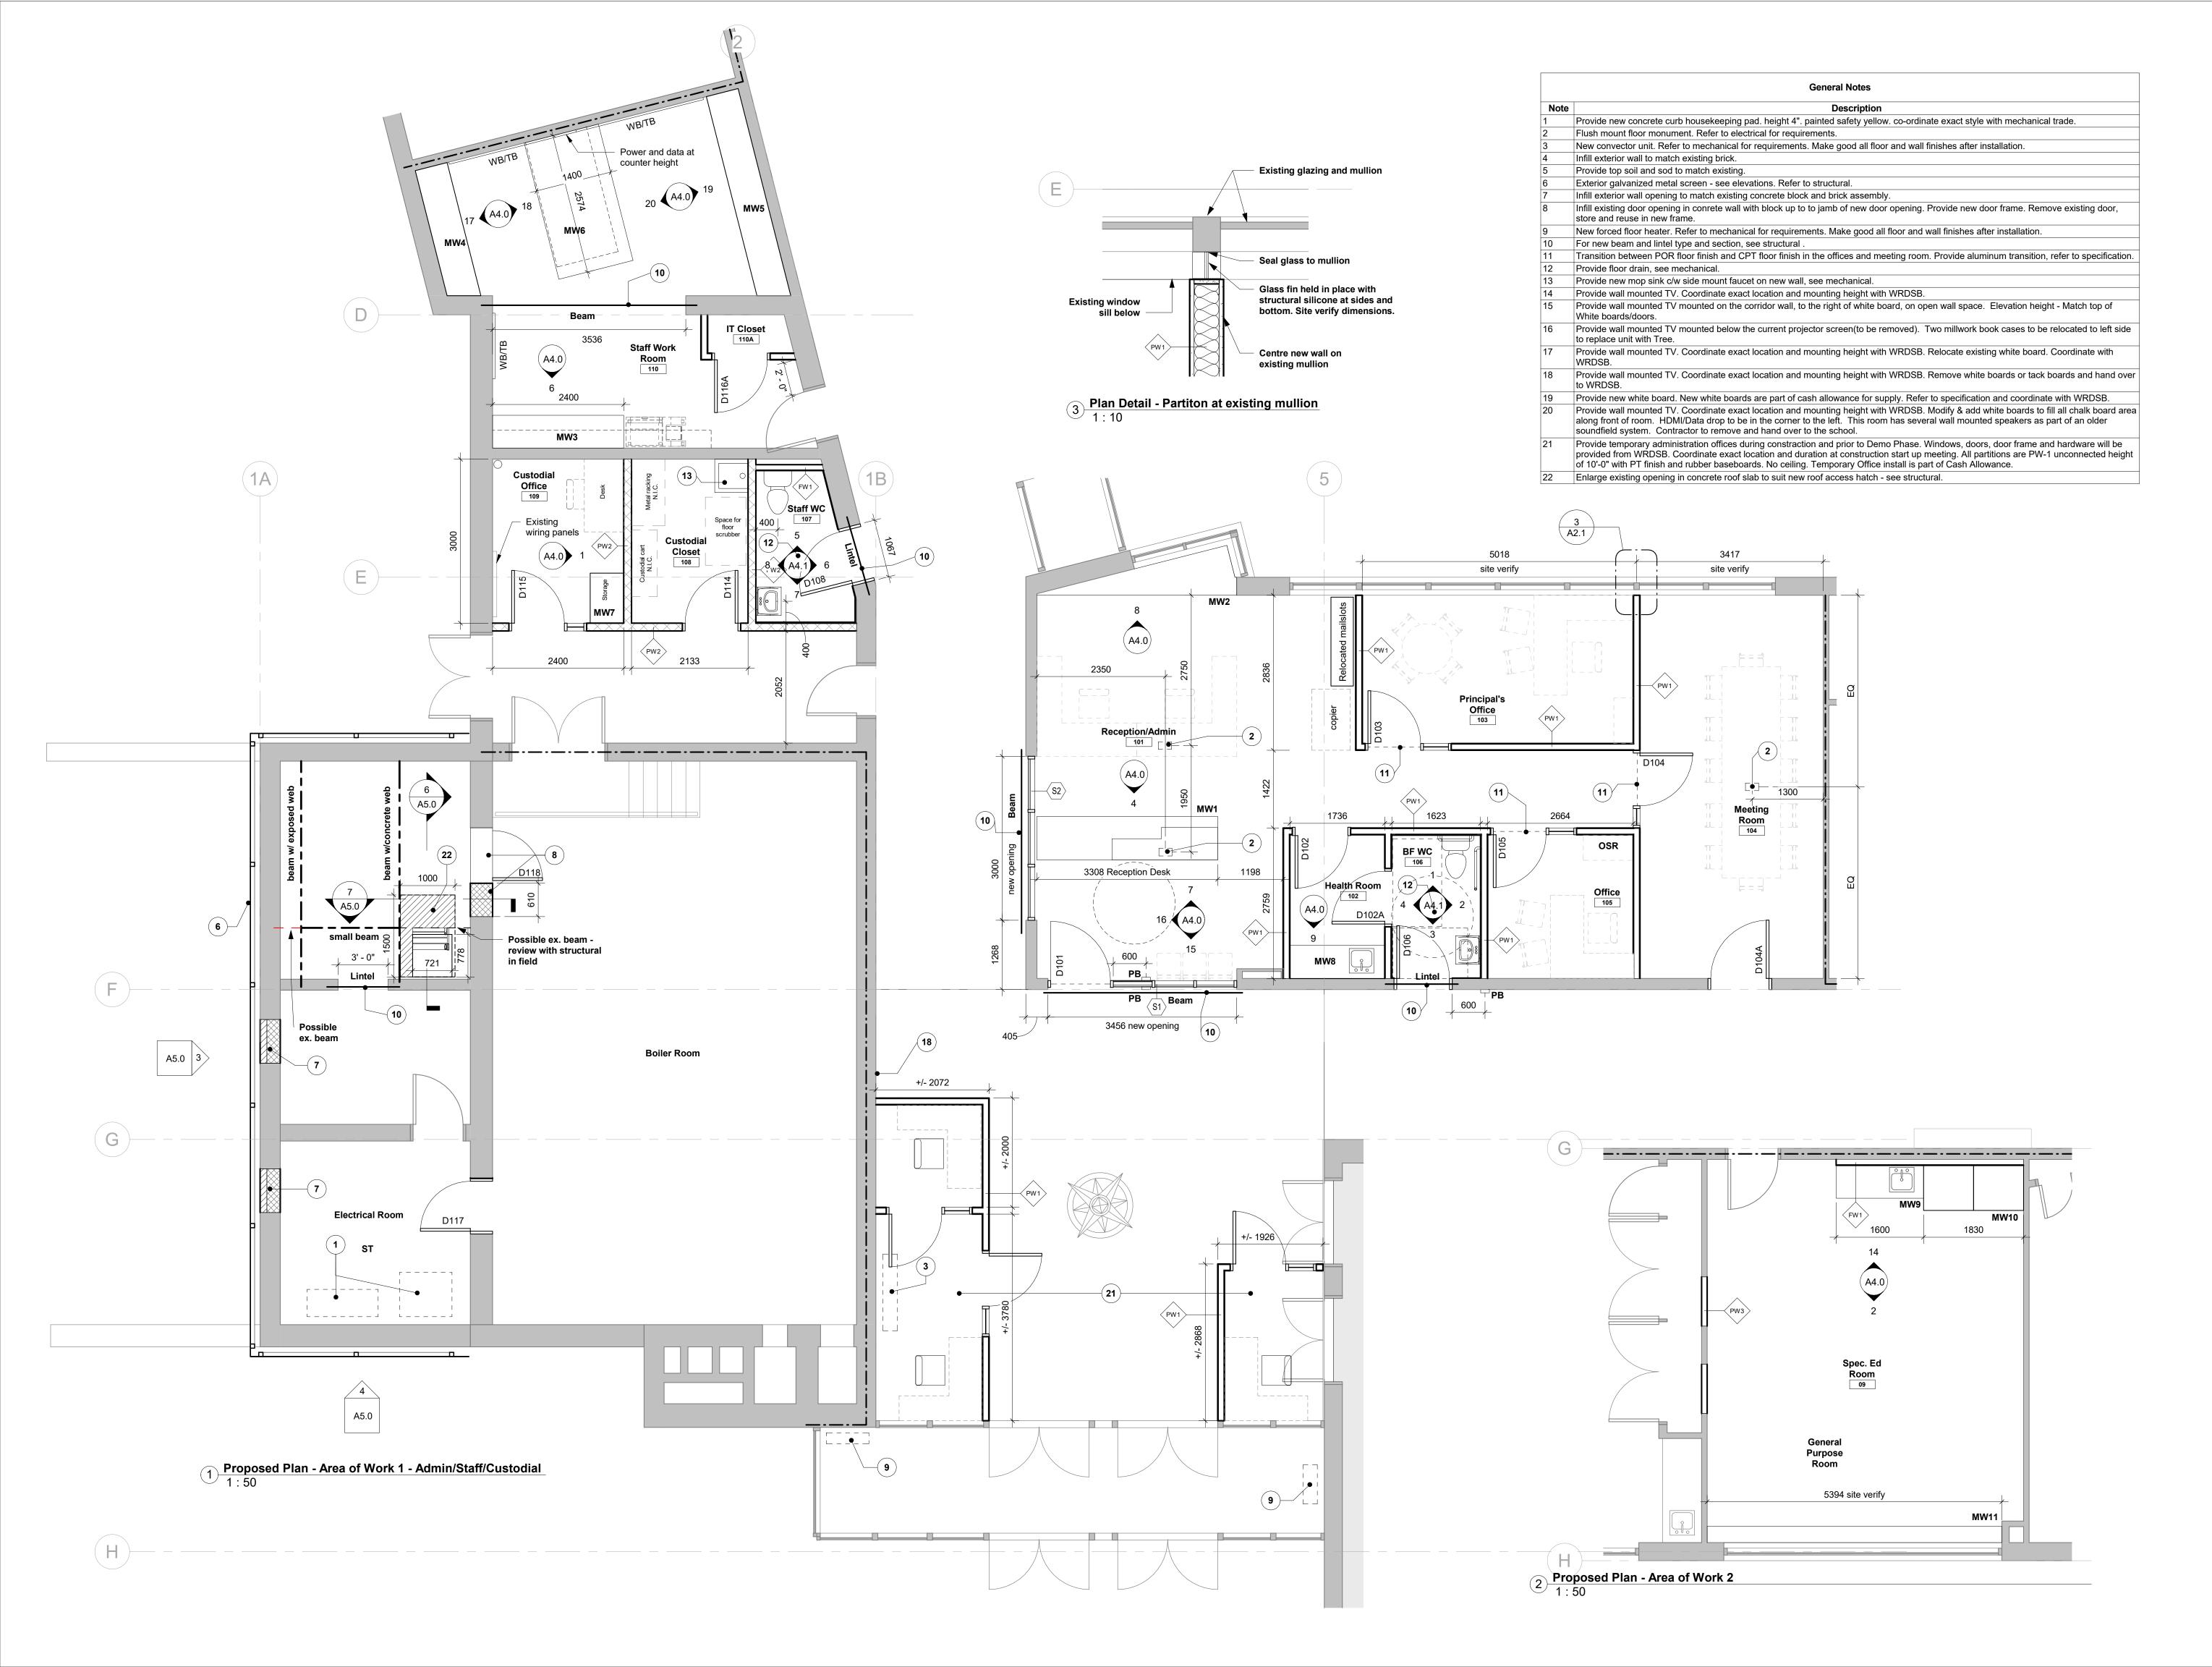
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PROJECT CODE:	SCALE:

Proposed Plans & Schedules



**A2.0** 





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lev Description Date

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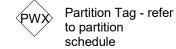
3 Issued for 90% Review 03 Dec 2021 4 Issued for Review 21 Jan 2022 5 Issued for Permit 04 Feb 2022 6 Issued for Tender 15 Feb 2022

<u>Legend</u>

Existing partition to remain

New partition as scheduled

## Symbols Legend



schedule

Glazed Screen tag - refer to

tag - refer to schedule

New Door tag - refer to schedule

MW1 Millwork Tag

Finished Floor

GWB
1' - 0"

Ceiling Material
Height above

(E) Existir



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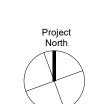
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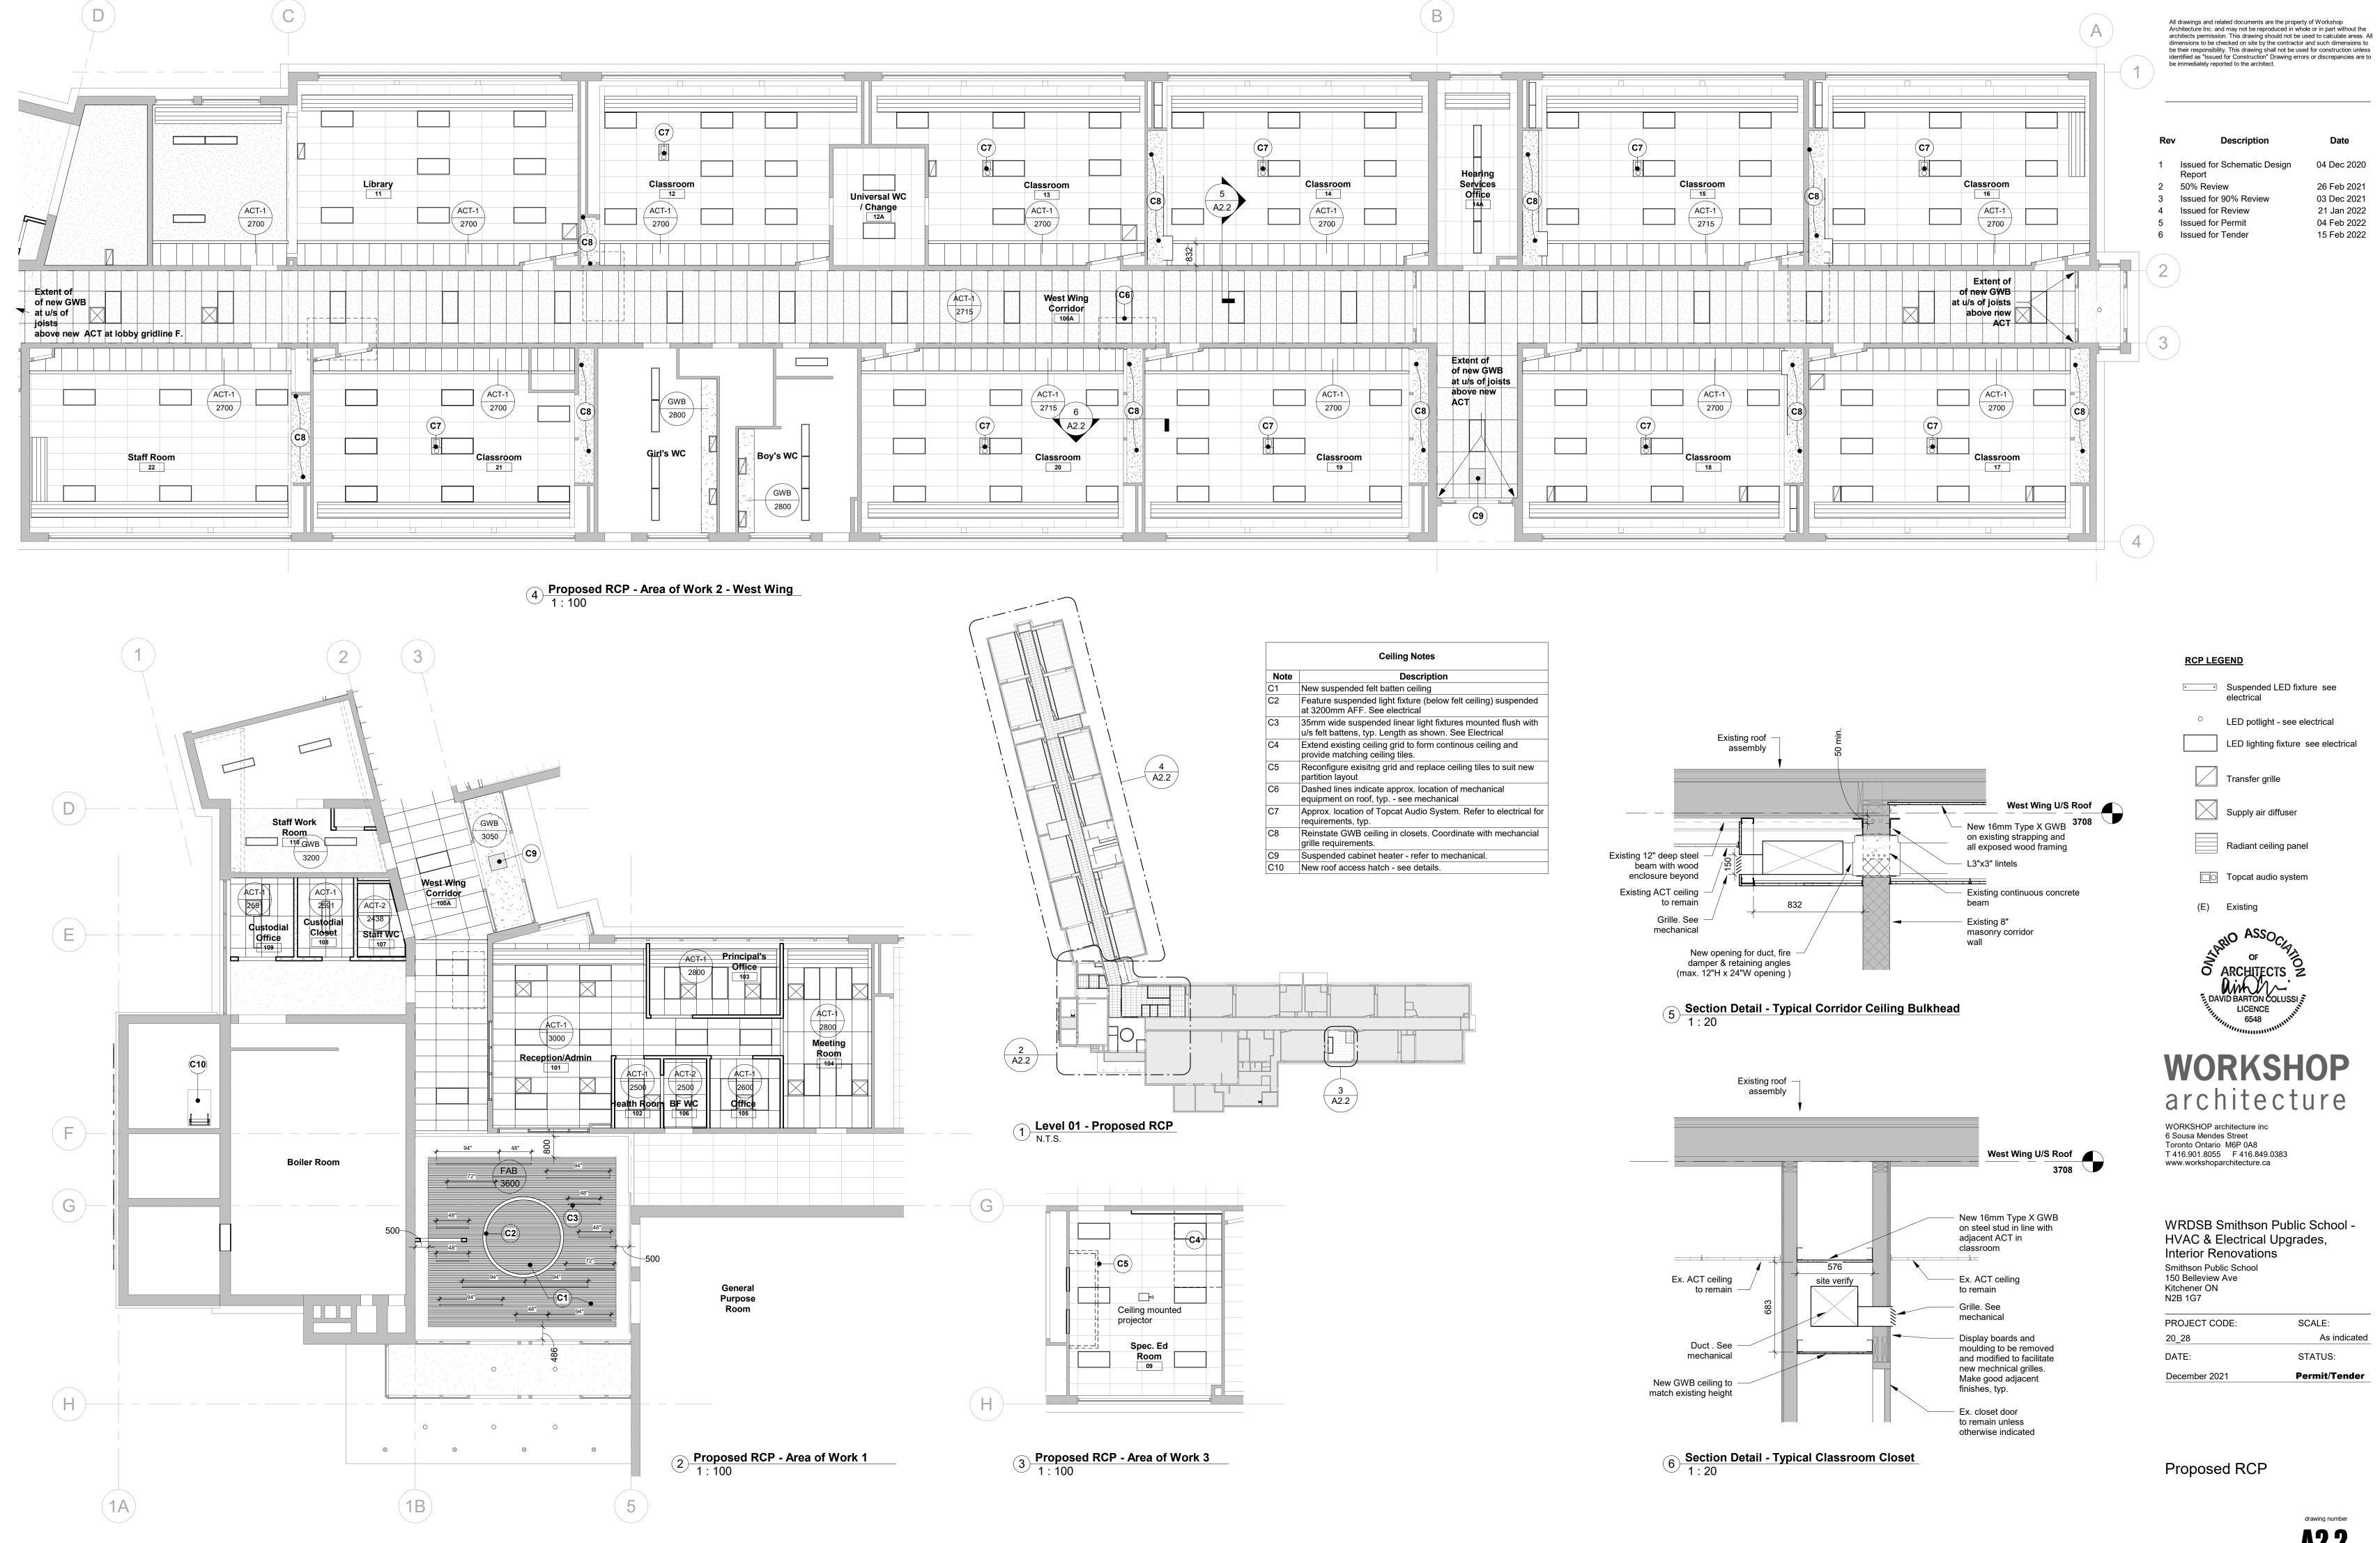
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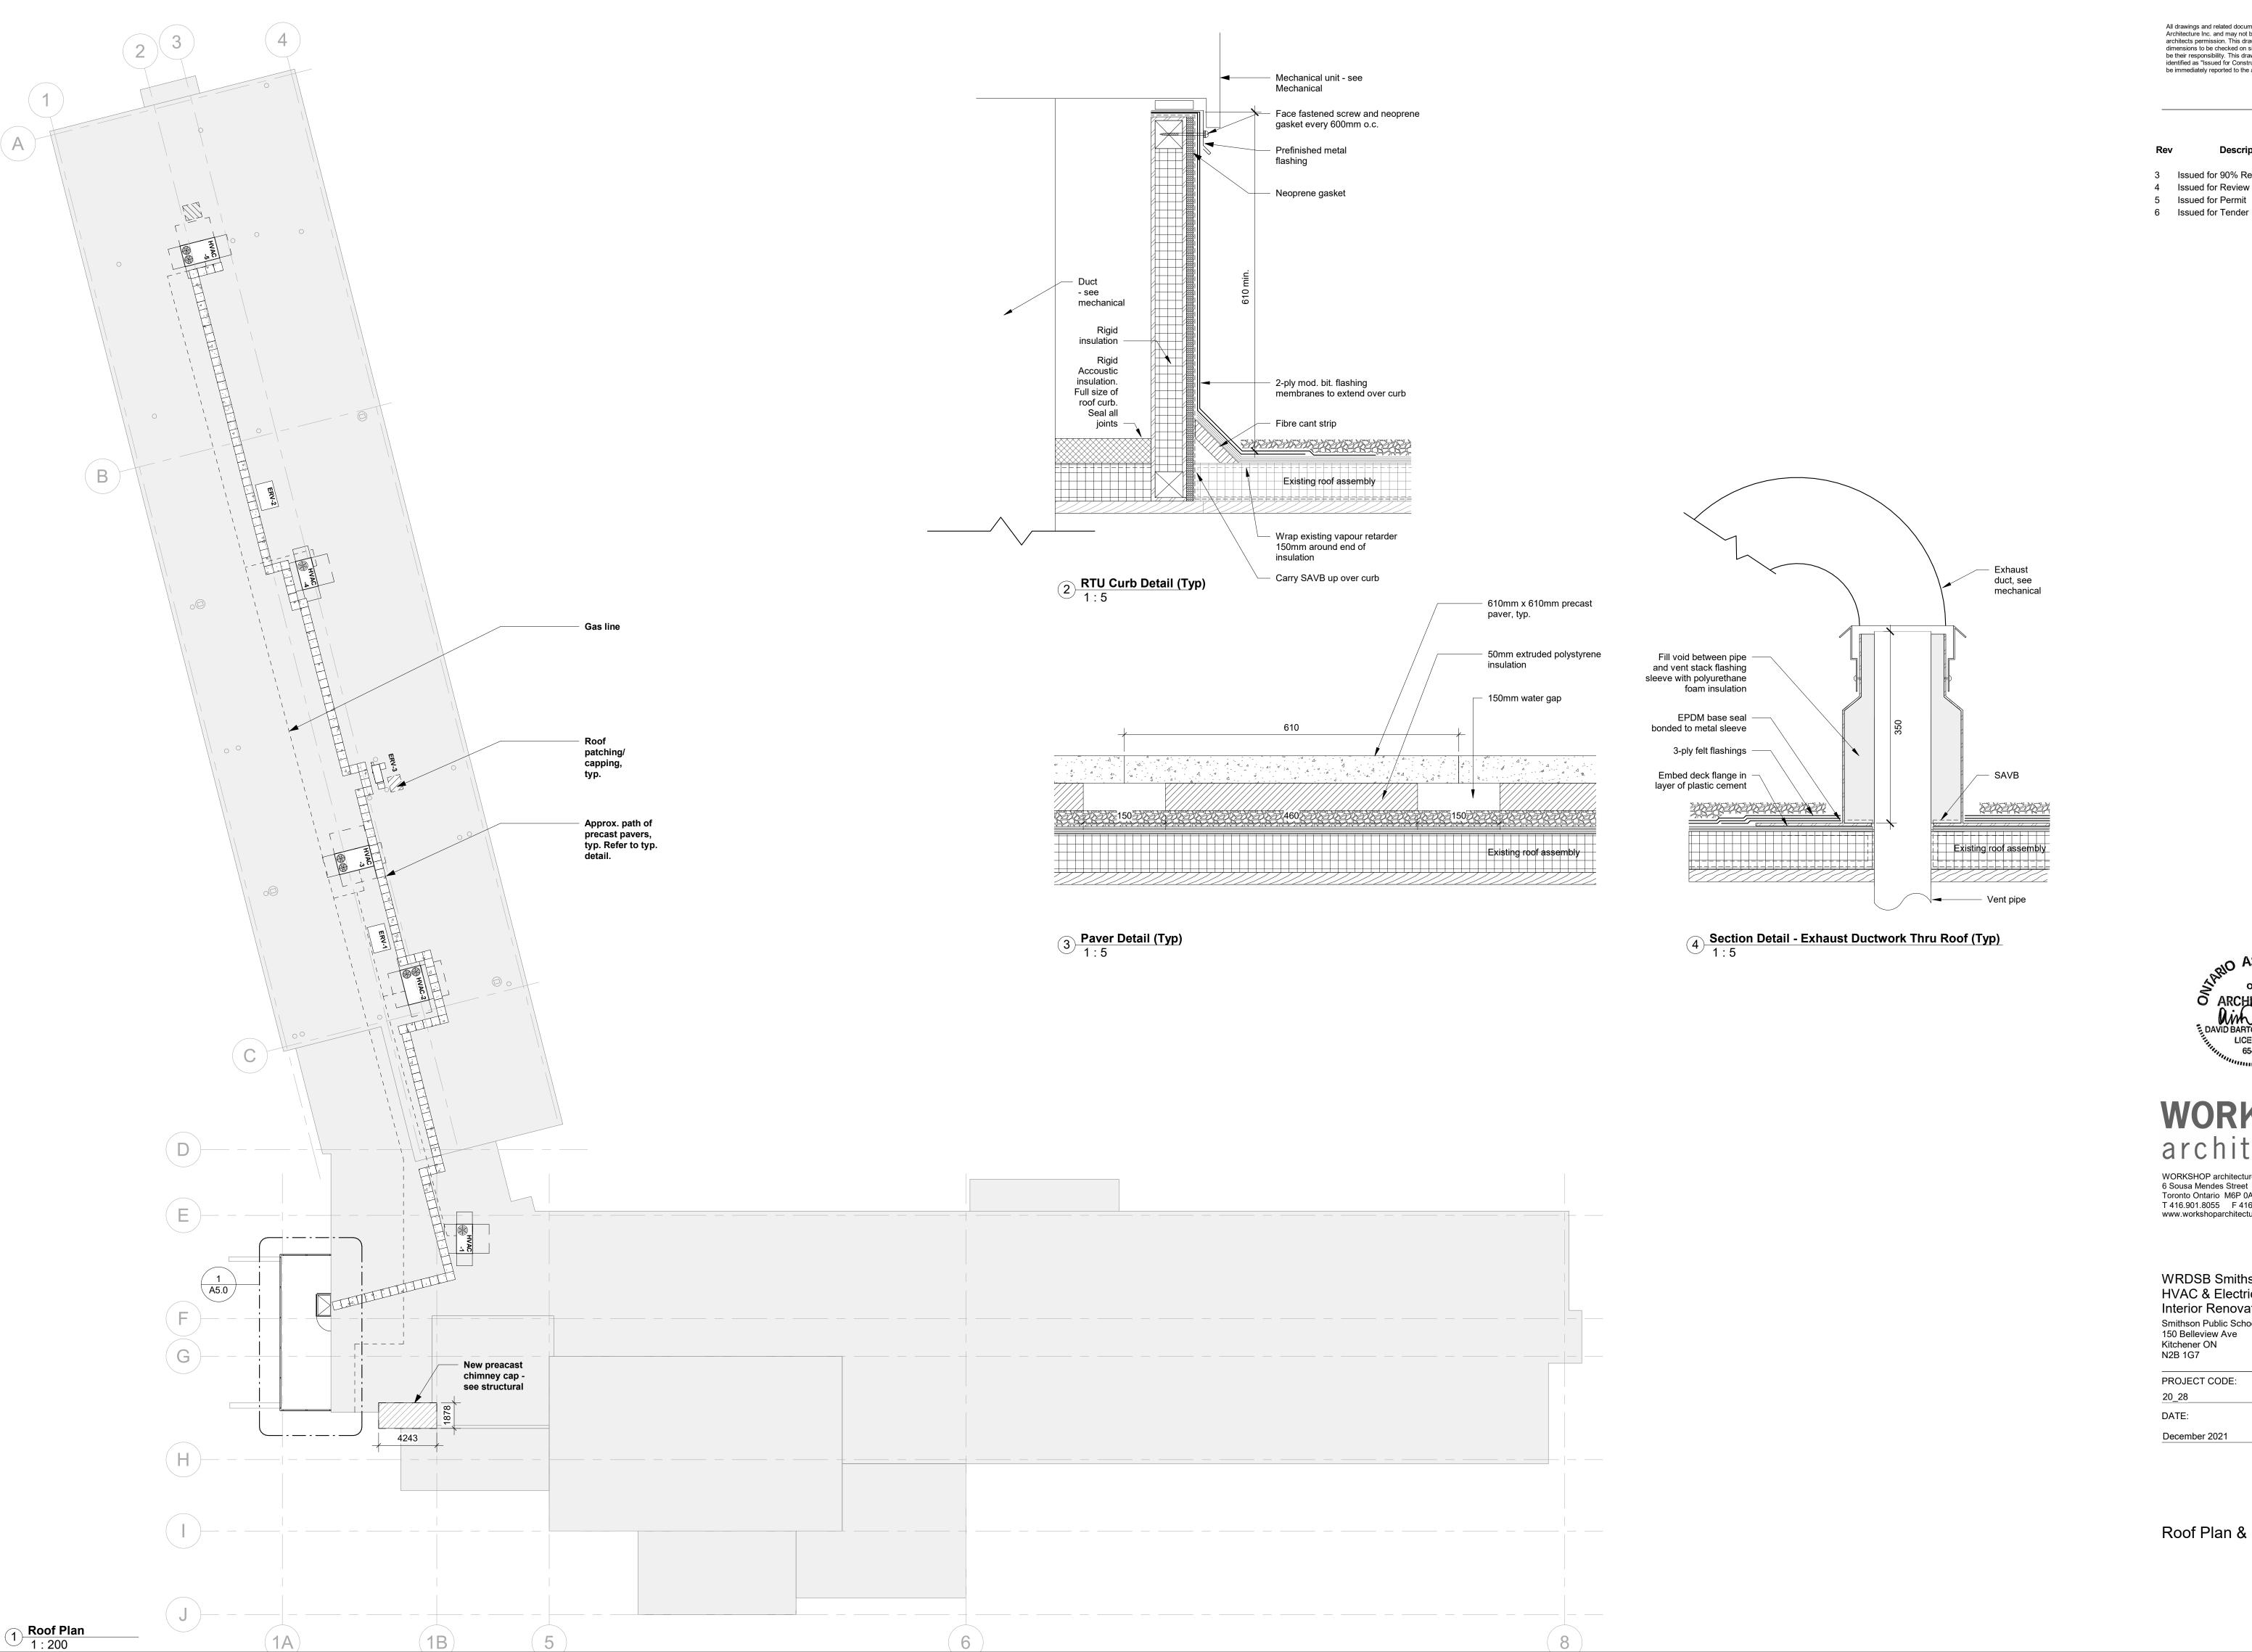
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Proposed Partial Plan









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04 Feb 2022

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3 Issued for 90% Review 4 Issued for Review Issued for Permit


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Roof Plan & Details



SCALE:

STATUS:

Permit/Tender

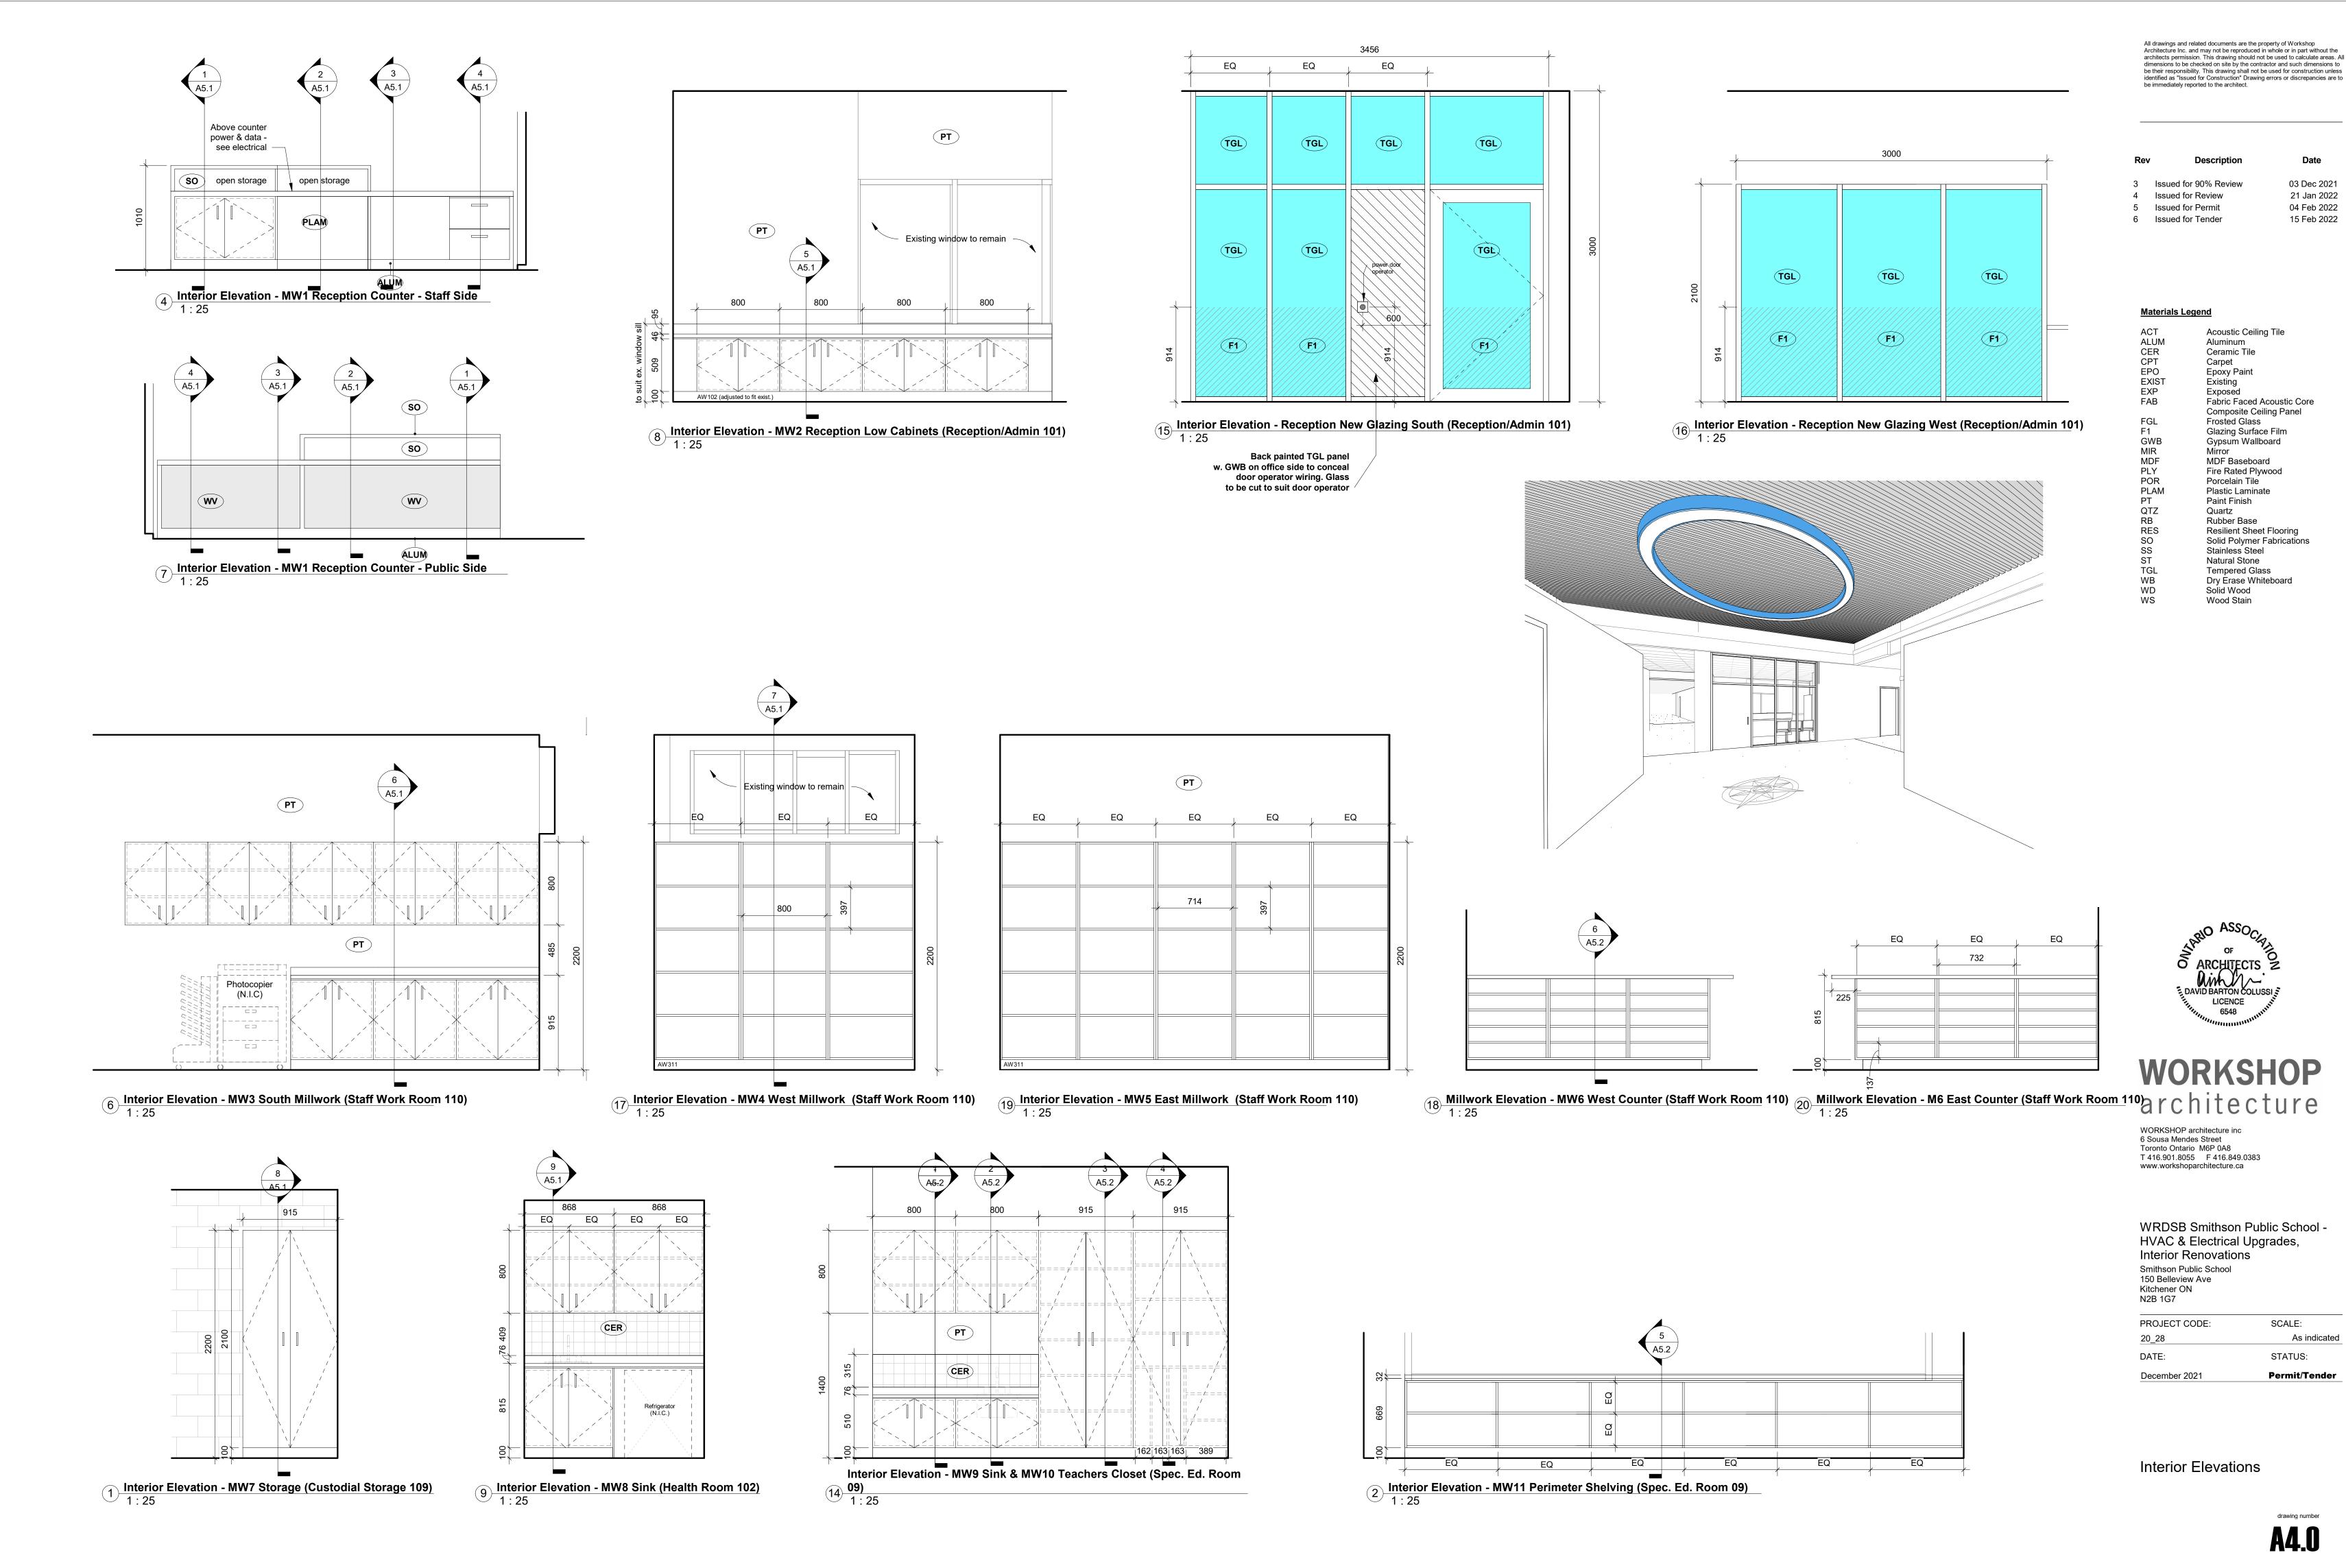
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04 Feb 2022

15 Feb 2022

Materials Legend

5 Issued for Permit

6 Issued for Tender

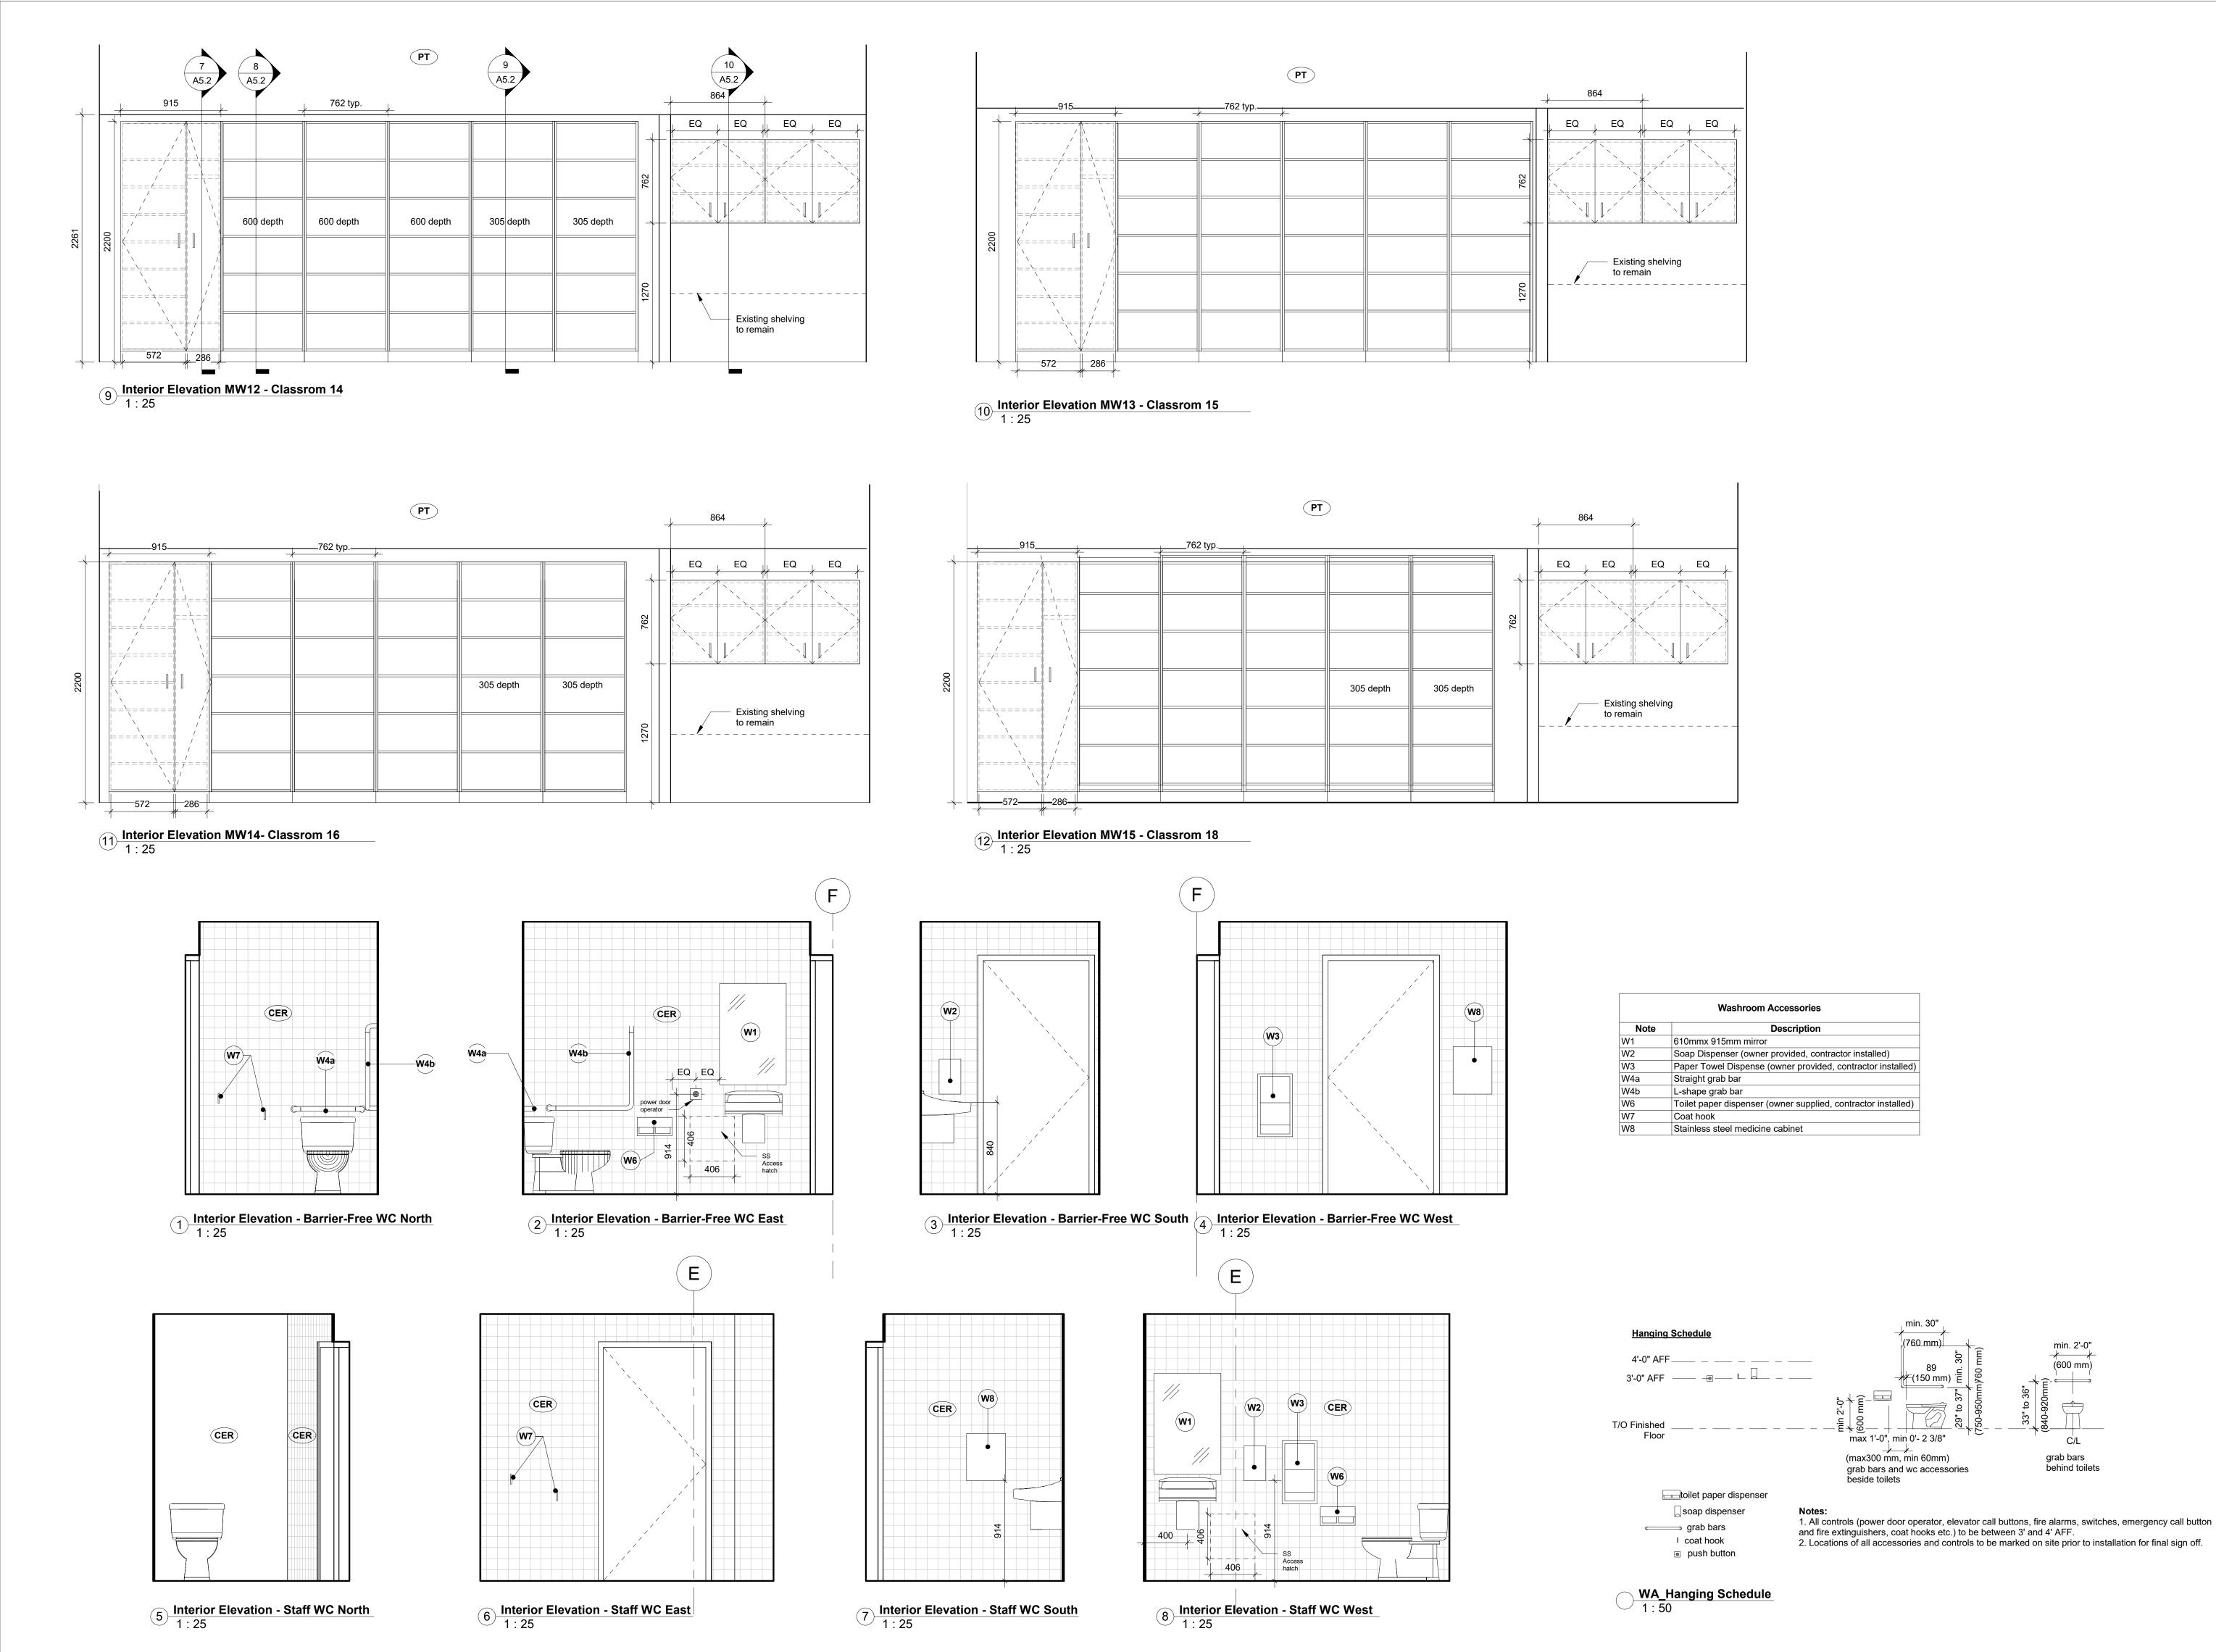ALUM Aluminum CER CPT Ceramic Tile Carpet EPO Epoxy Paint **EXIST** Existing Exposed FAB Fabric Faced Acoustic Core Composite Ceiling Panel Frosted Glass F1 GWB Glazing Surface Film Gypsum Wallboard MIR MDF MDF Baseboard PLY POR Fire Rated Plywood Porcelain Tile PLAM PT QTZ RB RES Plastic Laminate Paint Finish Quartz Rubber Base Resilient Sheet Flooring Solid Polymer Fabrications Stainless Steel Natural Stone Tempered Glass Dry Erase Whiteboard Solid Wood

Wood Stain



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min. 2'-0" (600 mm)

grab bars

behind toilets

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DATE:	STATUS:
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Interior Elevations & Schedules




8 Section Detail - Upper Roof Ladder 1: 25


3572 Infil opening after removed vestibule to match existing wall assembly. Tooth in new brick to match existing coursing. East Wing Floor Level

(1A)

5 Partial Elevation - Infill Wall at Demolished Vestibule 1:50

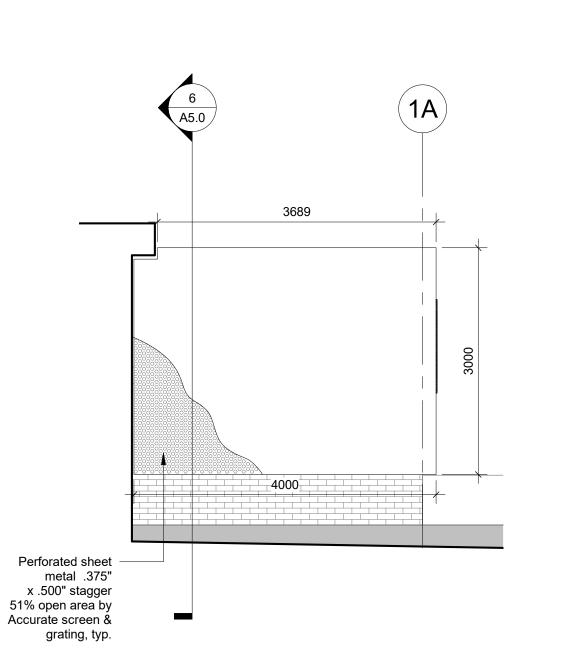


2 Partial North Elevation - Lower Roof Screen 1:50

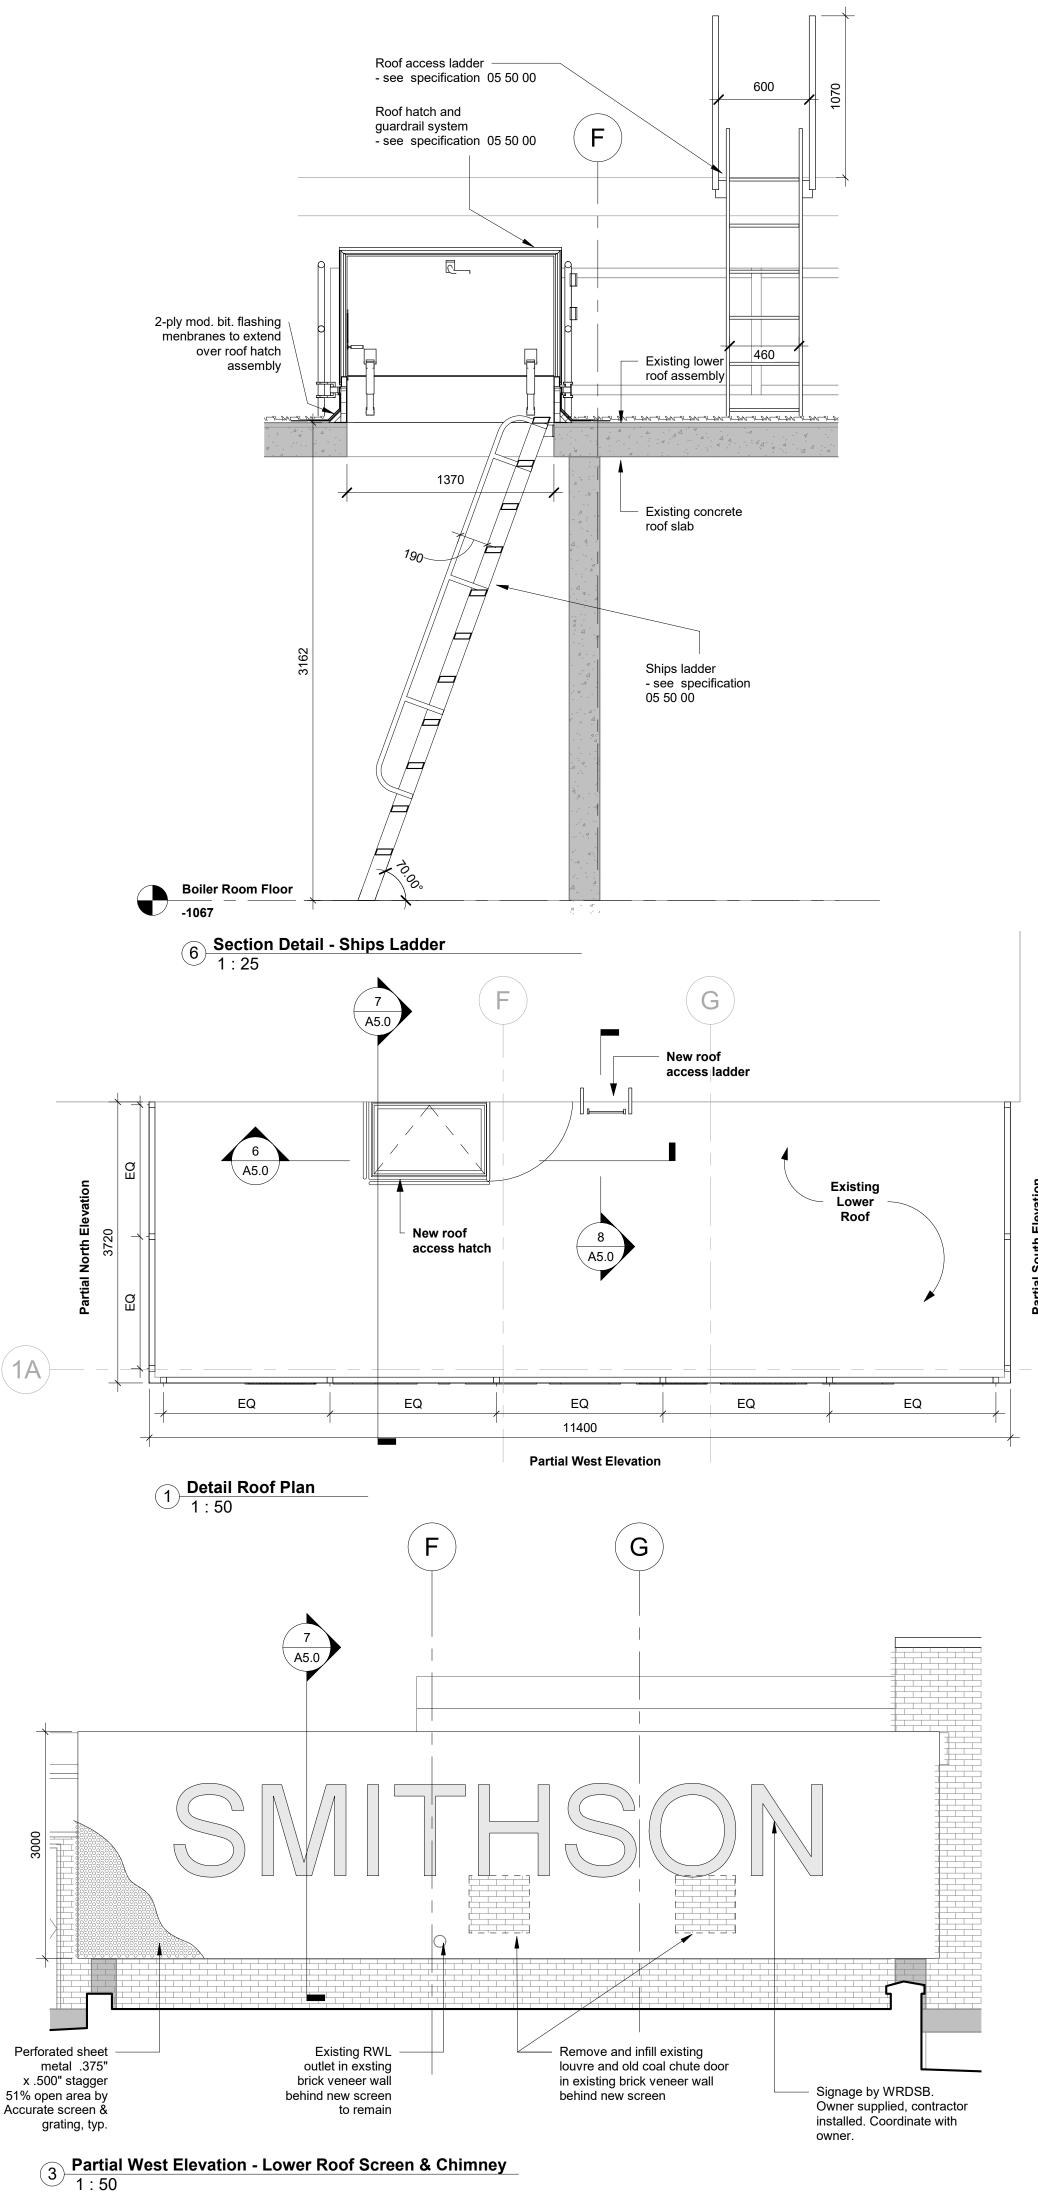

Existing roof Roof hatch and guardrail system
- see specification 05 50 assembly East Wing U/S Roof
3572 New Screen - see 2-ply mod. bit. flashing structural menbranes to extend over roof hatch assembly - Existing roof lower assembly **Bolted connection**  see structural Existing concrete roof slab Existing brick veneer **Bolted connection**  see structural Existing brick Ships ladder - see specification 05 50 00 Boiler Room Floor -1067

7 Section Detail - Ships Ladder and Lower Roof Screen 1:25

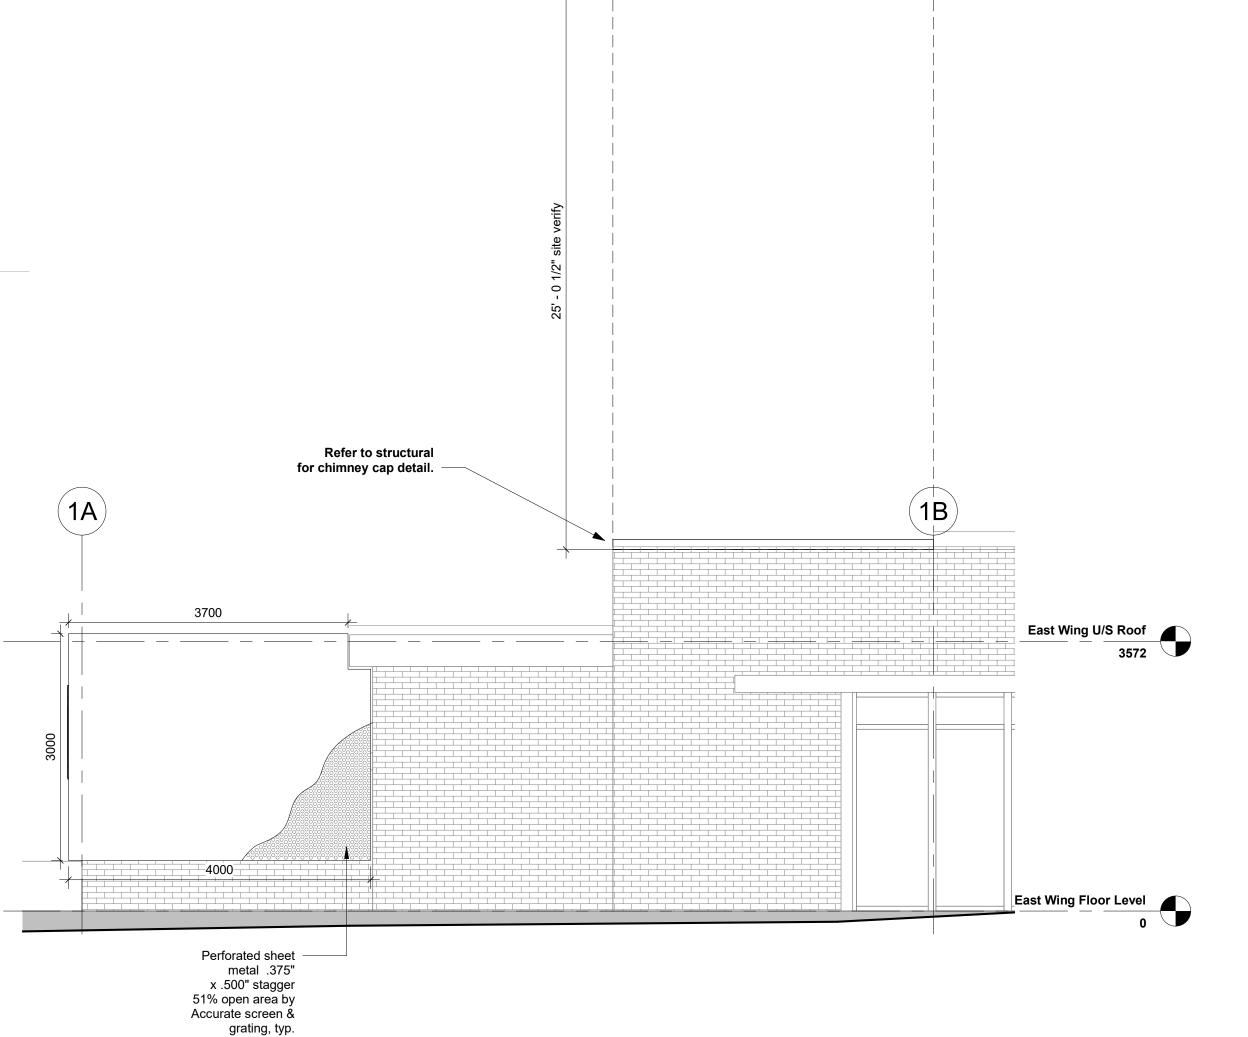

\_ \_\_\_\_\_

Exterior Elevations & Details 4 Partial South Elevation - Lower Roof & Chimney 1:50

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Lower Roof Detail Plan,



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Acoustic Ceiling Tile

## Materials Legend

ALUM Aluminum CER Ceramic Tile CPT Carpet EPO Epoxy Paint Existing **EXIST** EXP Exposed FAB Fabric Faced Acoustic Core Composite Ceiling Panel FGL Frosted Glass F1 GWB Glazing Surface Film Gypsum Wallboard MIR MDF MDF Baseboard PLY POR Fire Rated Plywood Porcelain Tile PLAM PT Plastic Laminate Paint Finish QTZ Quartz RB RES SO SS ST Rubber Base

Resilient Sheet Flooring Solid Polymer Fabrications

Stainless Steel Natural Stone

Tempered Glass

Solid Wood Wood Stain

Dry Erase Whiteboard

Millwork Hardware Legend

TGL

WB

WD

Adjustable shelf pins/ferrules: Richelieu No 2291/2292-180, nickel finish at 2" centres

Bumpers (2 each per door): Richelieu 3M (Peel &Stick)

Cabinet/Drawer Pulls: Richelieu Functional Steel Pull #33205195, Brushed Nickel

Concealed hinges: Blum Blumotion 110

Concealed shelf support brackets: Richelieu 1621712G

Soft close mechanism at all drawers:

Richelieu BP97309910

Steel Roller Glides at 350mm drawers: Accuride #3641 Full Extension

> Provide cam locks at all cabinets and LICENCE

**WORKSHOP** architecture


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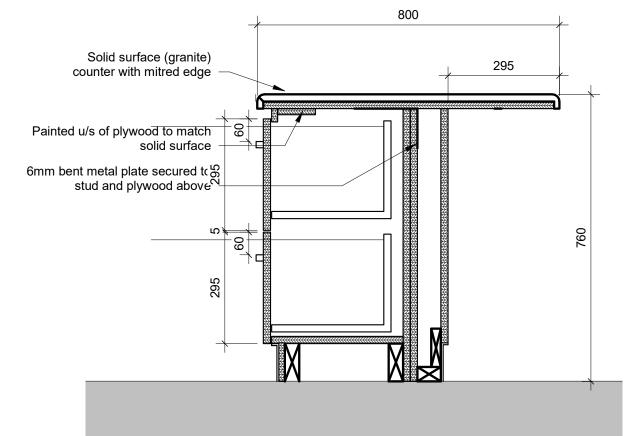
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150 Belleview Ave Kitchener ON N2B 1G7 PROJECT CODE: SCALE:


As indicated 20\_28\_ STATUS: DATE: Permit/Tender December 2021



2 Detail Section - MW1 Reception Desk through Transaction Counter 1:10

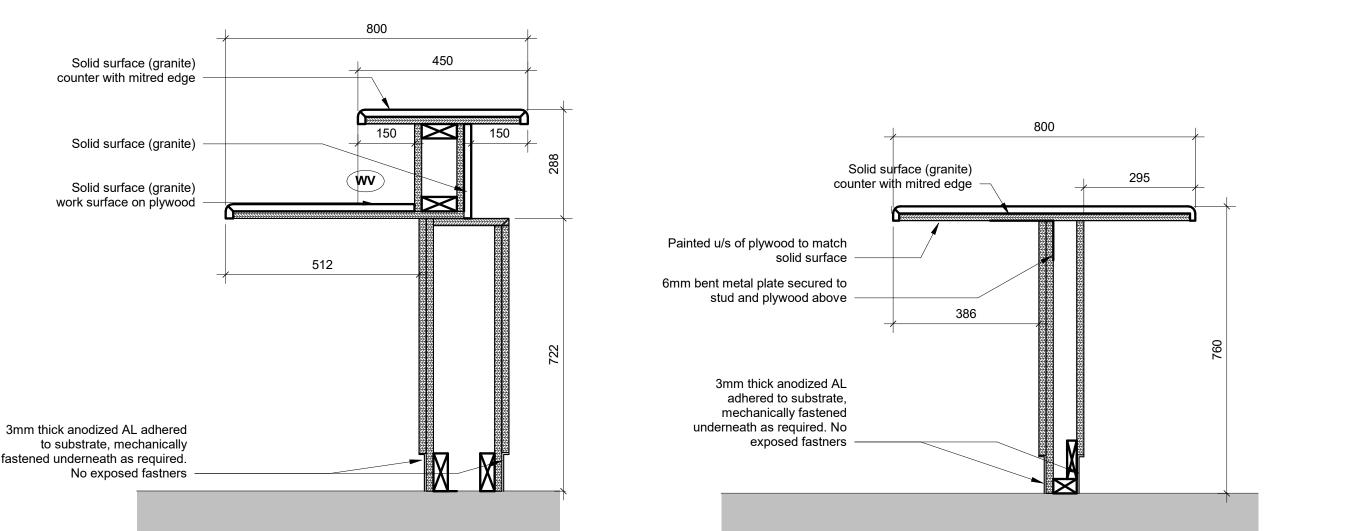

3 Detail Section - MW1 Reception Desk through Low Panel 1:10 4 Detail Section - MW1 Reception Desk through Drawers
1:10

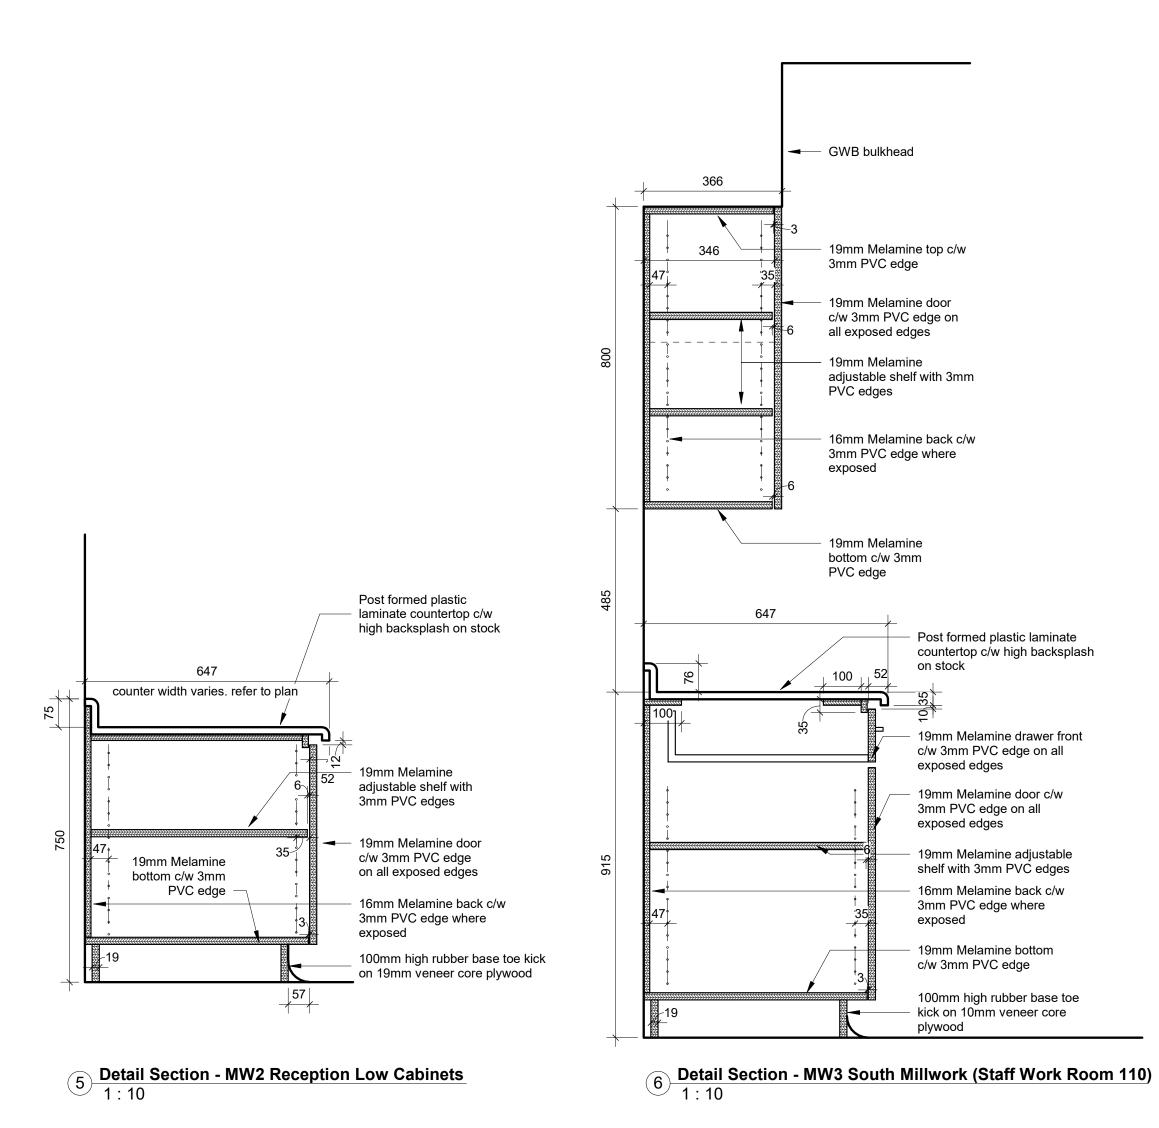

450

1 Detail Section - MW1 Reception Desk through Cabinet 1:10

Solid surface (granite)

Solid surface (granite)

counter with mitred edge

Solid surface (granite) work surface on plywood

Woood veneer on all exposed sides ©

of 19mm plywood panels and doors

19mm wood veneer adjustable

3mm thick anodized AL adhered

fastened underneath as required.


to substrate, mechanically


No exposed fastners

shelf with 5mm hardwood at

exposed eges -

5mm hardwood at all exposed edges -

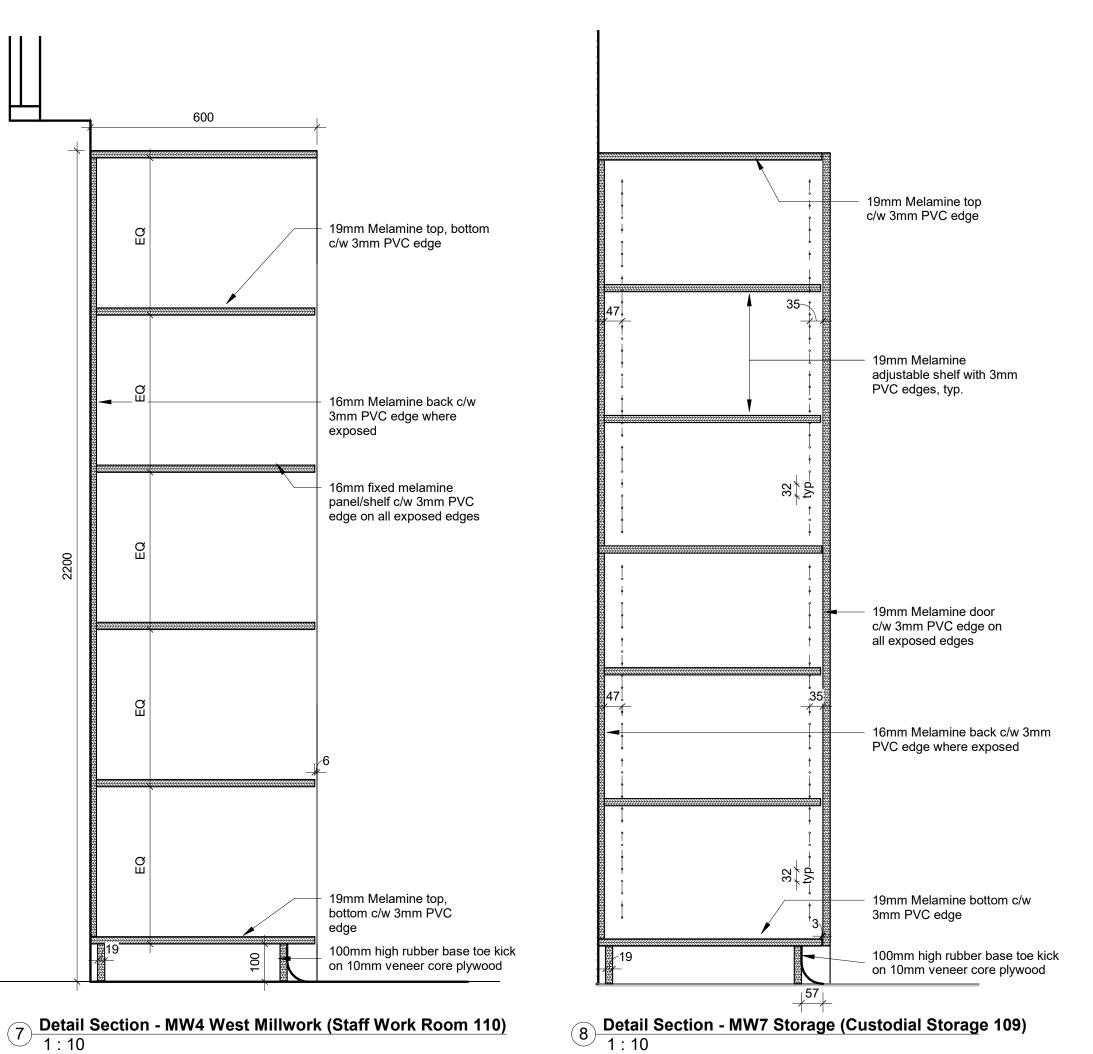

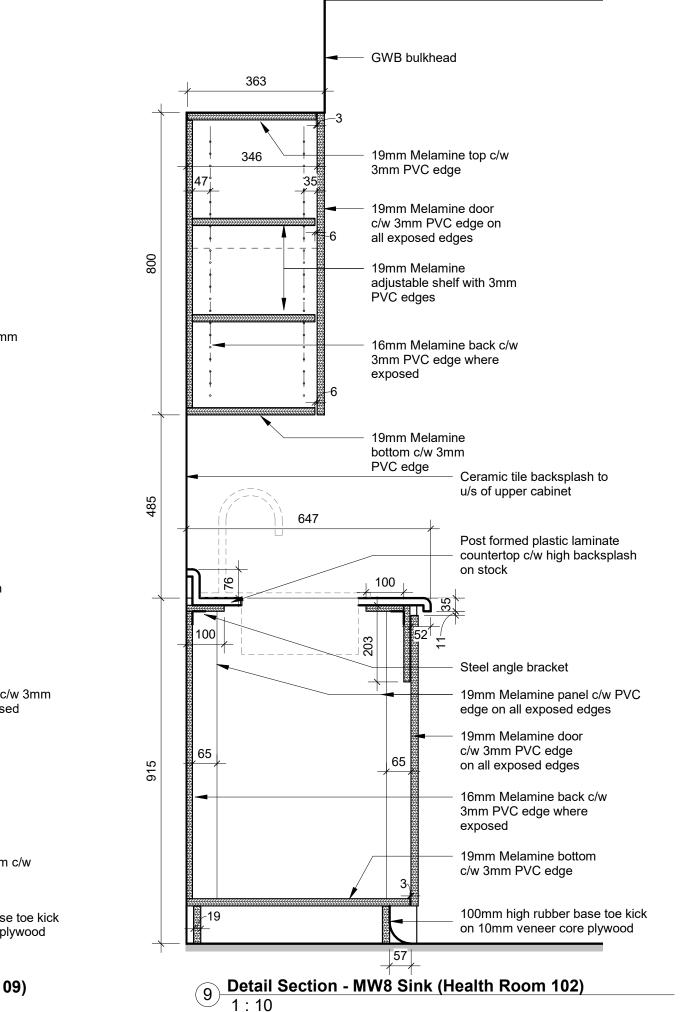





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RevDescriptionDate3Issued for 90% Review03 Dec 20214Issued for Review21 Jan 20225Issued for Permit04 Feb 20226Issued for Tender15 Feb 2022

Acoustic Ceiling Tile

Aluminum

Carpet

Ceramic Tile

### Materials Legend

ALUM

CER

CPT

EPO Epoxy Paint Existing **EXIST** EXP Exposed FAB Fabric Faced Acoustic Core Composite Ceiling Panel FGL Frosted Glass F1 GWB MIR Glazing Surface Film Gypsum Wallboard MDF MDF Baseboard PLY Fire Rated Plywood POR Porcelain Tile PLAM Plastic Laminate PT Paint Finish QTZ Quartz RB Rubber Base RES Resilient Sheet Flooring SO SS Solid Polymer Fabrications Stainless Steel ST Natural Stone TGL Tempered Glass WB Dry Erase Whiteboard WD Solid Wood

Wood Stain

## Millwork Hardware Legend

Adjustable shelf pins/ferrules: Richelieu No 2291/2292-180, nickel finish at 2" centres

Bumpers (2 each per door): Richelieu 3M (Peel &Stick)

Cabinet/Drawer Pulls: Richelieu Functional Steel Pull #33205195, Brushed Nickel

Concealed hinges: Blum Blumotion 110 degrees

Concealed shelf support brackets:

Richelieu 1621712G

Soft close mechanism at all drawers:

Richelieu BP97309910

Steel Roller Glides at 350mm drawers:

Accuride #3641 Full Extension

Provide cam locks at all cabinets and drawers

OF

OF

ARCHITECTS

LICENCE
6548

# **WORKSHOP** architecture

WORKSHOP architecture inc 6 Sousa Mendes Street Toronto Ontario M6P 0A8 T 416.901.8055 F 416.849.0383 www.workshoparchitecture.ca

WRDSB Smithson Public School -HVAC & Electrical Upgrades, Interior Renovations Smithson Public School 150 Belleview Ave Kitchener ON

PROJECT CODE: SCALE:


20\_28 As indicated

DATE: STATUS:

December 2021 Permit/Tender

Millwork Details

N2B 1G7

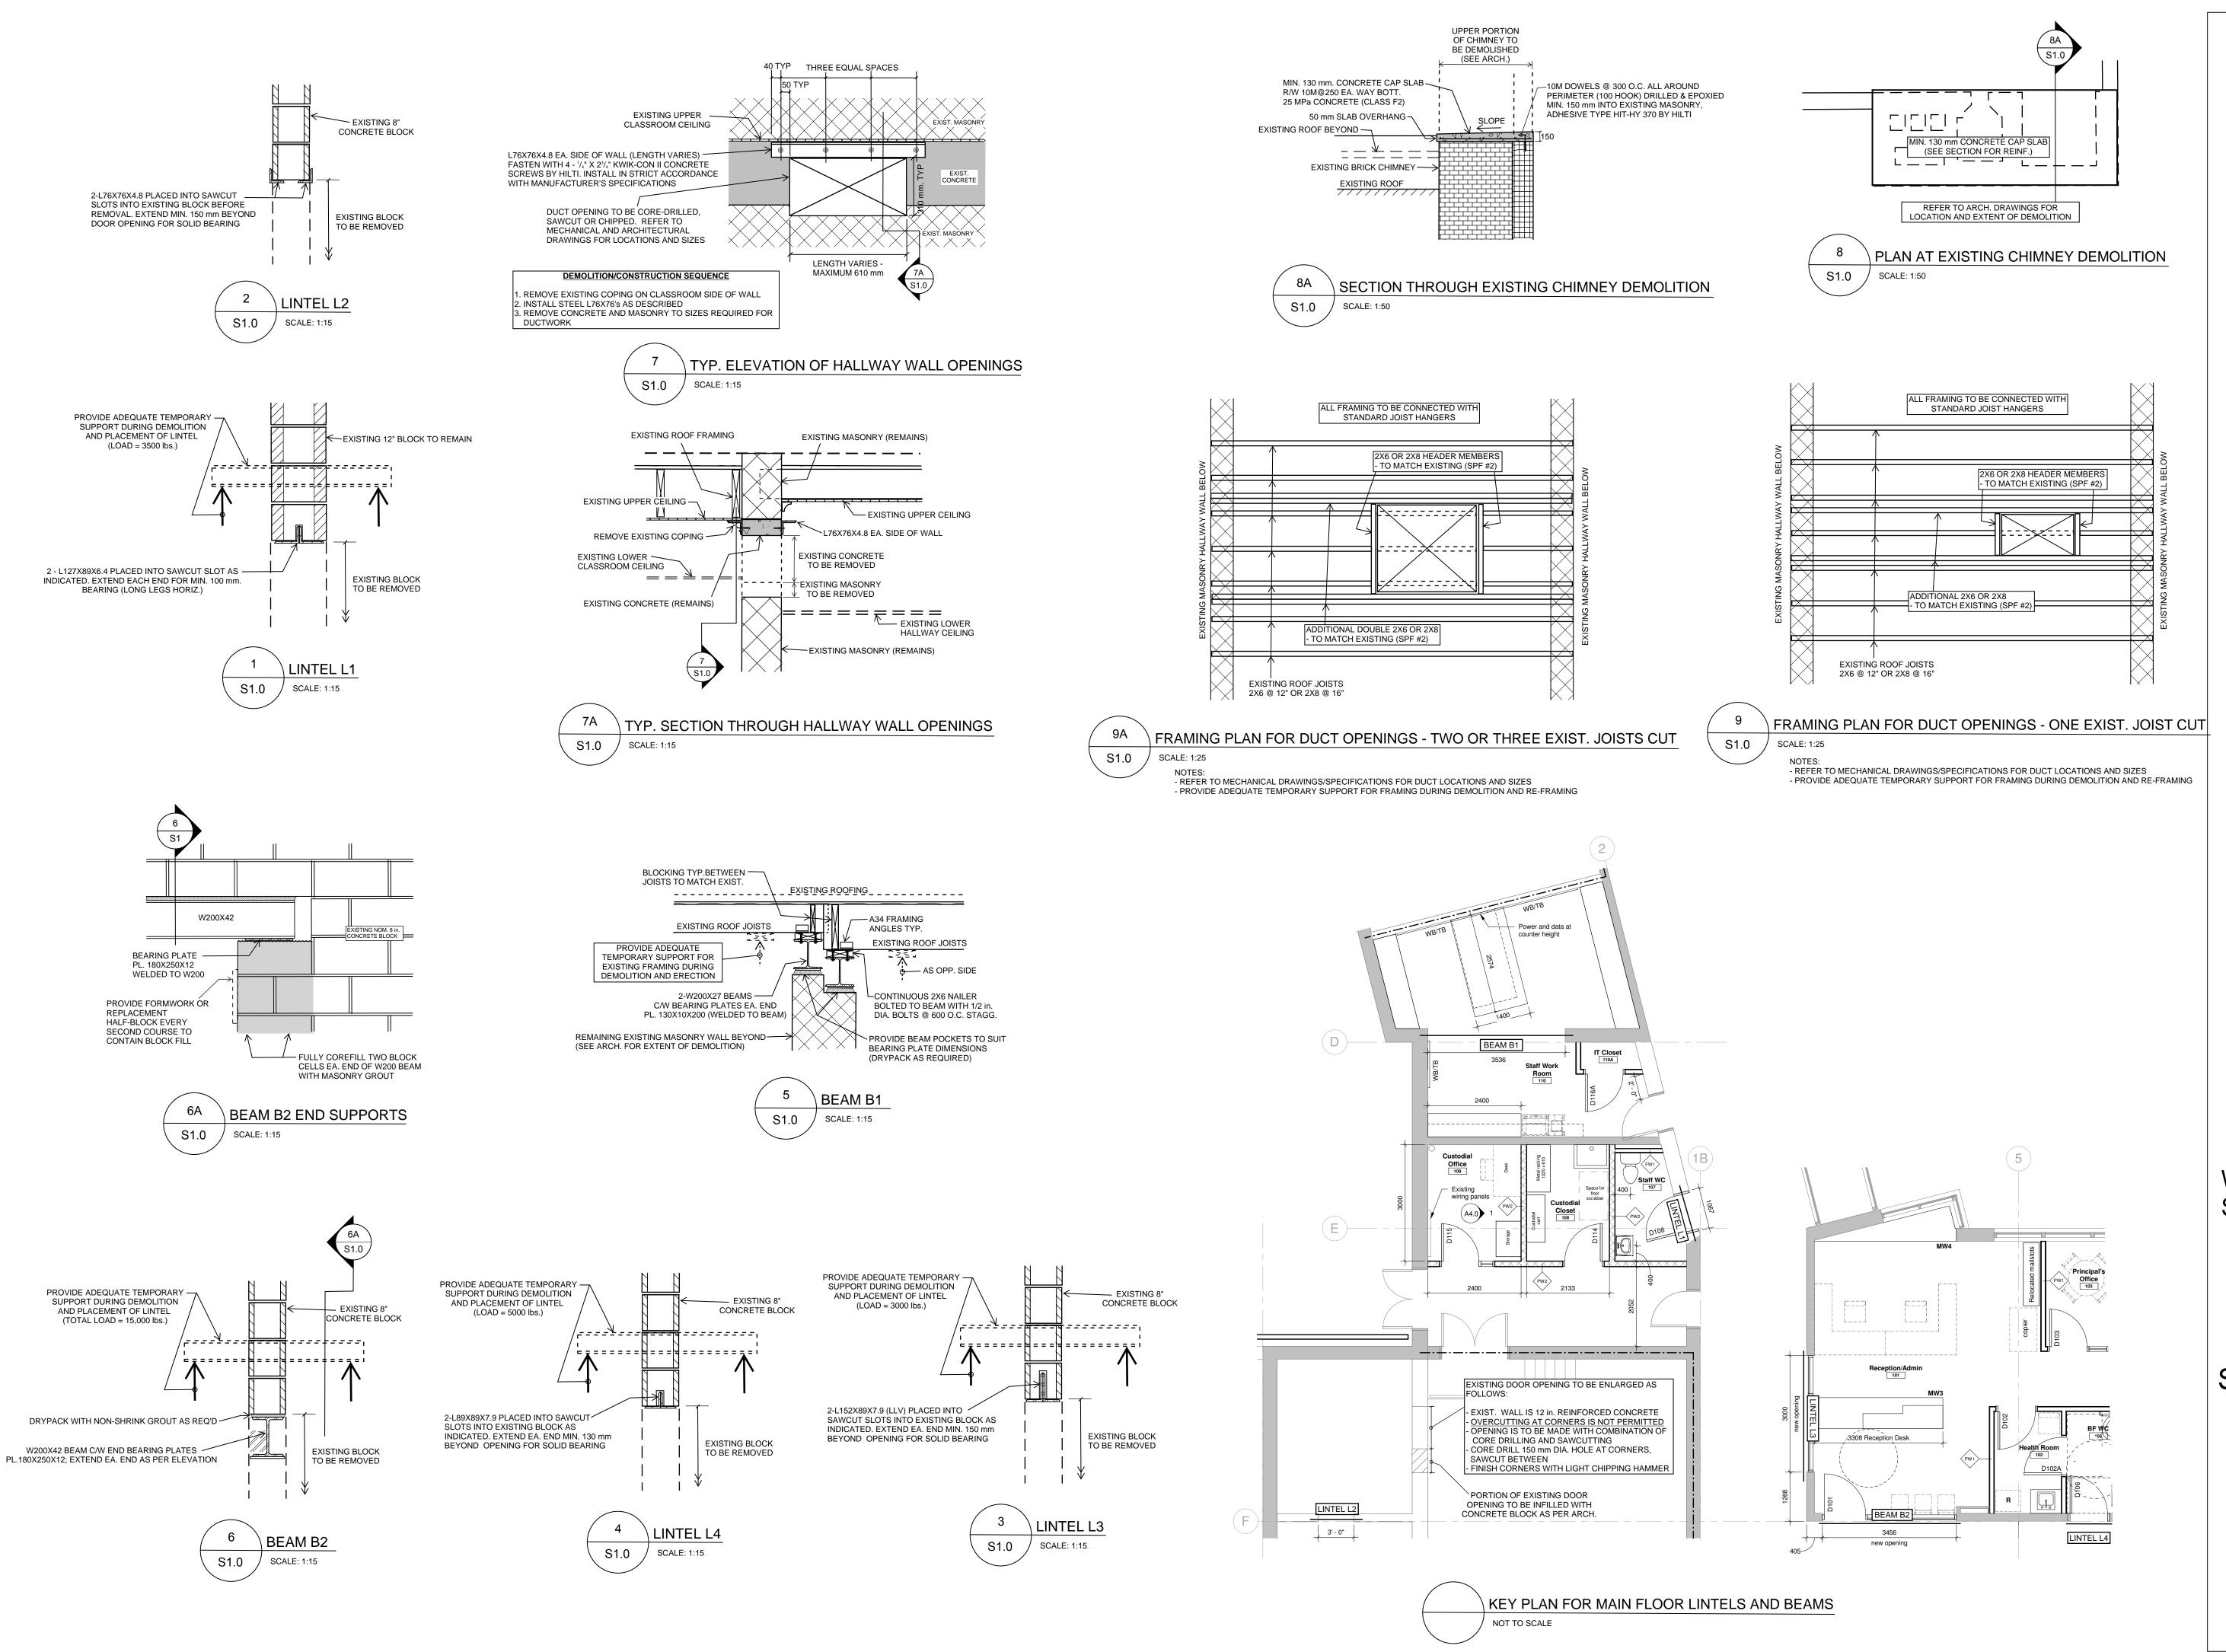

REVISION LOG

NO. DATE DESCRIPTION / NOTES

O1 17.12.2021 Issued for Client Review

02 20.01.2022 <u>Issued for Review</u>

03 04.02.2022 Issued for Permit

04 15.02.2022 Issued for Tender

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All dimensions are provided in millimeters unless noted otherwise.

Do not scale drawings.

Contractor shall confirm all dimensions with site conditions prior to commencing work and report any discrepancies to the consultants.

Construction and any temporary works used are to conform with all applicable codes and standards mandated by authorities having jurisdiction

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PROJECT

# WRDSB SMITHSON PUBLIC SCHOOL RENOVATIONS

150 Belleview Ave. Kitchener Ontario

DRAWING TITLE

## STRUCTURAL DETAILS

PROJECT NO.		DESIGNED BY	
	WORKS-21-031		PW
DATE		DRAWN BY	
	DECEMBER, 2021		PW
SCALE		CHECKED BY	
	AS NOTED		PW

DRAWING NO.

**S1.0** 

## GENERAL REQUIREMENTS FOR MASONRY

- 1. MASONRY WORK SHALL CONFORM TO CAN/CSA-A371 MASONRY CONSTRUCTION FOR BUILDINGS AND THE FOLLOWING REFERENCED DOCUMENTATION:
- 1.1. CONCRETE MASONRY BLOCKCAN/CSA-A165.1 TYPE H/15/A U.N.O.
- 1.2. MORTAR CAN/CSA-A179 TYPE S CAN/CSA-A179 MIN. 20 MPa U.N.O. 1.3. GROUT
- 1.4. MASONRY WIRE REINFORCING CSA G30.5 1.5. REINFORCING BARS

1200 mm STARTER DOWELS TO MATCH.

- CAN/CSA-G30.18 400MPa 1.6. CONNECTIONS CAN/CSA-A370
- 1.7. MASONRY DESIGN CSA S304.1 DESIGN OF MASONRY STRUCTURES

200 mm

- 2. TESTING OF MASONRY UNITS, MORTAR, AND GROUT SHALL BE PERFORMED IN ACCORDANCE WITH CAN/CSA S304.1 AND CAN/CSA-A371 3. UNLESS NOTED OTHERWISE, ALL LOAD-BEARING MASONRY TO BE RUNNING BOND CONSTRUCTION, KEYED IN AT
- CORNERS AND INTERSECTIONS. 4. UNLESS NOTED OTHERWISE, PROVIDE 15M @ 1200 c/c FULL-HEIGHT AT ALL LOAD-BEARING MASONRY WALLS, MIN.
- 6. ALL VERTICAL REINFORCING TO BE PLACED IN THE CENTRE OF THE WALL 6. PROVIDE CONTINUOUS HEAVY-DUTY LADDER TYPE OR TRUSS TYPE HORIZONTAL MASONRY REINFORCING AT 400 mm U.N.O., FULL OVERLAP AT CORNERS & INTERSECTIONS.
- 7. AT LOCATIONS OF CONCENTRATED LOADS, SOLID-FILL AT LEAST 2 COURSES BELOW AND 1 CORE TO EACH SIDE OF BEARING WITH 20MPa GROUT. 8. PROVIDE SOLID-GROUTED MASONRY BOND BEAM REINFORCED WITH 1-15M CONTINUOUS IN TOP COURSE OF
- WALLS BELOW BEAM OR JOIST BEARING 9. PROVIDE MIN. LAPS FOR REINFORCING AS FOLLOWS:
- 9.1. WIRE REINFORCING 9.2. 10M BARS
- 600 mm 9.3. 15M BARS 750 mm
- 10. PROVIDE CLEANOUTS FOR ALL CELLS TO BE REINFORCED 11. FILL ALL CELLS CONTAINING VERTICAL REINFORCING WITH 20MPa GROUT; VIBRATE OR PUDDLE FILL CELLS
- PROVIDE LINTELS OVER ALL WALL OPENINGS WITH MIN. 150 mm BEARING; SEE STRUCTURAL DRAWINGS FOR LINTEL SIZES AND ADDITIONAL REQUIREMENTS. GROUTING MIX TO HAVE SUFFICIENT WATER TO PRODUCE
- POURING CONSISTENCY WITHOUT SEGREGATION OF INGREDIENTS, AND TO RETAIN COHESIVENESS. 12. FILL CELLS IN LIFTS OF NO MORE THAN 1200 mm OR BETWEEN BOND BEAMS, WHICHEVER IS LESS. 13. NO MASONRY WORK SHALL BE PERMITTED AT TEMPERATURES BELOW 5 DEGREES CELSIUS UNLESS ADEQUATE PROVISIONS ARE MADE FOR HEATING AND PROTECTING THE MATERIALS IN ACCORDANCE WITH RECOMMENDED

## GENERAL REQUIREMENTS FOR WOOD FRAMING

- 1. ALL FRAMING DETAILS, MATERIALS, AND CONSTRUCTION TECHNIQUES TO BE IN ACCORDANCE WITH CAN/CSA086 (ENGINEERING DESIGN IN WOOD) AND PART 9 OF THE ONTARIO BUILDING CODE 2012, UNLESS OTHERWISE INDICATED ON THE DRAWINGS.
- 2. REQUIREMENTS FOR FRAMING MATERIALS
- 2.1. WALL STUDS AND BUILT-UP POSTS SPF STUD GRADE OR BETTER
- 2.2. CONVENTIONAL ROOF JOISTS AND BUILT-UP BEAMS SPF #2 GRADE OR BETTER

PRACTICES PUBLISHED BY THE INTERNATIONAL MASONRY ALL WEATHER COUNCIL.

## GENERAL REQUIREMENTS FOR STRUCTURAL STEEL

STANDARD CONNECTIONS

- 1. MATERIAL SPECIFICATIONS AND GRADES ONLY NEW MATERIAL TO BE USED:
- WIDE FLANGE SECTIONS CSA G40.21, GRADE 350W CHANNEL AND ANGLE SECTIONS, PLATES CSA G40.21, GRADE 300W TO ASTM A500 HSS SECTIONS
- TO ASTM A53/53M GRADE B PIPE SECTIONS 2. STRUCTURAL STEEL CONNECTIONS 2.1. ALL CONNECTIONS TO BE DESIGNED BY FABRICATOR UNLESS NOTED OTHERWISE.
- STANDARD FRAME CONNECTIONS WHICH DO NOT HAVE DESIGN FORCES INDICATED ON THE STRUCTURAL DRAWINGS TO BE DESIGNED FOR THE FULL FLEXURAL CAPACITY OF THE MEMBER (AS PROVIDED IN "BEAM LOAD TABLES" OF THE CURRENT CISC HANDBOOK OF STEEL CONSTRUCTION) IN ACCORDANCE WITH THE REQUIREMENTS OF CAN/CSA-S19 2.3. ERECTION DRAWINGS AND SHOP DRAWINGS ARE TO BE PREPARED BY THE FABRICATOR UNDER THE
- DIRECTION OF A PROFESSIONAL ENGINEER REGISTERED IN THE PROVINCE OF ONTARIO. THE ENGINEER SHALL PROVIDE A PROFESSIONAL SEAL ON SHOP DRAWINGS PREPARED UNDER HIS/HER DIRECTION, OR ALTERNATIVELY PROVIDE A LETTER SEALED AND SIGNED BY THIS ENGINEER VERIFYING THE CONNECTION DESIGN SATISFIES THE LOADING REQUIREMENTS, AND THE REQUIREMENTS OF CAN/CSA-S16 AND ALL APPLICABLE STANDARDS.
- DESIGN DRAWINGS INCLUDE ARCHITECTURAL, STRUCTURAL, MECHANICAL AND ELECTRICAL DRAWINGS: PREPARATION OF ERECTION AND SHOP DRAWINGS TO BE DONE IN CONSIDERATION OF THE DESIGN DRAWINGS.
- 4. REFER TO ARCHITECTURAL DRAWINGS FOR ALL DIMENSIONS INCLUDING ROOF SLOPES, FLOOR AND ROOF ELEVATIONS. WHERE DIMENSIONS ARE ALSO INDICATED ON STRUCTURAL DRAWINGS, CONFIRM WITH ARCHITECTURAL DRAWINGS AND REPORT ANY DISCREPANCIES.
- SUBMIT ERECTION AND SHOP DRAWINGS FOR REVIEW BY THE CONSULTANTS PRIOR TO COMMENCEMENT OF FABRICATION
- 6. FABRICATION, DESIGN, DETAILING AND ERECTION OF STRUCTURAL STEEL TO BE IN ACCORDANCE WITH CAN/CSA-S16 AND THE CISC CODE OF STANDARD PRACTICE FOR STRUCTURAL STEEL; ALL WELDING TO BE IN
- ACCORDANCE WITH CSA W59. STEEL FABRICATOR TO BE CERTIFIED TO DIVISION 2 (MINIMUM) OF CSA W47.1. SHOP WELDS, FIELD WELDS, BOLTED CONNECTIONS AND ERECTION TOLERANCES TO BE INSPECTED BY
- INDEPENDENT WELDING INSPECTION AGENCY CERTIFIED TO CSA W178.2.
- 9. SURFACE PREPARATION, PRIME PAINTING AND GALVANIZING: 9.1. STEEL RECEIVING FINISH PAINT
  - INCLUDES ARCHITECTURALLY EXPOSED STEEL STEEL WITH EXTERIOR EXPOSURE AND STEEL IN HUMID ENVIRONMENTS. SURFACE PREPARATION TO BE TO SSPC SP6 'COMMERCIAL BLAST CLEANING': PRIMER PAINT TO BE FULLY COMPATIBLE WITH FINISH PAINT (COORDINATE WITH ARCHITECTURAL SPECIFICATIONS).
  - STEEL ONLY RECEIVING PRIMER FOR STEEL WITH INTERIOR EXPOSURE AND NOT RECEIVING FINISH PAINT. STEEL TO BE CLEANED TO REMOVE ALL LOOSE RUST, LOOSE SCALE, DIRT, WELD FLUS, ETC. ALL GREASE AND OIL TO BE REMOVED IN ACCORDANCE WITH SSPC SP1-63 'SOLVENT CLEANING'. PRIMER PAINT TO MEET THE REQUIREMENTS OF CISC/CPMA STANDARD 1-73a 'A QUICK-DRYING ONE-COAT PAINT FOR USE ON STRUCTURAL STEEL.
  - 9.3 GALVANIZED STEEL FINISH FOR STEEL WITH EXTERIOR EXPOSURE AND RECEIVING FINISH PAINT. SURFACE PREPARATION TO BE TO SSPC SP8 'PICKLING': HOT DIP GALVANIZING TO BE IN ACCORDANCE WITH CAN/CSA G164. COORDINATE FINISH PAINT REQUIREMENTS WITH ARCHITECTURAL SPECIFICATIONS.

### GENERAL REQUIREMENTS FOR CONCRETE

- SPECIFYING AND DESIGN OF ALL CONCRETE MIXES TO BE IN ACCORDANCE WITH CSA A23.1, CONCRETE MATERIALS AND METHODS OF CONCRETE CONSTRUCTION.
- CURING OF CONCRETE ELEMENTS TO BE IN ACCORDANCE WITH CSA A23.1. THE CONCRETE SUPPLIER TO BE CERTIFIED BY THE READY MIX CONCRETE ASSOCIATION OF ONTARIO.
- PORTLAND CEMENT FOR USE IN CONCRETE MIXES TO BE TYPE GU UNLESS OTHERWISE INDICATED. CONCRETE DENSITY TO HAVE A UNIT WEIGHT OF 23.0 ± 0.5 kN PER CU. METRE UNLESS NOTED OTHERWISE.
- CONCRETE PROPERTIES FOR THE PERFORMANCE-BASED ALTERNATIVE FOR SPECIFYING CONCRETE (REFER TO TABLE 5 OF CSA A23.1) TO BE AS FOLLOWS:
  - 5.1. CONCRETE CAP SLAB FOR CHIMNEY 28-DAY COMPRESSIVE STRENGTH= 25 MPa (DETAIL 6/S1.0) EXPOSURE CLASS C1
- CALCIUM CHLORIDE IS NOT PERMITTED AS AN ADDITIVE IN ANY MIX WITHOUT THE WRITTEN APPROVAL OF THE
- STRUCTURAL ENGINEER COLD AND HOT/DRY WEATHER PLACEMENT, FINISHING, AND CURING OF CONCRETE TO BE IN ACCORDANCE WITH CSA A23.1.

### GENERAL CONSTRUCTION REQUIREMENTS

4.2. STRUCTURAL STEEL

DOCUMENTS

- 1. CONTRACTOR IS RESPONSIBLE FOR JOBSITE SAFETY, DESIGN, AND CONSTRUCTION OF ALL TEMPORARY STRUCTURES, FORMWORK, SCAFFOLDING, AND SHORING AS NECESSARY TO COMPLETE THE WORK. CONSTRUCTION SAFETY TO BE IN ACCORDANCE WITH THE CANADA OCCUPATIONAL SAFETY AND HEALTH REGULATIONS UNDER THE CANADA LABOUR CODE, PART 2, AND THE ONTARIO OCCUPATIONAL HEALTH AND SAFETY ACT AND REGULATIONS FOR CONSTRUCTION PROJECTS R.S.O. 1990.
- NOTWITHSTANDING THE PERIODIC FIELD REVIEW BY KONSOLIDATED STRUCTURAL. IT REMAINS THE RESPONSIBILITY OF THE CONTRACTOR TO CONSTRUCT THE WORK IN CONFORMITY WITH THE CONTRACT DOCUMENTS. KONSOLIDATED STRUCTURAL IS NOT RESPONSIBLE FOR THE ACTS OR OMISSIONS OF THE CONTRACTOR OR ANY OTHER PARTIES PERFORMING ANY OF THE WORK OR FOR THE FAILURE OF ANY PARTY TO CARRY OUT THE WORK IN ACCORDANCE WITH THE CONTRACT DOCUMENTS. THE CONTRACTOR REMAINS RESPONSIBLE FOR QUALITY CONTROL OF THE WORK.
- THE CONTRACTOR SHALL BE RESPONSIBLE TO VERIFY ALL SITE CONDITIONS AND SITE DIMENSIONS AND REPORT ALL AND ANY DISCREPANCIES OR UNSATISFACTORY CONDITIONS WHICH MAY ADVERSELY AFFECT THE PROPER COMPLETION OF THE PROJECT BEFORE PROCEEDING WITH THE STRUCTURAL WORK. SUCH
- CONDITIONS MUST BE REPORTED IMMEDIATELY TO THE ARCHITECT AND THE ENGINEER CONSTRUCTION TO BE IN ACCORDANCE WITH THE ONTARIO BUILDING CODE AND APPLICABLE MATERIAL CODES FOR THE SPECIFIC CONSTRUCTION MATERIALS USED ON THE PROJECT AS FOLLOWS (BUT NOT LIMITED TO

4.1. CAST-IN-PLACE CONCRETE CSA A23.1-09, CONCRETE MATERIALS AND METHODS OF CONCRETE CONSTRUCTION

S16-19 DESIGN OF STEEL STRUCTURES

4.3. MASONRY CAN/CSA A371-14


MASONRY CONSTRUCTION FOR BUILDINGS 4.4. TIMBER CSA 086-09, ENGINEERING DESIGN IN WOOD ONTARIO BUILDING CODE 2012


- 5. UNLESS NOTED OTHERWISE, ALL CODES AND STANDARDS REFERENCED APPLY TO THE MOST RECENT VERSION IN USE AT THE TIME OF ISSUE FOR BUILDING PERMIT
- COORDINATE ALL DIMENSIONS ON STRUCTURAL DRAWINGS WITH ALL OTHER CONTRACT DRAWINGS AND REPORT ALL AND ANY DISCREPANCIES TO THE STRUCTURAL ENGINEER. DIMENSIONS, ELEVATIONS, AND LOCATIONS OF STRUCTURAL MEMBERS AND SYSTEMS, AS SHOWN ON THESE DRAWINGS, GOVERN THE CONSTRUCTION OF STRUCTURAL WORK UNLESS OTHERWISE REPORTED TO THE STRUCTURAL ENGINEER AND THE ARCHITECT OR OTHER AFFECTED DISCIPLINE.
- REFER TO ARCHITECTURAL, MECHANICAL, ELECTRICAL, AND LANDSCAPE DRAWINGS FOR FLOOR/ROOF ELEVATIONS, CURBS, UPSTANDS, DRAINAGE SLOPES, RECESSES, OPENINGS THROUGH STRUCTURAL MEMBERS, AND LOCATIONS OF EQUIPMENT AFFECTING STRUCTURAL ELEMENTS.
- REFER TO ARCHITECTURAL AND MECHANICAL DRAWINGS AND SPECIFICATIONS FOR WATERPROOFING, DRAINAGE AND EXTERIOR CLADDING REQUIREMENTS SUBMIT SHOP DRAWINGS FOR CONSULTANT REVIEW AND PRIOR TO FABRICATION/CONSTRUCTION FOR STRUCTURAL ELEMENTS WHICH ARE DESIGNED BY FABRICATORS, ERECTORS, AND STRUCTURAL SUBTRADES FOR WORK INDICATED ON THE STRUCTURAL DRAWINGS. CONSULTANTS' REVIEW OF SHOP DRAWINGS DOES
- PERTAINING TO CONTENT OF SHOP DRAWINGS. 10. DO NOT CUT OR DRILL OPENINGS THROUGH STRUCTURAL COMPONENTS WITHOUT WRITTEN APPROVAL OF THE STRUCTURAL ENGINEER.

NOT RELIEVE THE SUBMITTING PARTY OF THEIR RESPONSIBILITIES FOR DESIGN, ACCURACY, ERRORS OR OMISSIONS


## CONSTRUCTION REVIEW BY KONSOLIDATED STRUCTURAL


- 1. PERIODIC SITE REVIEWS BY A DESIGNATED REPRESENTATIVE OF KONSOLIDATED STRUCTURAL WILL BE CONDUCTED TO DETERMINE, ON A RATIONAL SAMPLING BASIS, WHETHER THE WORK IS IN GENERAL CONFORMITY WITH THE STRUCTURAL DRAWINGS AND SPECIFICATIONS.
- THESE PERIODIC VISITS TO THE PROJECT SITE DO NOT MAKE KONSOLIDATED STRUCTURAL GUARANTORS OF THE CONTRACTOR'S WORK, NOR SHALL THEY BE INTERPRETED AS FORMING THE CONTRACTOR'S QUALITY CONTROL MANAGEMENT OF THE WORK.
- 3. QUALITY CONTROL, CONSTRUCTION SAFETY, AND CONSTRUCTION PROCEDURES TO ACHIEVE THE COMPLETED STRUCTURE REMAIN THE CONTRACTOR'S RESPONSIBILITY.
- 4. KONSOLIDATED STRUCTURAL WILL NOT BE RESPONSIBLE FOR THE ACTS OR OMISSIONS OF THE CONTRACTOR OR OTHER PARTIES CONSTRUCTING THE STRUCTURAL COMPONENTS OR FOR THE FAILURE OF ANY PARTIES PERFORMING THE STRUCTURAL WORK TO CONSTRUCT THE WORK IN ACCORDANCE WITH THE CONTRACT
- 5. PROVIDE A MINIMUM OF 24-HOURS NOTICE OF ANY REQUIRED FIELD REVIEW. THE WORK TO BE REVIEWED MUST BE SUBSTANTIALLY COMPLETE.

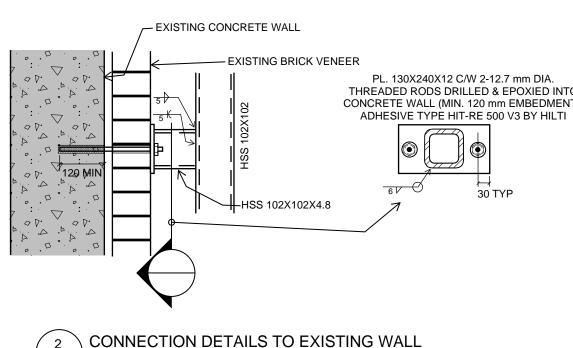

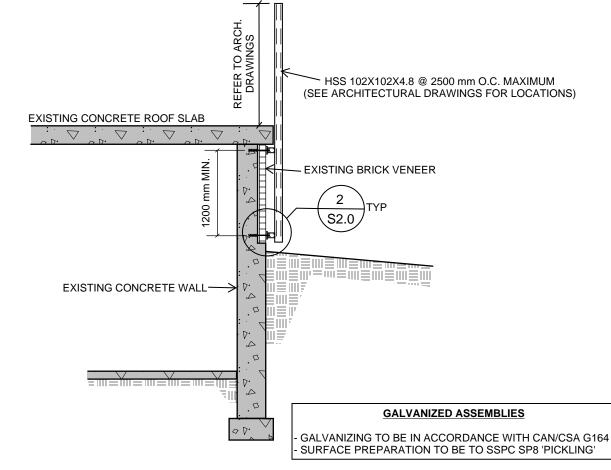



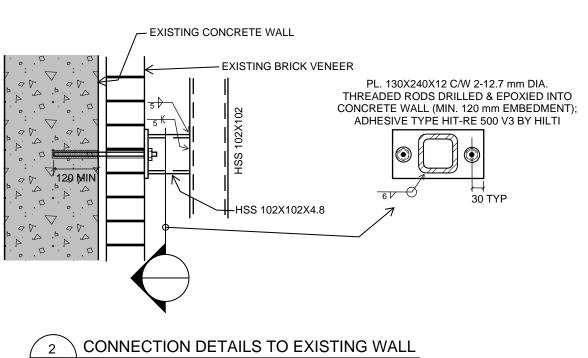

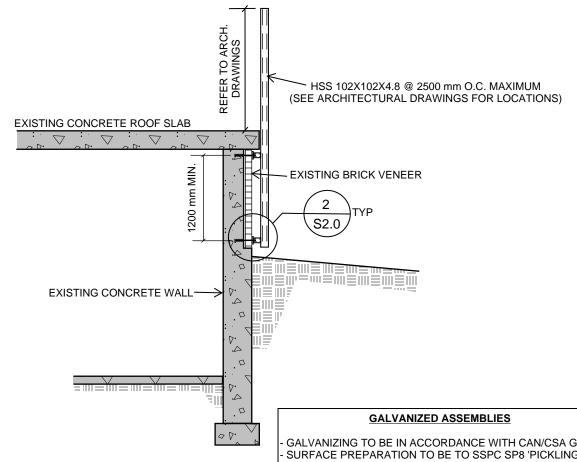

02 20.01.2022 Issued for Review 03 04.02.2022 Issued for Permit 04 15.02.2022 Issued for Tender

the intent of the contract documents.

REVISION LOG

NO. DATE DESCRIPTION / NOTES

01 17.12.2021 Issued for Client Review


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PROJECT

WRDSB SMITHSON PUBLIC SCHOOL RENOVATIONS

PROJECT ADDRESS


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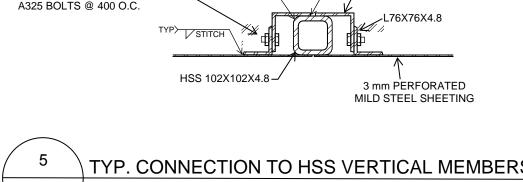
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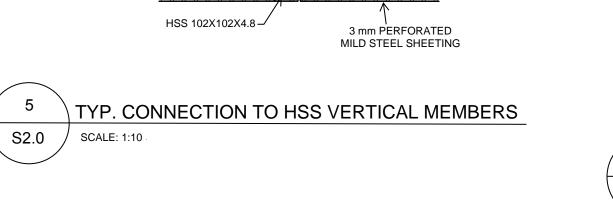
**SCREEN FRAMING &** CONSTRUCTION NOTES


PROJECT NO. DESIGNED B WORKS-21-031 DECEMBER, 2021 PWK CHECKED BY AS NOTED

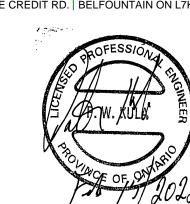DRAWING NO.






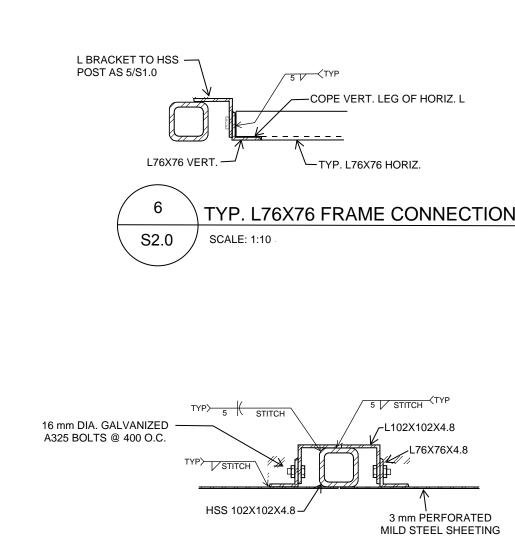

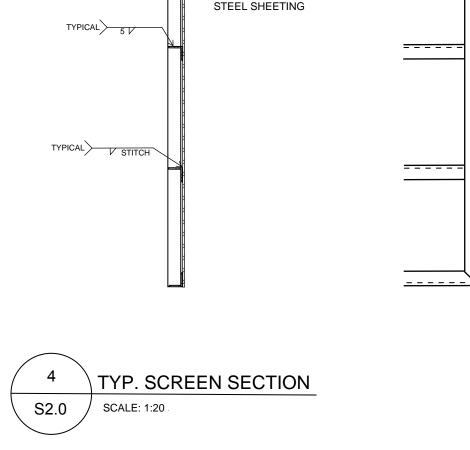

3 mm PERFORATED

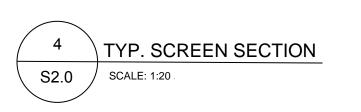

176X76X4.8 TY HORIZONTAL

> **GALVANIZED ASSEMBLIES** GALVANIZING TO BE IN ACCORDANCE WITH CAN/CSA G164 SURFACE PREPARATION TO BE TO SSPC SP8 'PICKLING'

TYP. SCREEN PANEL ELEVATION S2.0 SCALE: 1:20

L76X76X4.8

SPACING VARIES - SEE ARCHITECTURAL AND VERIFY BY SITE MEASUREMENTS

L76X76X4.8

3 mm PERFORATED MILD STEEL SHEETING (SEE ARCH.)

## SMITHSON PUBLIC SCHOOL


150 BELLEVIEW AVE, KITCHENER, ON

# WRDSB - WORKSHOP ARCHITECTURE - SMITHSON PS

PROJECT NO.: B20-349.02A

## **DRAWING LIST**


- M0 MECHANICAL SPECIFICATIONS
- 11 SITE PLAN
- M2 DEMO PLAN WEST WING
- M3 NEW HVAC PLAN WEST WING
- M4 NEW HYDRONIC PLAN WEST WING
- M5 PLUMBING PLAN WEST WING
- M6 ROOF PLAN WEST WING
- M7 MECHANICAL DETAILS PART 1
- M8 MECHANICAL DETAILS PART 2
- M9 HEATING PIPING SCHEMATIC
- M10 MECHANICAL SCHEDULES

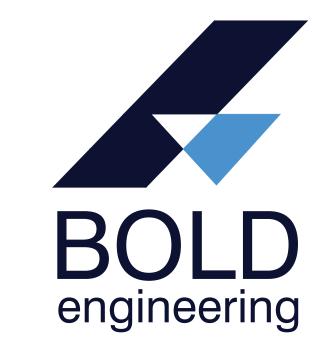


Bold Engineering Inc. 2778 Dufferin Street, Suite 104 Toronto, Ontario, M6B 3R7 Canada


Tel: 416-556-0766 Fax: 1-866-876-5758


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Bold Engineering Inc. 2778 Dufferin Street, Suite 104 Toronto, Ontario, M6B 3R7

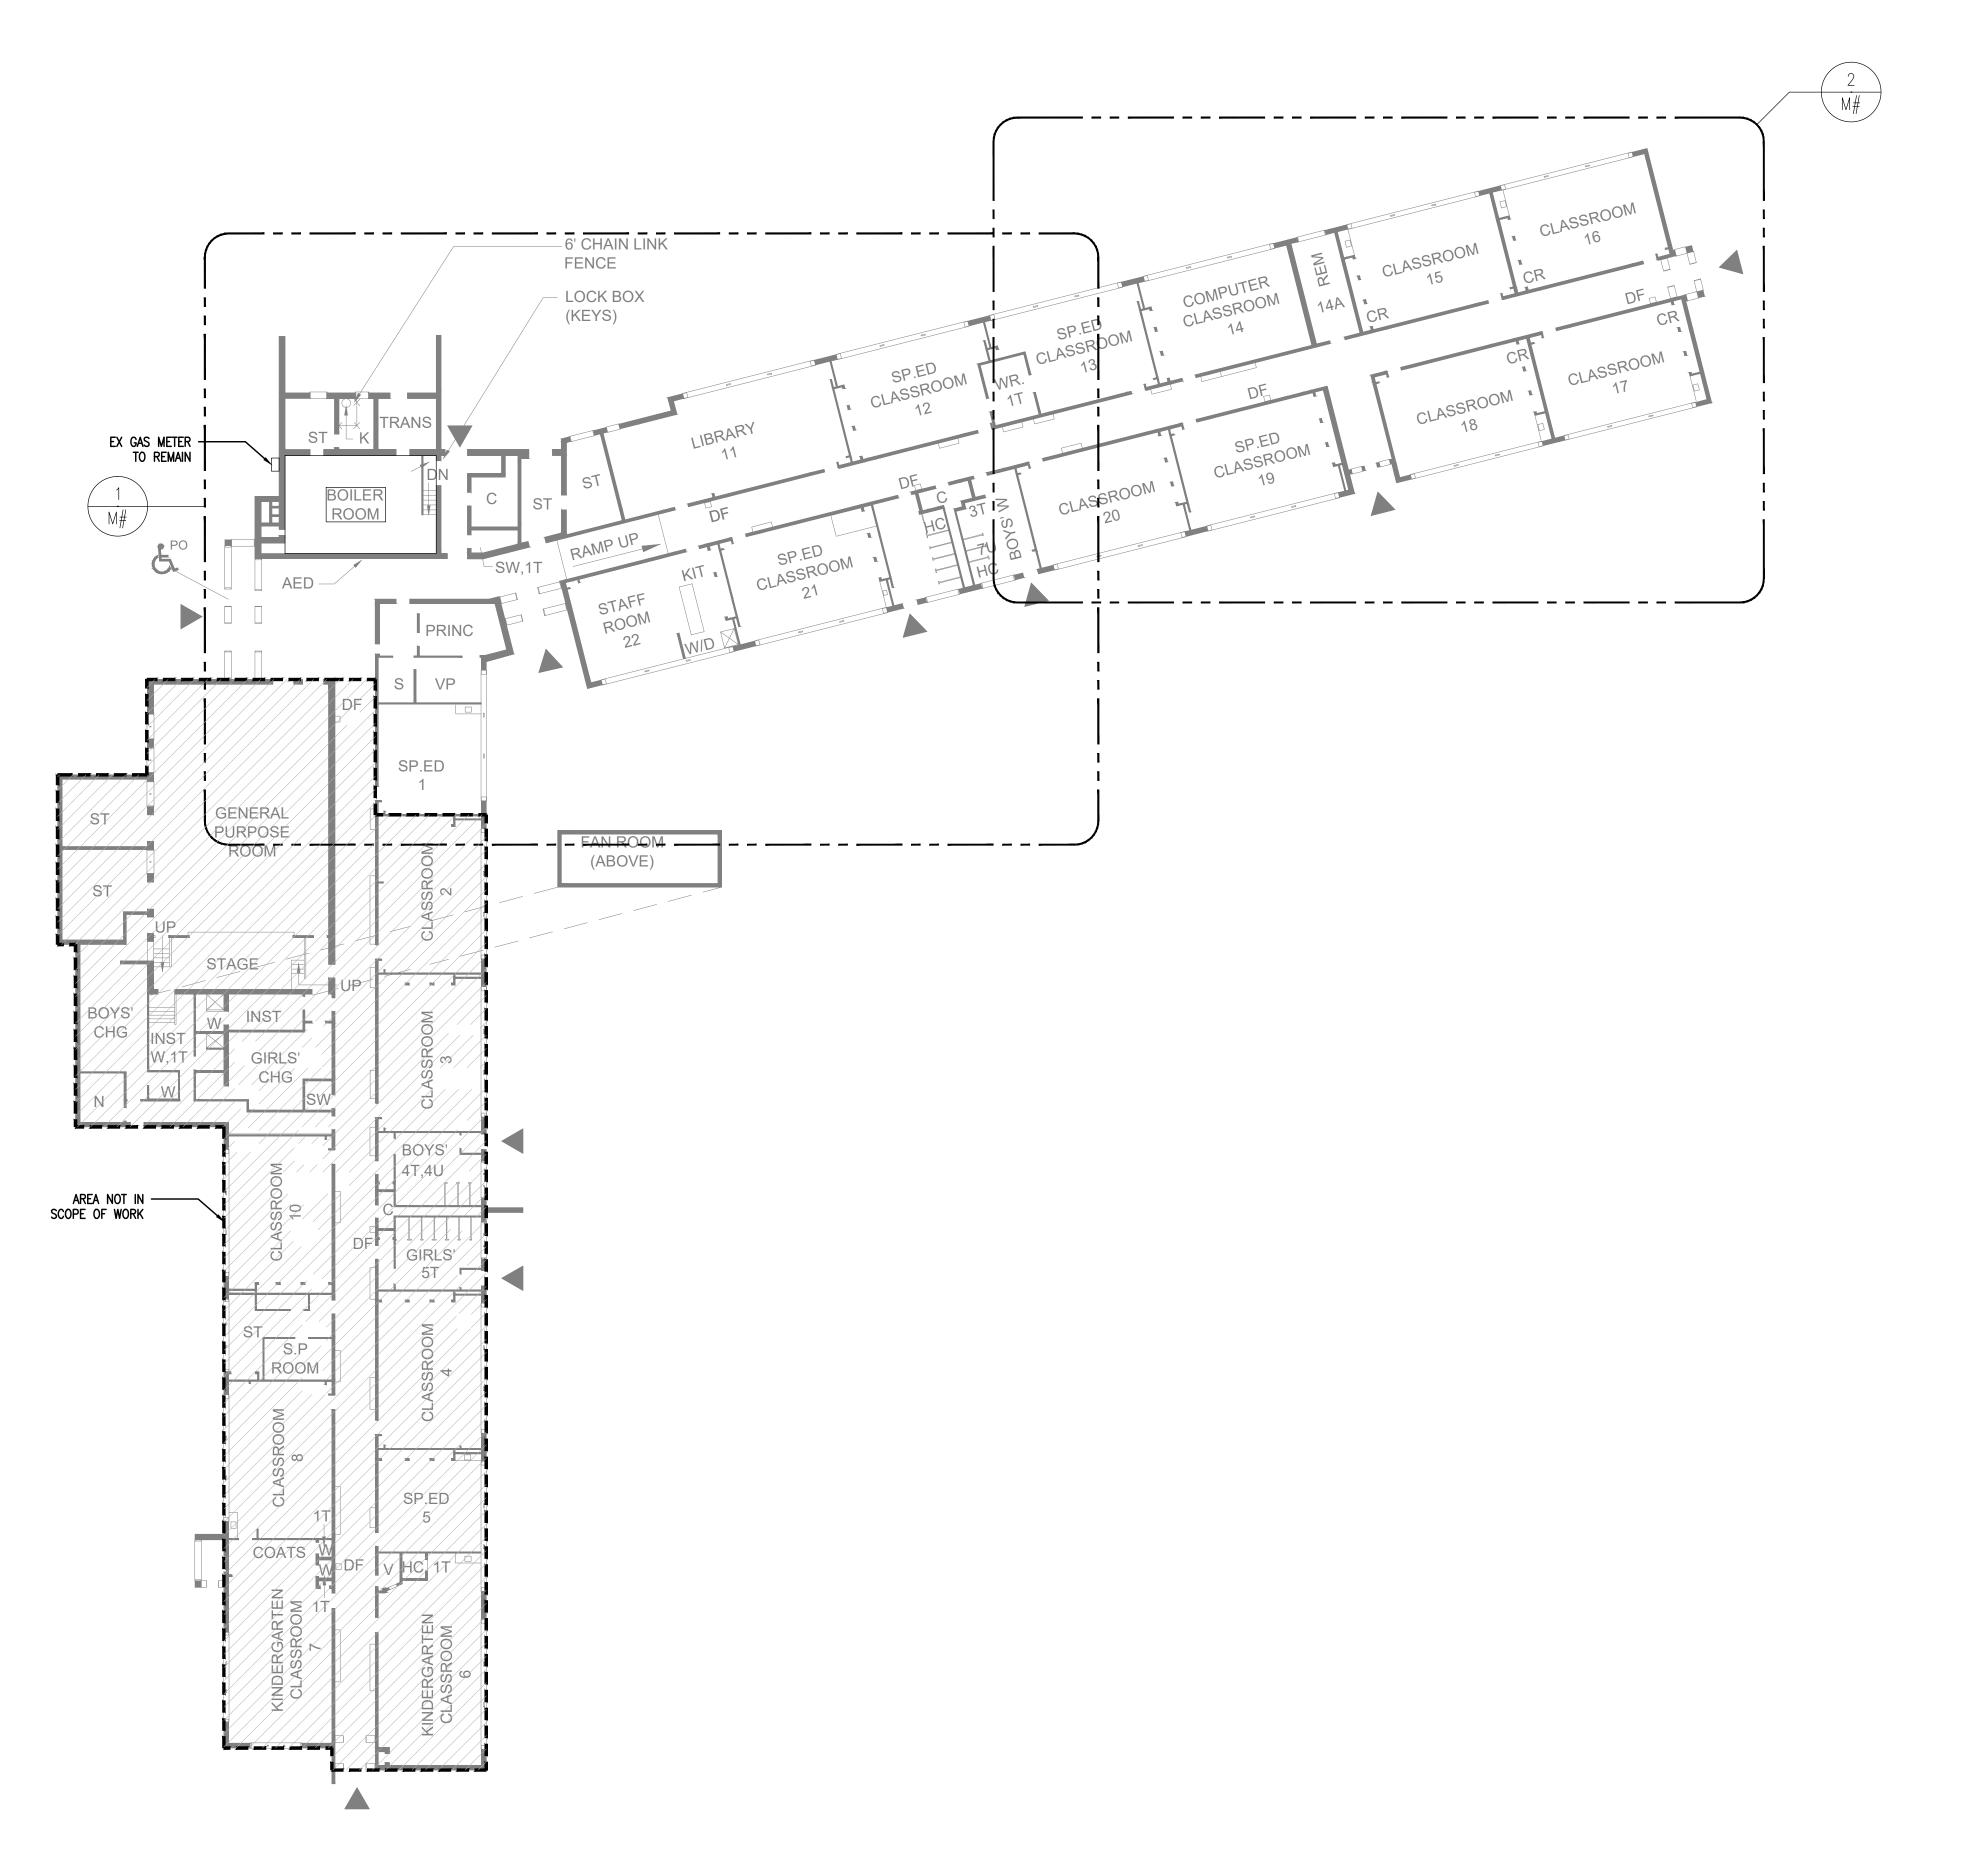engineering www.boldengineering.ca

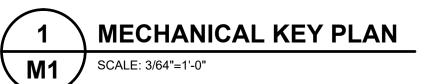Project Name

WRDSB - WORKSHOP ARCHITECTURE

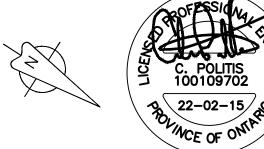**HVAC UPGRADES & INTERIOR RENOVATIONS** SMITHSON PUBLIC SCHOOL

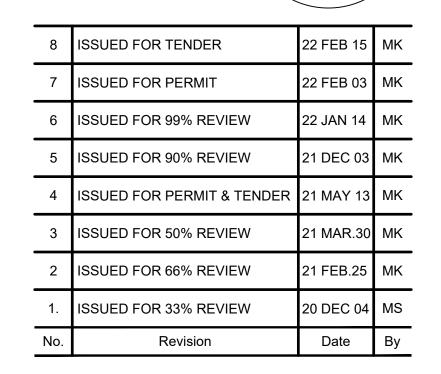150 BELLVIEW AVENUE, KITCHENER

Sheet Title

SITE PLAN


Drawn By MS Scale 1/8"=1'-0"

Designed By MS Date November 26, 2020


Project Number **B20-349.02A** 


Sheet Number **M1** 

Revision

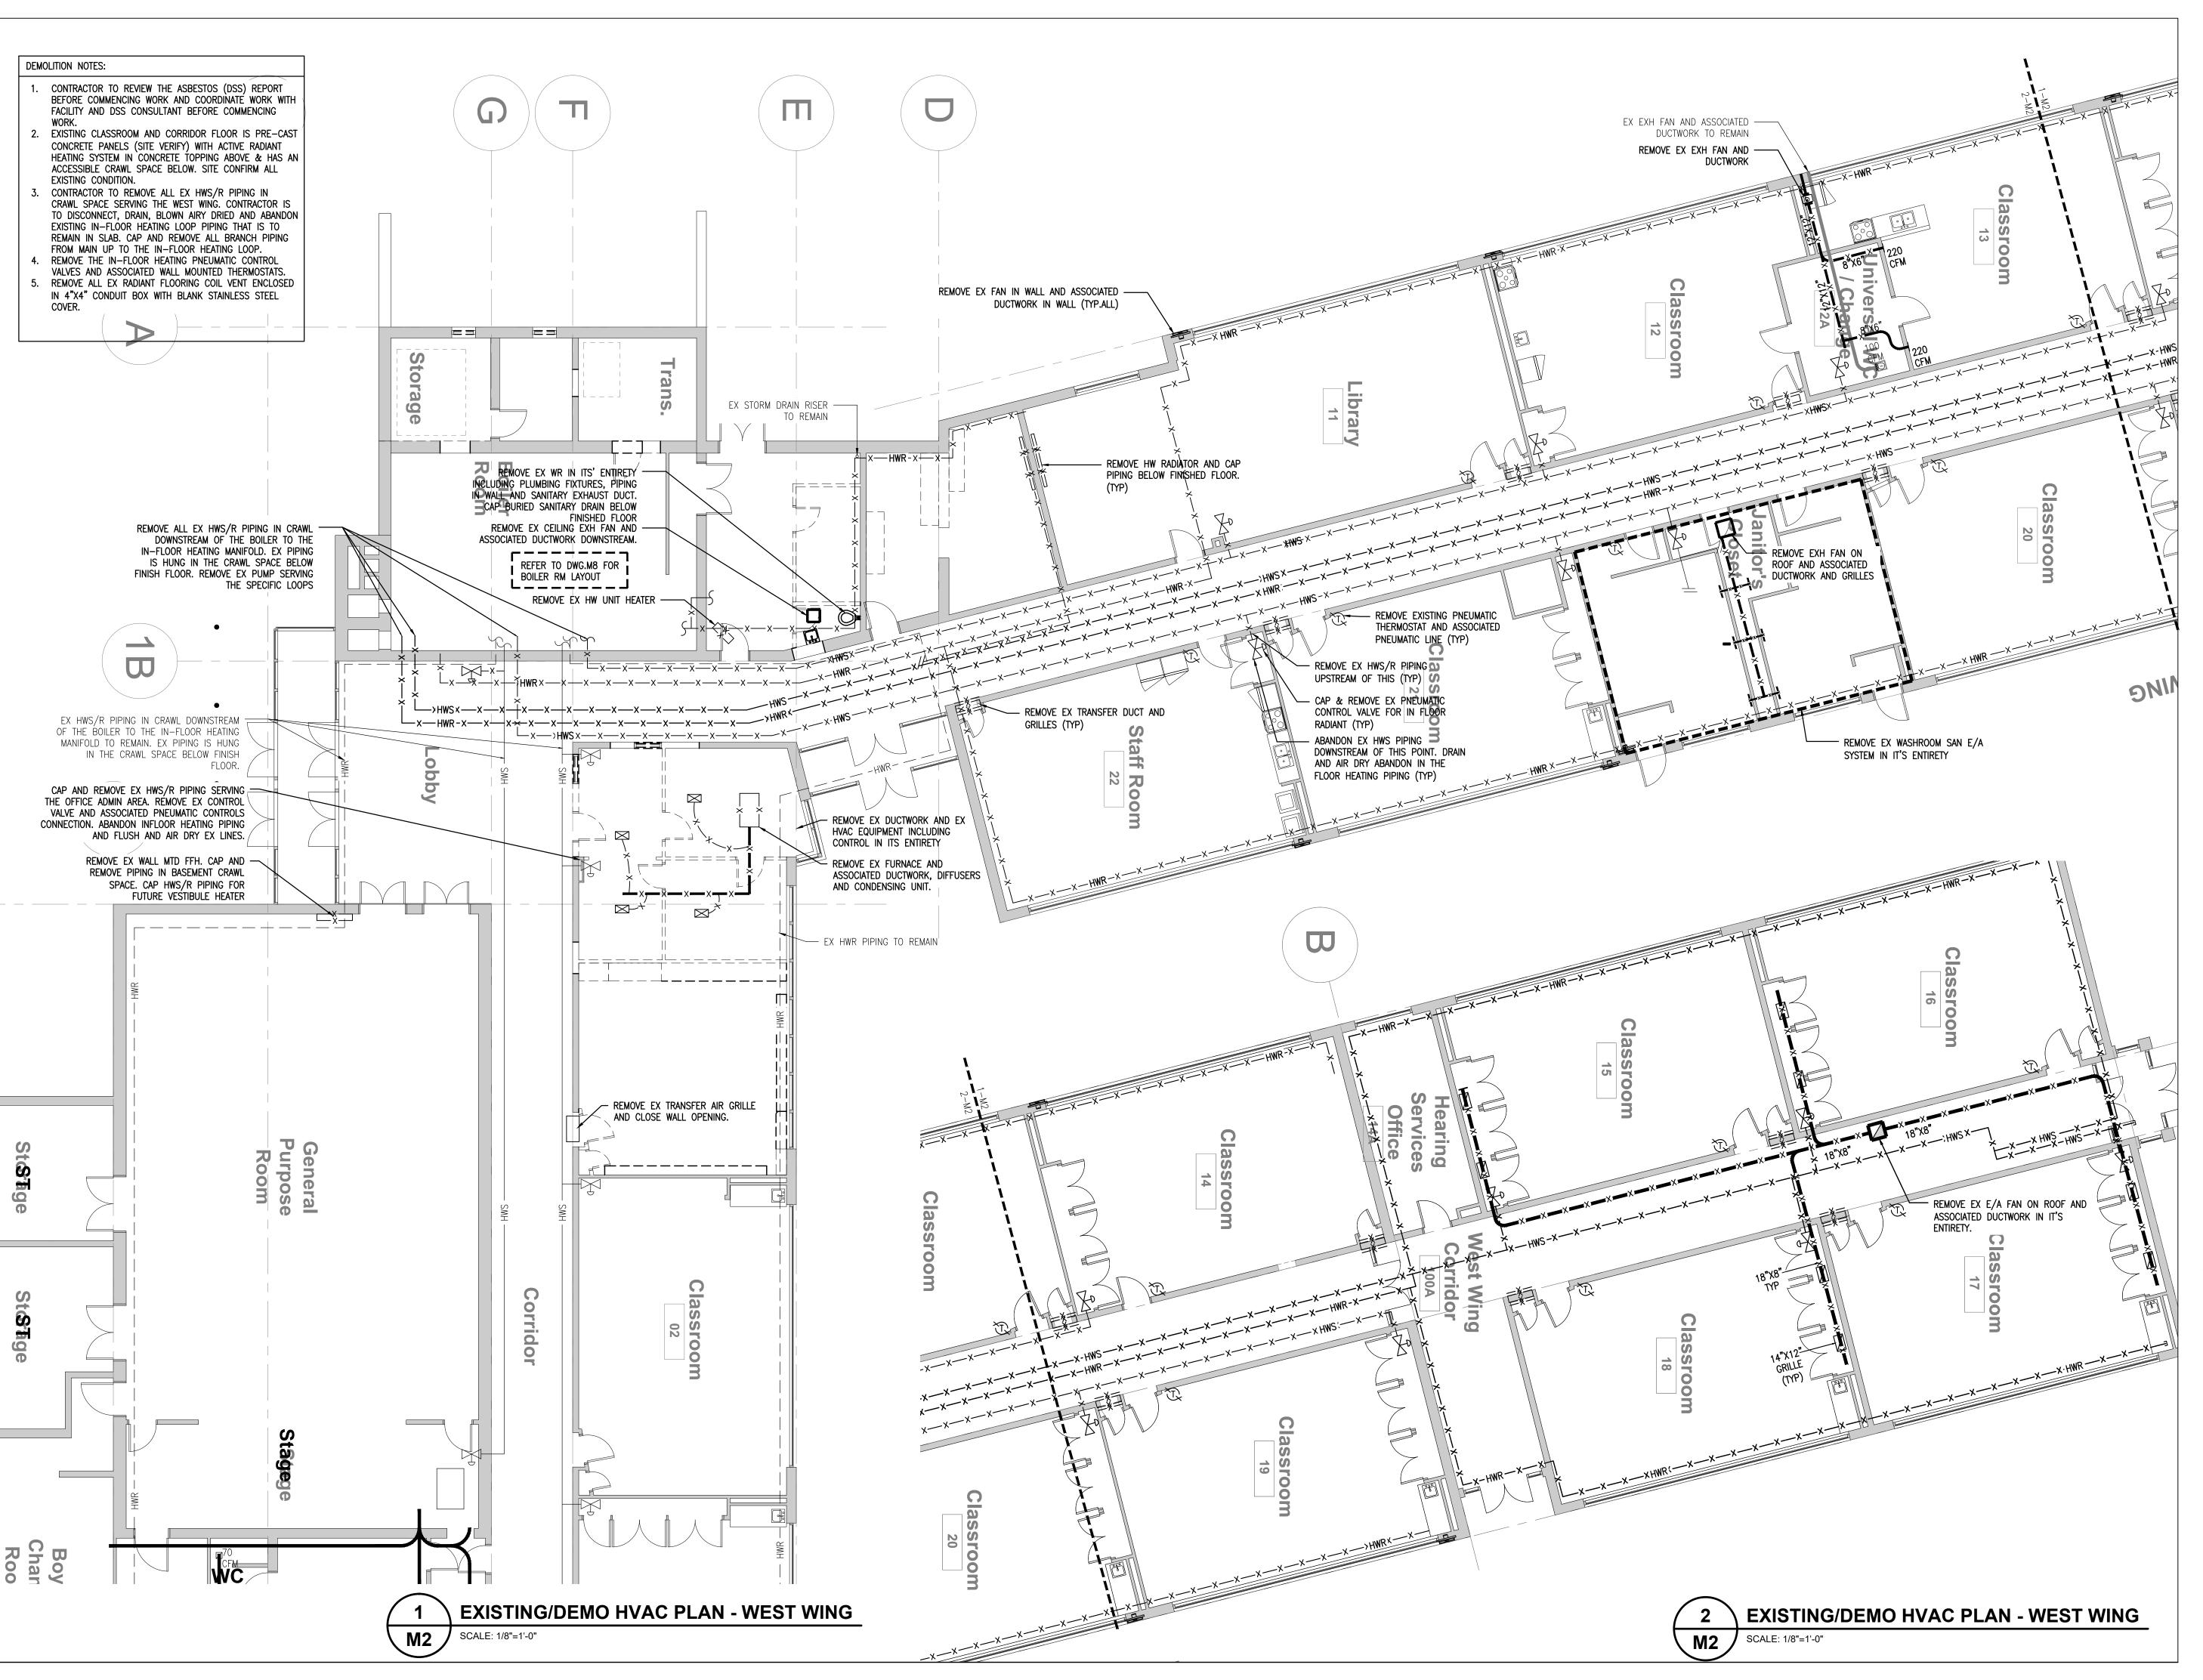

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	No.	Revision	Date	Ву
•	1.	ISSUED FOR 33% REVIEW	20 DEC 04	MS
•	2	ISSUED FOR 66% REVIEW	21 FEB.25	MK
•	3	ISSUED FOR 50% REVIEW	21 MAR.30	MK
•	4	ISSUED FOR PERMIT & TENDER	21 MAY 13	MK
•	5	ISSUED FOR 90% REVIEW	21 DEC 03	MK
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•	7	ISSUED FOR PERMIT	22 FEB 03	MK
·	8	ISSUED FOR TENDER	22 FEB 15	MK

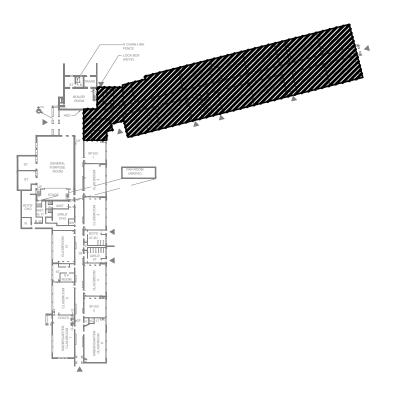
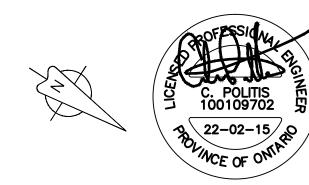
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engineering www.boldengineering.ca

Project Name WRDSB - WORKSHOP ARCHITECTURE

**HVAC UPGRADES & INTERIOR RENOVATIONS** SMITHSON PUBLIC SCHOOL 150 BELLVIEW AVENUE, KITCHENER


Sheet Title

EXISTING/DEMO HVAC PLANS - WEST WING


Drawn By MS Scale 1/8"=1'-0" Designed By MS Date November 26, 2020


Project Number **B20-349.02A Sheet Number** 

**M2** 

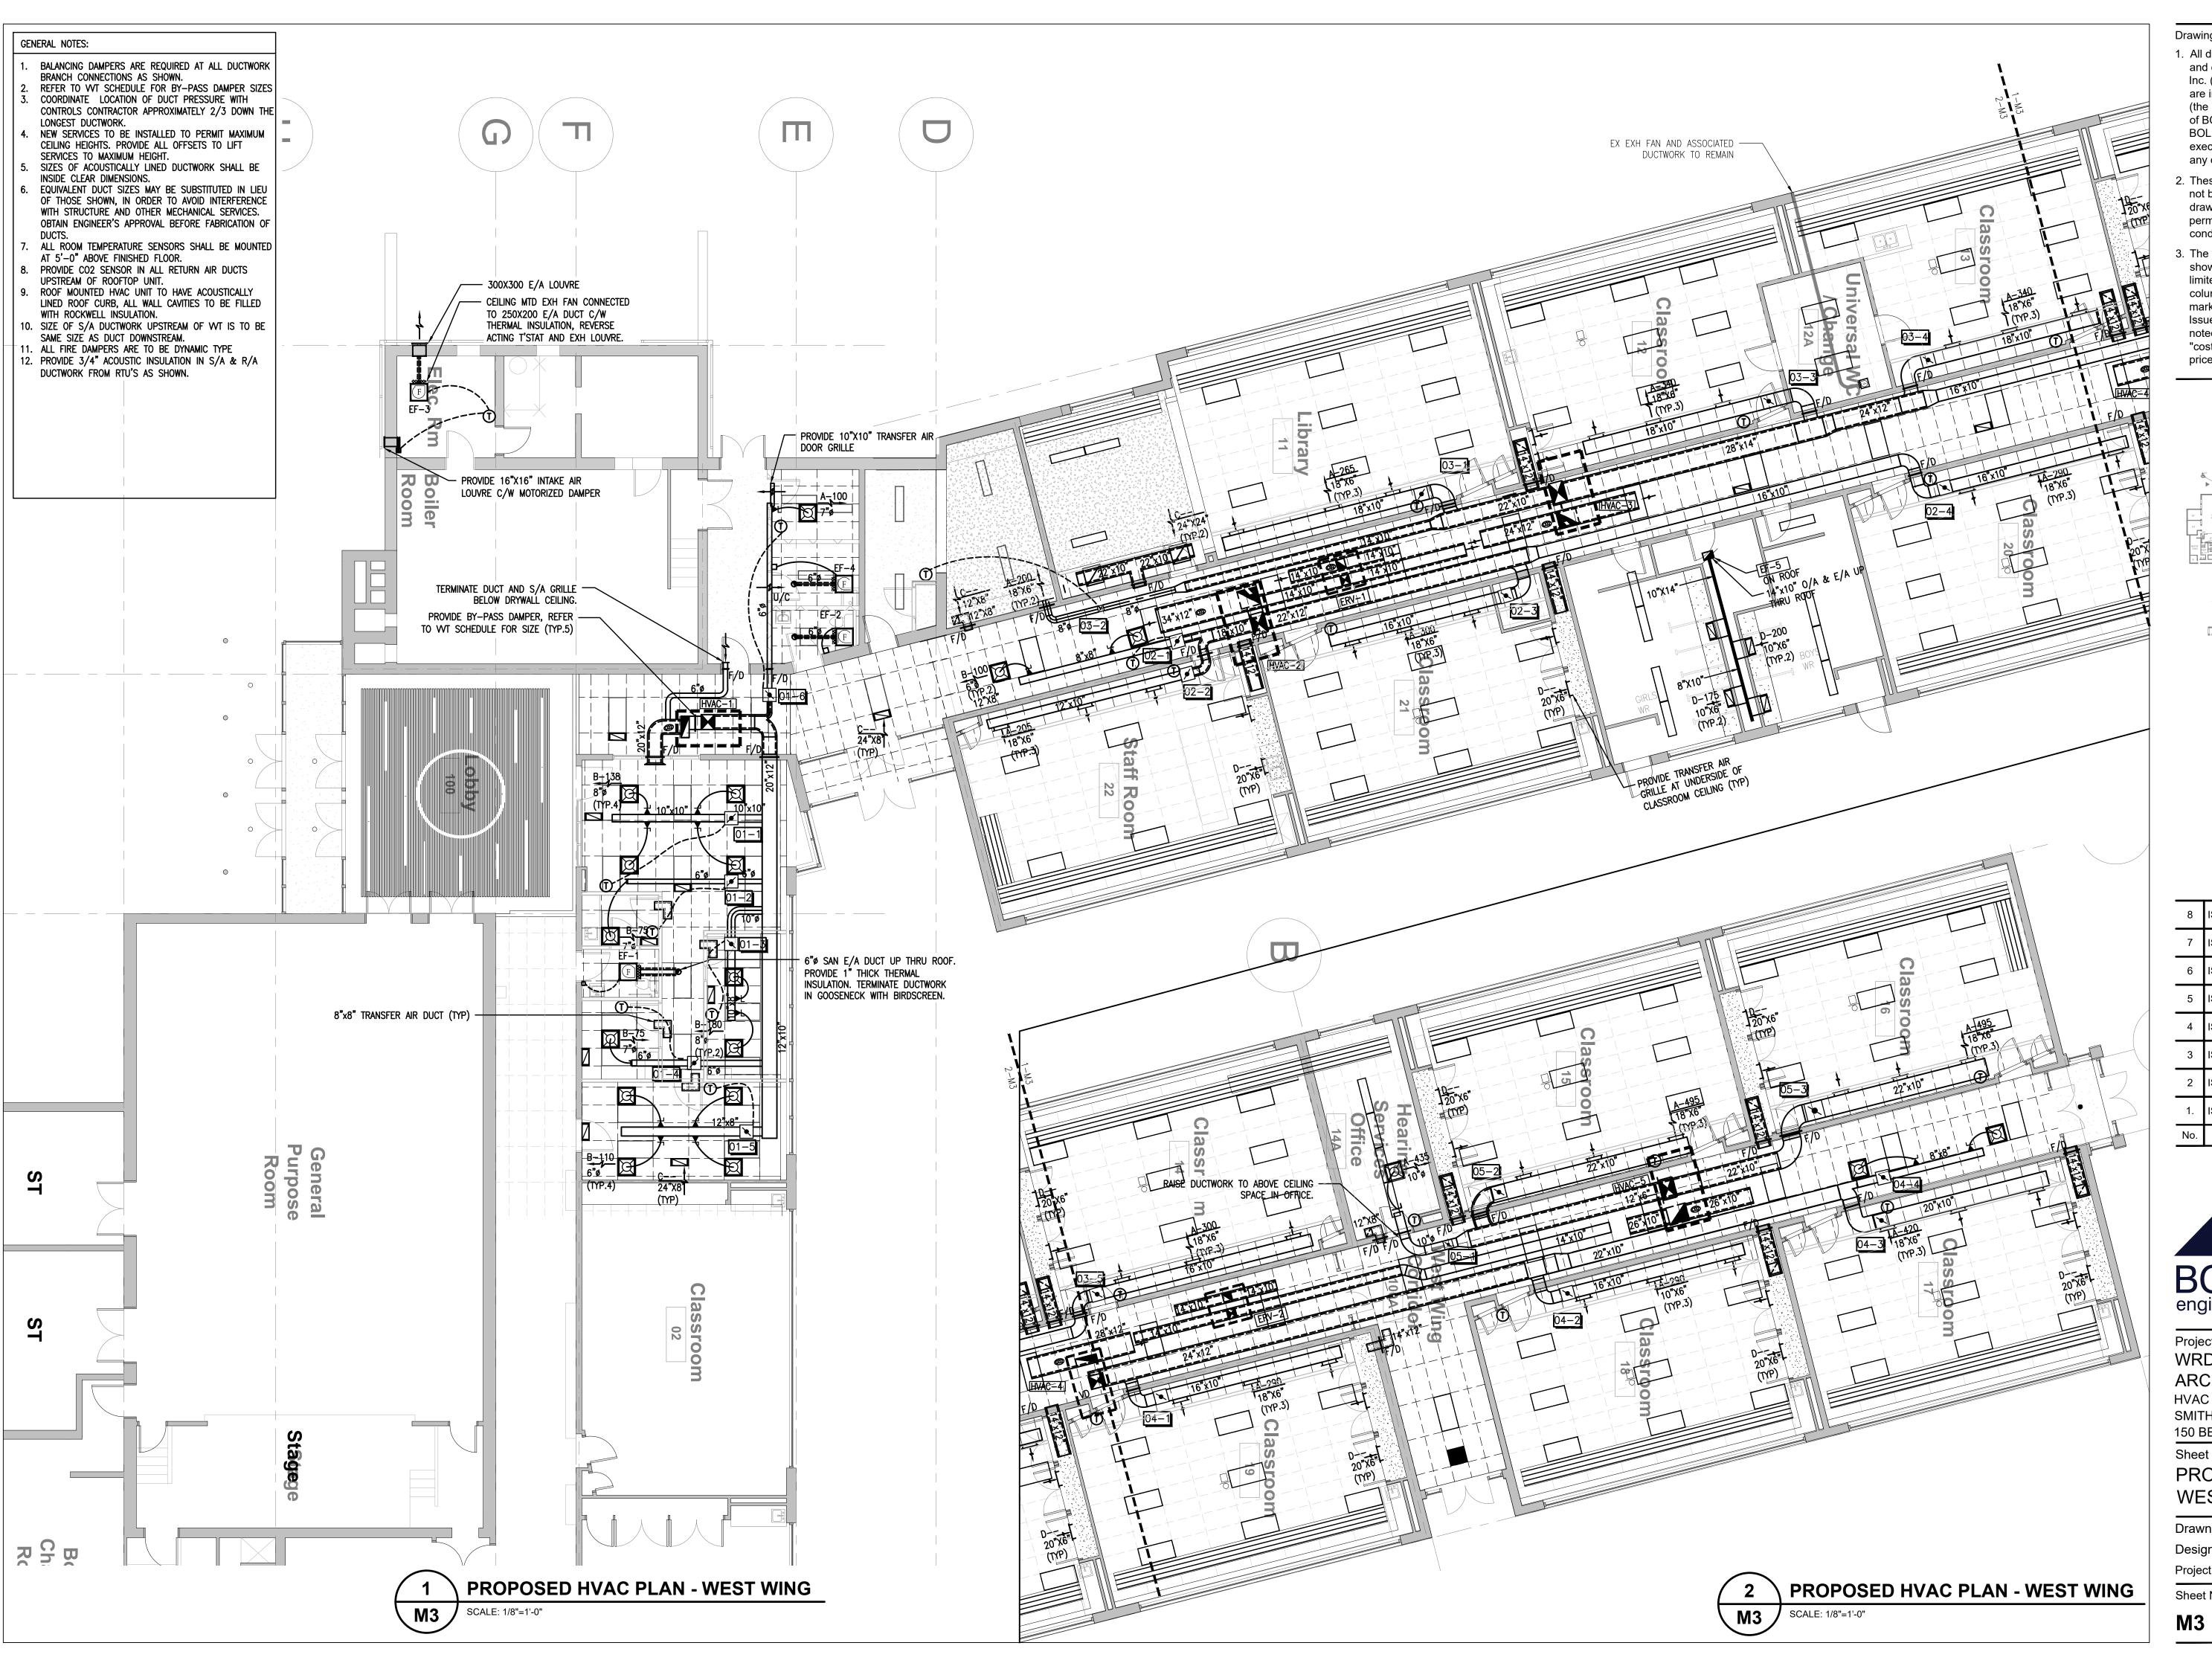

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Project Name

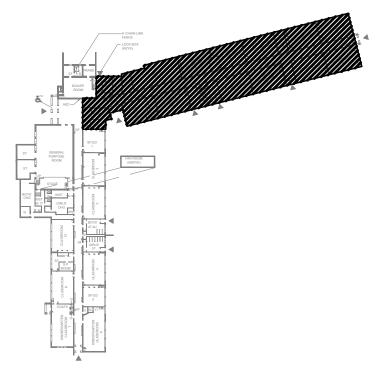WRDSB - WORKSHOP ARCHITECTURE

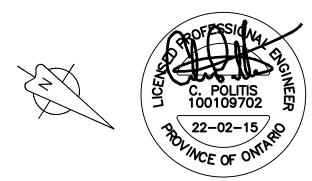
**HVAC UPGRADES & INTERIOR RENOVATIONS** SMITHSON PUBLIC SCHOOL 150 BELLVIEW AVENUE, KITCHENER

Sheet Title


PROPOSED HVAC PLANS -**WEST WING** 


Drawn By MS Scale 1/8"=1'-0" Designed By MS Date November 26, 2020

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Project Name WRDSB - WORKSHOP

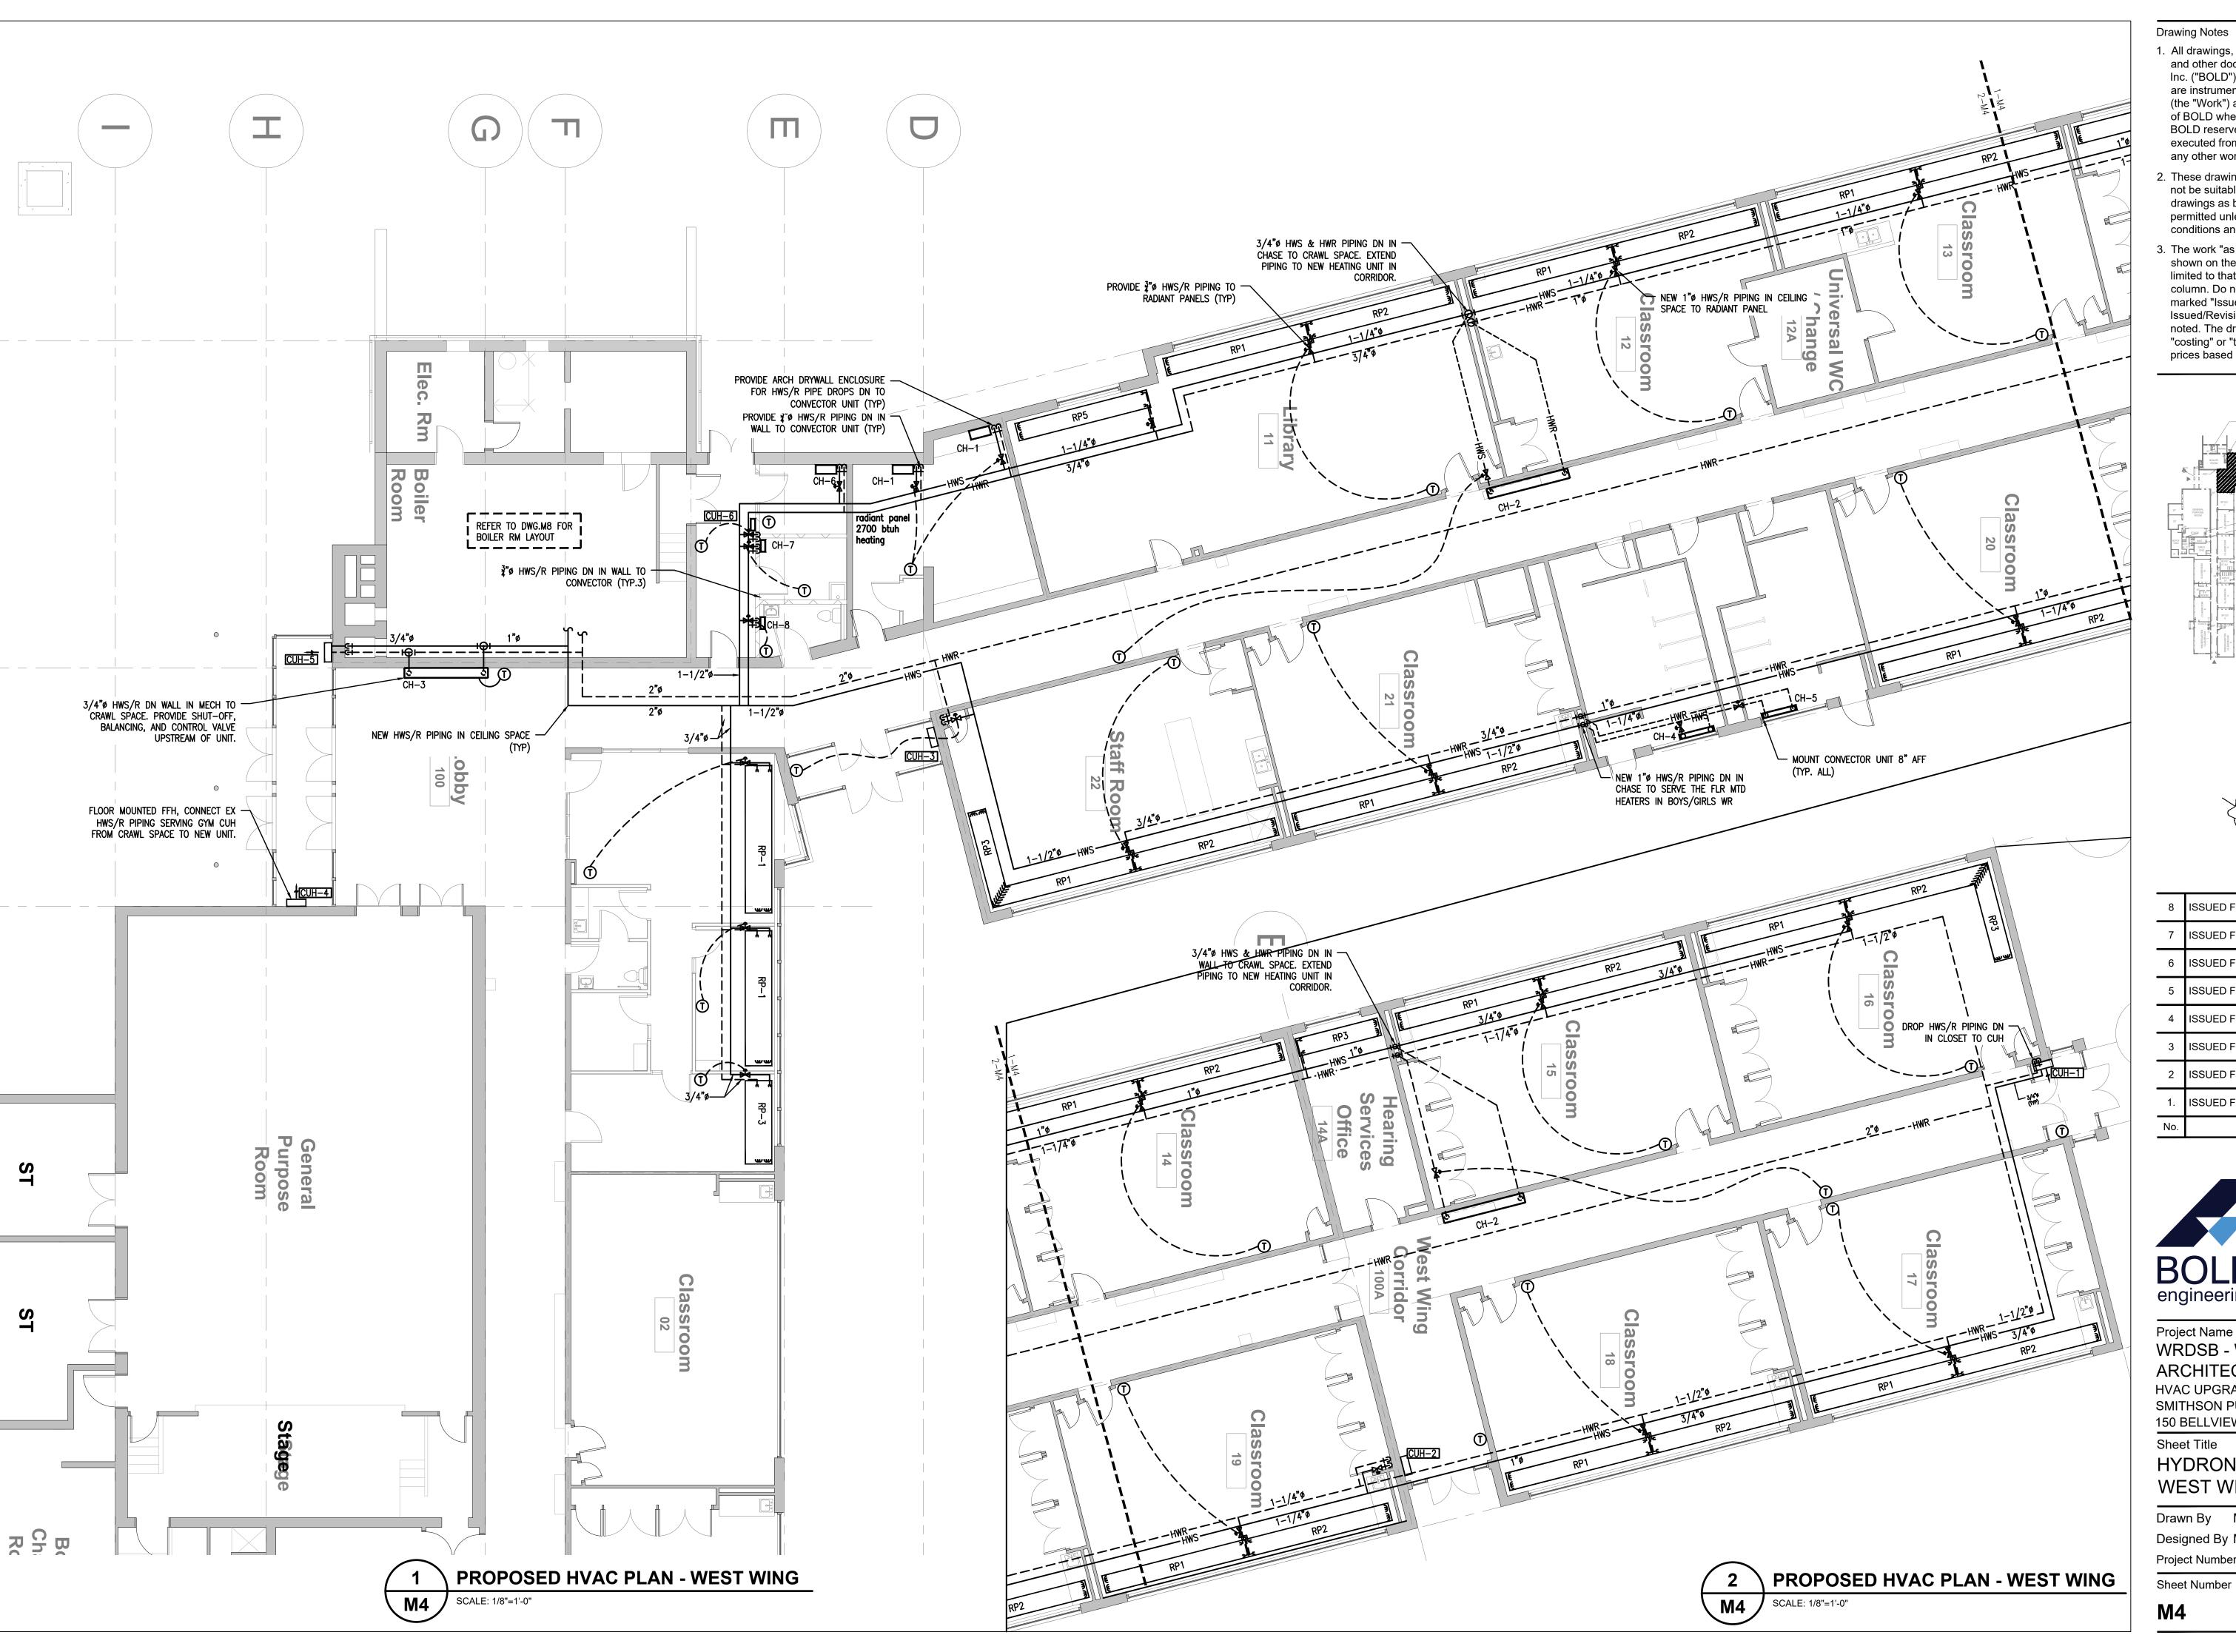
ARCHITECTURE **HVAC UPGRADES & INTERIOR RENOVATIONS** SMITHSON PUBLIC SCHOOL

150 BELLVIEW AVENUE, KITCHENER

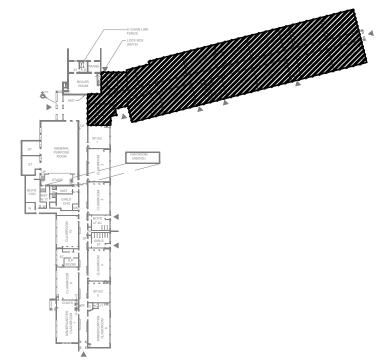
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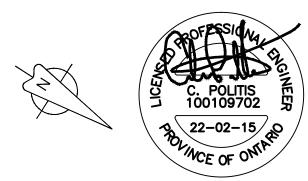
**HYDRONIC HVAC PLANS -WEST WING** 
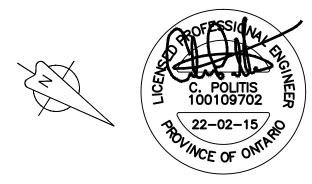
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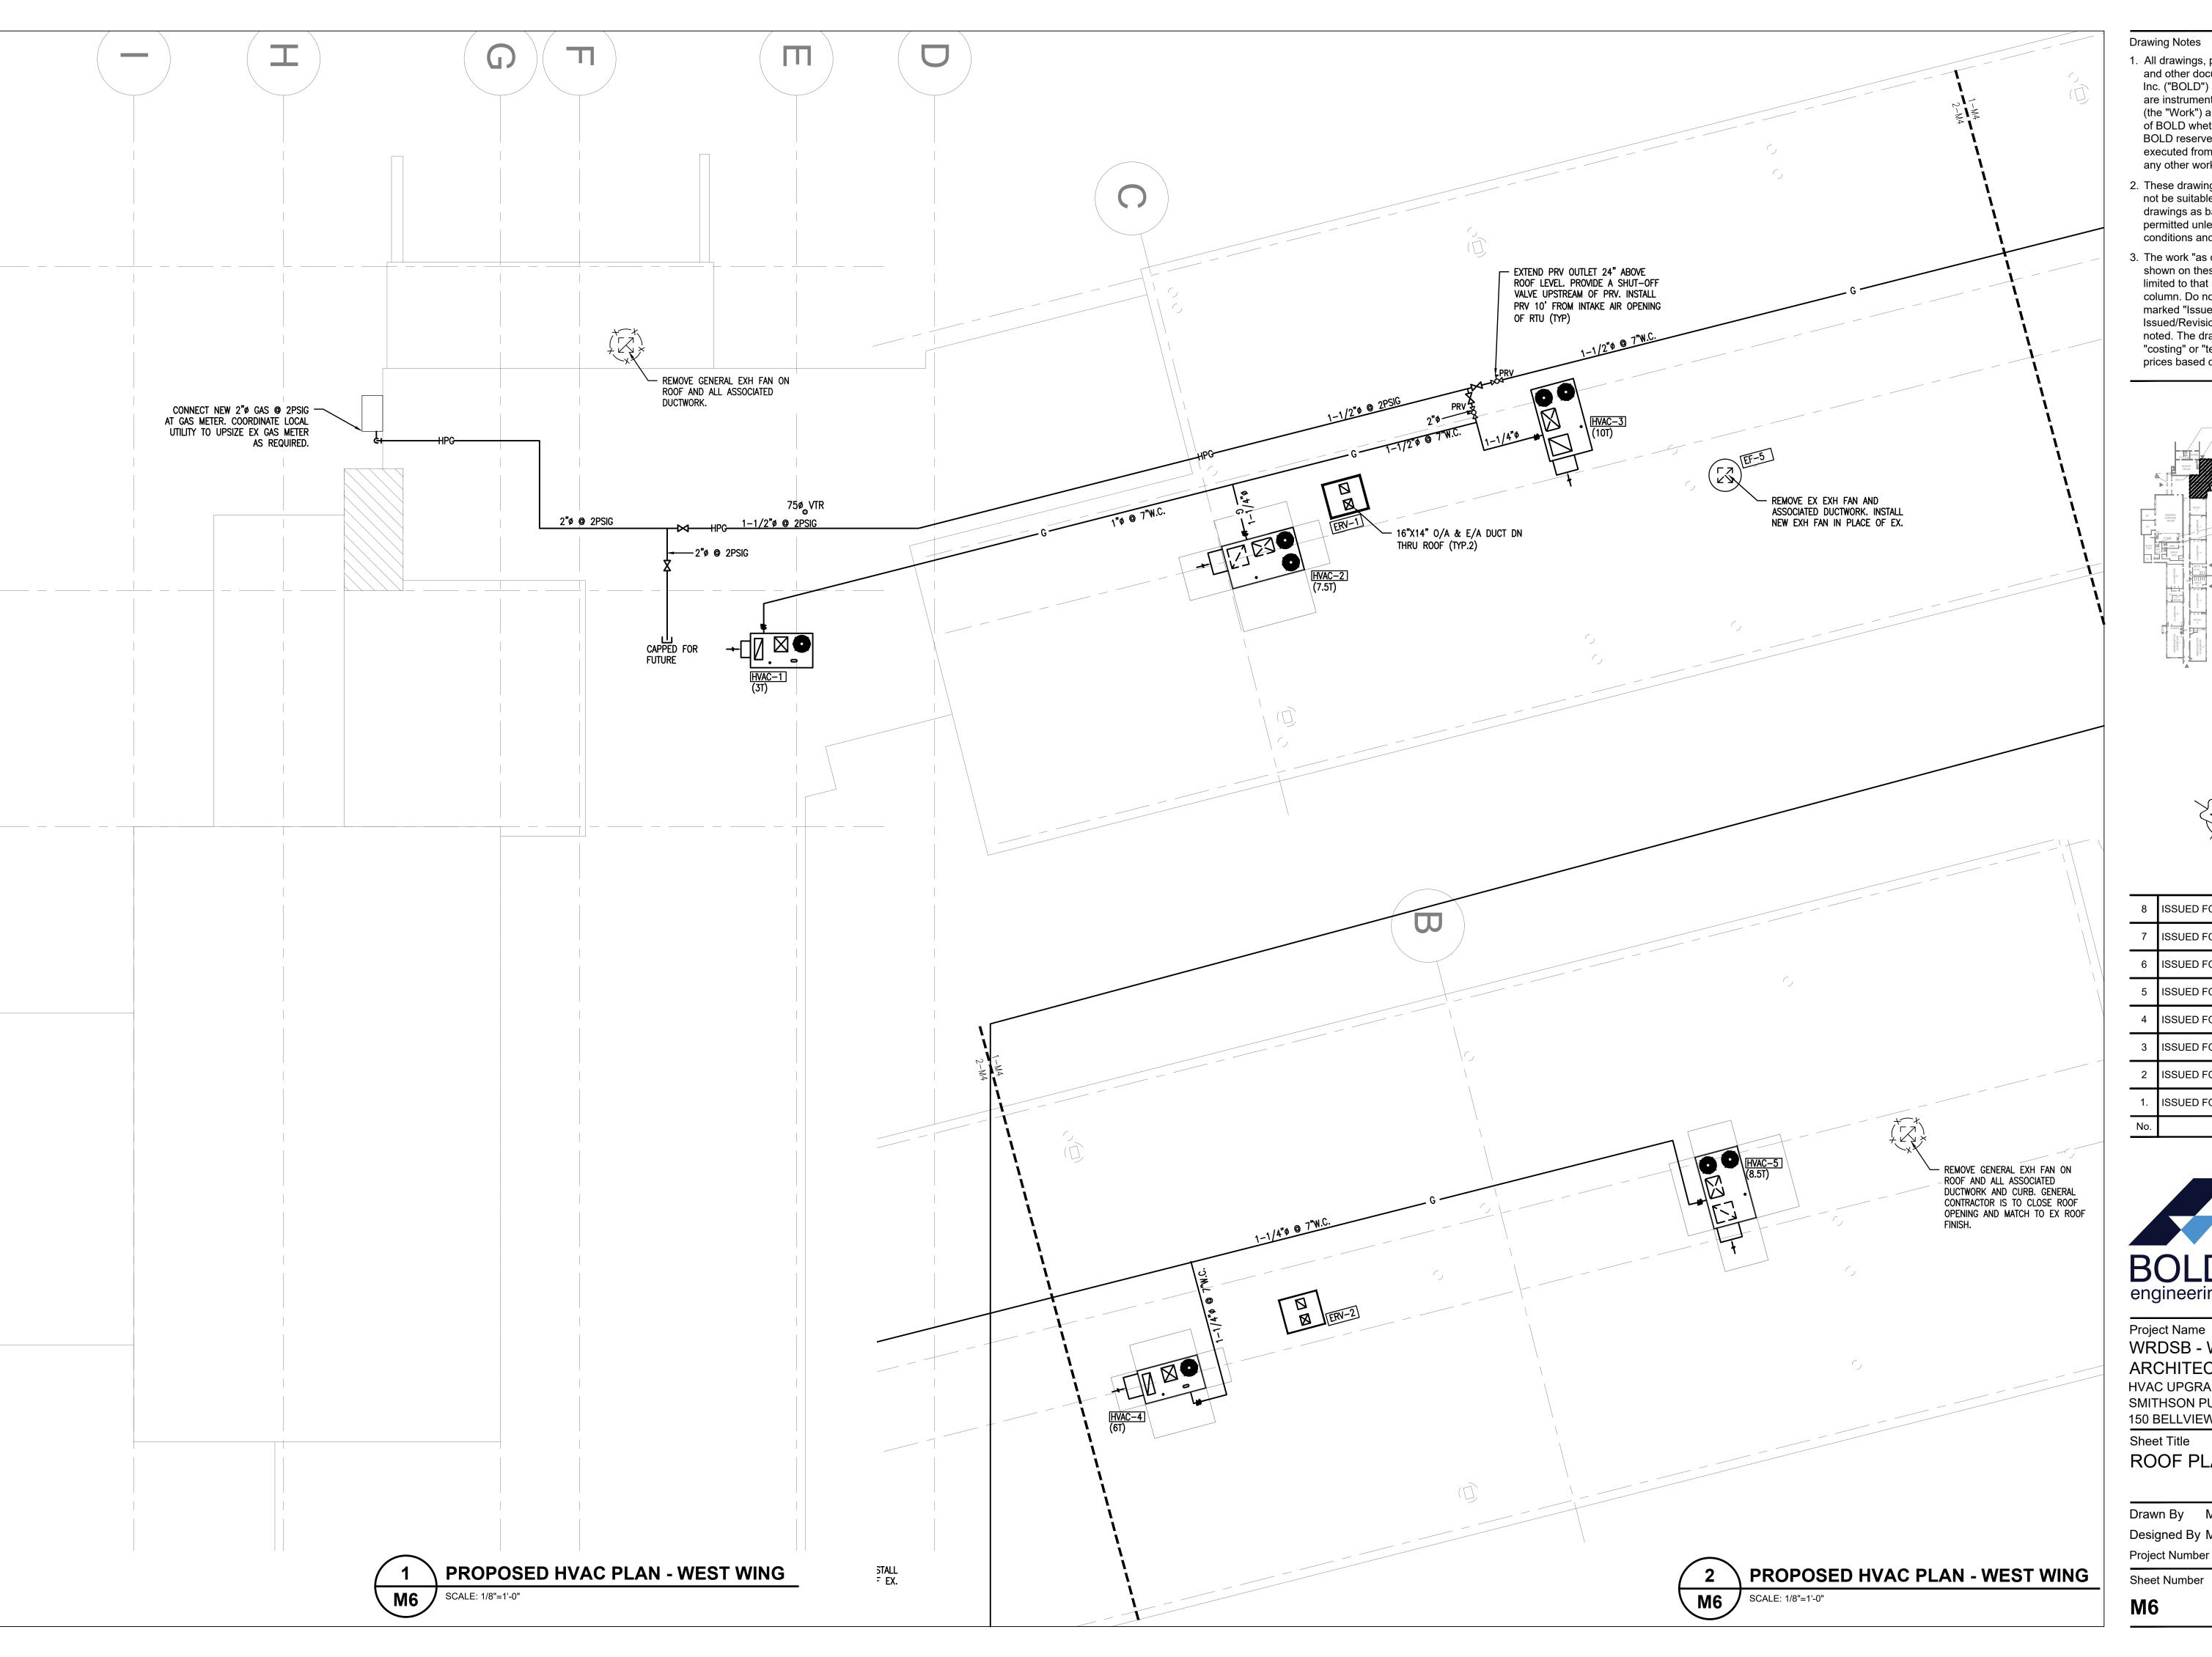
Project Name WRDSB - WORKSHOP ARCHITECTURE

**HVAC UPGRADES & INTERIOR RENOVATIONS** SMITHSON PUBLIC SCHOOL 150 BELLVIEW AVENUE, KITCHENER

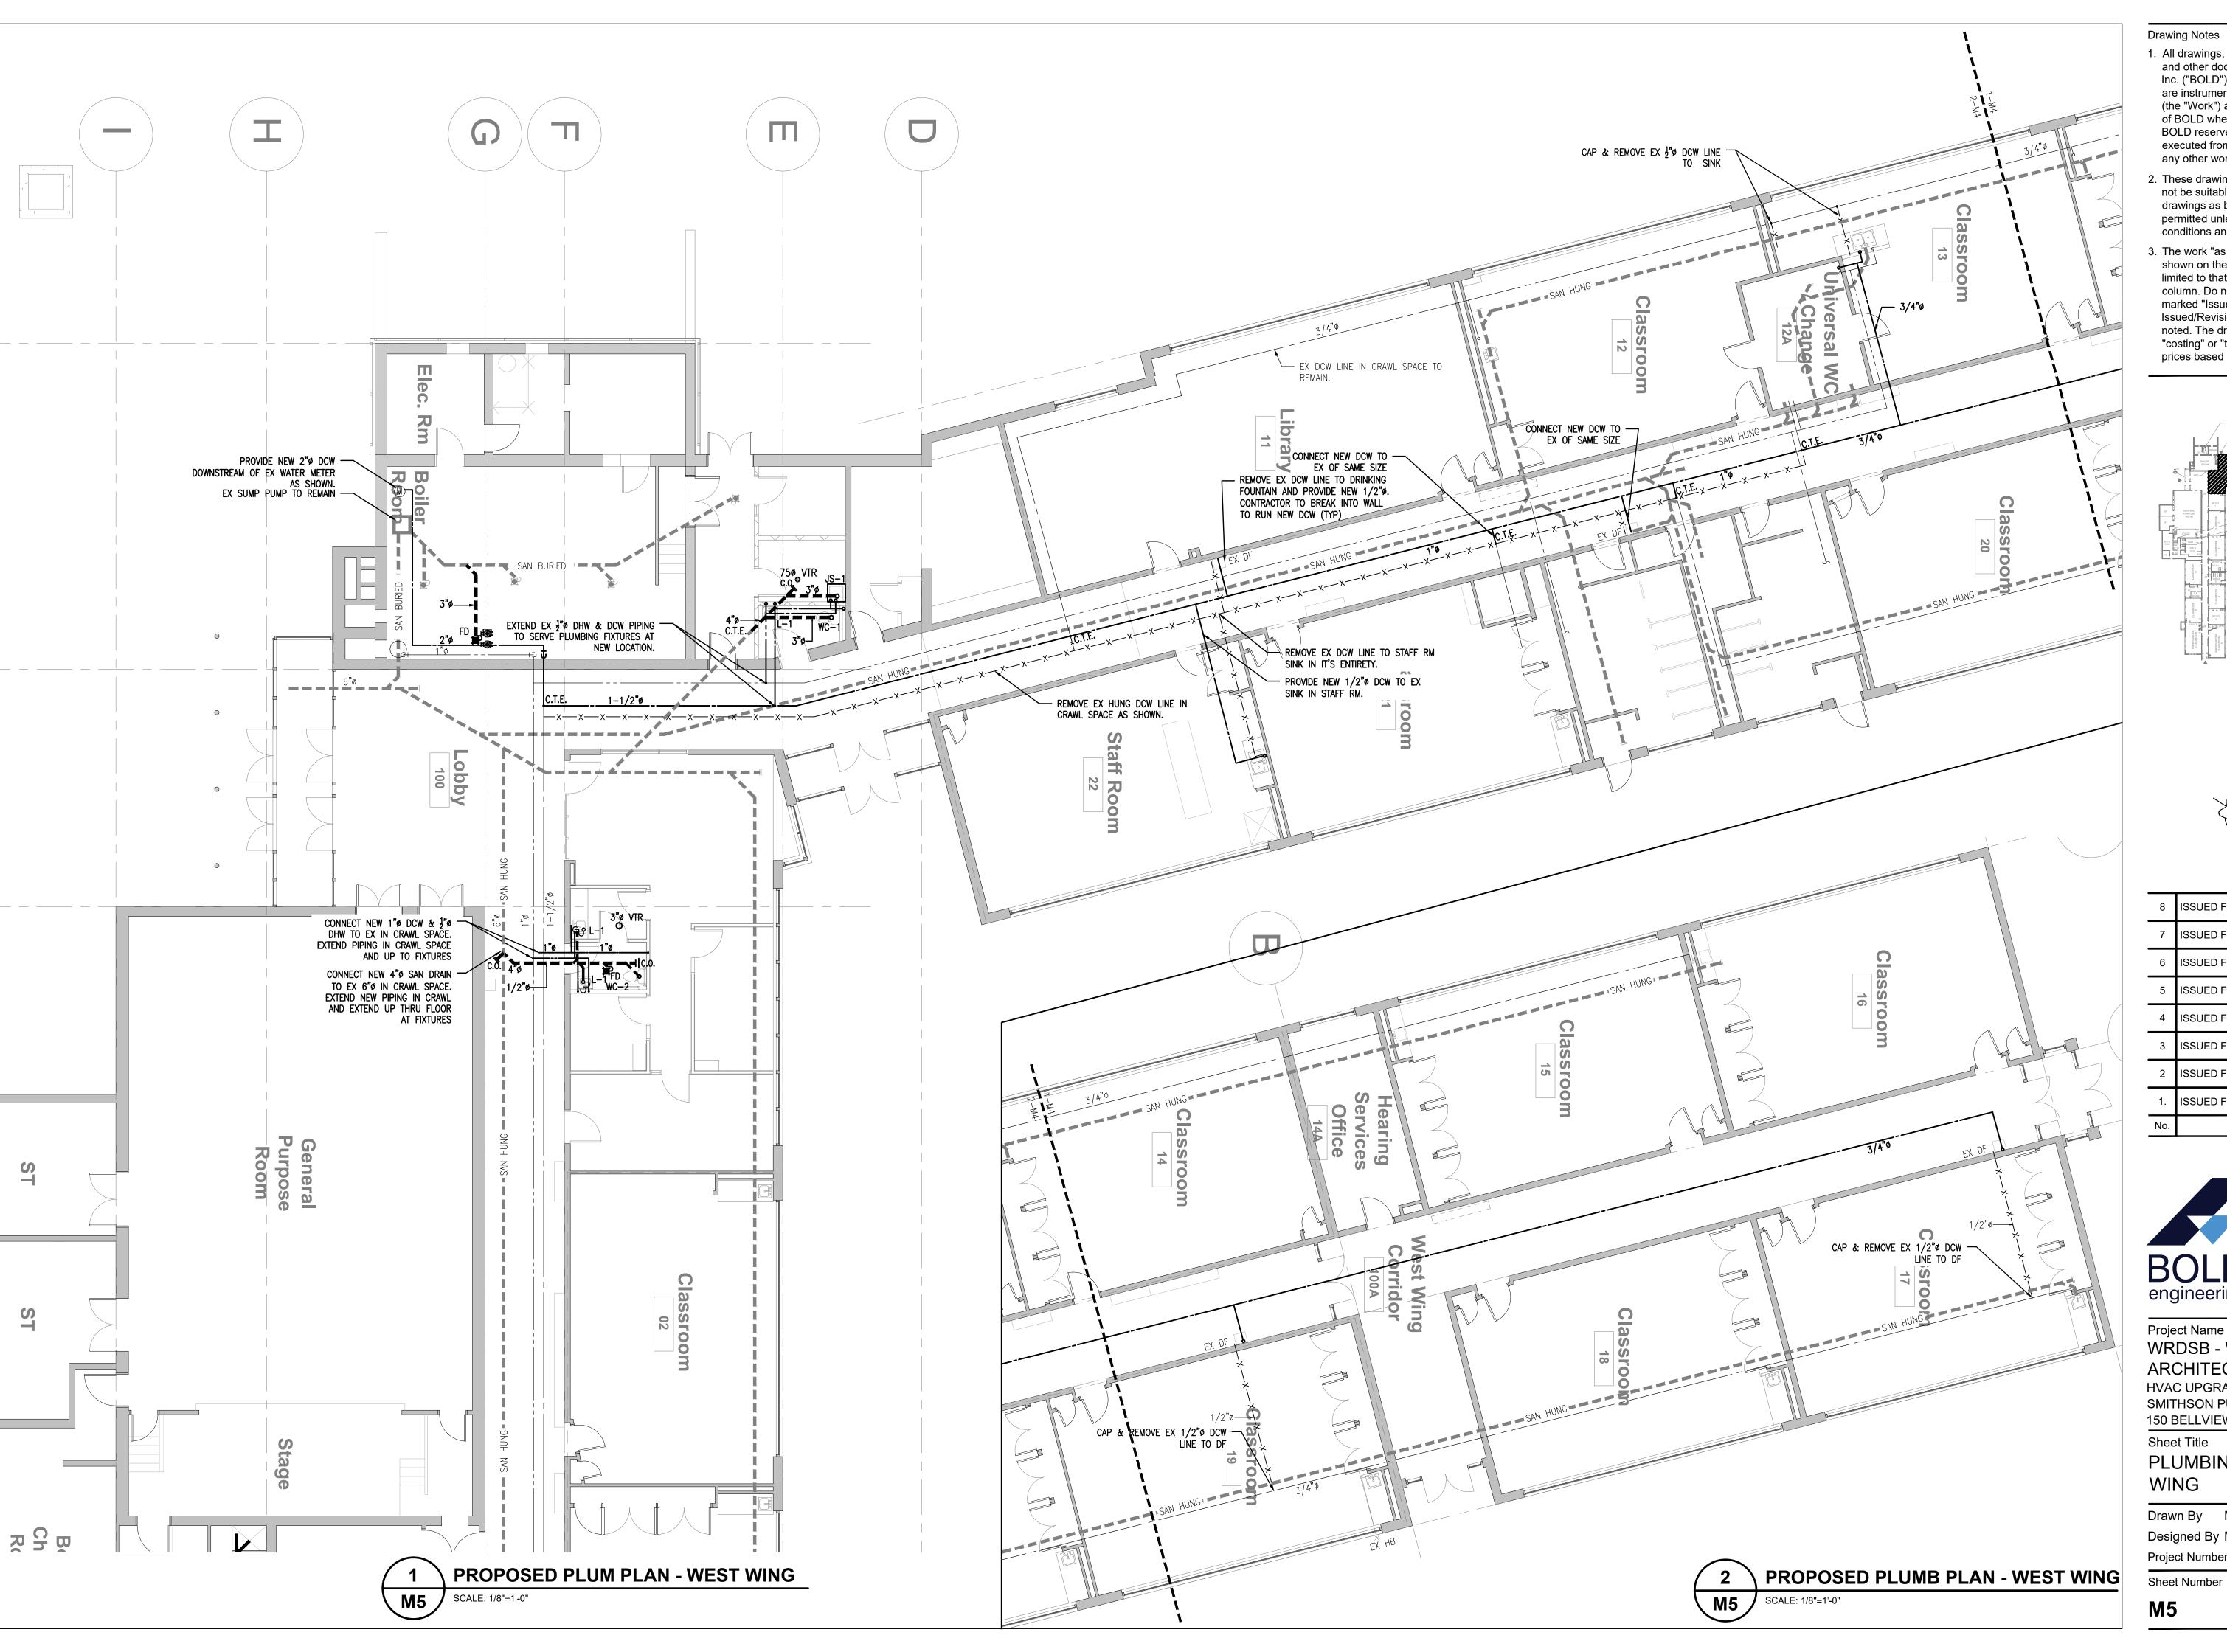
Sheet Title


PLUMBING PLAN - WEST WING
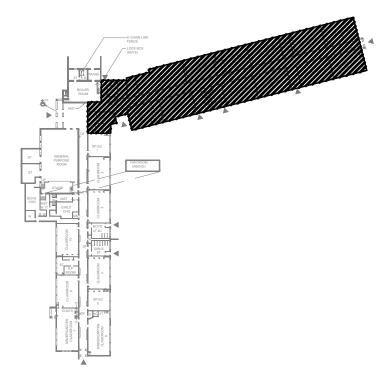
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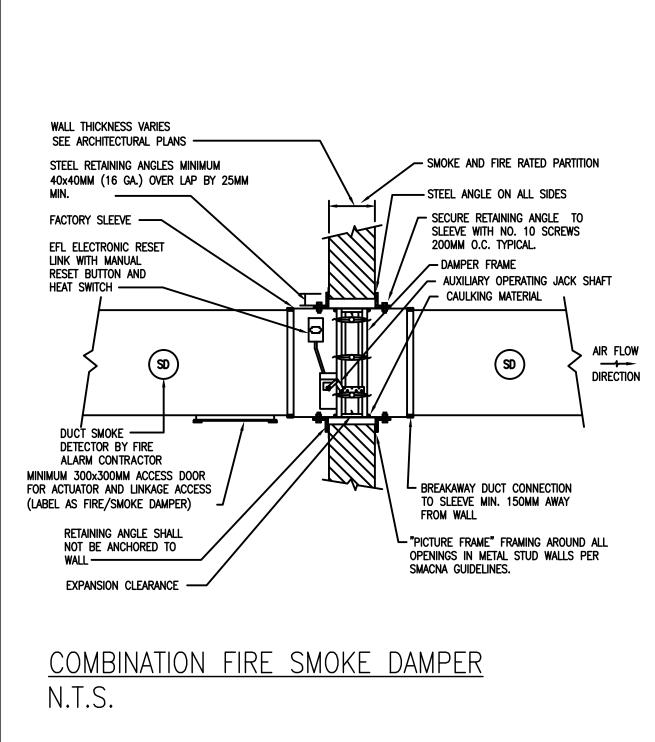
WRDSB - WORKSHOP ARCHITECTURE **HVAC UPGRADES & INTERIOR RENOVATIONS** 

SMITHSON PUBLIC SCHOOL 150 BELLVIEW AVENUE, KITCHENER

Sheet Title

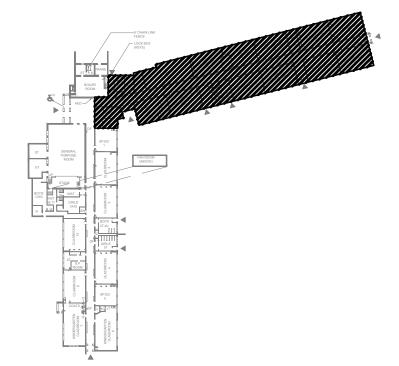**ROOF PLAN** 

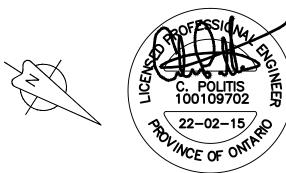Drawn By MS Scale 1/8"=1'-0" Designed By MS Date November 26, 2020




## 1. DAMPERS SHALL BE INSTALLED ACCORDING TO MANUFACTURER'S INSTALLATION REQUIREMENTS.


2. DAMPERS ARE TO BE INSTALLED IN STRICT ACCORDANCE WITH THE

ULC REQUIREMENTS.


- 3. ALL FIRE/SMOKE DAMPERS AND THEIR RESPECTIVE DAMPER OPERATOR MECHANISMS SHALL BE ULC LABELED AND TESTED AS AN ASSEMBLY WITH THE DAMPER OPERATOR MECHANISM FASTENED TO THE DAMPER SLEEVE MEETING THE REQUIREMENTS SET IN ULC.
- 4. VERTICAL DAMPER SHOWN HORIZONTAL INSTALLATION SIMILAR.
- . SMOKE DAMPER INSTALLATION SIMILAR BUT WITHOUT RESETTABLE
- 6. DAMPER OPERATOR SHALL BE INTERLOCKED WITH ASSOCIATED FAN. UNLESS NOTED OTHERWISE.
- WALL OPENINGS TO BE DUCT DIMENSIONS PLUS 10MM PER METER.
- DIRECTION 8. GENERAL CONTRACTOR TO COORDINATE CEILING ACCESS DOORS AS REQUIRED TO ACCESS AND MAINTAIN DAMPER.
  - 9. DUCT SMOKE DETECTOR SHALL BE FURNISHED FOR EACH FIRE SMOKE DAMPER. SMOKE DETECTOR SHALL BE INSTALLED WITHIN 1.5 METERS OF THE FIRE SMOKE DAMPER.

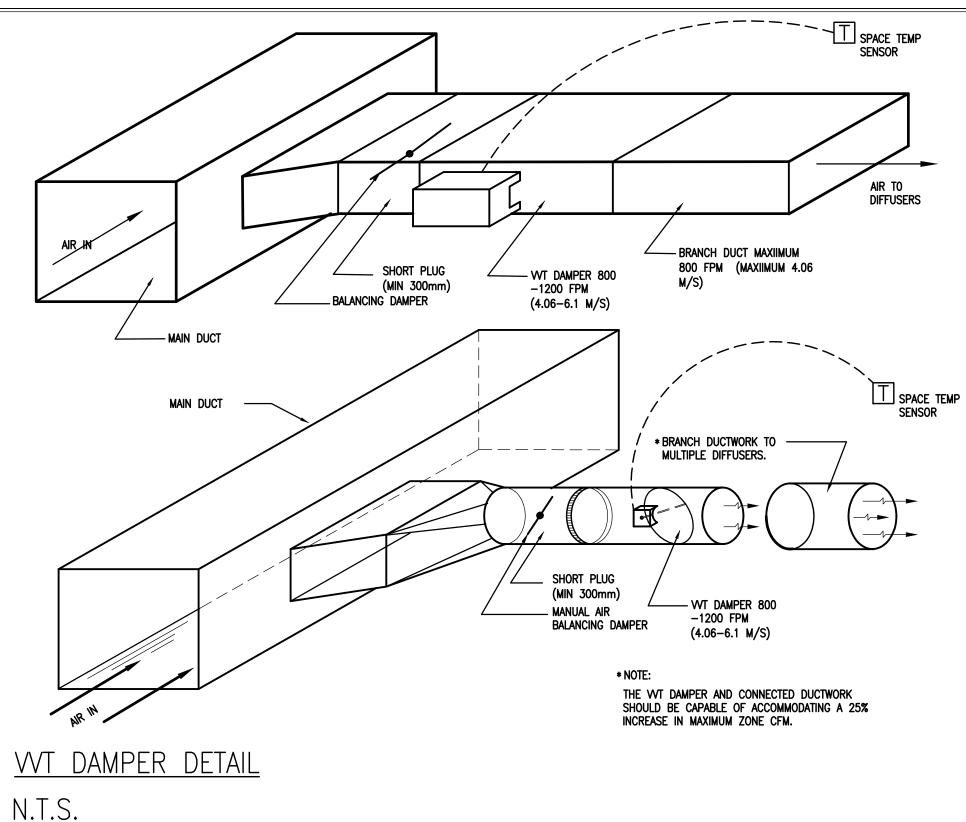


TYPICAL WT ROOF TOP UNIT DIAGRAM

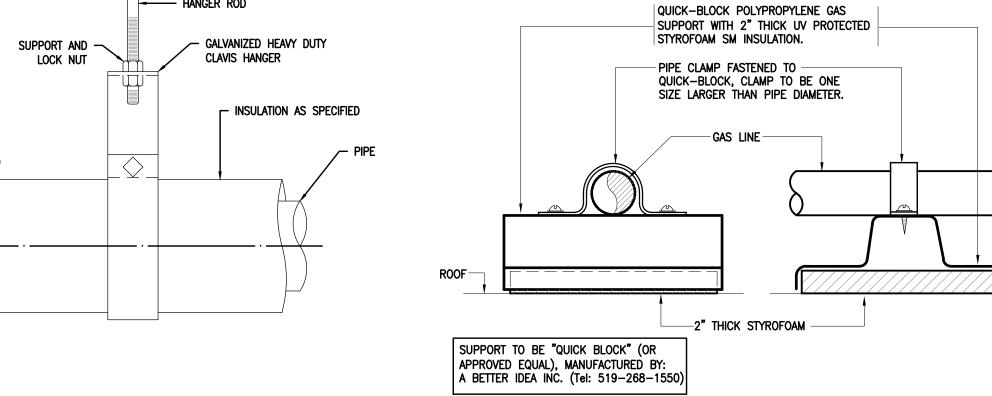



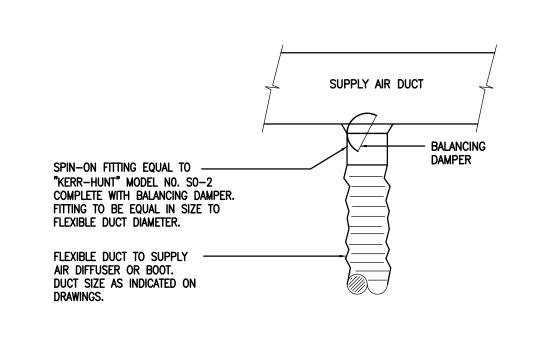

<u>typical spin—on fitting detail</u>

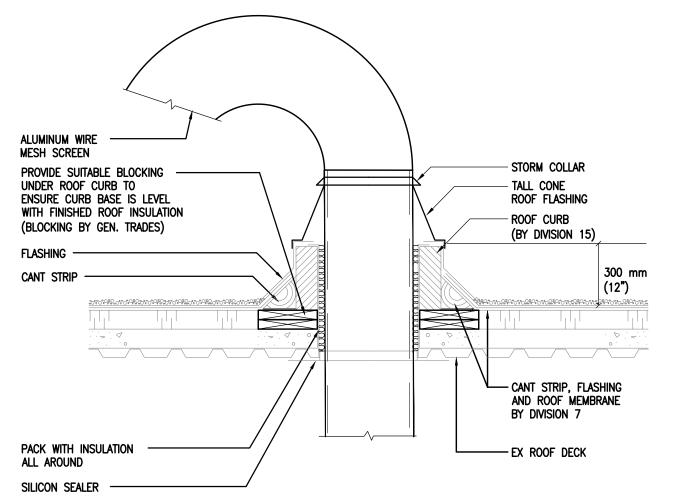

## EXHAUST DUCTWORK THROUGH ROOF DETAIL N.T.S.

NEW ROOFTOP UNIT -

S/A & R/A DUCTWORK PENETRATIONS ARE TO BE-

TIGHTLY FITTED WITH MAXIMUM 1/2" SPACE

RETURN AIR DUCT INTERNALLY

INSULATED DUCT AND OPEN TO CEILING

T-BAR CEILING

BY-PASS DAMPER REFER TO WT SCHEDULE FOR -

ZONE PANEL, FOR LOCATION


REFER TO PLAN ON THIS

INTERNALLY INSULATED DUCT (TYPICAL)


RUN DUCTWORK AT 12" ABOVE

CEILING (TYPICAL)

BETWEEN DUCT AND ROOF OPENING.

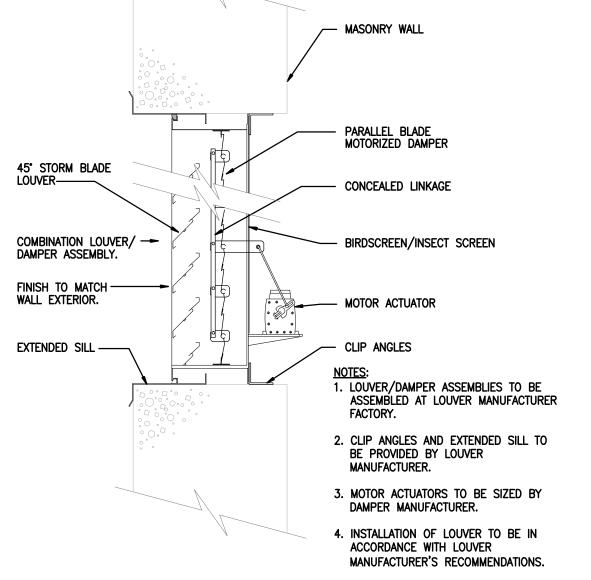





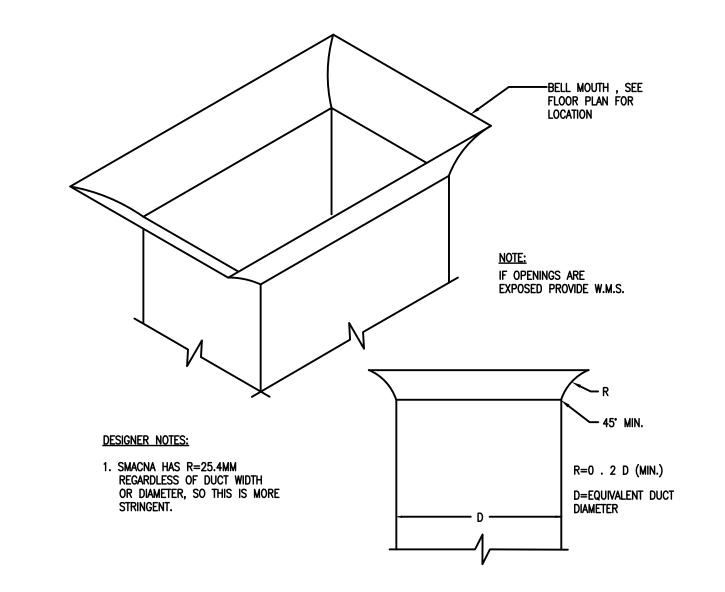

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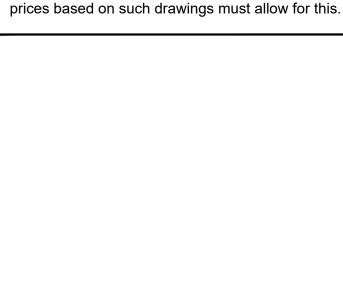
Revision



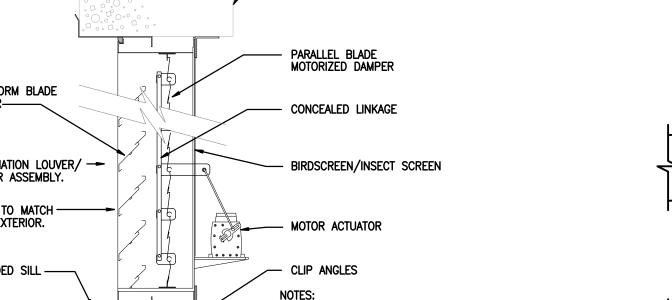

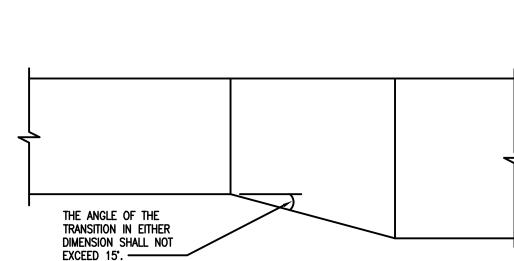

RETURN AIR BELL MOUTH FITTING DETAIL



- ROOM SENSOR FOR WT ZONE DAMPER. REFER TO DRAWING FOR LOCATIONS

COORDINATE WITH ENERGY CONTROLS FOR BAS

**Drawing Notes** 

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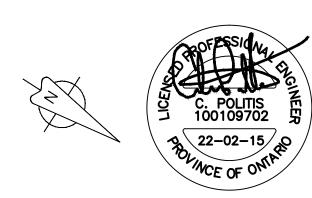
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**Project Name** 

WRDSB - WORKSHOP ARCHITECTURE

**HVAC UPGRADES & INTERIOR RENOVATIONS** SMITHSON PUBLIC SCHOOL

150 BELLVIEW AVENUE, KITCHENER

Sheet Title

MECHANICAL DETAILS PART 1 OF 2

Designed By MS Date November 26, 2020 Project Number B20-349.02A

**Sheet Number** 

- HANGER ROD - HANGER ROD GALVANIZED HEAVY DUTY SUPPORT AND -LOCK NUT INSULATION AS SPECIFIED

HANGER ROD SIZES PIPE SIZE 4" - 5" 6" -12" 2 1/2" - 3" HANGER ROD DIAMETER


					HANGE	R SPACIN	G					
PIPE SIZE	1"	1 1/4"	1 1/2"	2"	2 1/2"	3"	4"	5"	6"	8"	10"	12"
MAXIMUM SPACING	7'	8'	9'	10'	11'	12'	14'	16'	17'	19'	22'	23'

1/2"

PIPE HANGER DETAIL

CARBON STEEL PIPE SPACER

N.T.S.

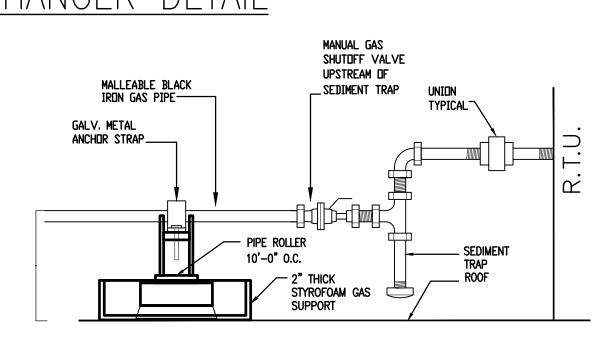

GAS CONNECTION @ RTU



TOUCH-UP PAINT

TO TOUCH UP PANELS SPRAY PAINT INTO A CLEAN RECEPTACLE AND APPLY LIGHTLY TO SCRATCHES WITH THE SUPPLIED BRUSH.

### DO NOT APPLY DIRECTLY FROM CAN TO PANEL.

DUE TO THE DIFFERENCE IN PRODUCTS, LIQUID VERSUS POWDER COATING A SHINE DIFFERENCE WILL BE MORE EVIDENT IF SPRAYED DIRECTLY FROM CAN. PAINT IS SHIPPED IN SPRAY CAN TO PREVENT FREEZING ONLY, NOT FOR APPLICATION.

## GENERAL NOTES

SHOP DRAWINGS MUST BE AVAILABLE TO THE INSTALLERS PRIOR TO THE START OF PIPING ROUGH IN. PIPING FOR RADIANT PANELS MUST NOT CHANGE FROM THE MECHANICAL DRAWINGS FOR THE PROJECT.

RADIANT PANEL SHOP DRAWINGS, ARCHITECTURAL DRAWINGS AND MECHANICAL DRAWINGS MUST BE CONSULTED BEFORE INSTALLATION BEGINS. REFER TO MECHANICAL DRAWINGS FOR PIPE SIZES AND VALVE LOCATIONS. ANY PANEL INSTALLED AGAINST EXTERIOR WALLS SHOULD HAVE THE FIRST TUBE SUPPLIED NEAREST THE WALL.

INSTALL RADIANT PANELS WITH FEMALE EDGE TOWARD EXTERIOR WALL. PLEASE NOTE THAT ALL PANELS HAVE A RED LABEL INDICATING THE FEMALE EDGE.

WIRE EMPLOYED TO SUSPEND THE RADIANT CEILING PANEL FROM THE EXISTING STRUCTURE. THE STANDARD MATERIAL IS 2.64mm (12 GAUGE) GALVANIZED, SOFT ANNEALED STEEL WIRE, CONFORMING TO ASTM A 641M OR A 641. VERTICAL SUSPENSION OF 1 (ONE) WIRE PER CROSS-BRACE FOR PANELS OF A WIDTH EQUAL TO OR LESS THAN 600mm (24"). PANELS OVER 600mm (24") REQUIRE A MINIMUM OF 2 WIRE HANGERS PER CROSS-BRACE. MINIMUM OF 2 WIRE HANGERS PER PANEL. WIRE HANGERS ARE TO BE SUSPENDED TO A MAXIMUM OF 1200mm (4') ON CENTRE. OR AS PER SEISMIC ENGINEER'S REQUIREMENTS.

CROSS BRACING ON RADIANT PANELS:

 2 BRACES UP TO 1220mm 3 BRACES 1221mm TO 2900mm 4 BRACES 2901mm TO 4114mm 5 BRACES 4115mm TO 4885mm

FOR CUTTING OF RADIANT PANELS USE A CIRCULAR SAW WITH CARBIDE TIPPED BLADE. CUT WITH THE FINISH SURFACE FACING THE SAW. ENSURE YOU PROTECT THE FINISH SURFACE BEFORE CUTTING BEGINS.

WHEN PANELS REQUIRE SITE CUTTING, FOLLOW THESE STEPS:

 INSTALL ALL BUT THE LAST PANEL, MEASURE LENGTH REQUIRED. CUT LAST PANEL TO THE REQUIRED LENGTH USING PROCEDURE LISTED IN PART (

• INSTALL FINAL PANEL IN CEILING.

SUPPLIER IS RESPONSIBLE ONLY FOR THE SUPPLY OF RADIANT PANELS. OTHERS ARE

TO SUPPLY AND INSTALL THE FOLLOWING: NECESSARY PIPING BETWEEN PANELS (OTHER THAN MANUFACTURER)

INTERCONNECTORS, AS SHOWN) PIPING FROM PANELS TO SUPPLY AND RETURN MAINS.

 SPECIFIED INSULATION AND HANGER WIRES. SUSPENDED CEILING GRIDS AND PANEL SUPPORT MOULDINGS.

GENERAL SPECIFICATIONS - LINEAR PANELS

HE ALUMINUM PLANKS INCORPORATE A TUBE SADDLE CHANNEL AS AN INTEGRAL PART OF THE PROFILE. THE COPPER TUBE IS SEATED INTO THIS CHANNEL AND HELD IN DIRECT THERMAL CONTACT WITH THE EXTRUSION A NON-HARDENING HEAT PASTE BETWEEN COPPER AND ALUMINUM, AS WELL AS THE FACE PROFILE, ENSURES EVEN HEAT DISTRIBUTION TO THE ACTIVE PANEL PROVIDING OVERALL THERMAL EFFICIENCY.

PANEL PLANKS ARE TONGUE-AND-GROOVED TO PROVIDE A CLEAN JOINT LONGITUDINALLY. THEY ARE HELD TOGETHER USING A SPECIAL CLAMPING SYSTEM.

LINEAR PANELS CAN BE PROVIDED IN MULTIPLE LENGTHS OF UP TO 4877mm (16') AND WIDTHS IN MULTIPLES OF 102mm (4"), AND 152mm (6"). AN OPERATING WEIGHT OF 9.76 kg/m2 (2Ib/ft2) SHOULD BE USED WHEN CALCULATING THE REQUIREMENTS FOR CLAMPING AND SUSPENSION COMPONENTS.

MATERIALS OF CONSTRUCTION:

PIPEWORK: PANELS: PANEL JOINT STRIPS:

16mm (5/8") O.D. COPPER TUBE. EXTRUDED ALUMINUM PLANKS WITH PROFILE FACE CADMIUM OR ZINC-PLATED STEEL SPRINGS. CADMIUM OR ZINC-PLATED STEEL SPRINGS.

PANEL SUSPENSION CLIPS: PIPEWORK CLIPS: CROSS BRACE:

CADMIUM OR ZINC-PLATED STEEL SPRINGS. EXTRUDED ALUMINUM 38mmx19mmx1.6mm (1½"x¾"x½")
STANDARD COLOUR IS AN OFF-WHITE ELECTROSTATIC

COLOUR: SUSPENSION SYSTEM: INSULATION:

TESTING:

COLOUR:

POLYESTER POWDER COATING. STANDARD T-BAR INSTALLATION AS PER ENGINEER'S SPECIFICATIONS (USUALLY FOIL-BACKED FIBERGLASS).

RADIANT PANEL INSTALLATION INSTRUCTIONS

AIRTEX RADIANT HEATING PANELS ARE FINISHED WITH A BAKED POLYESTER POWDER COATING THE PANEL SURFACE MUST NOT COME IN CONTACT WITH BARE SKIN. PERSPIRATION OR GREASE FROM UNGLOVED HAND WILL LEAVE A MARK ON THE PANEL.

INSTALLATION PERSONNEL MUST WEAR CLEAN WHITE GLOVES WHEN HANDLING THE RADIANT

USE HEAT PAD BETWEEN RADIANT PANEL AND COPPER PIPE WHEN MAKING SOLDER CONNECTION. HEAT WILL DAMAGE BAKED ENAMEL FINISH.

ADDITIONAL RADIANT PANEL INFORMATION

ALL PANELS MUST BE PNEUMATICALLY TESTED BY THE

MECHANICAL CONTRACTOR AFTER INSTALLATION ACCORDING TO THE ENGINEER'S TESTING PROCEDURE.

AS PER ENGINEER'S SPECIFICATIONS. ENSURE ALL AIR CLEANING & FLUSHING:

IS VENTED TO MAINTAIN NOISELESS OPERATION. AIRTEX STANDARD WHITE, AS PER COLOUR SAMPLE.

JUSE 2 WIRE HANGERS ON EACH CROSS BRACE IF PANEL IS OVER 610mm WIDE OR AS PER SEISMIC ENGINEER'S REQUIREMENTS FINE LINE ACCUSTIC TALE GRID SYSTEMS (%6") ARE NOT COMPATIBLE WITH RADIANT PANEL INSTALLATION RADIANT PANEL LUSE A MINIMUM OF 1 / WIRE HANGER PER ANGLE BY DIVISION CROSS BRACE CLIP BY OTHERS CLIP BY 9. DO NOT OVER TORQUE MOUNTING SCREWS AS -ALUMINUM CROSS BRACE AIRTEX THIS WILL DISTORT MOULDING ##<u>```````</u> YNON-HARDENING HEAT -T-BAR BY PASTE BETWEEN TUBING DTHERS AND ALUMINUM PERIMETER T-BAR INSTALLATION

CONNECTION BY

SUPPLY & RETURN


CONTRACTOR IS TO


ENSURE EVEN FLOW THROUGH ALL CIRCUITS


CONTRACTOR


HEADER BY MECHANICAL


MECHANICAL CONTRACTOR

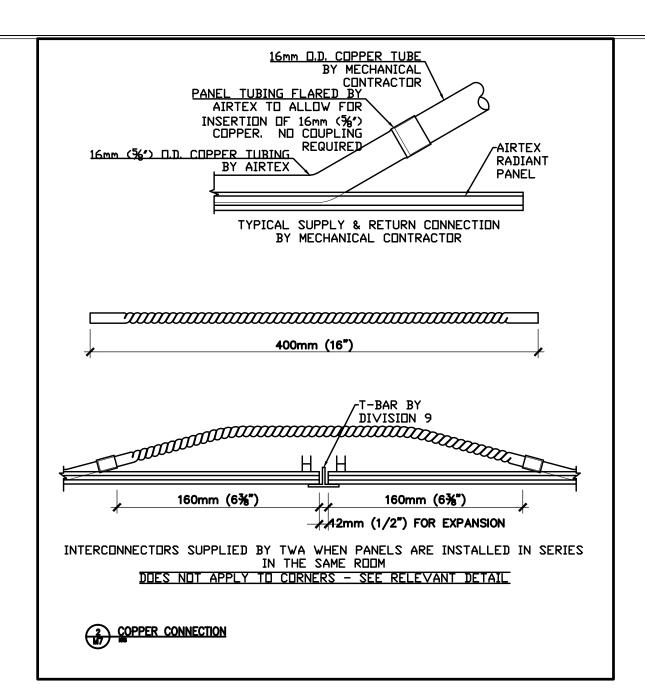

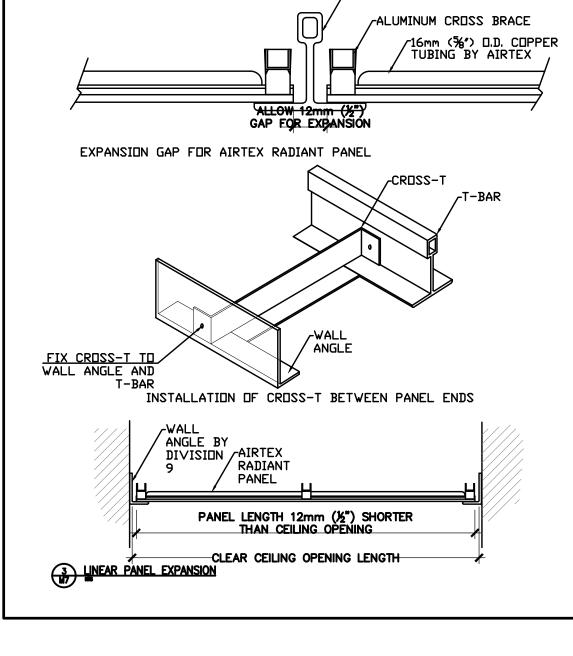

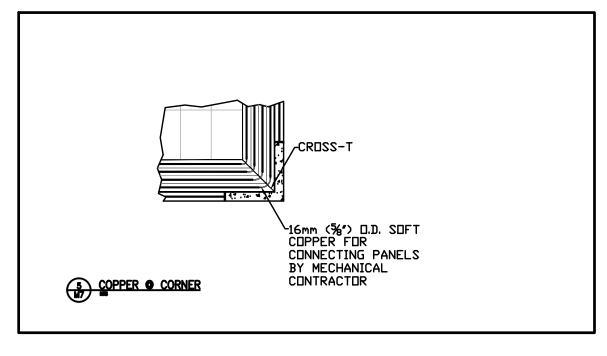


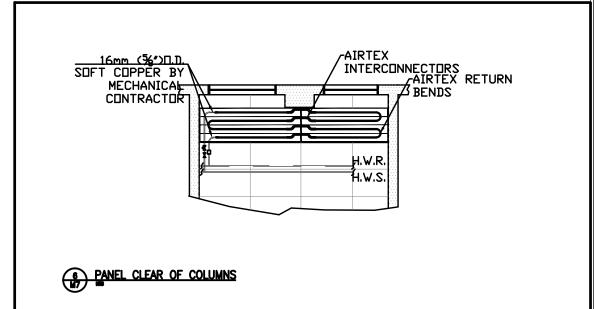


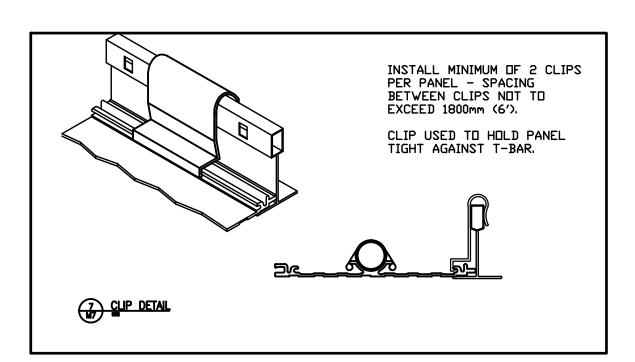



INTERCONNECTORS


4 LINEAR PANEL CIRCUITRY

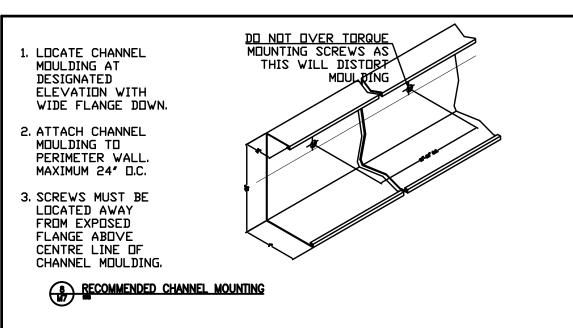

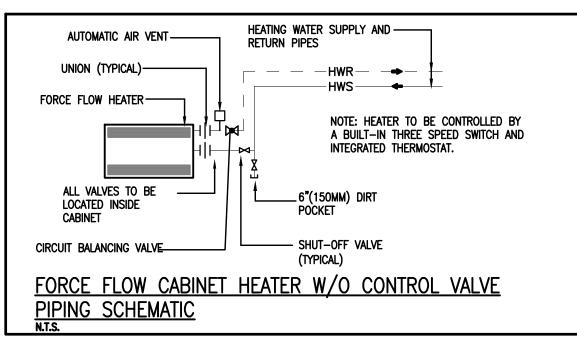

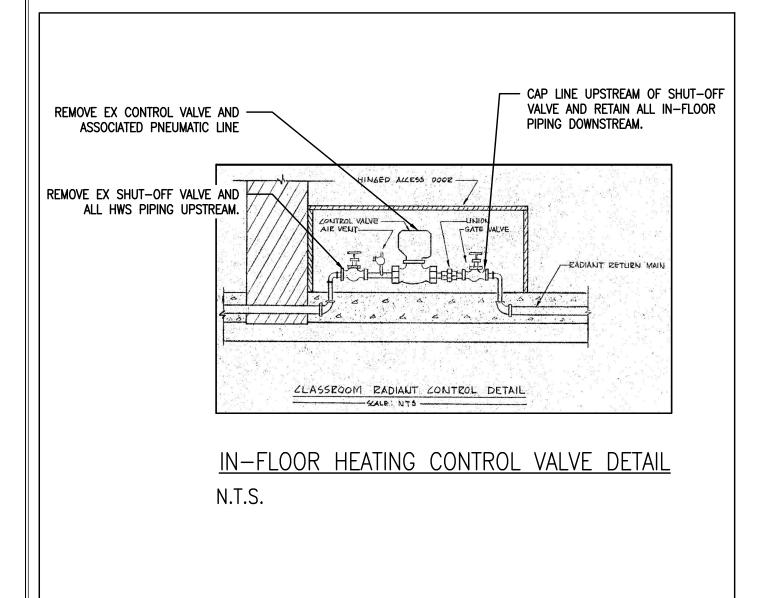


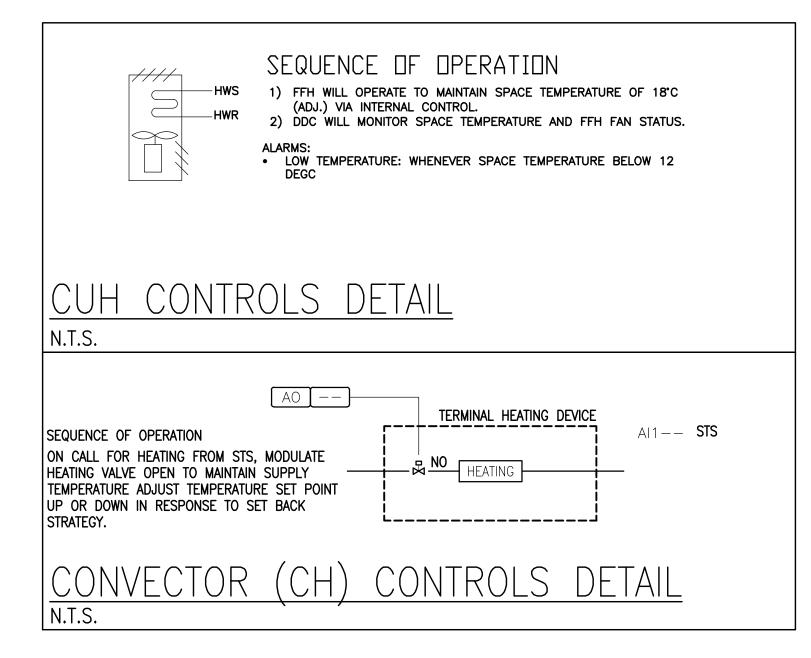

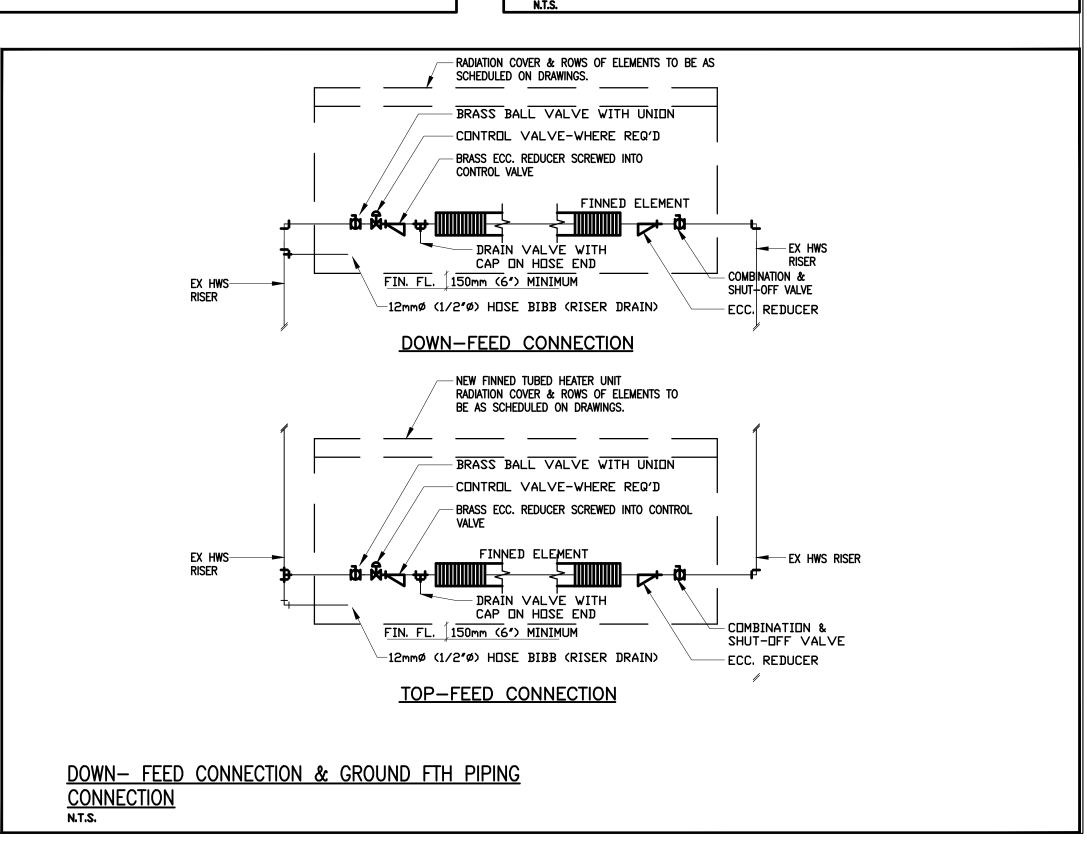

## **Drawing Notes**

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8	ISSUED FOR TENDER	22 FEB 15	MK
7	ISSUED FOR PERMIT	22 FEB 03	MK
6	ISSUED FOR 99% REVIEW	22 JAN 14	MK
5	ISSUED FOR 90% REVIEW	21 DEC 03	MK
4	ISSUED FOR PERMIT & TENDER	21 MAY 13	MK
3	ISSUED FOR 50% REVIEW	21 MAR.30	MK
2	ISSUED FOR 66% REVIEW	21 FEB.25	MK
1.	ISSUED FOR 33% REVIEW	20 DEC 04	MS
No.	Revision	Date	Ву

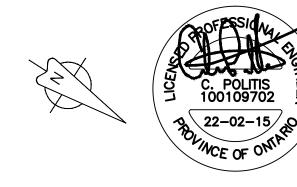

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Tel: 416-556-0766 Fax: 1-866-876-5758 engineering www.boldengineering.ca

Project Name

WRDSB - WORKSHOP ARCHITECTURE

**HVAC UPGRADES & INTERIOR RENOVATIONS** SMITHSON PUBLIC SCHOOL

150 BELLVIEW AVENUE, KITCHENER

Sheet Title


MECHANICAL DETAILS PART 2 OF 2


Drawn By MS Scale 1/8"=1'-0" Designed By MS Date November 26, 2020

**Sheet Number** 

Project Number B20-349.02A

Revision

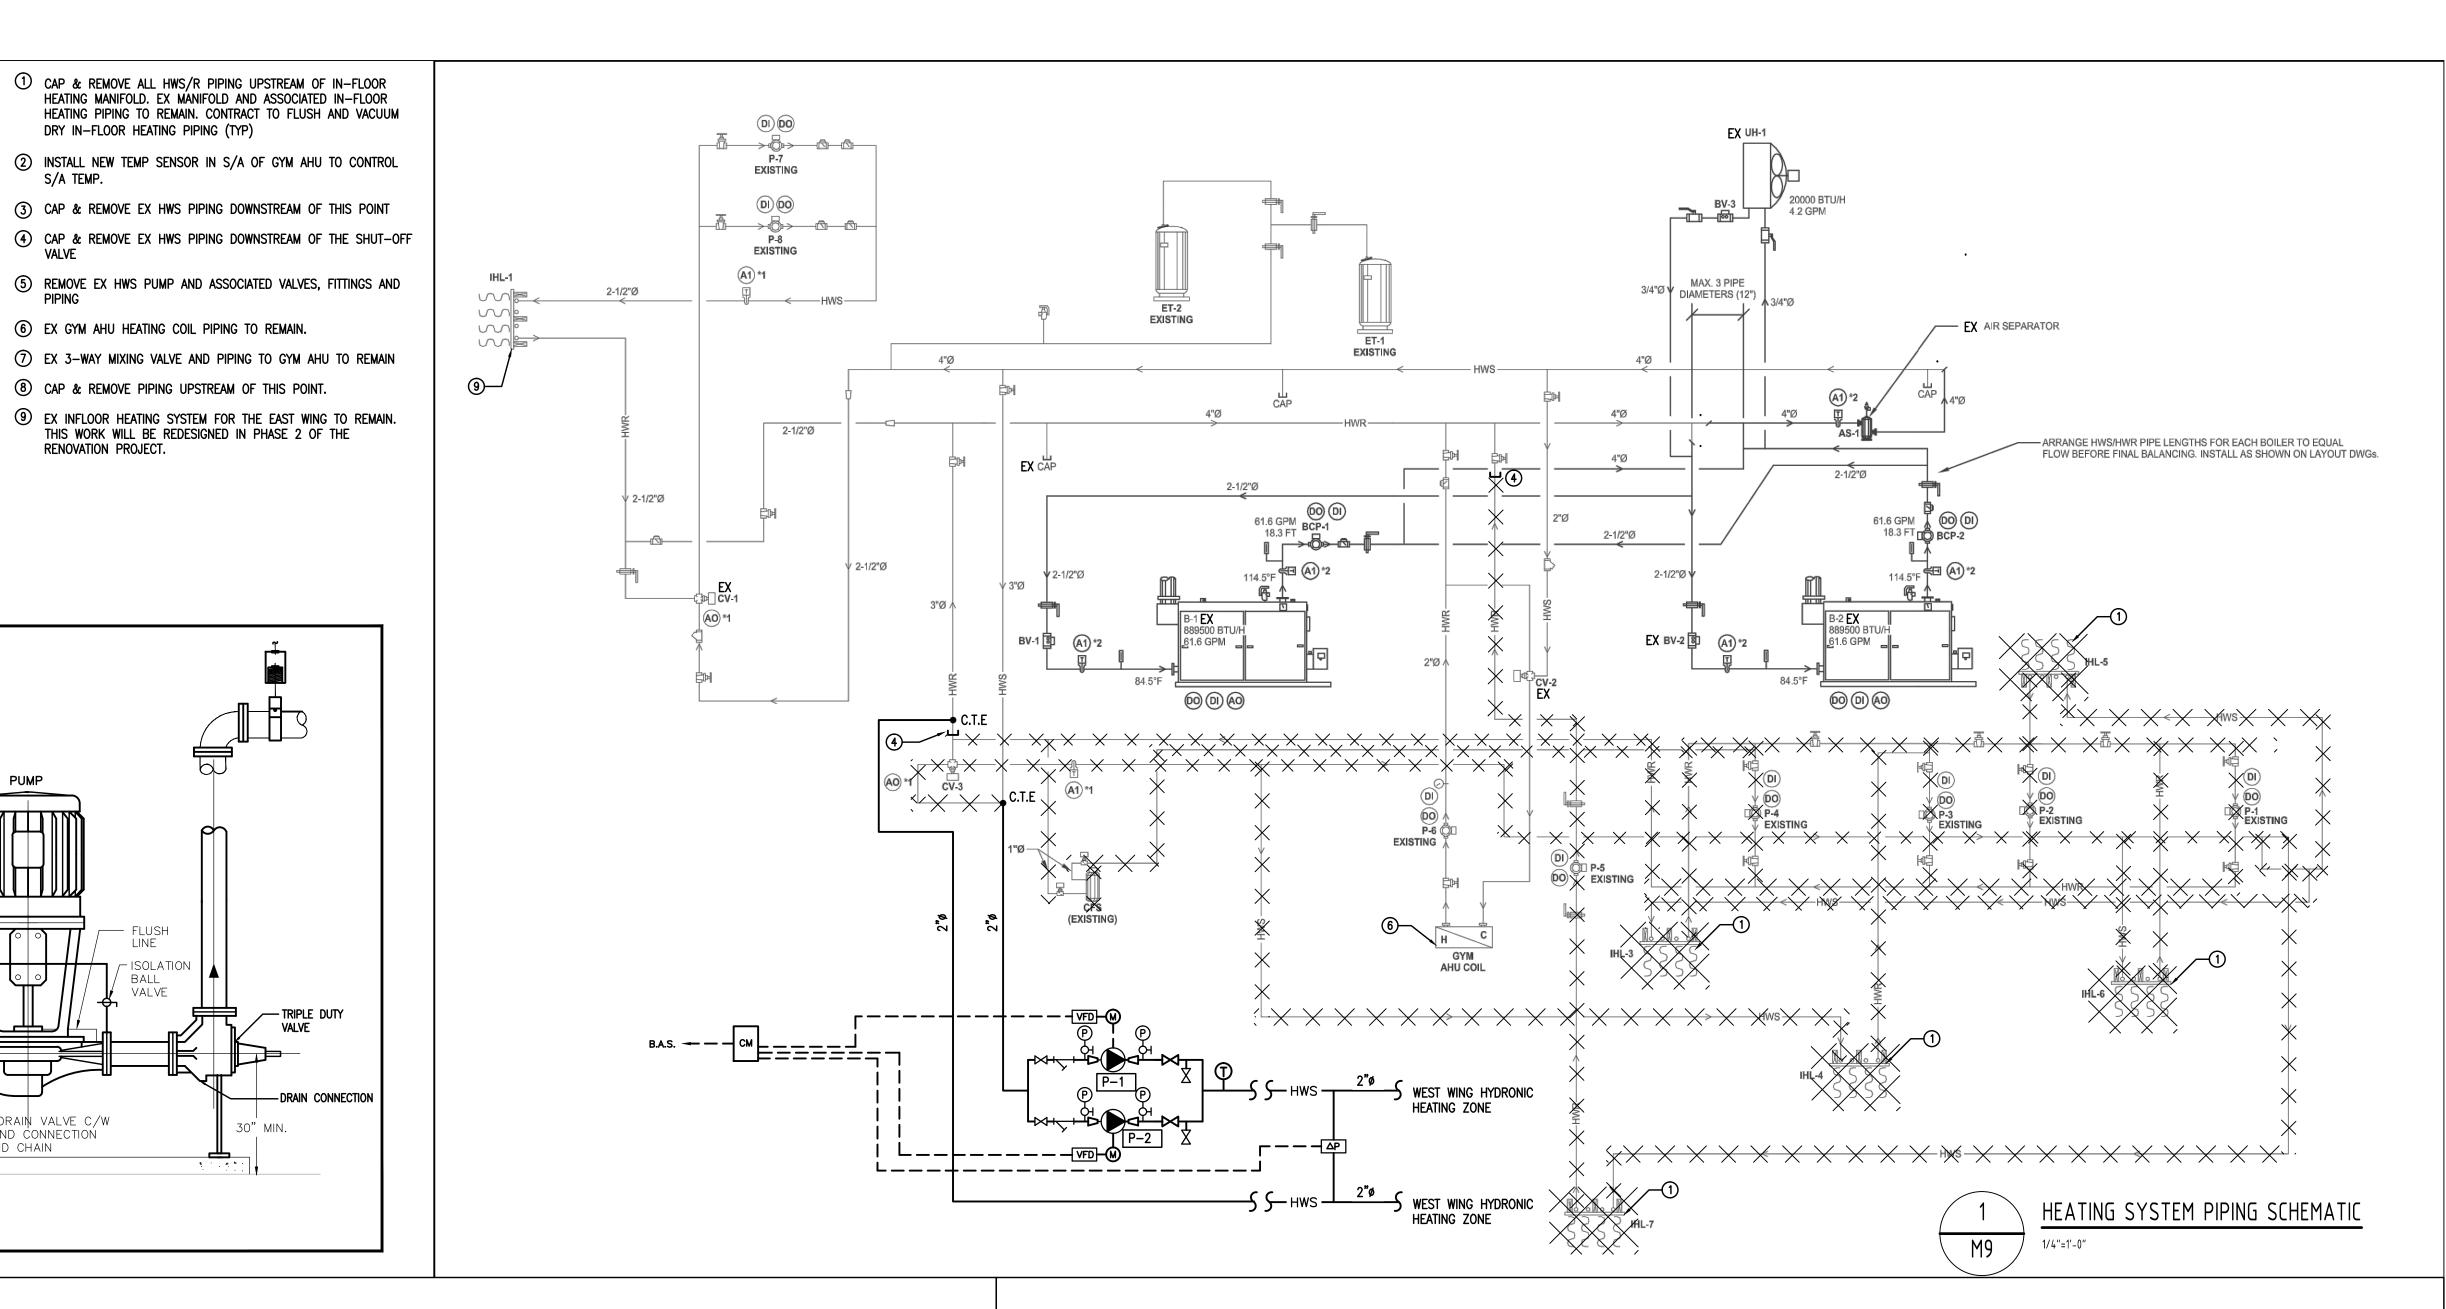

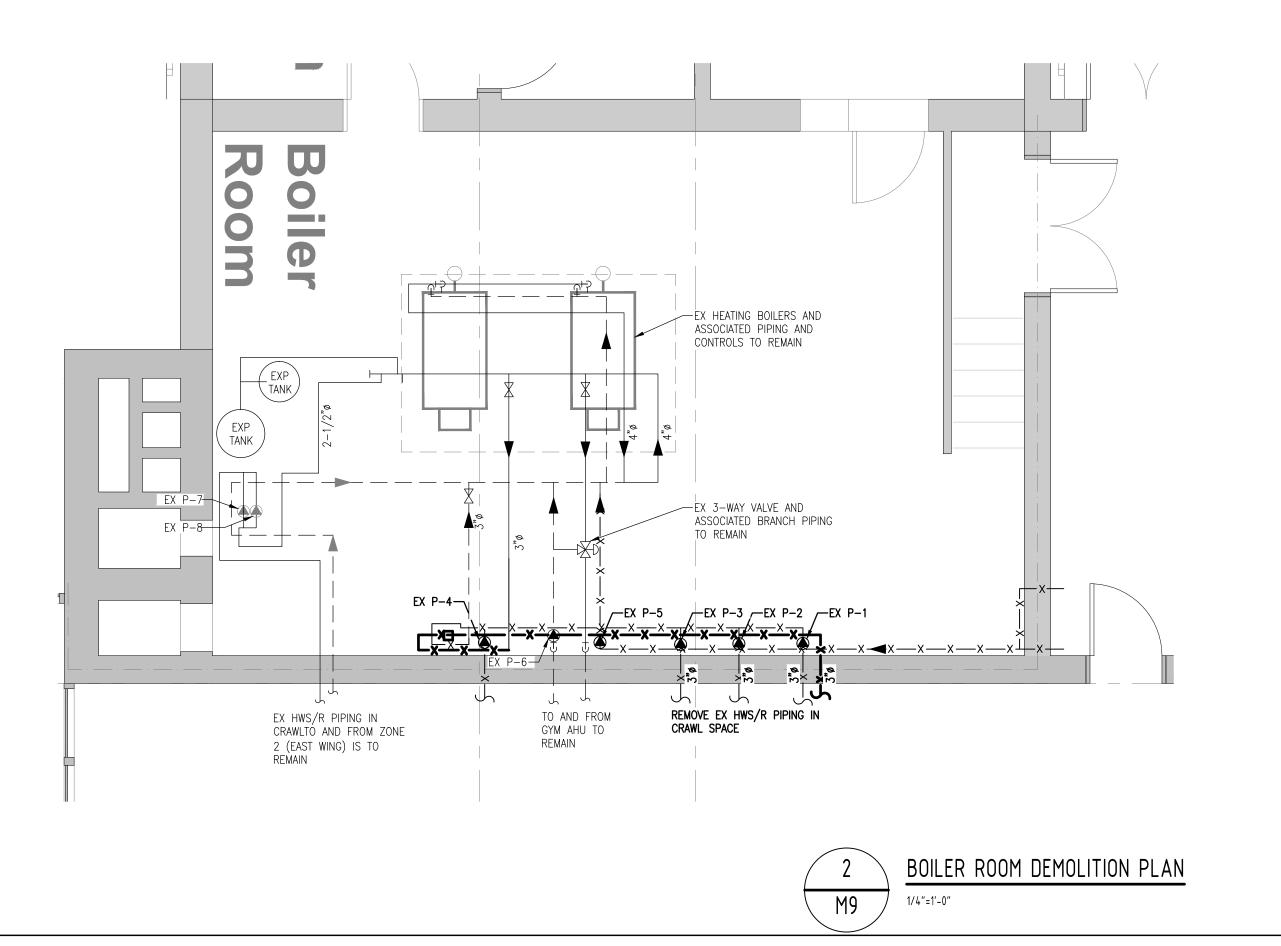

DRY IN-FLOOR HEATING PIPING (TYP)

6 EX GYM AHU HEATING COIL PIPING TO REMAIN.

(8) CAP & REMOVE PIPING UPSTREAM OF THIS POINT.

- ISOLATION

3/4"ø DRAIN VALVE C/W

HOSE END CONNECTION CAP AND CHAIN

ISOLATION HANGER (TYP.) 50mm Static Deflection (MIN) After Installation of Pump adjust PIPE HANGERS TO ELIMINATE LOAD ON PIPE SUPPORT STAND.

FLEXIBLE CONNECTOR (TYP)

BUTTERFLY VALVE

SUCTION GUIDE ---

VIBRATION ISOLATION PAD ----(PROVIDE SPRING ISOLATOR

4"Ø HIGH HOUSEKEEPING PAD ---

(FOR PUMPS MOUTED ADJACENT

VERTICAL IN-LINE PUMP DETAIL

TO EACH OTHER, PROVIDE


CONTINUOUS PAD BETWEEN

PIPE SUPPORT-

WHERE SPECIFIED


PRESSURE GAUGE ----

(TYPICAL)

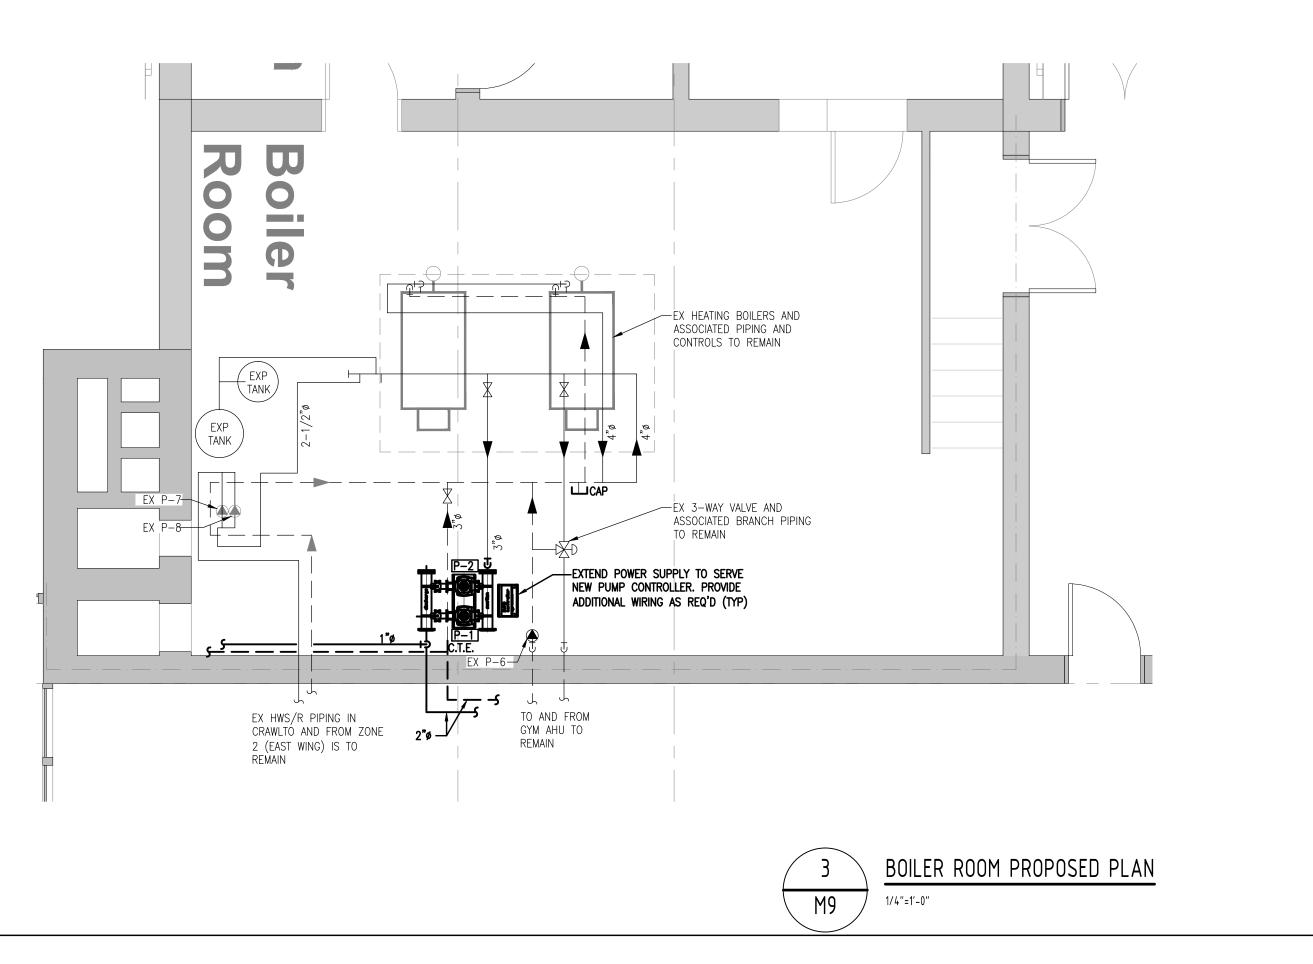

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Project Name

## WRDSB - WORKSHOP ARCHITECTURE

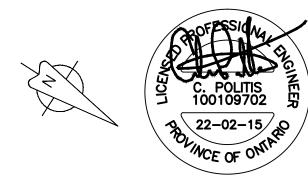HVAC UPGRADES & INTERIOR RENOVATIONS SMITHSON PUBLIC SCHOOL

150 BELLVIEW AVENUE, KITCHENER

Sheet Title

## HEATING PIPING SCHEMATIC

Drawn By MS Scale 1/8"=1'-0" Designed By MS Date November 26, 2020

Project Number B20-349.02A

Sheet Number Revision

	LEGEND
	S/A DIFFUSER: ROUND/SQUARE  X — TYPE  Y — NECK SIZE  Z — AIRFLOW (CFM)
Z → X	RETURN OR EXHAUST GRILLE  X — AIRFLOW (CFM)  Y — SIZE
	SUPPLY/RETURN/EXHAUST AIR DUCTWORK RISER  SUPPLY/RETURN/EXHAUST AIR DUCTWORK DROP  EXTERNALLY INSULATED DUCTWORK  DUCT ACOUSTICALLY LINED INTERNALLY  SPIN ON CONNECTION COMPLETE WITH BALANCING DAMPER  THERMOSTAT
-√- <b>-</b>	DIRECTION OF AIR FLOW  TRANSFER GRILL
——————————————————————————————————————	DOOR GRILLE  CEILING MOUNTED EXHAUST FAN
<b>O</b>	INLINE FAN
	CONVECTOR OR FORCE FLOW HEATER
AHU-1	EQUIPMENT TAG  EXISTING PIPING, DUCTWORK, EQUIPMENT
	NEW PIPING, DUCTWORK, EQUIPMENT
	ITEMS TO BE DEMOLISHED OR REMOVED
-	DIRECTION OF FLOW
	DOMESTIC COLD WATER (DCW)
	DOMESTIC HOT WATER (DHW)
	DOMESTIC HOT WATER RECIRCULATION (DHWR)
G	NATURAL GAS LINE (LOW PRESSURE 7" WC)
——НРС ——	NATURAL GAS LINE (MED PRESSURE)
—-S	PIPE CUT
	CUT
•	PIPE UP
G	DROP (PLUMBING)  DROP (DRAINAGE)
	PIPE DOWN BELOW MAIN
<u></u> —⋈—	CAP OR PLUG SHUT-OFF VALVE
## —##	FLOOR DRAIN TRAP
	CLEAN OUT (HUNG)  CLEAN OUT (BURIED)
	GAS OR WATER METER  UNION
	DIELECTRIC CONNECTION  SHUT-OFF VALVE
	PUMP (SCHEMATIC)

RADIAN	T CEILING	PANE	LS	CON	/ECTOR	HEATER	SCHE	ΞDl
Location	LENGTH (FT)	Btuh	GPM	TAG	HEIGHT	LENGTH	втин	G
Library				STAFF F	RM 110			
RP1	15	7,950	0.80	CH-1	20"	36"	3040	
RP2	15	7,950	0.80					
RP5	10	5,300	0.53	STAFF F	RM 110A		•	
Total panel		21,200	2.12	CH-1	20"	36"	3040	
Classroom 12			<u> </u>	WEST V	VING CORRIE	OOR 100		
RP1	15	7,950	0.80	CH-2	20"	44"	3920	
RP2	15	7,950	0.80	CH-2	20"	44"	3920	
Total panel		15,900	1.59					
				ENTRAI	NCE LOBBY		·	
Classroom 13	l.			CH-3	20"	72"	6720	
RP1	15	7,950	0.80					
RP2	15	7,950	0.80	BOYS W	/R			
Total panel		15,900	1.59	CH-4	26"	48"	8600	
Classroom 14				GIRLS V	VP			
RP1	15	7,950	0.80	CH-5	26"	48"	8600	
RP2	15	7,950	0.80	CITS	120	10	0000	
Total panel	1	15,900	1.59	NOTES				
•		,		SELECT	ON BASED O	N MANUFAC	TURER 'SIG	ΑMέ
Classroom 14	·A			MODEL	CWS-B FREE	STANDING C	CONVECTO	R FL
RP3	9	4,770	0.48	MOUNT	ΓED GRILLE IN	NLET. 4" DEE	P, ENTERIN	G W
Total panel		4,770	0.48	1	80°F AND WA		•	
•		· · · · · · · · · · · · · · · · · · ·		UNITS	WILL BE INST.	ALLED SURFA	CE MOUN.	TED
Classroom 15			•	THE FLO	OOR. BOYS &	GIRLS WR CH	H ARE 6-1/2	2" DI
RP1	15	7,950	0.80	ALL OT	HERS 4-1/2".			
RP2	15	7,950	0.80	APPRO\	/ED EQUALS	ENG A &	TRANE	
Total panel		15,900	1.59					

CONVECTOR		HEATER	R SCHE	EDUL
TAG	HEIGHT	LENGTH	втин	GPM
STAFF RM	110			
CH-1	20"	36"	3040	0.30
STAFF RM	110A			
CH-1	20"	36"	3040	0.30
WEST WIN	IG CORRID	OR 100		
CH-2	20"	44"	3920	0.39
CH-2	20"	44"	3920	0.39
ENTRANC	E LOBBY			
CH-3	20"	72"	6720	0.67
BOYS WR				
CH-4	26"	48"	8600	0.8
GIRLS WR				
CH-5	26"	48"	8600	0.8
NOTES				
		N MANUFAC		
		STANDING (		
		LET. 4" DEE		
		TER TEMP [		
		ALLED SURF		
THE FLOO	R. BOYS & (	GIRLS WR C	H ARE 6-1/2	۲" DEEP,

VVT DAMP	ER SCHE	DULE			
ROOFTOP UNIT No.	BY-PASS DAMPER SIZE	DAMPER NUMBER	AIR FLOW (CFM) MAX.	DAMPER SIZE (IN.)	REMARKS
HVAC-1	20x10	01-1	550	10x10	
		01-2	75	6ø	
		01-3	360	10X8	
		01-4	75	6ø	
		01-5	440	12x8	
		01-6	100	6ø	
HVAC-2	20x12	03-1	200	8x8	PROVIDE 5' LONG ACOUSTIC LINED DUCT
		03-2	613	12x10	_ DOWNSTREAM OF EACH VVT BOX
		03-3	900	16x10	
		03-4	868	16x10	
HVAC-3	30x12	03-1	1061	18x10	
		03-2	150	8ø	
		03-3	1019	18x10	
		03-4	1008	18x10	
		03-5	911	16x10	
HVAC-4	24x12	04-1	866	16x10	
		04-2	874	16x10	
		04-3	1258	20x10	
		04-4	200	8x8	
HVAC-5	28X12	05-1	435	12x6	
		05-2	1480	22x10	
		05-3	1480	22x10	

	HVAC UNIT SCHEDULE																			APPROVED EQUAL: YORK, TRANE, CARRIER		
ITEM NO	MANUFACTURER	MODEL	TONS	I CEM	MIN	HEATIN		COOLING		MPRESSOR .		ENSER FANS		MOTOR	F	POWER EXHAUS		MCA	UNIT VOLTAGE		SERVICING	REMARKS
112111 140.	MANOTACIONEN	MODEL	(NOM.)	01 181	SP	INPUT (BTU/HR)	OUTPUT (BTU/HR)	CAPACITY (BTU/HR)	QTY	RLA (TOTAL)	QTY	FLA (TOTAL)	HP	FLA	QTY	HP	FLA (TOTAL)	WO V	& PHASE	(LBS)	SERVIOIRO	NEW WING
HVAC-1	LENNOX	LGH048H4EH1J	4	1,600	0.5	150,000	120,000	50,100	1	5.0	1	1.6	0.75	2.4				11.0	575/3/60	902	OFFICE	LENNOX ENERGENCE MODEL LGH ROOFTOP UNIT COMPLETE WITH 24" HIGH CURB ACOUSTICALLY
HVAC-2	LENNOX	LGH072H4BH1J	6	2,400	0.5	150,000	120,000	73,500	1	7.4	1	1.0	1.0	1.7				12.0	575/3/60	1056	CLASS RM 20,21,22	INSULATED, R-410A REFRIGERANT, RELIEF AIR DAMPER,POWER EXHAUST, ECONOMIZER, WEATHER-PROOF DISCONNECT SWITCH & GFC
HVAC-3	LENNOX	LGH120H4MH1J	10	4,000	0.5	240,000	192,000	122,000	2	10.0	2	2.0	3.0	3.9				18.0	575/3/60	1470	LIBRARY	BY ELECTRICAL CONTRACTOR.  PROVIDE POWER EXHAUST FLUE EXTENSION
HVAC-4	LENNOX	LGH092H4MH1J	7.5	3,000	0.5	240,000	192,000	93,000	2	8.8	2	2.0	3.0	3.9				16.0	575/3/60	1428	CLASS RM 17,18,19	INCLUDE LEMNOX FRODIGI COMMOLLEN.
HVAC-5	LENNOX	LGH102H4MH1J	8.5	3,400	0.5	240,000	192,000	103,800	2	9.6	2	2.0	3.0	3.9				17.0	575/3/60	1435	CLASS RM 15&16	CONTROLS CONNECTIONS TO BE MADE BY SCHOOL BOARD CONTROLS CONTRACTOR.

PUMP SCHE	DULE												APPROVED EQUAL: B&G, ARMSTRONG, TACO
TAG	LOCATION	MANUFACTURER	MODEL	SERVICE	QTY	FLOW (USGPM)	HEAD (FT)	FLANGE SIZE (IN)	RPM	HP	VOLTAGE (V/\p/Hz)	WEIGHT (LBS)	REMARKS
P-1 P-2	MECH RM	GRUNDFOS		WEST WING	2	40	57.7	IN: 1-1/2" OUT: 1-1/2"	3467	1.5	208/3/60	50	HEATING LOOP PUMP C/W VFD, CONTROLLLER PACKAGE, REFER TO COMPLETE BOOK SPECIFICATION PACKAGE FOR DETAILS. PUMP VFD'S TO HAVE FILTER BY-PASS.

FAN	SCHEDULE	•								APPROVED EQUAL: GREENHECK, DELHI, PENBERRY
ITEM NO.	MANUFACTURER	MODEL	CFM	MIN. SP	FAN HP	UNIT VOLTAGE & PHASE	FAN LOCATION	AREA SERVED	WEIGHT (LBS)	REMARKS
EF-1	соок	GC-220	70	.25	41W	120/1/60	CEILING	BF 105	12 KG	CEILING MTD EXH FAN C/W RUBBER ISOLATORS, WALL MTD STARTER, AND EXH GRILLE.
EF-2	соок	GC-220	70	.25	41W	120/1/60	CEILING	JANITOR WR	12 KG	CEILING MTD EXH FAN C/W RUBBER ISOLATORS, WALL MTD STARTER, AND EXH GRILLE.
EF-3	соок	GN-520	340	.25	171W	120/1/60	CEILING	ELECT RM	25 KG	CEILING MTD EXH FAN C/W RUBBER ISOLATORS, REVERSE ACTING TSTAT, EXH LOUVRE.
EF-4	соок	GC-220	70	.25	41W	120/1/60	CEILING	BF 105	12 KG	CEILING MTD EXH FAN C/W RUBBER ISOLATORS, WALL MTD STARTER, AND EXH GRILLE.
EF-5	CARNES	VEDK10	750	.25	1/8	120/1/60	ROOF	BOY & GIRLS WR	35 LBS	ROOF MTD DIRECT DRIVE EXH FAN C/W ROOF CURB & CONNECTED TO BAS.

ERV	UNIT S	CHE	DULE						BASIS OF DESIGN: ALDES ALL OTHER EQUALS ACCEPTABLE			
TAG	MANUFACTURER	MODEL	AREA SERVED	AIR FLOW (CFM)	E.S.P	ELEC	MOCP	MCA	FAN I	HP EF	REMARKS	
ERV-1	ALDES	PW15E	CLASSROOMS	1500	0.3 INWC	575/3/60	5	4,2	1.5	1.5	CLASS RM VENTILATION UNIT, 22GA PREPAINT EXT STEEL, 22GA INT GALVANIZED STEEL, 1" INSUL, 24" HIGH CURB ACOUSTICALLY INSULATED, PROVIDE ELECT POWER TO ALL 3 MOTORS, MERV 13 FILTER, FACTORY SUPPLIED DEFROST AND DAMPER CONTROL, AND	
ERV-2	ALDES	PW15E	CLASSROOMS	1500	0.3 INWC	575/3/60	5	4,2	1.5	1.5	TERMINAL STRIP FOR FANS AND WHEEL START/STOP STATUS. CONNECT UNIT TO EX BAUNIT TO BE CONNECTED TO BAS. PROVIDE INTAKE AIR HOOD WITH BIRD SCREEN.	

FORCE	D FLOW HYD	RONIC HEA	TER								BASIS OF DESIGN: ENG A ALL OTHER EQUALS ACCEPTABLE
ITEM NO.	MAKE/MODEL	LOCATION	AIR FLOW (CFM)	HEAT OUTPUT MBH	FLOW GPM	PD (FT)	EWT F	DEL T F	MOTOR RPM	ELECT. CHAR. V/PHASE/HZ	
CUH-1	ENG-A CUH-6	VESTIBULE WALL MTD	600	49.27 MBH	5.02	3.36	180	20	1050	115/1/60	INTERLOCK CUH OPERATION WITH BAS TO CONTROL FAN. PROVIDE
CUH-2	ENG-A CUH-6	VESTIBULE WALL MTD	600	49.27 MBH	5.02	3.36	180	20	1050	115/1/60	STATUS TO BAS. FAN OPERATION BASED ON LOCAL T'STAT.
CUH-3	ENG-A CUH-6	VESTIBULE WALL MTD	600	49.27 MBH	5.02	3.36	180	20	1050	115/1/60	
CUH-4	ENG-A CUH-6	VESTIBULE WALL MTD	600	49.27 MBH	5.02	3.36	180	20	1050	115/1/60	
CUH-5	ENG-A CUH-6	VESTIBULE WALL MTD	600	49.27 MBH	5.02	3.36	180	20	1050	115/1/60	
CUH-6	ENG-A CUH-6	VESTIBULE WALL MTD	600	49.27 MBH	5.02	3.36	180	20	1050	115/1/60	

GRI	LLES &	: DIFFU	SERS SCHEDULE  BASIS OF DESIGN: EH PRICE EQUAL IN: NAYLOR, TITUS
TAG	MAKE	MODEL	REMARKS
A	EH PRICE	520	SIDEWALL S/A GRILLES, DOUBLE DEFLECTION, STEEL CONSTRUCTION, 3/4 (19MM) BLADE SPACING.
В	EH PRICE	SPD	CEILING MTD S/A SQUARE PLAQUE DIFFUSERS FIXED PATTER, STEEL CONSTRUCTION
С	EH PRICE	80 SERIES	CEILING MOUNT EGGCRATE R/A & E/A GRILLE. STEEL CONSTRUCTION, 1/2 (12MM) SPACING. CLASS RM R/A TO HAVE CHANNEL BORERS (80CH) AND E/A TO HAVE SCREWED BORDER (80FA)
D	EH PRICE	530	EXH AIR GRILLE, LOUVRED RETURN, FIXED 45° DEFLECTION, 37" LOUVRE SPACING, STEEL CONSTRUCTIO

PLLIMBING	FIYTLIRE	DIDING	CONNECTIONS
LOMPING	LIVIONE	LILING	COMMECTIONS

		WATER	SUPPLY	DRAIN	VENT
SYMBOL	FIXTURE TYPE	HDT mm(in)	COLD mm(in)	mm(in)	mm(in)
'WC-2'	WATER CLOSET, FLUSH VALVE	-	25ø (1")	75ø (3")	40ø (1-1/2")
'WC-1	WATER CLOSET, FLUSH TANK	-	12ø (1/2")	75ø (3")	40ø (1-1/2")
L-1 & 2	LAVATORY	12ø (1/2")	12ø (1/2")	32ø (1-1/4")	32ø (1-1/4")
'S-1'	SINK	12ø (1/2")	12ø (1/2")	32ø (1-1/4")	32ø (1-1/4")
'FD'	FLOOR DRAIN (C/W PRIME LINE)	_		75ø (3")	40ø (1-1/2")
'JS-1'	JANITORS SINK	12ø (1/2")	12ø (1/2")	75ø (3")	40ø (1-1/2")

## APPROVED EQUALS: ENG A & TRANE

SELECTION BASED ON MANUFACTURER 'AIRTEX' AND MODEL HEF-2 RADIANT CEILING

PANELS. HEAT OUTPUT IS 530 BTUH/FT,

PERFORMANCE BASED ON 70°F AIR ENTERING

AND 67°F AST WITH NATURAL CONVECTION.

PANEL WIDTH IS TO BE 36" WIDE AND LENGTH

Total panel

Classroom 14

Total panel

Classroom 16

Panel 3

Total panel

Classroom 17

Total panel

Classroom 18

Total panel

Classroom 19

Total panel

Classroom 20

Total panel

Classroom 21

Total panel

Total panel

Reception 10

Total panel

Total panel

Office 105

Total panel

AS NOTED ABOVE.

Office 1

Classroom 14A

7,950 0.80 7,950 0.80 4,770 0.48

20,670 2.07

7,950 0.80 7,950 0.80

15,900 | 1.59

7,950 0.80

15,900 | 1.59

7,950 0.80 7,950 0.80

15,900 1.59

7,950 | 0.80 7,950 0.80

15,900 | 1.59

4,770 0.48

20,670 | 2.07

3,180 | 0.32

7,950 | 0.80

7,950 0.80

4,770 0.48 4,770 | 0.48

> 3,180 | 0.32 3,180 0.32

## PLUMBING FIXTURES

WC-1 FLOOR MOUNTED TOILET - VITREOUS CHINA - TANK TYPE

AMERICAN STANDARD CADET PRO ELONGATED #215CA.104.020 TOILET, 3517C.101, 4188A.104, 381 MM HIGH, VITREOUS CHINA WITHEVERCLEAN ANTIMICROBIAL SURFACE WHICH INHIBITS THE GROWTH OF STAIN AND ODOR CAUSING BACTERIA MOLD AND MILDEW, ELONGATED BOWL, WHITE FINISH, FLOOR MOUNTED, CADET FLUSHING SYSTEM WHICH SCRUBS BOWL WITH EVERY FLUSH, 4.8 L (1.28 US GAL) PER FLUSH, RAISED SANITARY BAR AND FOUR (4) POINTS TANK STABILIZATION, 229 MM X 203 MM (9" X 8") WATER SURFACE, TWO (2) PIECE, 'SPEED CONNECT' TANK ASSEMBLY, CADET FLUSHING SYSTEM WHICH SCRUBS BOWL WITH EVERY FLUSH, RAISED SANITARY BAR AND FOUR (4) POINTS TANK STABILIZATION, UNLINED TANK, LEFT HAND TRIPLEVER, OVERSIZED 76 MM (3") FLUSH VALVE WITH FLAPPER, METAL SHANK

AMERICAN STANDARD CADET FLUSHING SYSTEM WHICH SCRUBS BOWL WITH EVERY FLUSH, RAISED SANITARY BAR AND FOUR (4) POINTS TANK STABILIZATION, UNLINED TANK, LEFT HAND TRIPLEVER, OVERSIZED 76 MM (3") FLUSH VALVE WITH FLAPPER, METAL SHANK

AMERICAN STANDARD CADET FLUSHING SYSTEM WHICH SCRUBS BOWL WITH EVERY FLUSH, RAISED SANITARY BAR AND FOUR (4) POINTS TANK STABILIZATION, UNLINED TANK, LEFT HAND TRIPLEVER, OVERSIZED 76 MM (3") FLUSH VALVE WITH FLAPPER, METAL SHANK

AMERICAN STANDARD CADET FLUSHING SYSTEM WHICH SCRUBS BOWL WITH EVERY FLUSH, RAISED SANITARY BAR AND FOUR (4) POINTS TANK STABILIZATION, UNLINED TANK, LEFT HAND TRIPLEVER, OVERSIZED 76 MM (3") FLUSH VALVE WITH FLAPPER, METAL SHANK

AMERICAN STANDARD CADET FLUSHING SYSTEM WHICH SCRUBS BOWL WITH EVERY FLUSH, RAISED SANITARY BAR AND FOUR (4) POINTS TANK STABILIZATION, UNLINED TANK, LEFT HAND TRIPLEVER, OVERSIZED 76 MM (3") FLUSH FL FILL VALVE, 305 MM (12") ROUGH—IN, ELONGATED BOWL, 54 MM (2-1/8") FULLY GLAZED INTERNAL TRAPWAY, FLOOR OUTLET, BOLT CAPS, TOILET SEAT NOT INCLUDED. CENTOCO #500STSCC.001 TOILET SEAT, HEAVY DUTY, FOR ELONGATED BOWL, OPEN FRONT, SOLID PLASTIC, LESS COVER, STAINLESS STEEL CHECK HINGES, METAL FLAT WASHERS STAINLESS STEEL CHECK HINGES

## WC-2 FLOOR MOUNTED TOILET - VITREOUS CHINA - TANK TYPE

AMERICAN STANDARD CADET PRO RIGHT HEIGHT ELONGATED #215AA.104.020 TOILET, 3517A.101, 4188A.104, 419 MM HIGH, VITREOUS CHINA WITH EVERY FLUSH, 4.8 L (1.28 US GAL) PER FLUSH, RAISED SANITARY BAR AND FOUR (4) POINTS TANK STABILIZATION, UNLINED TANK, LEFT HAND TRIPLEVER, OVERSIZED 76 MM (3") FLUSH VALVE WITH FLAPPER, METAL SHANK FILL VALVE, 305 MM (12") ROUGH-IN, ELONGATED BOWL, 54 MM (2-1/8") FULLY GLAZED INTERNAL TRAPWAY, FLOOR OUTLET, BOLT CAPS, TOILET SEAT NOT INCLUDED. NOTE: PROVIDE BOLTED TANK COVER IF REQUIRED - TO MEET LOCAL CENTOCO #500STSCC.001 TOILET SEAT, HEAVY DUTY, FOR ELONGATED BOWL, OPEN FRONT, SOLID PLASTIC, LESS COVER, STAINLESS STEEL CHECK HINGES, METAL FLAT WASHERS STAINLESS STEEL POSTS AND NUTS. MCGUIRE #LFH172BV TOILET SUPPLY, CHROME PLATED FINISH POLISHED BRASS, COMMERCIAL DUTY 1/4 TURN BALL VALVE ANGLE STOPS, 13 MM (1/2") I.D. INLET X 127 MM (5") LONG RIGID HORIZONTAL INTEGRAL COPPER SWEAT TUBE NIPPLES, COMBINATION V.P. LOOSE KEY HANDLES, ESCUTCHEON AND FLEXIBLE COPPER RISERS. PROVIDE FLOOR FLANGE, (SAME MATERIAL AS THE CONNECTING PIPE DRAIN), WITH ALL BRASS BOLTS AND WITH RUBBER GASKET. PROVIDE TRIP LEVER ON OPEN SIDE OF TOILET (WIDE SIDE) IF REQUIRED — TO MEET LOCAL CODES.

AMERICAN STANDARD DECORUM #9024.004EC.020 BASIN, 3 HOLES, 4" (102 MM) CENTER, 508 MM X 464 MM X 127 MM (20" X 18-1/4" X 5") HIGH, VITREOUS CHINA, WHITE FINISH, FOR CARRIER WITH CONCEALED ARMS, FOR CARRIER WITH CONCEALED ARMS, FOR CARRIER WITH CONCEALED ARMS, REAR OVERFLOW, SELF-DRAINING FAUCET LEDGE. AMERICAN STANDARD COLORY MATCHED UNDERBODY, AERATOR OUTLET, 107 MM (4-3/16") PROJECTION REACH, SPEED CONNECT CABLE OPERATED NON-METALLIC POP-UP DRAIN MCGUIRE #LFH170BV FAUCET SUPPLIES, CHROME PLATED FINISH POLISHED BRASS, COMMERCIAL DUTY 1/4 TURN BALL VALVE ANGLE SCUTCHEON TUBES, CONVERTIBLE 1/4 TURN/LOOSE KEY HANDLES, ESCUTCHEON AND FLEXIBLE COPPER RISERS. MCGUIRE #8872C P-TRAP, HEAVY CAST BRASS ADJUSTABLE BODY, WITH SLIP NUT, 32 MM (11/4") SIZE, SHALLOW WALL FLANGES TO ATTACH TO BACKING PLATE SECURED IN WALL WITH LOCKING DEVICE AND LEVELLING SCREWS, HEAVY GAUGE STEEL UPRIGHTS WITH INTEGRAL WELDED FEET. FOR ONE UNIT: 102 MM (4") FOR TWO TO SIX UNITS IN A ROW: 152 MM (6") FINISHED METAL STUD WALL TO BACK OF PIPE SPACE.

L-2 WALL HUNG BASIN - SINGLE HANDLE FAUCET - BELOW DECK MECHANICAL WATER MIXING VALVE

AMERICAN STANDARD DECORUM #9024.004EC.020 BASIN, 3 HOLES, 4" (102 MM) CENTER, 508 MM X 464 MM X 127 MM (20" X 18-1/4" X 5") HIGH, VITREOUS CHINA, WHITE FINISH, FOR CARRIER WITH CONCEALED ARMS, FOR CARRIER WITH UNDERBODY, AERATOR OUTLET, 107 MM (4-3/16") PROJECTION REACH, POP-UP LIFT ROD, HOLE AND KNOB, SUPPLIED WITH AUTOMATIC RESET WHEN TEMPERATURE EXCEEDS 120 °F (48.8 °C), INTEGRAL CHECKS, OFFER TEMPERATURE RANGE FROM FULL COLD THROUGH 46 °C (114.8 °F). NOTE: PROVIDE TEE, ADAPTORS AND COPPER TUBING TO SUIT INSTALLATION. PROVIDE TEMPERED WATER TO HOT SIDE OF FAUCET. MCGUIRE #155A OPEN GRID DRAIN, CAST BRASS ONE PIECE TOP, 17 GA. (1.5 MM) TUBULAR 32 MM (1-1/4") TAILPIECE. MCGUIRE #157A OPEN GRID DRAIN, CAST BRASS ONE PIECE TOP, 17 GA. (1.5 MM) TUBULAR 32 MM (1-1/4") TAILPIECE. MCGUIRE #157A OPEN GRID DRAIN, CAST BRASS ONE PIECE TOP, 17 GA. (1.5 MM) TUBULAR 32 MM (1-1/4") TAILPIECE. MCGUIRE #157A OPEN GRID DRAIN, CAST BRASS ONE PIECE TOP, 17 GA. (1.5 MM) TUBULAR 32 MM (1-1/4") TAILPIECE. MCGUIRE #157A OPEN GRID DRAIN, CAST BRASS ONE PIECE TOP, 17 GA. (1.5 MM) TUBULAR 32 MM (1-1/4") TAILPIECE. MCGUIRE #157A OPEN GRID DRAIN, CAST BRASS ONE PIECE TOP, 17 GA. (1.5 MM) TUBULAR 32 MM (1-1/4") TAILPIECE. MCGUIRE #157A OPEN GRID DRAIN, CAST BRASS ONE PIECE TOP, 17 GA. (1.5 MM) TUBULAR 32 MM (1-1/4") TAILPIECE. MCGUIRE #157A OPEN GRID DRAIN, CAST BRASS ONE PIECE TOP, 17 GA. (1.5 MM) TUBULAR 32 MM (1-1/4") TAILPIECE. MCGUIRE #157A OPEN GRID DRAIN, CAST BRASS ONE PIECE TOP, 17 GA. (1.5 MM) TUBULAR 32 MM (1-1/4") TAILPIECE. MCGUIRE #157A OPEN GRID DRAIN, CAST BRASS ONE PIECE TOP, 17 GA. (1.5 MM) TUBULAR 32 MM (1-1/4") TAILPIECE. MCGUIRE #157A OPEN GRID DRAIN, CAST BRASS ONE PIECE TOP, 17 GA. (1.5 MM) TUBULAR 32 MM (1-1/4") TAILPIECE. MCGUIRE #157A OPEN GRID DRAIN, CAST BRASS ONE PIECE TOP, 17 GA. (1.5 MM) TUBULAR 32 MM (1-1/4") TAILPIECE. MCGUIRE #157A OPEN GRID DRAIN, CAST BRASS ONE PIECE TOP, 17 GA. (1.5 MM) TUBULAR 32 MM (1-1/4") TAILPIECE. MCGUIRE #157A OPEN GRID DRAIN, CAST BRASS ONE PIECE TOP, 17 GA. (1.5 MM) TUBULAR 32 MM (1-1/4") TAILPIECE. MCGUIRE #157A OPEN GRID DRAIN, CAST BRASS ONE PIECE TOP, 17 GA. (1.5 MM) TUBULAR 32 MM (1-1/4") TAILPIECE. MCGUIRE #157A OPEN GRID DRAIN, CAST BRASS ONE PIECE TOP, 17 GA. (1.5 MM) TUBULAR 32 MM (1-1/4") TAILPIECE. MCGUIRE #157A OPEN GRID DRAIN, CAST BRASS ONE PIECE TOP, 17 GA. (1.5 MM) TUBULAR 32 MM (1-1/4") TAILPIECE. MCGUIRE #157A OPEN GRID DRAIN TOP TOP TO VALVE ANGLE STOPS, 13 MM (1/2") I.D. INLET X 127 MM (5") HORIZONTAL EXTENSION TUBES, CONVERTIBLE 1/4 TURN/LOOSE KEY HANDLES, ESCUTCHEON AND FLEXIBLE COPPER RISERS. MCGUIRE #8872C P-TRAP, HEAVY CAST BRASS ADJUSTABLE BODY, WITH SLIP NUT, 32 MM (1-1/4") SIZE, SHALLOW WALL FLANGE AND SEAMLESS TUBULAR ALL BEND. MCGUIRE #8872C P-TRAP, HEAVY CAST BRASS ADJUSTABLE BODY, WITH SLIP NUT, 32 MM (1-1/4") SIZE, SHALLOW WALL FLANGE AND SEAMLESS TUBULAR ALL BEND. MCGUIRE PROWRAP #PW2000 SANITARY COVERING VANDAL-RESISTANT, FLEXIBLE SEAMLESS MOULDED CLOSED-CELL PVC RESIN, FORMULATED WITH ANTI-MICROBIAL ADDITIVE TO LIMIT THE GROWTH OF FUNGUS AND BACTERIA, TO EXPOSED PIPING (TO PROTECT AGAINST HEAT/CONTUSIONS) AS PER LOCAL CODES. WATTS #WCA-411 BASIN CARRIER, CONCEALED ARMS, WALL FLANGES TO ATTACH TO BACKING PLATE SECURED IN WALL WITH LOCKING DEVICE AND LEVELLING SCREWS, HEAVY GAUGE STEEL UPRIGHTS WITH INTEGRAL WELDED FEET. FOR ONE UNIT: 102 MM (4") FOR TWO TO SIX UNITS IN A ROW: 152 MM (6") FINISHED METAL STUD WALL TO BACK OF PIPE SPACE.

JS-1 SERVICE / MOP SINK - TWO HANDLES FAUCET


FIAT #TSB200100 SQUARE SERVICE / MOP SINK, 610 MM (24") WIDE X 610 MM (24") LONG X 305 MM (12") HIGH DEEP, FLOOR MOUNTED, TERRAZZO, WHITE, PLAIN CURB, INTEGRAL STAINLESS STEEL DRAIN ASSEMBLY AND STRAINER PLATE, 3" (76 MM) OUTLET. NOTE: COMPLETE WITH DRAIN GASKET. AMERICAN STANDARD YOKE #8354112.002 WALL MOUNTED TWO HANDLES FAUCET, POLISHED CHROME FINISH, FLEXIBLE TO BE AND PLOYET HOOK 237 MM (9-6/16") EPOM WALL TO OUTLET REACH LEVER HANDLES TOP BRACE, PROVIDE P-TRAP. SAME MATERIAL AS THE CONNECTING PIPE DRAIN. INSTALLATION WITHIN THE RANGE OF 6" (152 MM) TO 10" (254 MM), CAST BRASS BODY, WASHERLESS CERAMIC DISC VALVE CARTRIDGES, 22.7 LPM (6.0 GPM) UNRESTRICTED HOSE END OUTLET, SPOUT WITH ATMOSPHERIC VACUUM BREAKER AND BUCKET HOOK, 237 MM (9-5/16") FROM WALL TO OUTLET REACH, LEVER HANDLES, TOP BRACE. PROVIDE P-TRAP, SAME MATERIAL AS THE CONNECTING PIPE DRAIN.


S—1 COUNTERTOP MOUNT SINK — SINGLE HANDLE FAUCET
FRANKE COMMERCIAL #LBS6808—1/1 SINGLE BOWL COUNTERTOP MOUNT SINK, 1 HOLE, 508 MM (20") WIDE X 521 MM (20—1/2") LONG X 203 MM (8") HIGH DEEP, COUNTER MOUNTED, BACKLEDGE, GRADE 18—10 20 GA. (0.9 MM) TYPE 302 STAINLESS STEEL, SELF—RIMMING, SATIN FINISH RIM AND BOWLS, MOUNTING KIT PROVIDED, FULLY UNDERCOATED TO REDUCE CONDENSATION AND RESONANCE, FACTORY APPLIED RIM SEAL, 3— 1/2" (89 MM) CRUMB CUP WASTE ASSEMBLY WITH 1—1/2" (38 MM) TAILPIECE. AMERICAN STANDARD ARCH #4101100.002 SINGLE HANDLE FAUCET, POLISHED CHROME FINISH, CENTER HOLE ONLY, BRASS, 47 MM WASHERLESS CERAMIC DISC VALVE, 8.3 LPM (2.2 GPM) OUTLET, METAL SWING SPOUT, 242 MM (9—1/2") PROJECTION REACH, METAL LEVER HANDLE, PULL—OUT SPRAY WITH ADJUSTABLE SPRAY PATTERN. MCGUIRE #LFBV170 FAUCET SUPPLIES, CHROME PLATED FINISH POLISHED BRASS, COMMERCIAL DUTY 1/4 TURN BALL VALVE ANGLE STOPS, 13 MM (1/2") I.D. INLET X 127 MM (5") HORIZONTAL EXTENSION TUBES, CONVERTIBLE 1/4 TURN/LOOSE KEY HANDLES, ESCUTCHEON AND FLEXIBLE COPPER RISERS. MCGUIRE #8912CB P—TRAP, HEAVY CAST BRASS ADJUSTABLE BODY, WITH SLIP NUT, 38 MM (1—1/2") SIZE, BOX FLANGE AND SEAMLESS TUBULAR WALL BEND.

**Drawing Notes** 

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ISSUED FOR TENDER ISSUED FOR PERMIT 2 FEB 03 22 JAN 14 ISSUED FOR 99% REVIEW 21 DEC 03 ISSUED FOR 90% REVIEW ISSUED FOR PERMIT & TENDER 21 MAY 13 1 MAR.30 ISSUED FOR 50% REVIEW 1 FEB.25 ISSUED FOR 66% REVIEW 20 DEC 04 ISSUED FOR 33% REVIEW Date

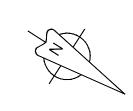

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Project Name

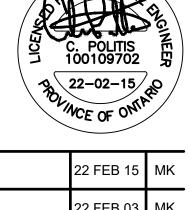WRDSB - WORKSHOP ARCHITECTURE

HVAC UPGRADES & INTERIOR RENOVATIONS SMITHSON PUBLIC SCHOOL

150 BELLVIEW AVENUE, KITCHENER

MECHANICAL SCHEDULE

Drawn By MS Scale 1/8"=1'-0" Designed By MS Date November 26, 2020

Sheet Number

Revision

M10

# SMITHSON PUBLIC SCHOOL HVAC UPGRADES & INTERIOR RENOVATIONS


150 BELLEVIEW AVE, KITCHENER, ON

# WRDSB - WORKSHOP ARCHITECTURE - SMITHSON PS

PROJECT NO.: B20-349.02A

## **DRAWING LIST**

- E1 ELECTRICAL LEGEND AND SCHEDULES
- **E2** ELECTRICAL SINGLE LINE DIAGRAM AND SITE PLAN
- E3 EXISTING/DEMO POWER PLANS
- **E4** EXISTING/DEMO FIRE ALARM PLANS
- E5 EXISTING/DEMO LIGHTING & REFLECTED CEILING PLANS
- E5.1 EXISTING/DEMO LIGHTING & REFLECTED CEILING PLANS
- E5.2 EXISTING/DEMO EMERGENCY LIGHTING & EXIT SIGN PLANS
- **PROPOSED POWER PLANS**
- **E6.1 PROPOSED POWER PLANS**
- **E7 PROPOSED FIRE ALARM PLANS**
- E8 PROPOSED LIGHTING & REFLECTED CEILING PLANS
- E8.1 PROPOSED LIGHTING & REFLECTED CEILING PLANS
- E8.2 PROPOSED EMERGENCY LIGHTING & EXIT SIGN PLANS
- E9 ELECTRICAL AND BOILER ROOM LAYOUTS
- E10 PROPOSED ROOFTOP POWER PLANS
- **E11 ELECTRICAL DETAILS**
- **E11.1 ELECTRICAL DETAILS**

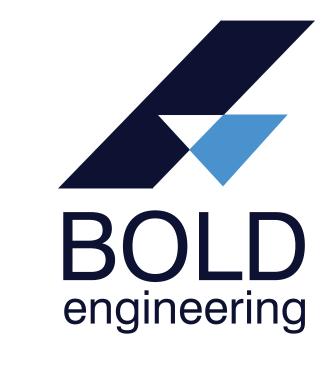

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www.boldengineering.ca

	ELECTRICAL LEGEND
	BASE BUILDING LUMINAIRE
	NEW LUMINAIRE
`A'	LUMINAIRE DESIGNATOR LETTER DEMOTES TYPE REFER TO LUMINAIRE SCHEDULE
T 4.	WALL MOUNTED EMERGENCY LIGHTING REMOTE HEAD(S)
BU BU	WALL MOUNTED EMERGENCY LIGHTING BATTERY UNIT WITH HEAD(S)
<u></u>	CEILING MOUNTED EXIT SIGN DIRECTIONAL ARROW(S) AND WALL FACE(S) AS SHOWN
f⊗t	WALL MOUNTED EXIT SIGN DIRECTIONAL ARROW(S) AND WALL FACE(S) AS SHOWN
<u> </u>	EXIT SIGNS WITH BATTERIES
\$	TOGGLE SWITCH - 120V
\$ \$ \$	GANGED TOGGLE SWITCHES, 2, 3, 4 GANG
\$ <sub>D</sub>	DIMMER SWITCH
\$3	3 - WAY SWITCH
\$ <b>к</b>	KEY SWITCH
Φ	WALL MOUNTED DUPLEX RECEPTACLE
**************************************	WALL MOUNTED QUAD RECEPTACLE (15A, 120V UNLESS OTHERWISE NOTED)
⊕ GFI	WALL MOUNTED ABOVE COUNTER, GROUND FAULT INTERRUPTER DUPLEX RECEPTACLE (15A, 120V)
⊕ <b>WP</b>	NEMA 5-20R GFI DUPLEX RECEPT. C/W WEATHERPROOF COVER FOR HVAC MAINTENANCE INSTALLED AT 750mm ABOVE FINISHED ROOF
▼	WALL MOUNTED VOICE OUTLET
$\nabla$	WALL MOUNTED DATA OUTLET
<b>T</b>	WALL MOUNTED DATA/VOICE OUTLET
V	FLOOR MOUNTED VOICE OUTLET
	FLOOR MOUNTED DATA OUTLET
<u>V</u>	FLOOR MOUNTED DATA/VOICE OUTLET
WAP	WIRELESS ACCESS POINT
	FLOOR MOUNTED COMBINATION OUTLETS WITH OUTLETS AS SHOWN
	WALL FEED FOR POWER AND COMMUNICATIONS TO SYSTEM FURNITURE  FLOOR FEED FOR POWER AND COMMUNICATIONS TO SYSTEM FURNITURE
1	
₩ W	TELEVISION SYSTEM OUTLET — CEILING, WALL MOUNTED
JB 💮	JUNCTION BOX
<u> </u>	DIRECTION CONNECTION OUTLET  MOTOR CONNECTION
<u> </u>	DISCONNECT SWITCH — UNFUSED
 	DISCONNECT SWITCH - FUSED
	SURFACE MOUNTED PANEL BOARD
_	RECESSED MOUNTED PANEL BOARD
$\boxtimes$	TRANSFORMER
	FIRE ALARM PULL STATION
\III/	FIRE ALARM HORN AND STROBE COMBO UNIT
SP SP	SPEAKER — CEILING, WALL MOUNTED
©S \$0C	OCCUPANCY SENSOR
•	SMOKE DETECTOR
€	DUCT TYPE SMOKE DETECTOR W/ REMOTE INDICATION
<b>₽</b>	HEAT DETECTOR - 135' FIXED TEMPERATURE TYPE - CEILING, WALL MOUNTED
PB MD	AUTOMATIC DOOR PUSHBUTTON
	MOTION DETECTOR
TCA	TOPCAT AUDIO SYSTEM (CEILING MOUNTED)
PJR	SMARTBOARD PROJECTOR MOUNT (CEILING MOUNTED)
	OUTLETS FOR AUDIO/VISUAL SYSTEM INSTALLATION
EX	EXISTING TO REMAIN
R PF/PF	EXISTING TO REMOVED  EXISTING TO BE REMOVED AND REINSTALLED
RE/RE RL	EXISTING TO BE REMOVED AND REINSTALLED  EXISTING IN RELOCATED POSITION
AFF	ABOVE FINISHED FLOOR
NL	NIGHT LIGHT CIRCUIT
.112	

	LIGHTING SCHEDULE											
TYPE	MAKE / MODEL	DESCRIPTION	VOLTAGE		LAN	AP DATA		MOUNTING	REMARKS			
IIFE	WANE / WODEL	DESCRIPTION	VOLIAGE	No.	TYPE	WATTS	COLOUR	MODITING	NEMPINS			
'L1'	LITHONIA LIGHTING 2GTL-4-48L-GZ10-LP840	RECESSED LED 2'x4' TROFFER	120V	1	LED	36W	4000K	RECESSED	LIGHTING TO BE ON DIMMERS AS SHOWN OF DRAWINGS. PROVIDE DIMMING CONTROLLER.			
'L2'	LITHONIA LIGHTING 2GTL-4-40L-GZ10-LP840	RECESSED LED 2'x4' TROFFER	120V	1	LED	30W	4000K	RECESSED	LIGHTING TO BE ON DIMMERS AS SHOWN OF DRAWINGS. PROVIDE DIMMING CONTROLLER.			
'L3'	LITHONIA LIGHTING SBL4-4000LM-40K	SURFACE MOUNTED 1'x4'	120V	1	LED	32W	4000K	SURFACE	_			
'L4'	LITHONIA LIGHTING SBL4-4800LM-40K	SURFACE MOUNTED 1'x4'	120V	1	LED	40W	4000K	SURFACE	-			
'L5'	LLI ARCHITECTURAL LIGHTING LLI-S-IC1-SF-XX-40K-24V-XX	SUSPENDED LINEAR STRIP	120V	1	LED	XW/FT	4000K	SUSPENDED	COORDINATE SUSPENSION LENGTH AND EXAC LOCATION WITH ARCHITECTURAL TRADE.			
'L6'	CAMMAN LIGHTING P1044-108-40K-1-ACM	ARCHITECTURAL PENDENT	120V	1	LED	160W	4000K	SUSPENDED	COORDINATE SUSPENSION LENGTH AND EXAC LOCATION WITH ARCHITECTURAL TRADE			
'L7'	LITHONIA LIGHTING 2GTL-2-48L-GZ10-LP840	RECESSED 2'x2' TROFFER	120V	1	LED	42W	4000K	RECESSED	-			
'L8'	LITHONIA LIGHTING FMLWL-48-840-MVOLT	RECESSED FIXTURE	120V	1	LED	42W	4000K	SURFACE	PATCH EXISTING CEILING AROUND FIXTURE. FINISHES TO MATCH EXISTING.			
'L9'	HOLOPHANE PARKPAK PPSQL2-P10-40K-PY-TSE	RECESSED EXTERIOR FIXTURE	120V	1	LED	25W	4000K	RECESSED	PATCH EXISTING SOFFIT AROUND FIXTURE. FINISHES TO MATCH EXISTING.			
'L10'	LITHONIA LIGHTING MNSL-L48-2LL-MVOLT-40K-80CRI-M6	SUSPENDED STRIP FIXTURE	120V	1	LED	35W	4000K	SUSPENDED	-			
BU	BEGHELLI TEMPESTA LED TA-LED-SE-UNV-TB	EMERGENCY LIGHT WITH BATTERY PACK	120V	1	LED	2.3W	-	RECESSED	RECESSED IN ACT CEILING, C/W MINIMUM 90MIN BATTERY BACKUP.			
<b>③</b> ⊗	BEGHELLI FORTE RM FR-RM-SP-L-1/2-OLR-W/C-90SP	GREEN RUNNING MAN PICTOGRAM EXIT SIGN (SINGLE/DUAL FACE)	120V	1	LED	_	-	WALL/CEILING MOUNTED	COMPLETE WITH INTEGRAL STANDALONE 90MIN BATTERY BACKUP.			

	E	XISTIN	IG PANE	L 'LP-	-2'	
VOLTAGE: <u>120/208V, 3PH,</u>	4W, 20 CC	<u>T</u>		NEW		EXISTING
MAINS: <u>60A</u> ,				MOU	NTING: S	SURFACE
TYPE: <u>POWER PANEL</u>				LOCA	ATION: <u>[</u>	BOILER ROOM
LOAD DESCRIPTION	BRKR.	CCT.	PHASE	ССТ.	BRKR.	LOAD DESCRIPTION
EOAD DESCRIPTION	SIZE	No.	А В	No.	SIZE	EOAD DESCRIPTION
PUMP 8	15A	1	+ +	2	15A	PUMP 5
FOME 8	2P	3	+	4	15A	SOUTH RECEPTACLE
DIMD 7	15A	5	+ +	6	15A	BOILER #2
PUMP 7	2P	7	+	8	15A	BOILER #1
PUMP 6	15A	9	+	10	15A	SPARE
FUMP 0	2P	11	<del>                                     </del>	12	15A	SPARE
		13	+	14		
		15	<b>-</b>	16		
		17	<del>                                     </del>	18		
		19	+	20		



VOLTAGE: <u>120/208V, 3PH,</u> MAINS: <u>100A, MLO, 18kAI</u>		_			NEW		EXISTING
TYPE: <u>POWER PANEL</u>	<u> </u>					_	BOILER ROOM
LOAD DESCRIPTION	BRKR. SIZE	CCT.		ASE B C	CCT.	BRKR. SIZE	LOAD DESCRIPTION
WEST WING SMOKE DAMPER CCT#1	15A	1	+		2	20A	MAINTENANCE RECEPTACLE
WEST WING SMOKE DAMPER CCT#2	15A	3	]		4	15A	SOUTH RECEPTACLE
WEST WING SMOKE DAMPER CCT#3	15A	5	<del>                                     </del>	+	6	15A	BOILER #2
E-5	15A	7	]∳—		8	15A	BOILER #1
DUMP 0	15A	9	}		10	15A	EF-3 / EF-4
PUMP 6	2P	11		+	12	20A	ROOFTOP RECEPTACLE
BAS SYSTEM SUPPLY	15A	13	<del>                                     </del>		14	20A	ROOFTOP RECEPTACLE
BAS SYSTEM SUPPLY	15A	15	}		16		
NIGHT LIGHTING	15A	17		+	18		
CUH-1, CUH-2 & CUH-6	15A	19	<del> </del>		20		
CUH-3, CUH-4 & CUH-5	15A	21	}		22		
		23		+	24		
		25	<del> </del>		26		
		27	}		28		
		29		+	- 30		
		31	<del> </del>		32		
		33	}	$\vdash$	34		
		35		+	- 36		
		37	<b> </b>		- 38		
		39		$\vdash$	40		
		41		+	42		

2	NEW "LP-2" PANEL SCHEDULE
<b>E1</b>	SCALE: N.T.S.

	SWB	8-1 SWITCHBOARD DISTRIBUTIO	ON LOAD SCHEDUL	E (400A,600/347V,	3PH,4W)	
LOAD ID	LOAD DESCRIPTION	OVERCURRENT DEVICE TYPE	DEVICE AMP RATING	VOLTAGE	WIRING	# OF POLES
A1	EXISTING SWB	MOLDED CASE BREAKER	175A	600V	3-#3/0 CU + GND	3
A2	PHASE LOSS RLY	MOLDED CASE BREAKER	15A	600V	3-#12 AWG CU + GND	3
А3	SPD	MOLDED CASE BREAKER	30A	600V	3-#10 AWG CU + GND	3
A4	HVAC-1	MOLDED CASE BREAKER	15A	600V	3-#12 AWG CU + GND	3
A5	HVAC-2	MOLDED CASE BREAKER	25A	600V	3-#10 AWG CU + GND	3
A6	HVAC-3	MOLDED CASE BREAKER	25A	600V	3-#10 AWG CU + GND	3
Α7	HVAC-4	MOLDED CASE BREAKER	20A	600V	3-#10 AWG CU + GND	3
A8	HVAC-5	MOLDED CASE BREAKER	25A	600V	3-#10 AWG CU + GND	3
A9	ERV-1/ERV-2	MOLDED CASE BREAKER	15A	600V	3-#12 AWG CU + GND	3
A10	PUMP P-1	MOLDED CASE BREAKER	15A	600V	3-#12 AWG CU + GND	3
A11	PUMP P-2	MOLDED CASE BREAKER	15A	600V	3-#12 AWG CU + GND	3



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No.	Revision	Date	Ву
5.	ISSUED PERMIT / TENDER	21 MAY 11	СР
6.	ISSUED FOR 90% REVIEW	21 DEC 03	DB
7.	ISSUED FOR 90% REVIEW	22 JAN 21	DB
8.	ISSUED FOR PERMIT	22 FEB 03	СР
9.	ISSUED FOR TENDER	22 FEB 15	СР



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BOLD Tel: 416-556-0766 Fax: 1-866-876-5758

engineering www.boldengineering.ca

Project Name

WRDSB - WORKSHOP
ARCHITECTURE
HVAC UPGRADES & INTERIOR RENOVATIONS
SMITHSON PUBLIC SCHOOL

150 BELLVIEW AVENUE, KITCHENER
Sheet Title

ELECTRICAL LEGEND AND SCHEDULES


Drawn By DB Scale As Shown

Designed By DB Date November 26, 2020 Project Number **B20-349.02A** 

Sheet Number

Revision

E1

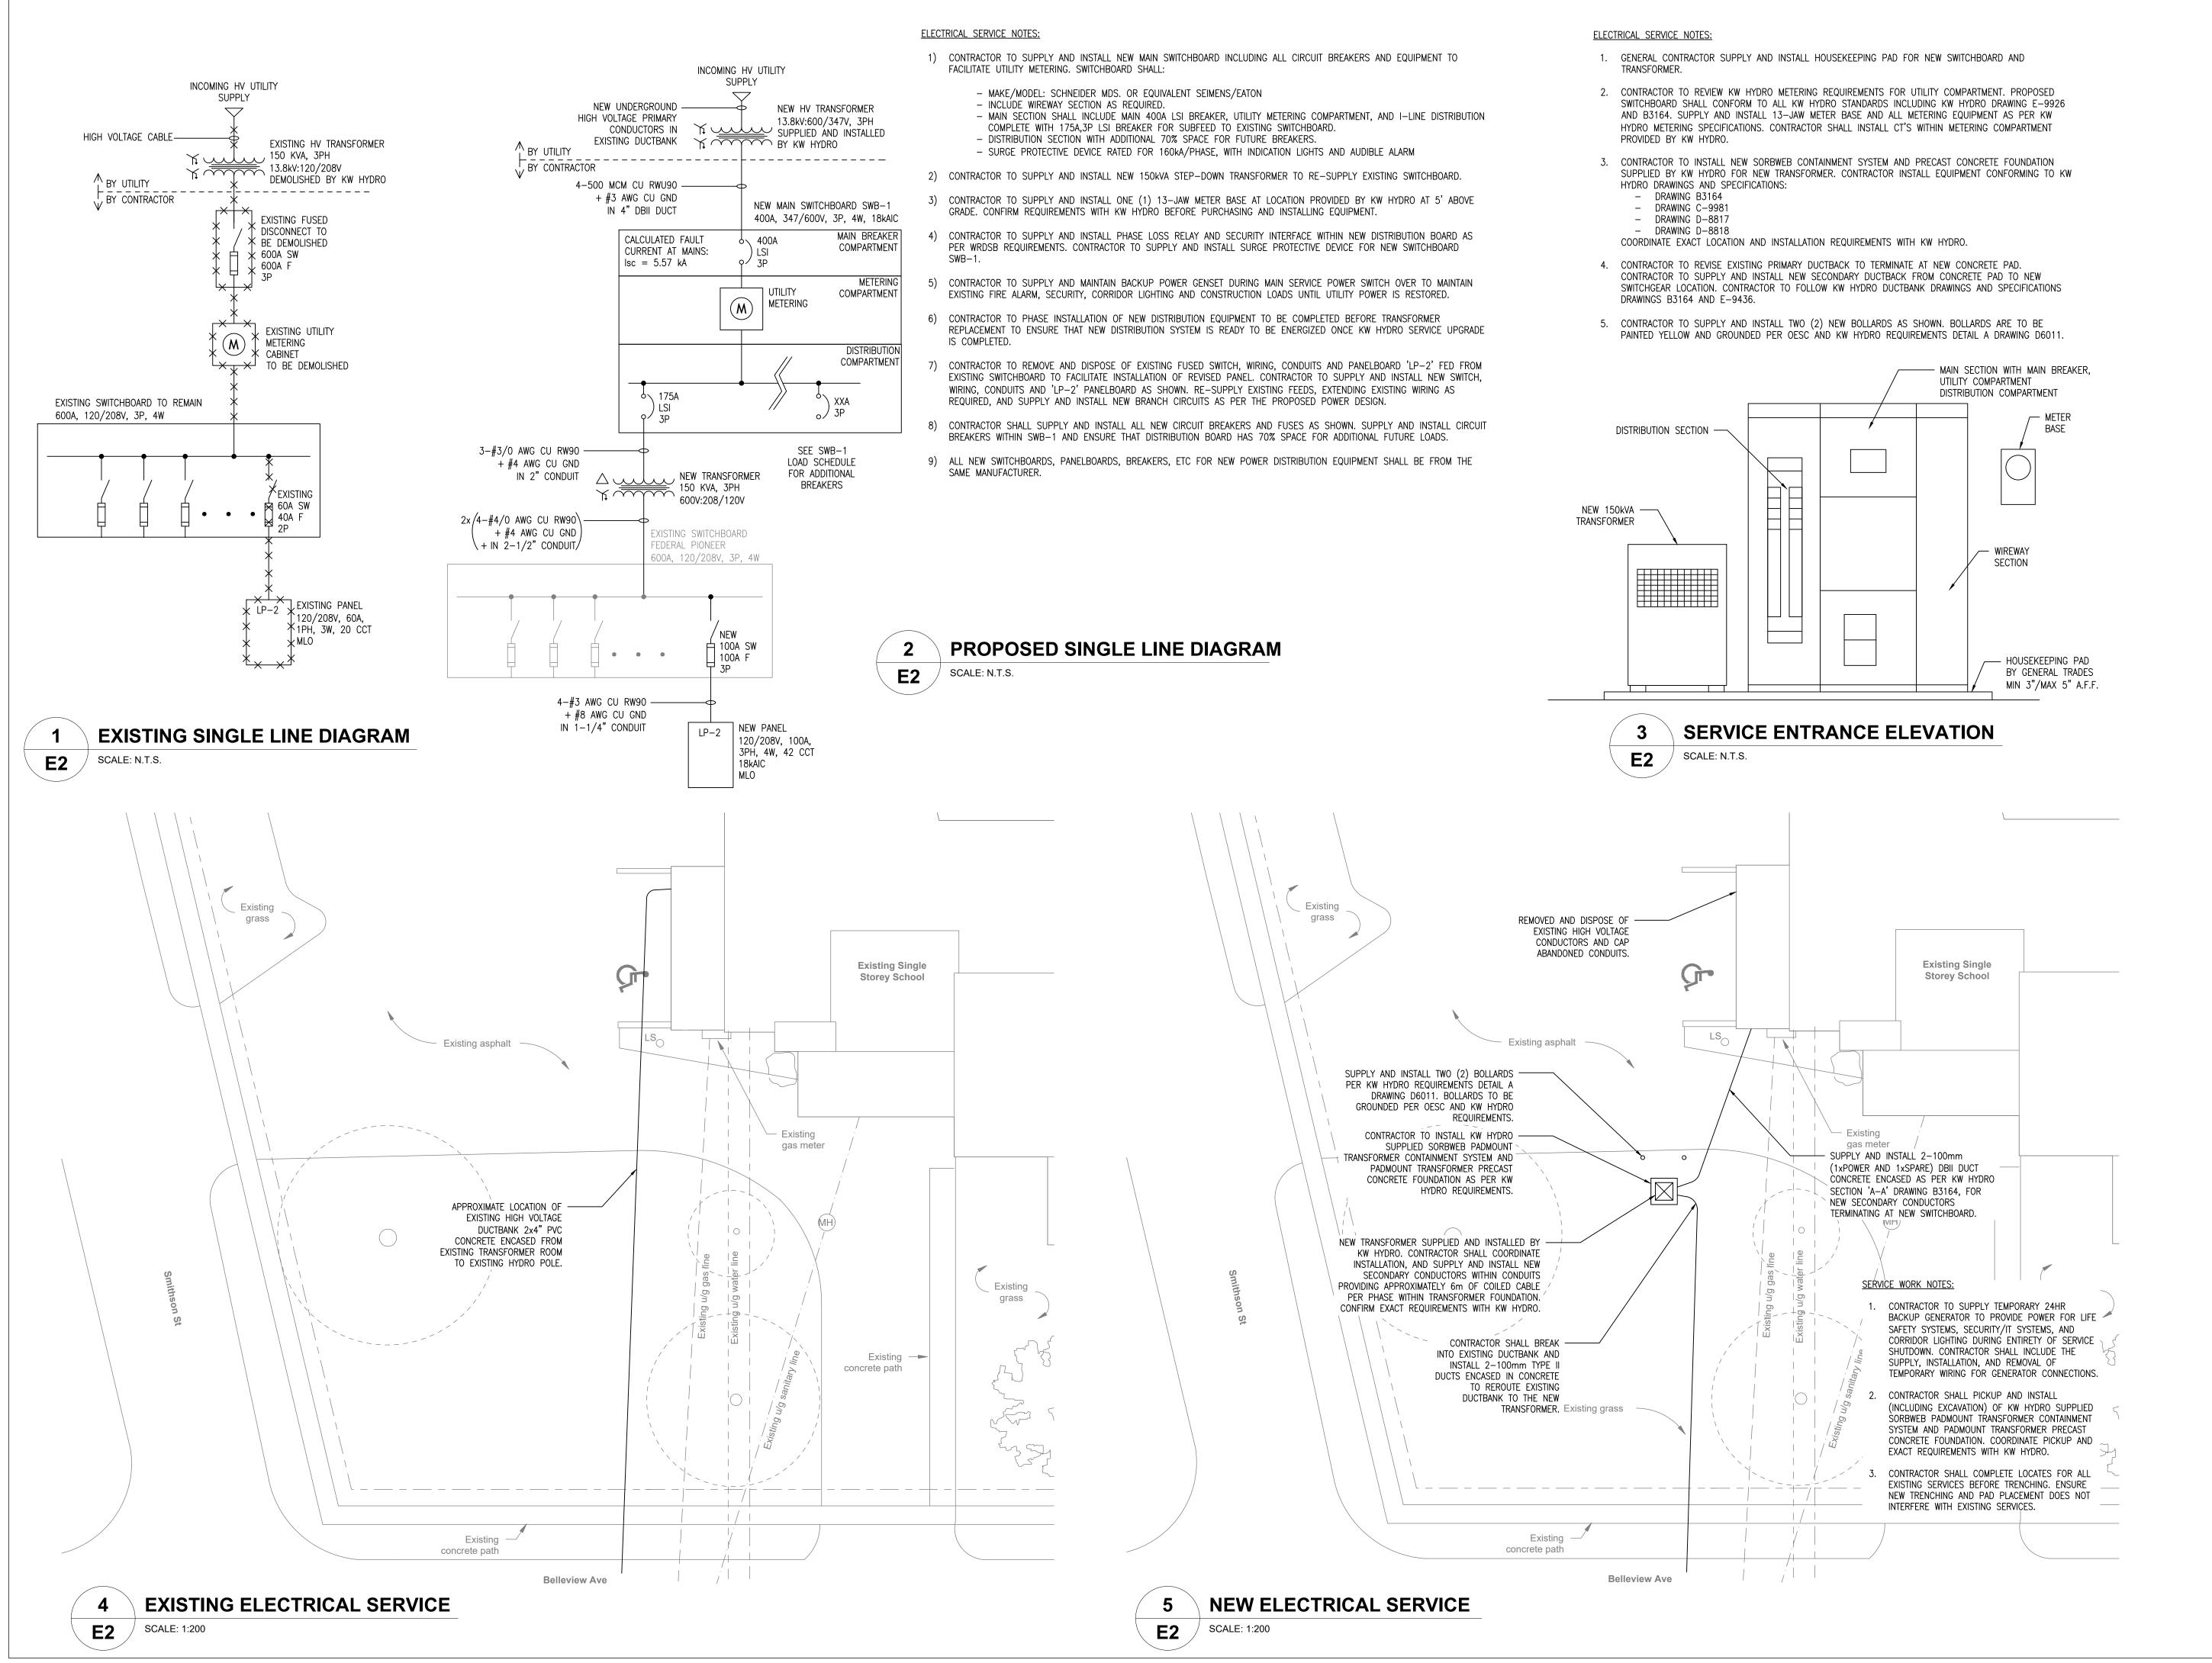

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	9.	ISSUED FOR TENDER	22 FEB 15	СР
	8.	ISSUED FOR PERMIT	22 FEB 03	СР
	7.	ISSUED FOR 90% REVIEW	22 JAN 21	DB
•	6.	ISSUED FOR 90% REVIEW	21 DEC 03	DB
	5.	ISSUED PERMIT / TENDER	21 MAY 11	СР
·	No.	Revision	Date	Ву



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Tel: 416-556-0766

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Project Name

WRDSB - WORKSHOP ARCHITECTURE **HVAC UPGRADES & INTERIOR RENOVATIONS** 

SMITHSON PUBLIC SCHOOL 150 BELLVIEW AVENUE, KITCHENER


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**ELECTRICAL SINGLE LINE** DIAGRAM AND SITE PLAN


Drawn By DB Scale As Shown Designed By DB Date November 26, 2020

Project Number B20-349.02A

**Sheet Number** Revision

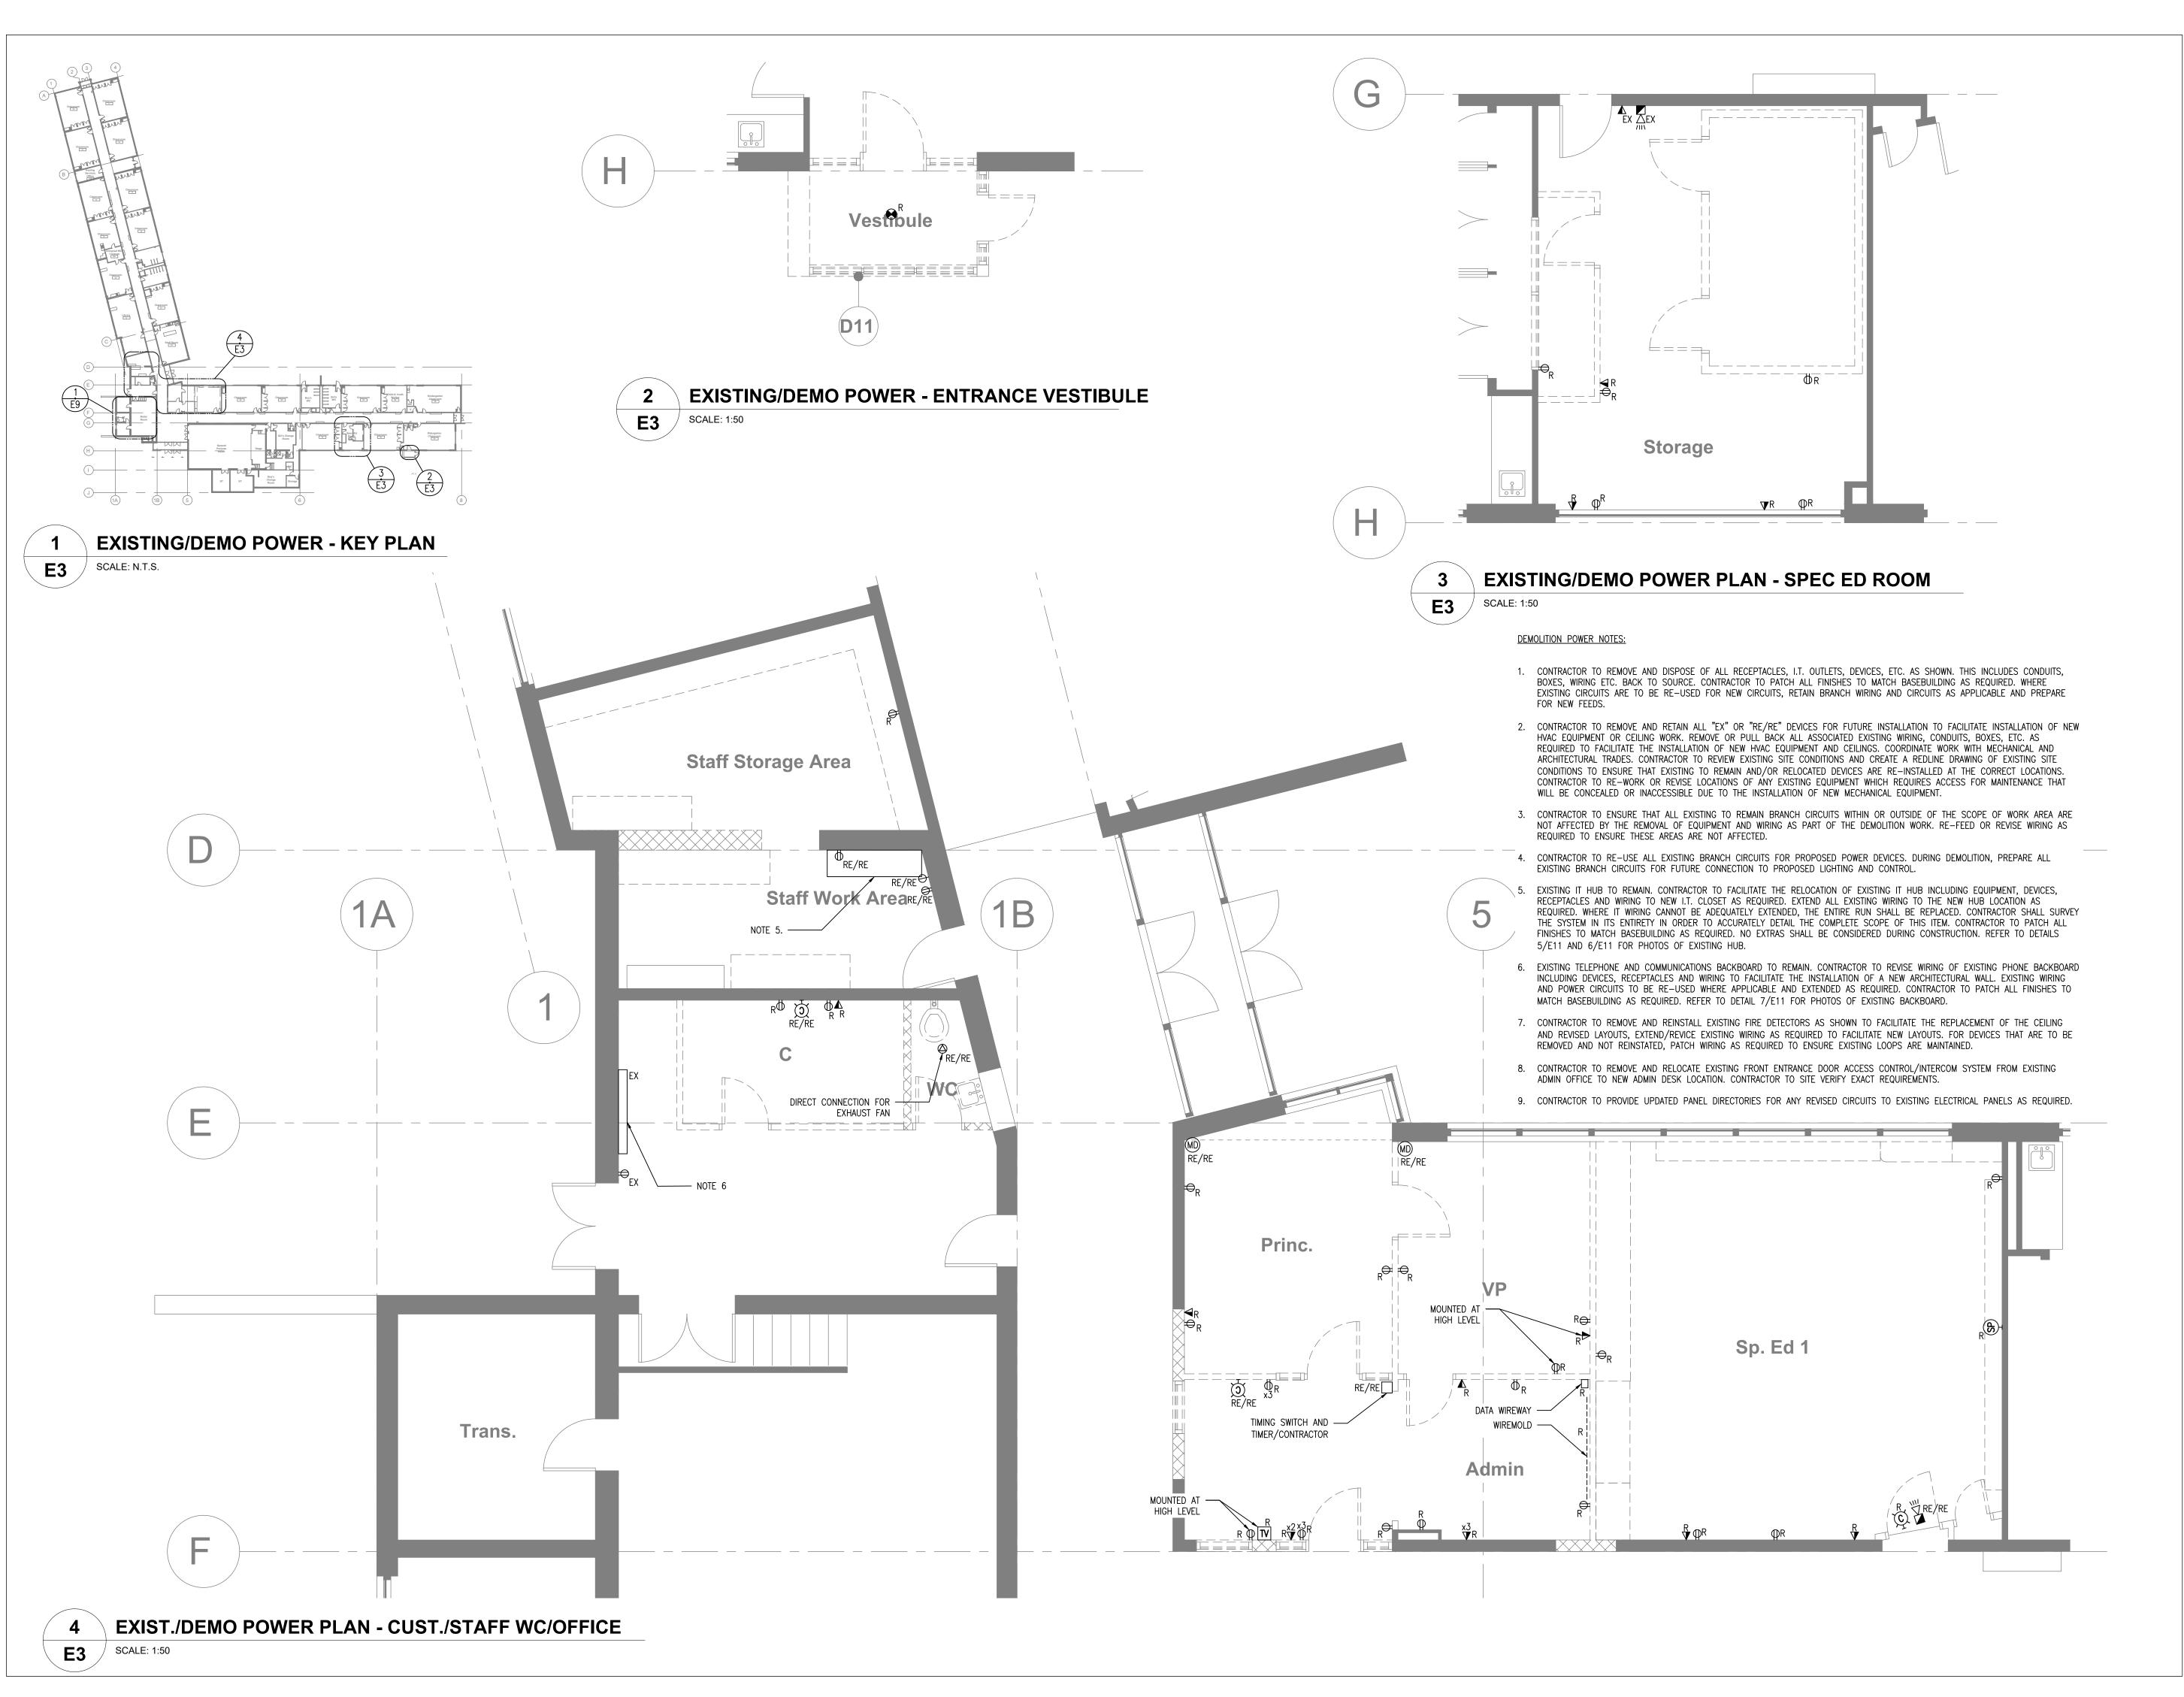

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KEY PLAN (N.T.S.)

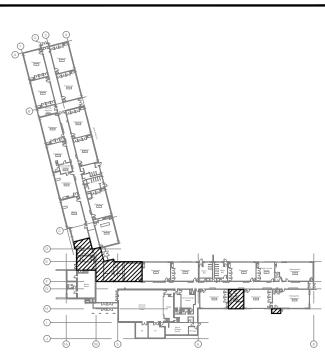

No.	Revision	Date	Ву
No	Povision	Data	Dv
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Project Name

WRDSB - WORKSHOP ARCHITECTURE

HVAC UPGRADES & INTERIOR RENOVATIONS SMITHSON PUBLIC SCHOOL

150 BELLVIEW AVENUE, KITCHENER

Sheet Title

## EXISTING/DEMO POWER PLANS


Drawn By DB Scale As Shown
Designed By DB Date November 26, 2020

Sheet Number


Project Number B20-349.02A


E3

Revision

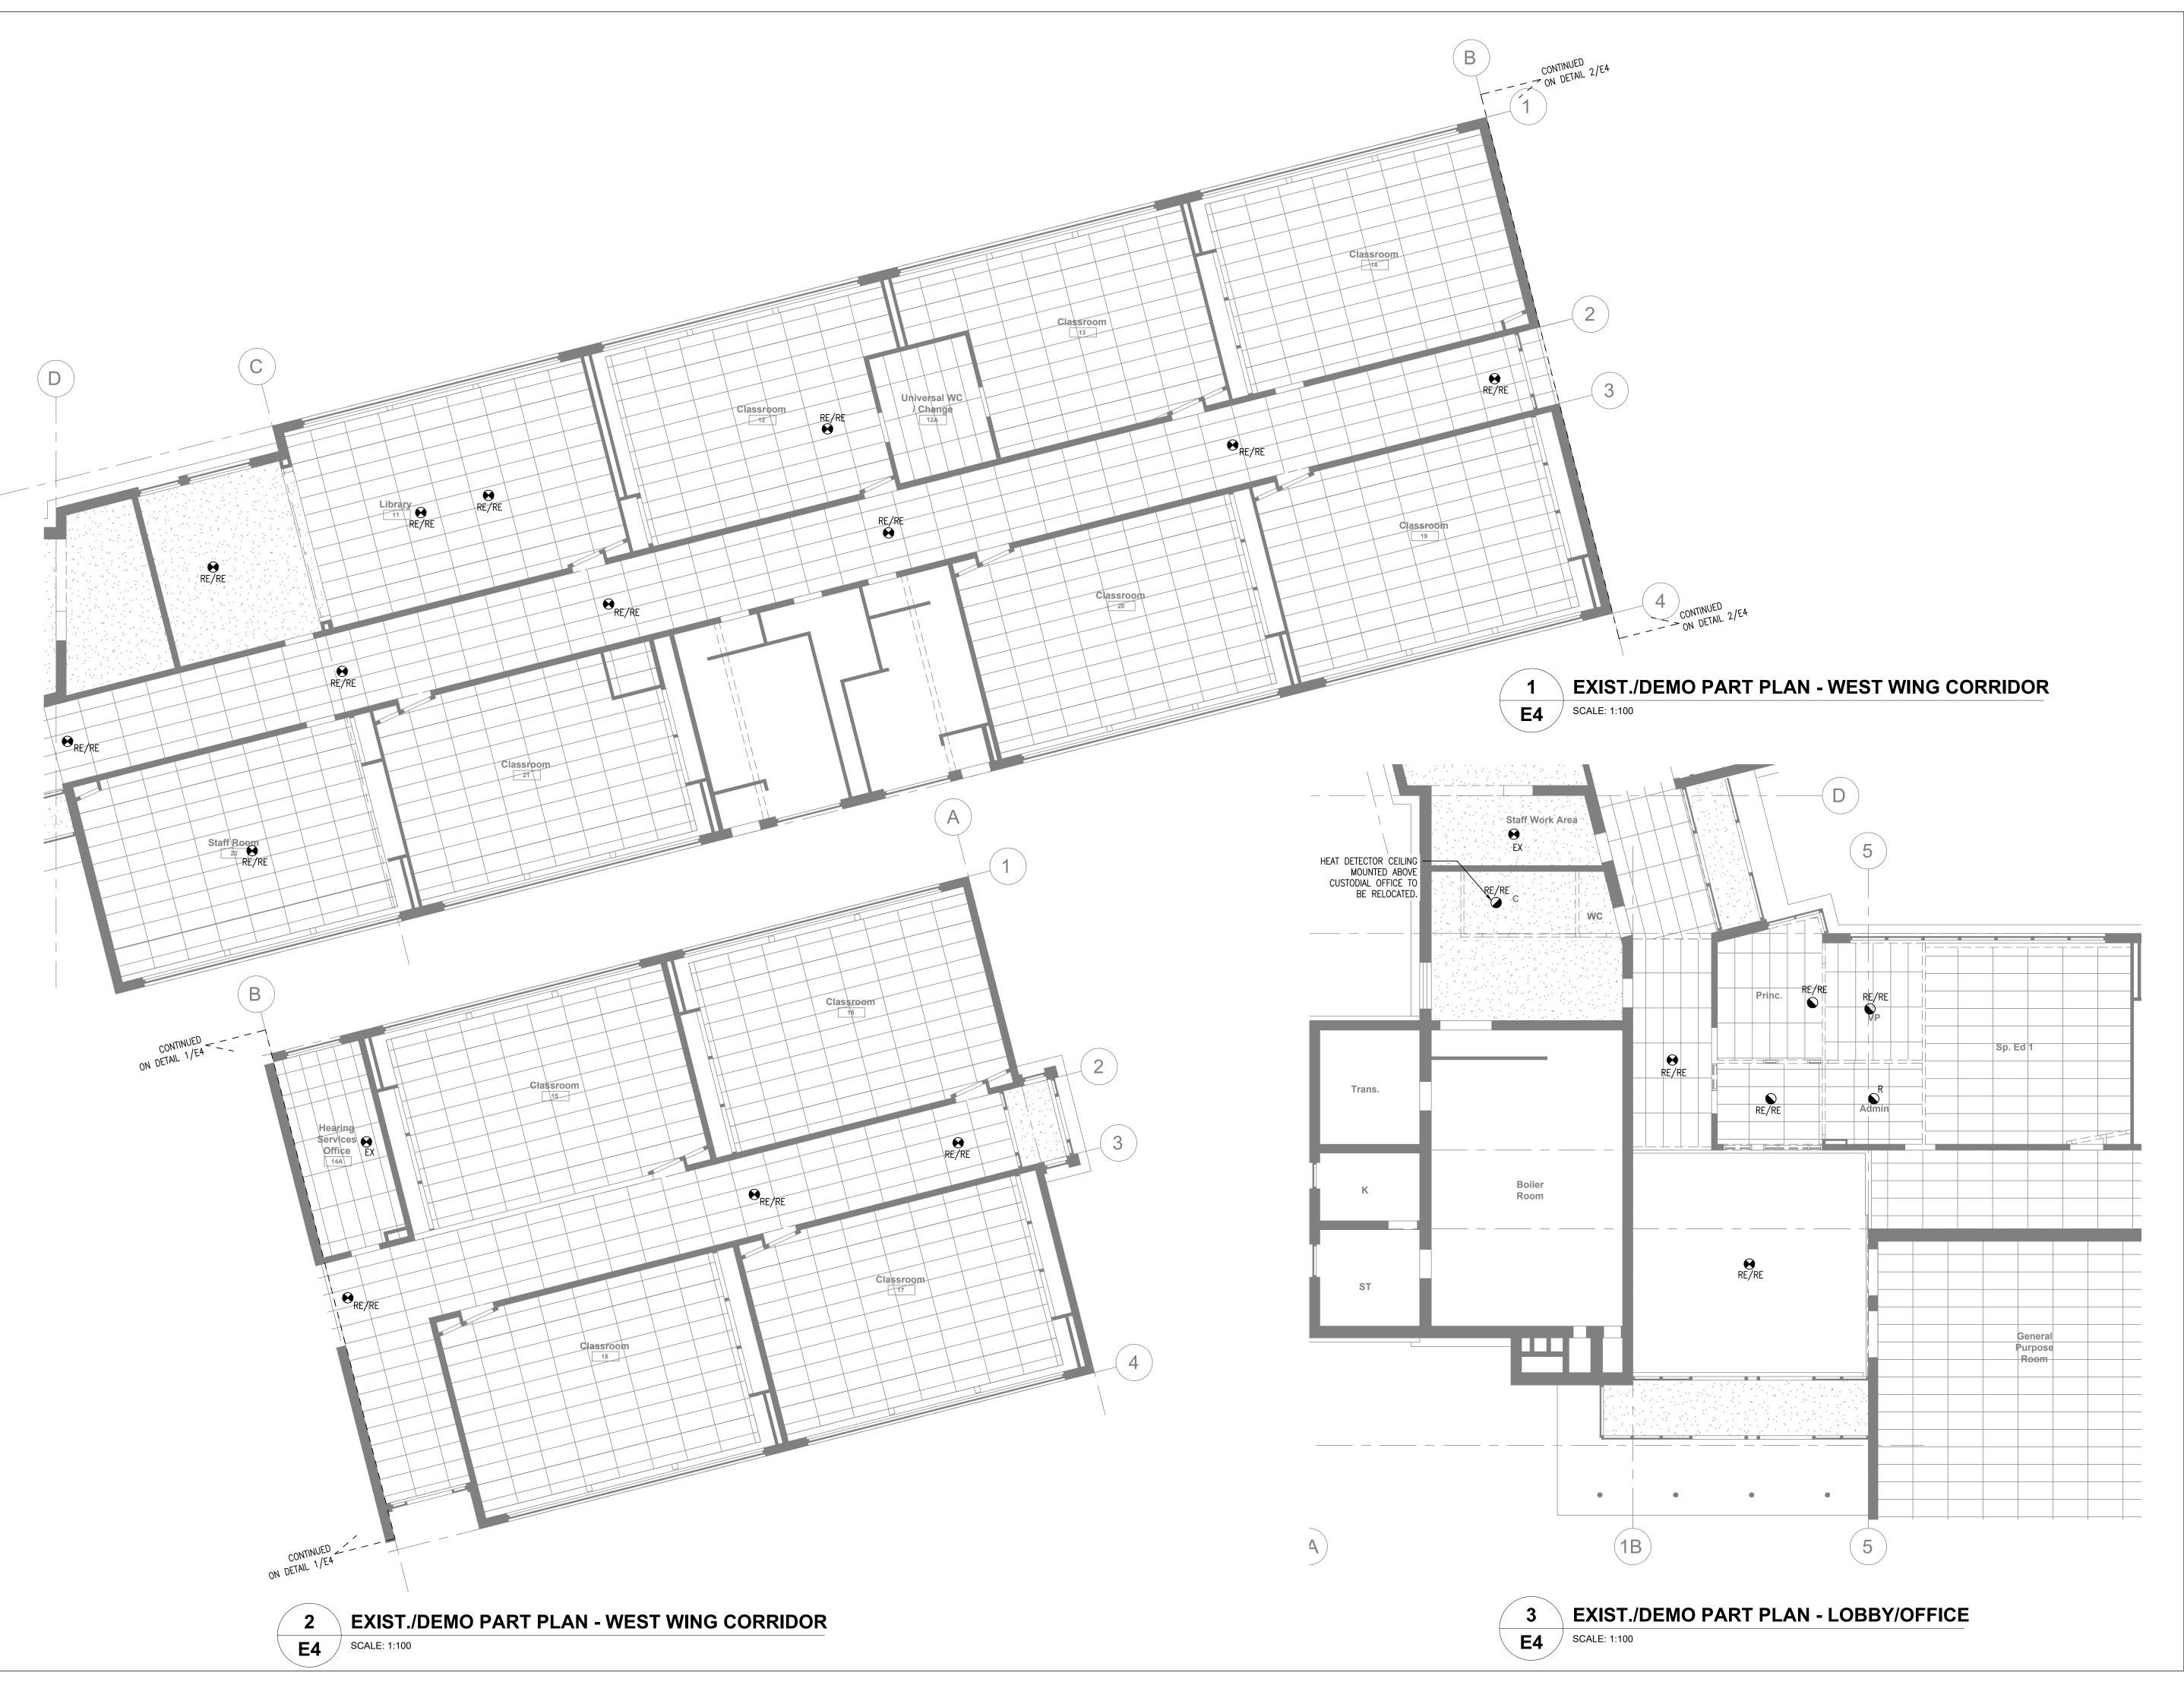

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Project Name

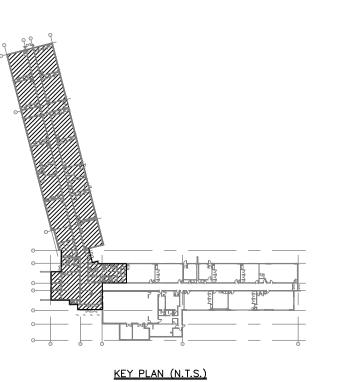WRDSB - WORKSHOP ARCHITECTURE HVAC UPGRADES & INTERIOR RENOVATIONS SMITHSON PUBLIC SCHOOL

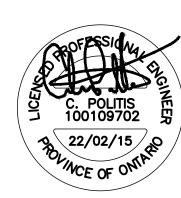150 BELLVIEW AVENUE, KITCHENER


Sheet Title EXISTING/DEMO FIRE ALARM **PLANS** 

Drawn By DB Scale As Shown Designed By DB Date November 26, 2020


Project Number **B20-349.02A** 

**E4** 

Sheet Number Revision

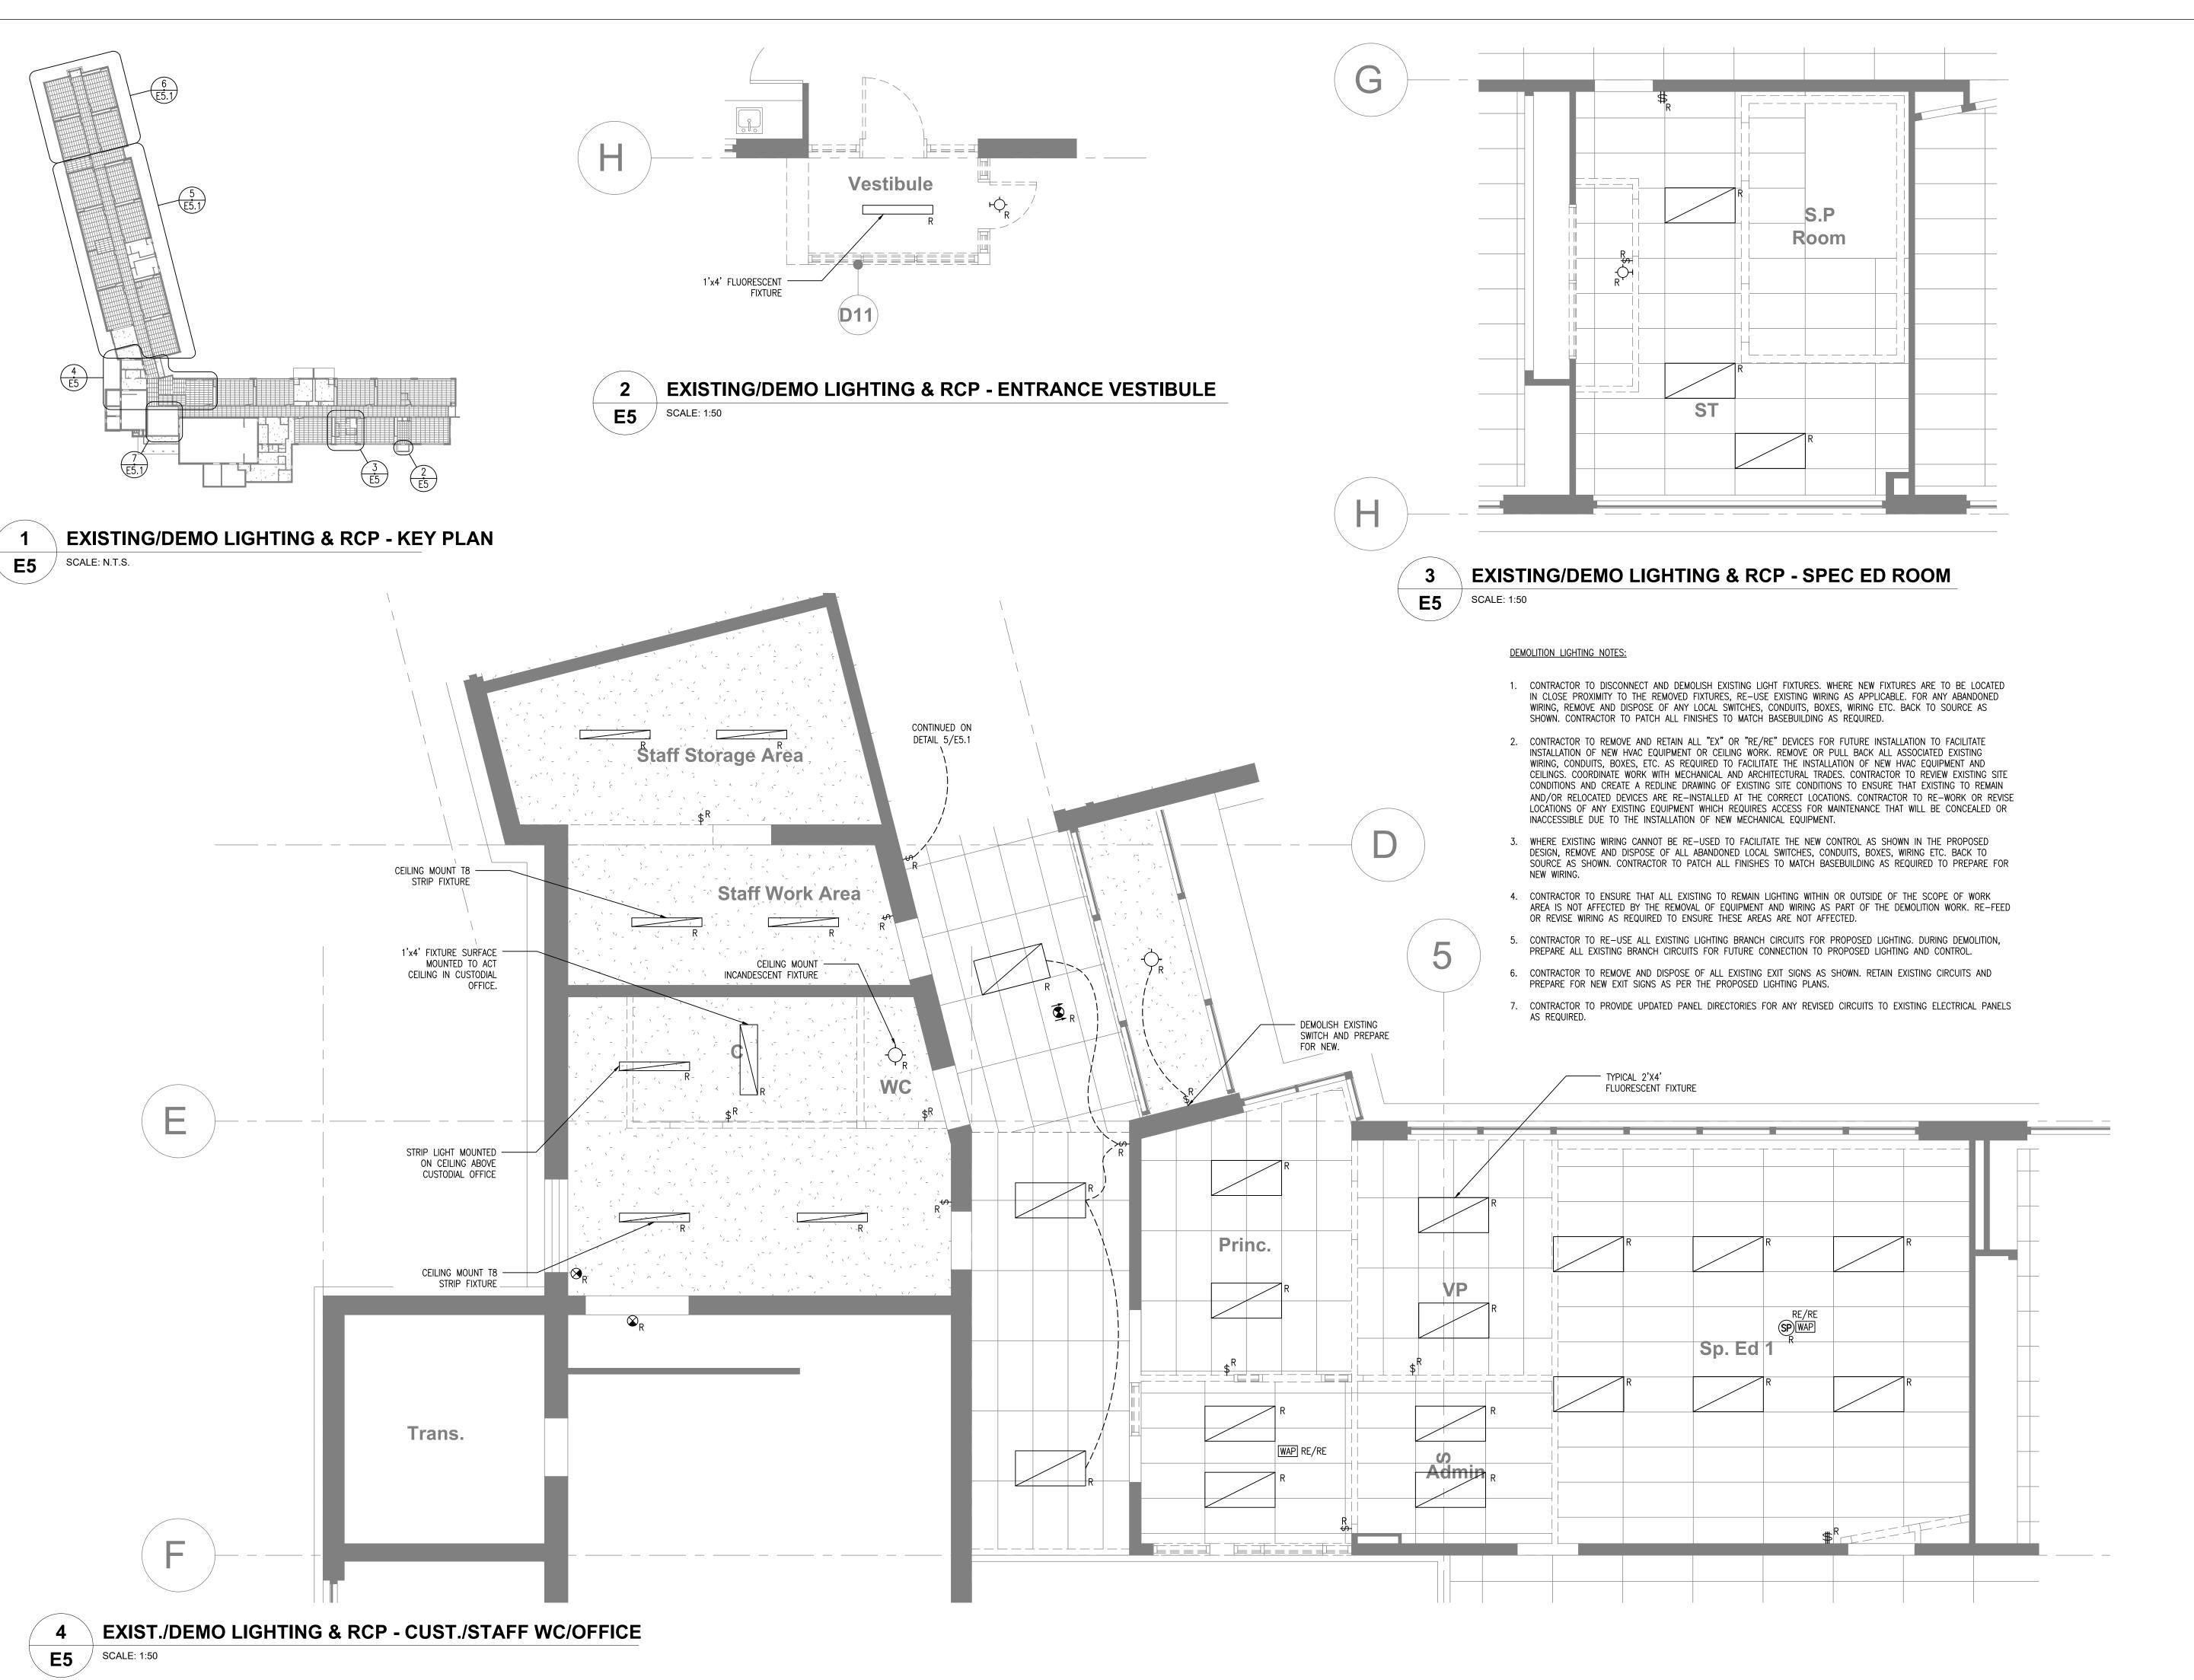

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KEA DI VII (N 16)

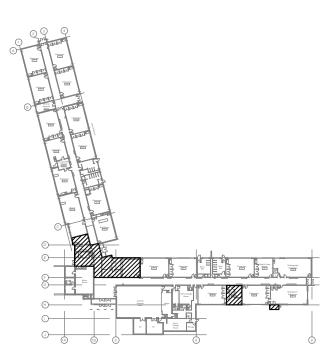

9.	ISSUED FOR TENDER	22 FEB 15	СР
8.	ISSUED FOR PERMIT	22 FEB 03	СР
7.	ISSUED FOR 90% REVIEW	22 JAN 21	DB
6.	ISSUED FOR 90% REVIEW	21 DEC 03	DB
5.	ISSUED PERMIT / TENDER	21 MAY 11	СР
No.	Revision	Date	Ву
	8. 7. 6. 5.	<ul> <li>8. ISSUED FOR PERMIT</li> <li>7. ISSUED FOR 90% REVIEW</li> <li>6. ISSUED FOR 90% REVIEW</li> <li>5. ISSUED PERMIT / TENDER</li> </ul>	<ul> <li>8. ISSUED FOR PERMIT 22 FEB 03</li> <li>7. ISSUED FOR 90% REVIEW 22 JAN 21</li> <li>6. ISSUED FOR 90% REVIEW 21 DEC 03</li> <li>5. ISSUED PERMIT / TENDER 21 MAY 11</li> </ul>



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WRDSB - WORKSHOP ARCHITECTURE

HVAC UPGRADES & INTERIOR RENOVATIONS SMITHSON PUBLIC SCHOOL

150 BELLVIEW AVENUE, KITCHENER

Sheet Title

## EXISTING/DEMO LIGHTING & REFLECTED CEILING PLANS

Drawn By DB Scale As Shown
Designed By DB Date November 26, 2020


Sheet Number

Project Number B20-349.02A

E5



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VEY DIAN (NTC)

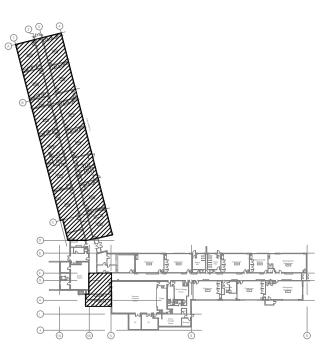

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'	No.	Revision	Date	Ву
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	9.	ISSUED FOR TENDER	22 FEB 15	СР



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Project Name

WRDSB - WORKSHOP ARCHITECTURE

HVAC UPGRADES & INTERIOR RENOVATIONS SMITHSON PUBLIC SCHOOL

150 BELLVIEW AVENUE, KITCHENER

Sheet Title


E5.1

# EXISTING/DEMO LIGHTING & REFLECTED CEILING PLANS


Drawn By DB Scale As Shown
Designed By DB Date November 26, 2020

Project Number **B20-349.02A**Sheet Number

nber Revision

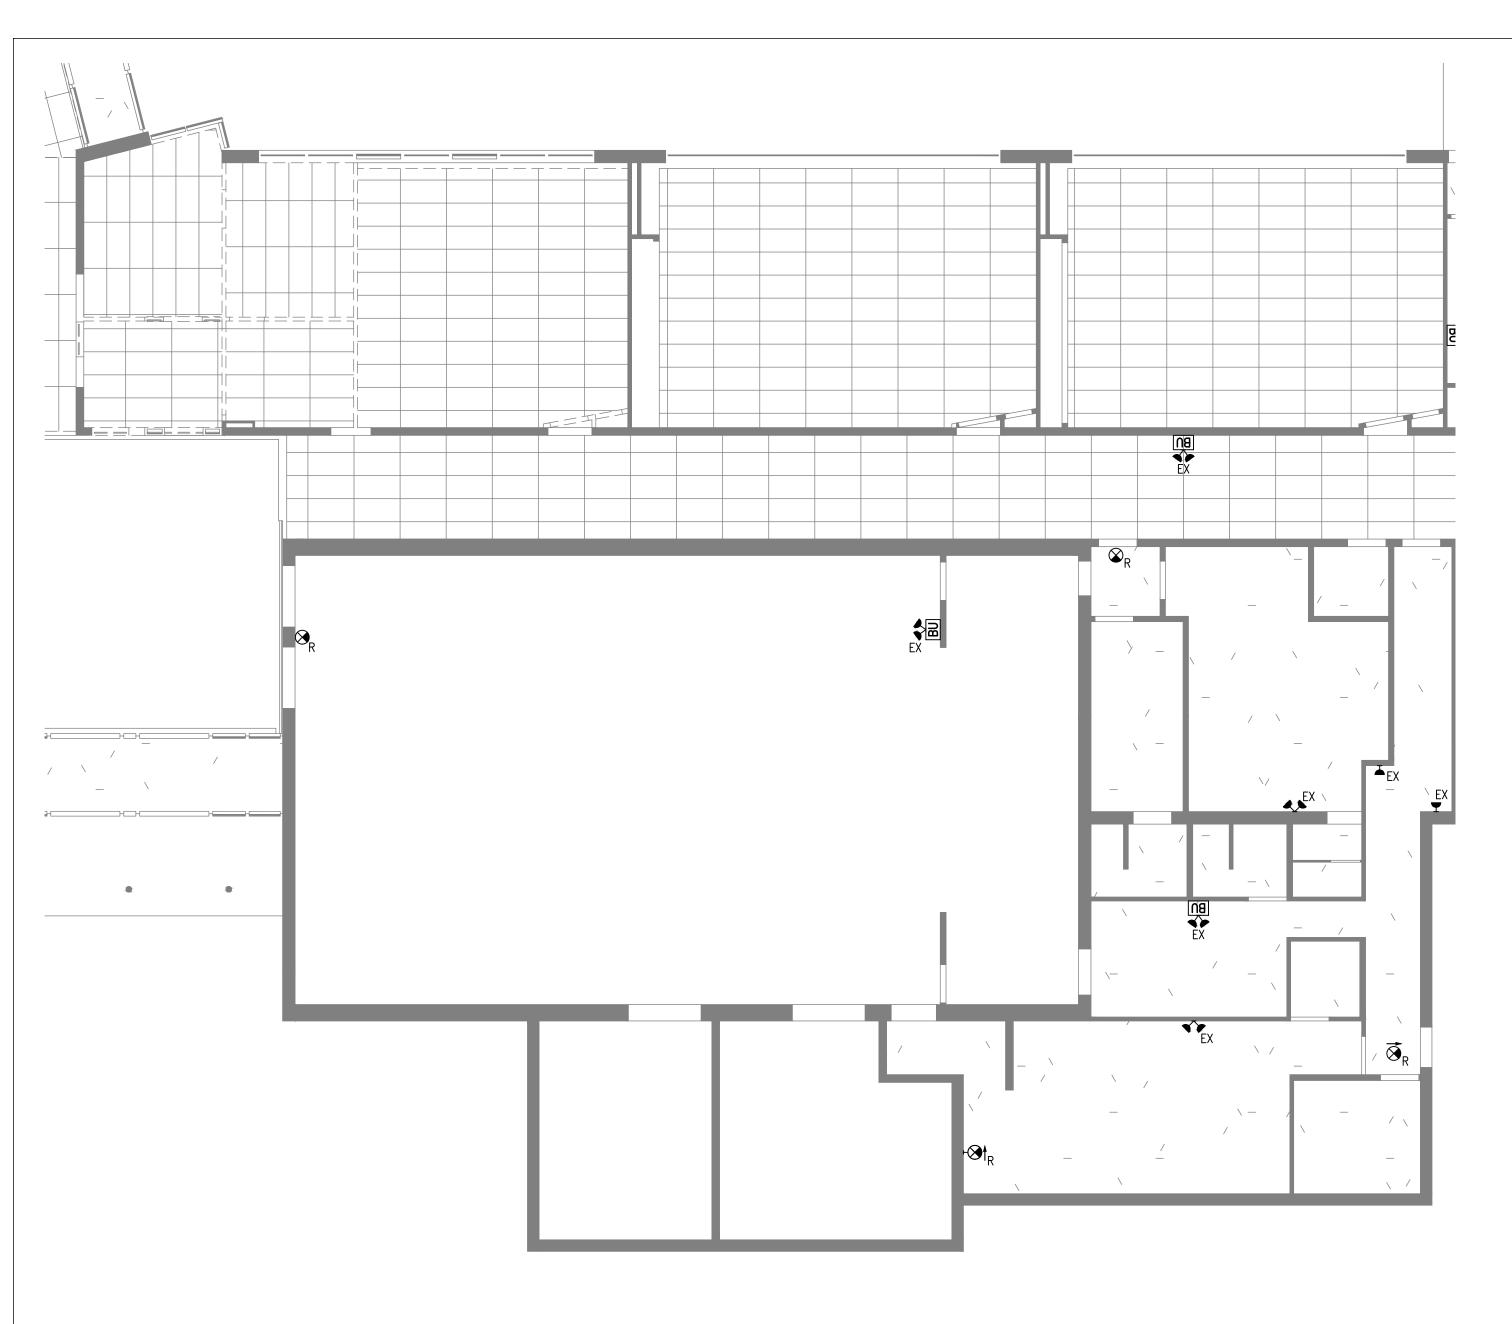

## EXIST./DEMO EM LITG/EXISTS - EAST WING/GYM **E5.2** SCALE: 1:100

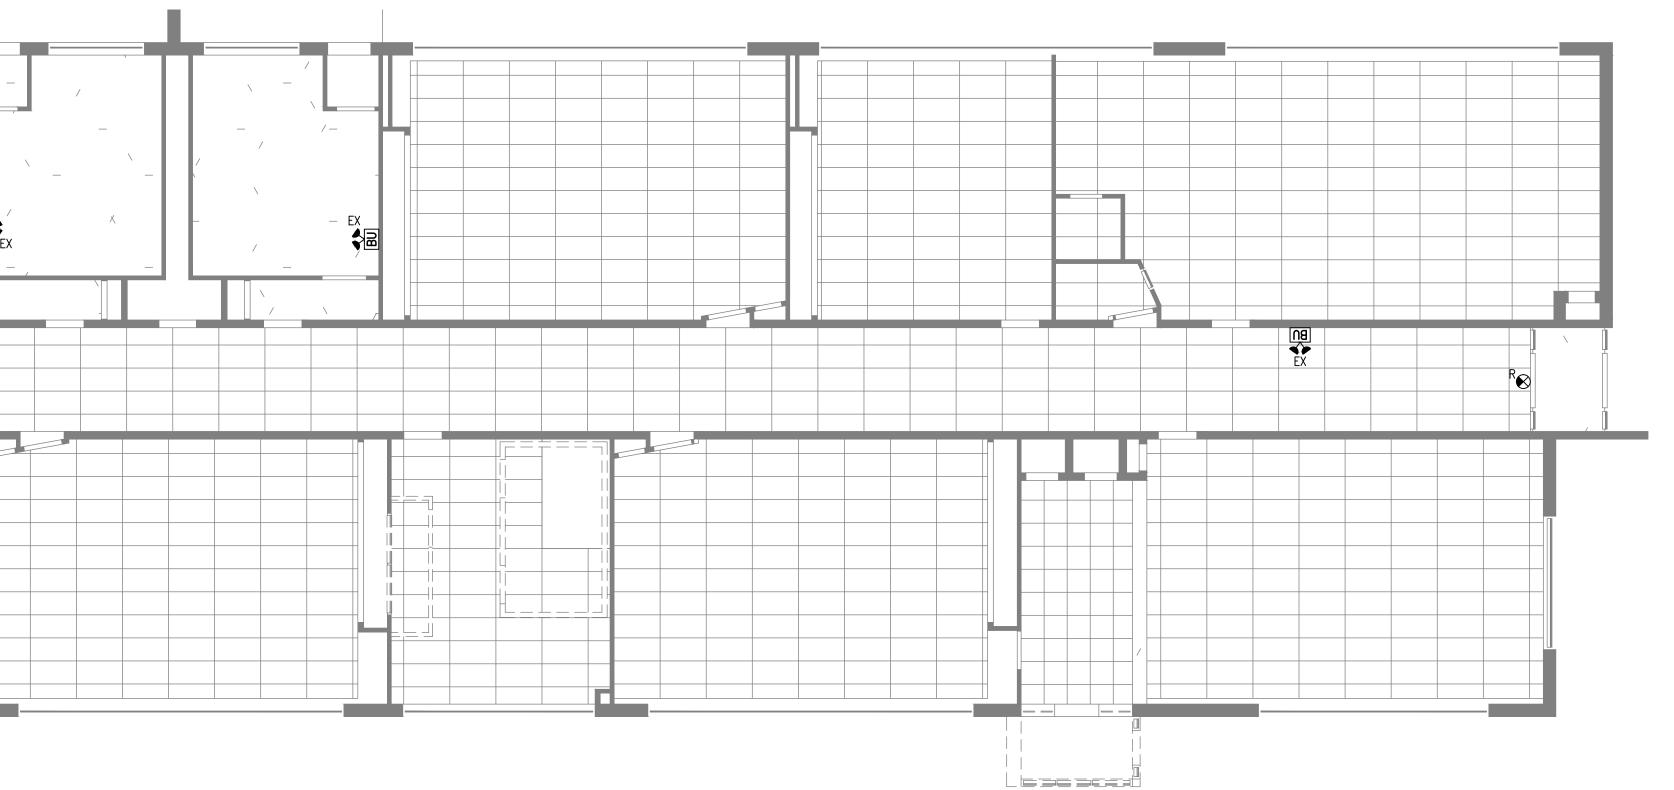


**EXISTING/DEMO EM LLTG/EXITS - EAST WING COORIDOR** 

**E5.2** SCALE: 1:100

## **Drawing Notes**

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9		ISSUED FOR TENDER	22 FEB 15	СР

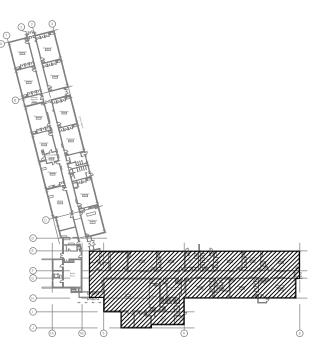

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WRDSB - WORKSHOP ARCHITECTURE

HVAC UPGRADES & INTERIOR RENOVATIONS SMITHSON PUBLIC SCHOOL

150 BELLVIEW AVENUE, KITCHENER

Sheet Title

## EXISTING/DEMO EMERGENCY LIGHTING & EXIT SIGN PLANS


Drawn By DB Scale As Shown Designed By DB Date November 26, 2020

Sheet Number


Project Number **B20-349.02A** 

E5.2

Revision

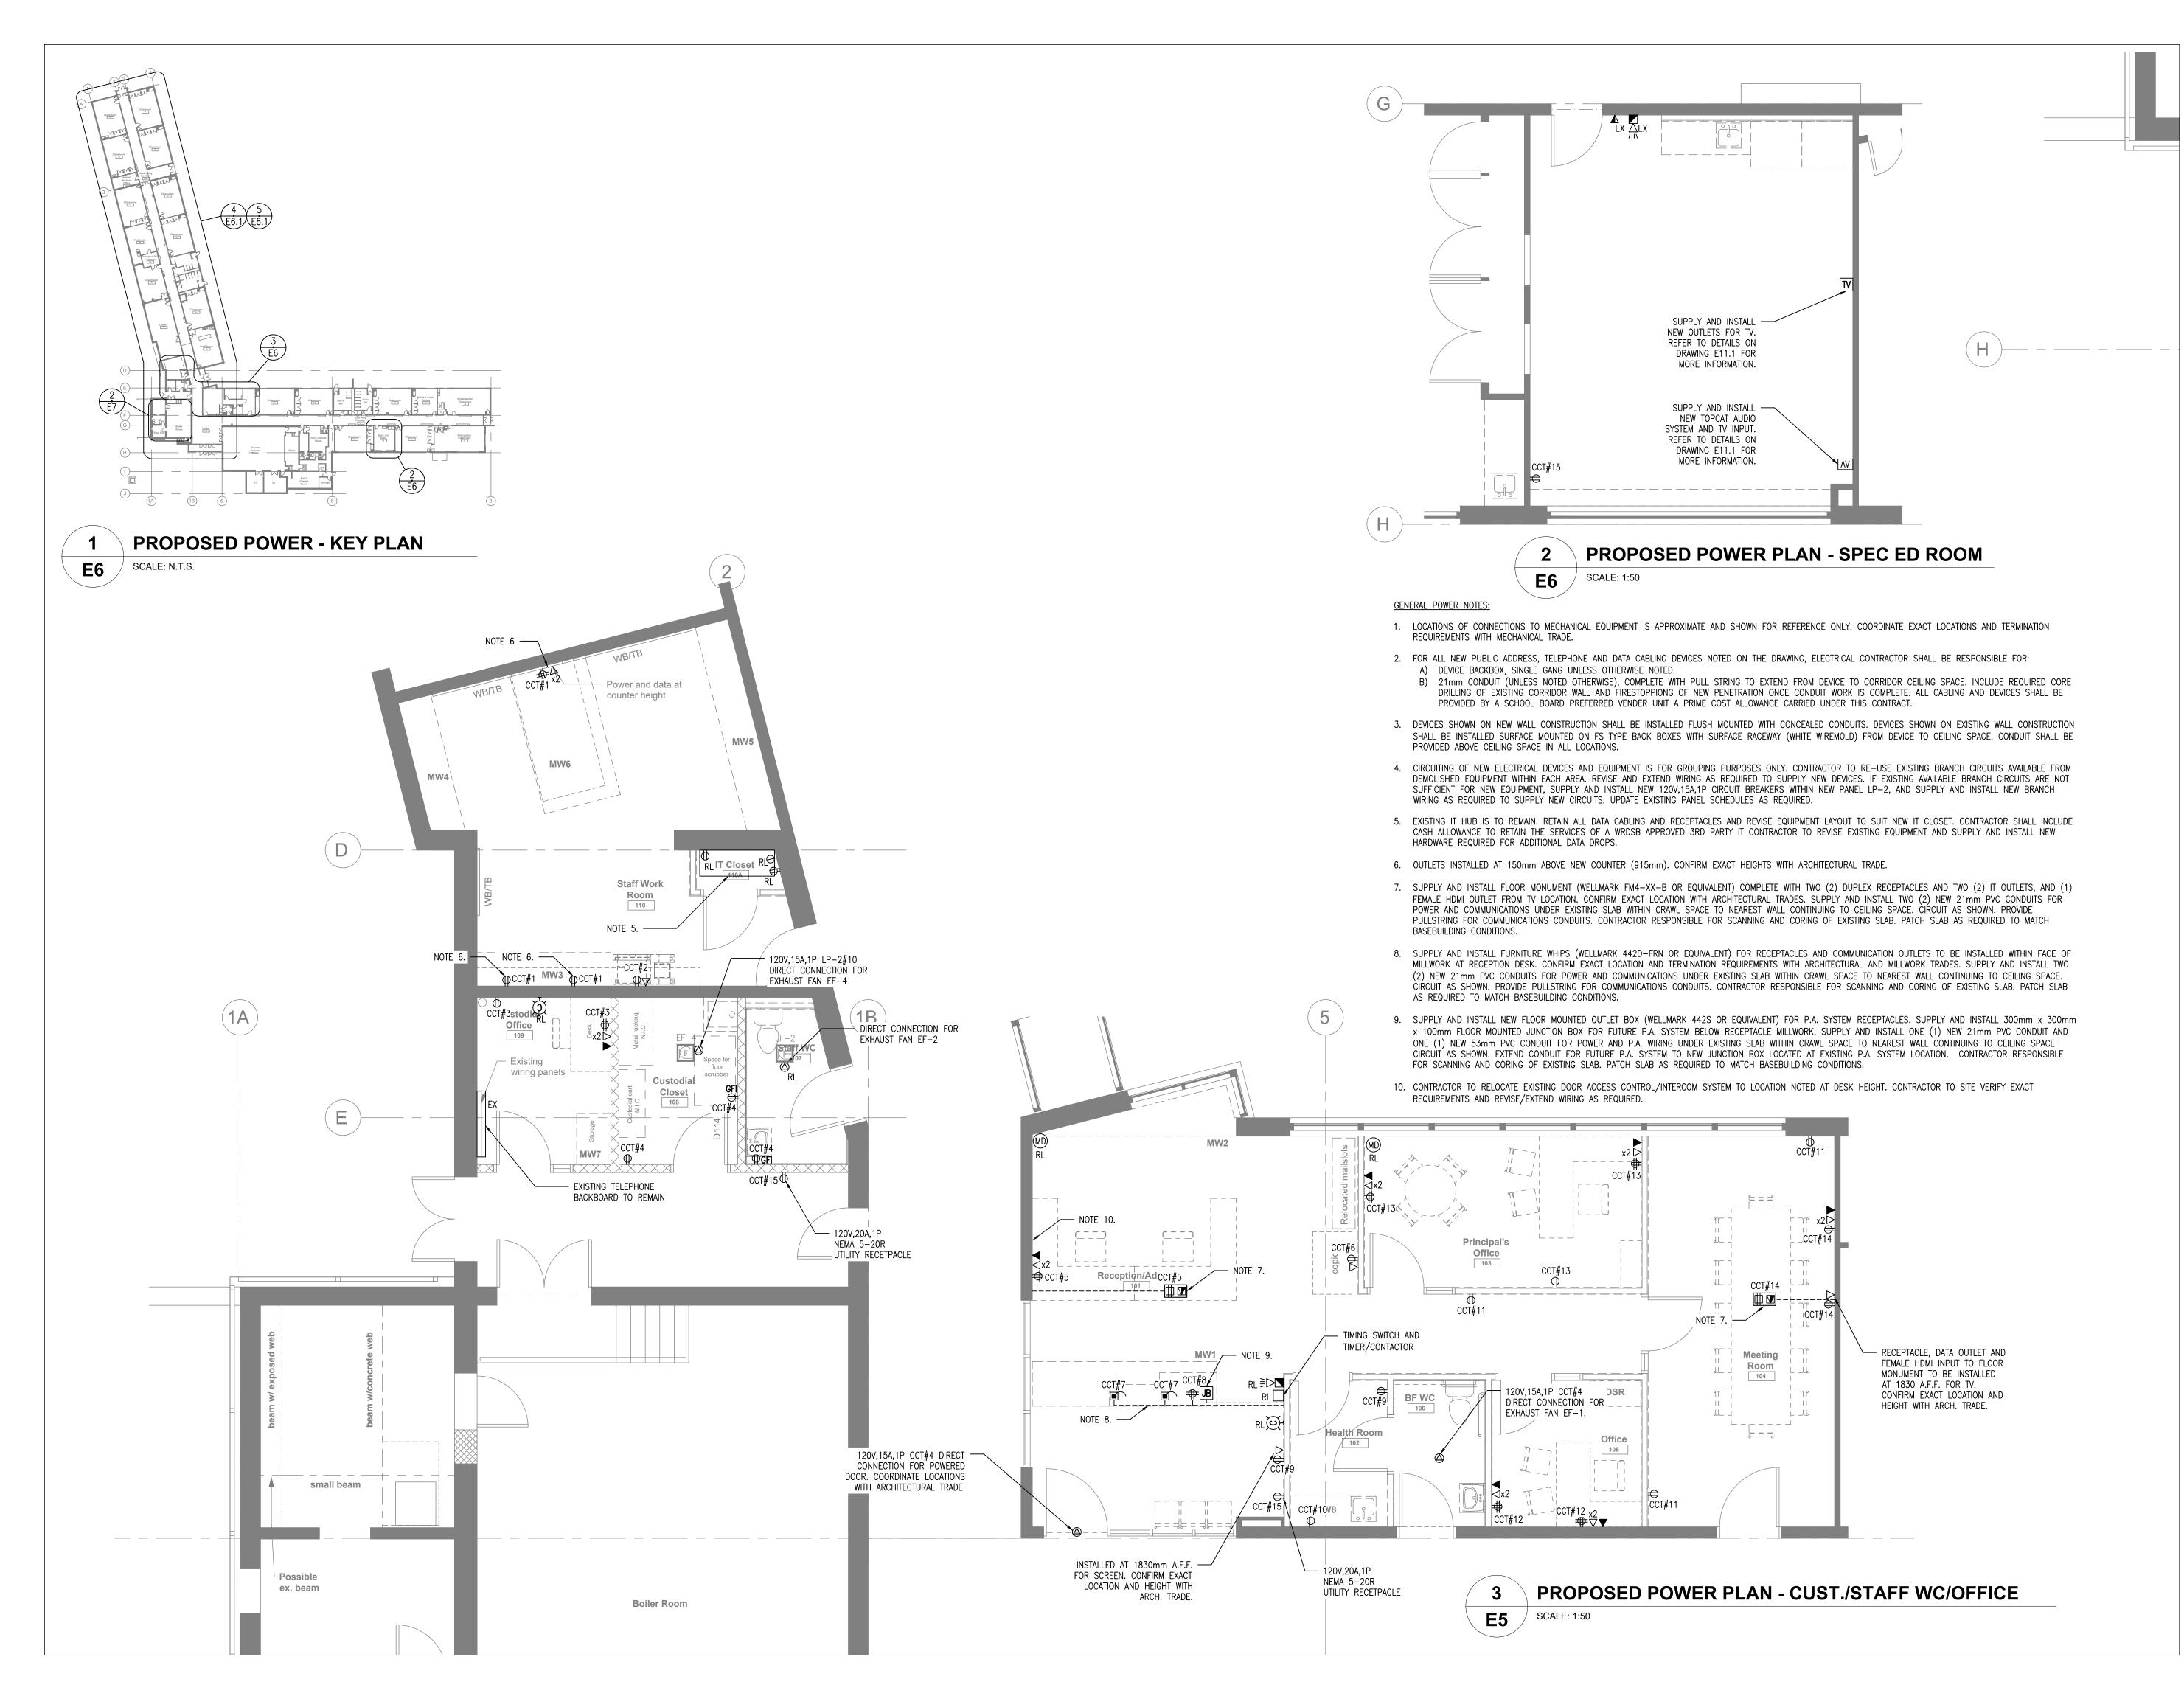

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9.	ISSUED FOR TENDER	22 FEB 15	СР
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No.	Revision	Date	Ву

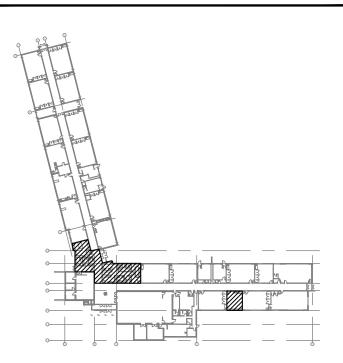

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Project Name WRDSB - WORKSHOP ARCHITECTURE

SMITHSON PUBLIC SCHOOL

150 BELLVIEW AVENUE, KITCHENER

**HVAC UPGRADES & INTERIOR RENOVATIONS** 


Sheet Title

## PROPOSED POWER PLANS

Drawn By DB Scale As Shown Designed By DB Date November 26, 2020 Project Number B20-349.02A

Sheet Number


Revision **E6** 

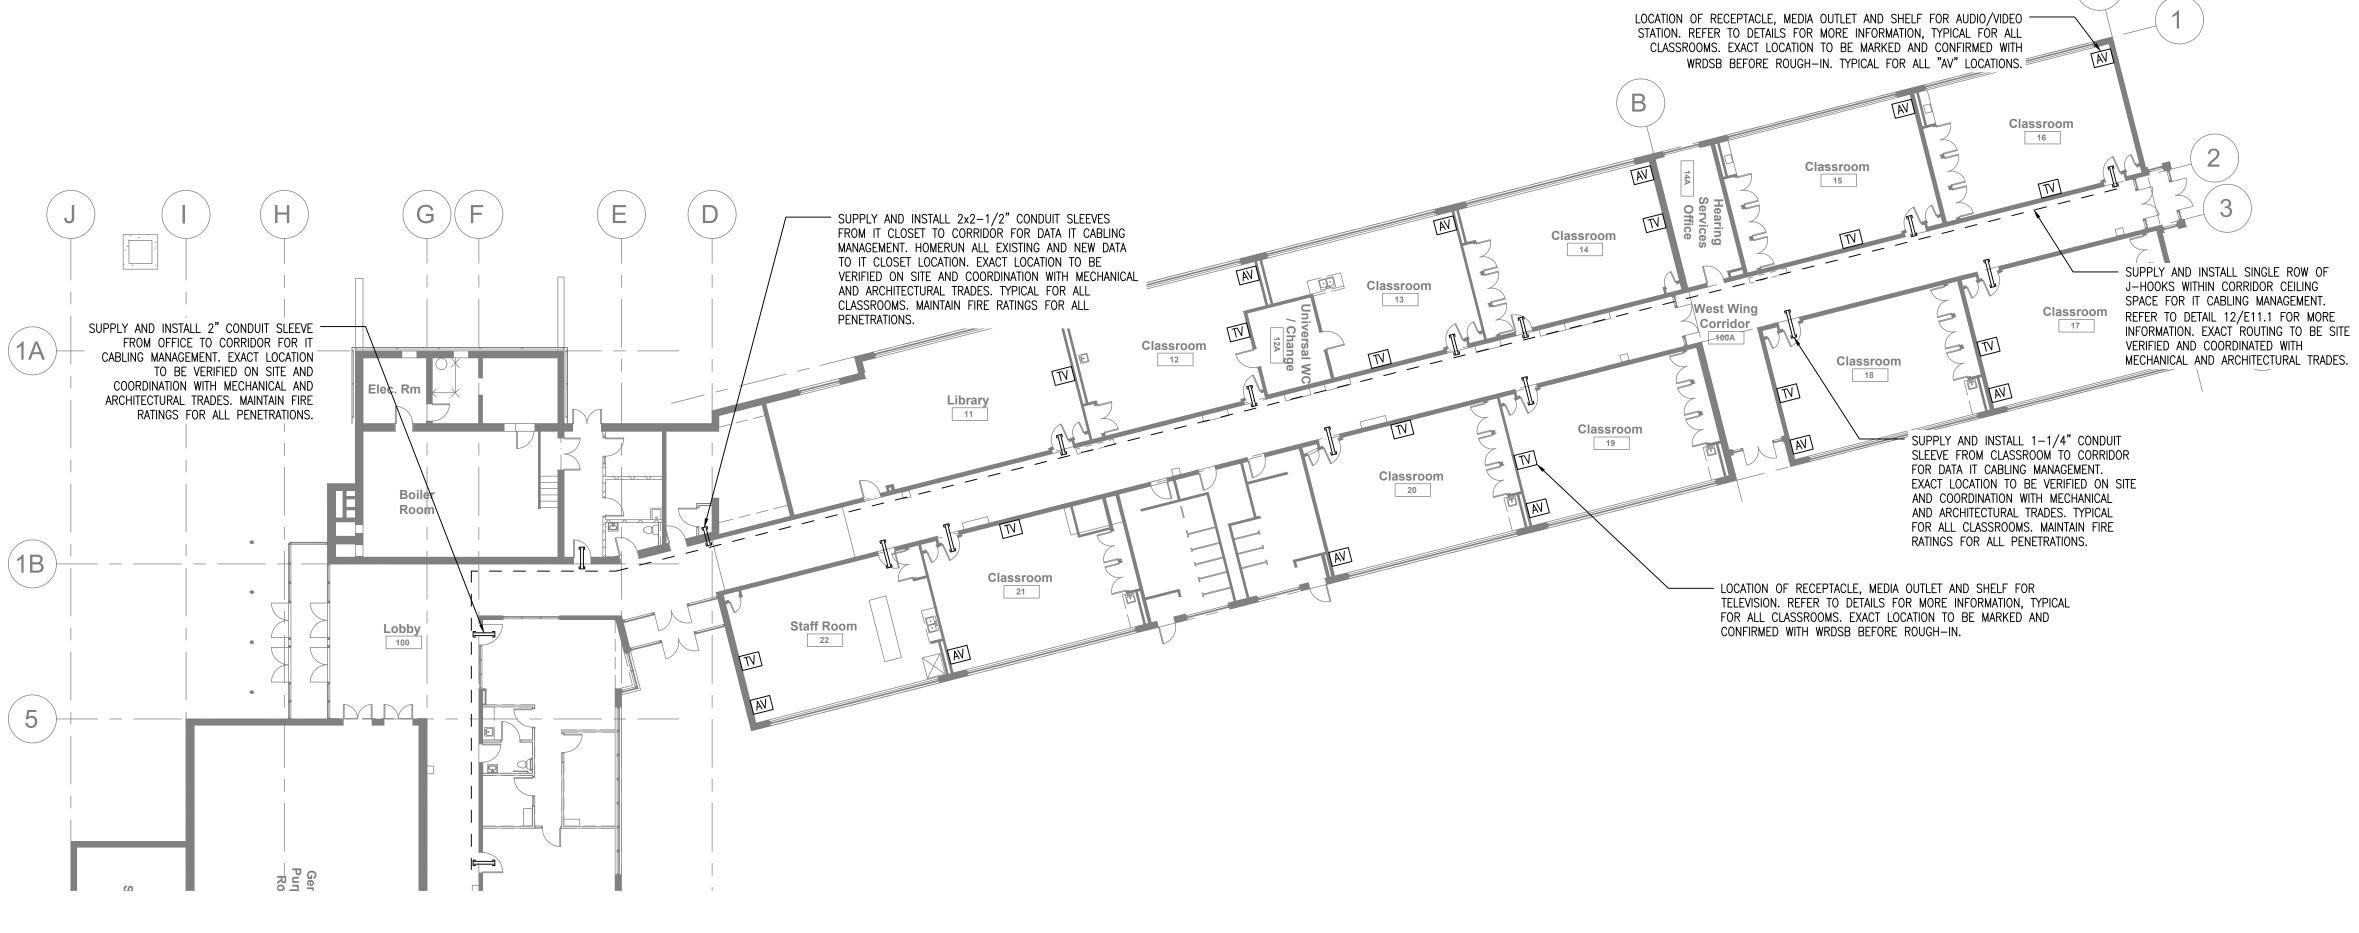

## 4

## IT & MEDIA PLAN - WEST WING CORRIDOR

**E6.1** SCALE: 1:200

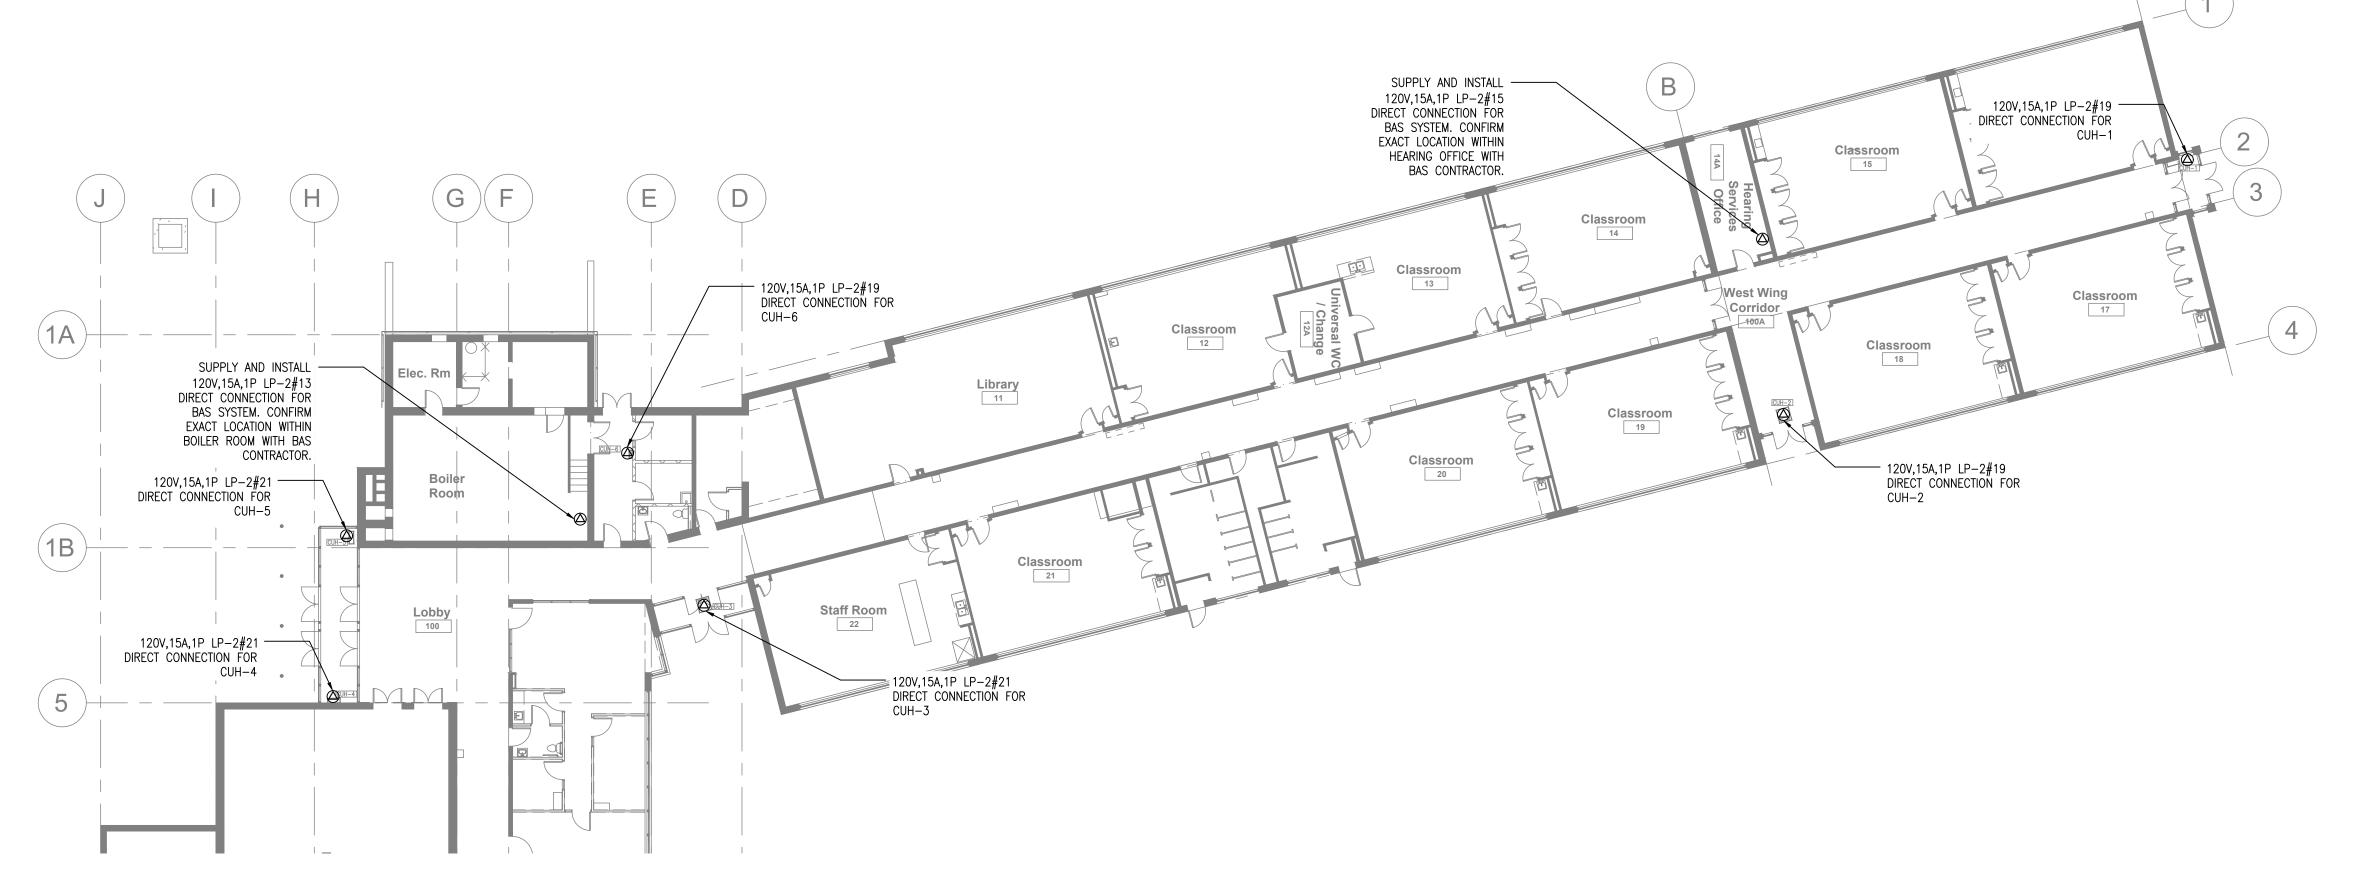


5

PROPOSED POWER PLAN - WEST WING CORRIDOR

**E6.1** SCALE: 1:200

Drawing Notes

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	9.	ISSUED FOR TENDER	22 FEB 15	СР

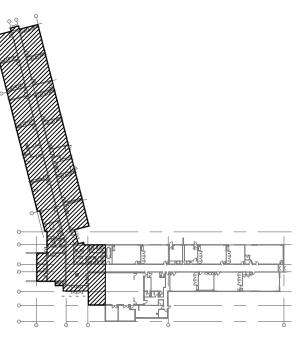

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Project Name

WRDSB - WORKSHOP ARCHITECTURE

HVAC UPGRADES & INTERIOR RENOVATIONS SMITHSON PUBLIC SCHOOL

150 BELLVIEW AVENUE, KITCHENER

Sheet Title


## PROPOSED POWER PLANS

Drawn By	DB	Scale	As Shown
Designed By	DB	Date	November 26, 2020
Project Number	er <b>B20-</b> 3	349.02	4


Sheet Number


Revision

E6.1

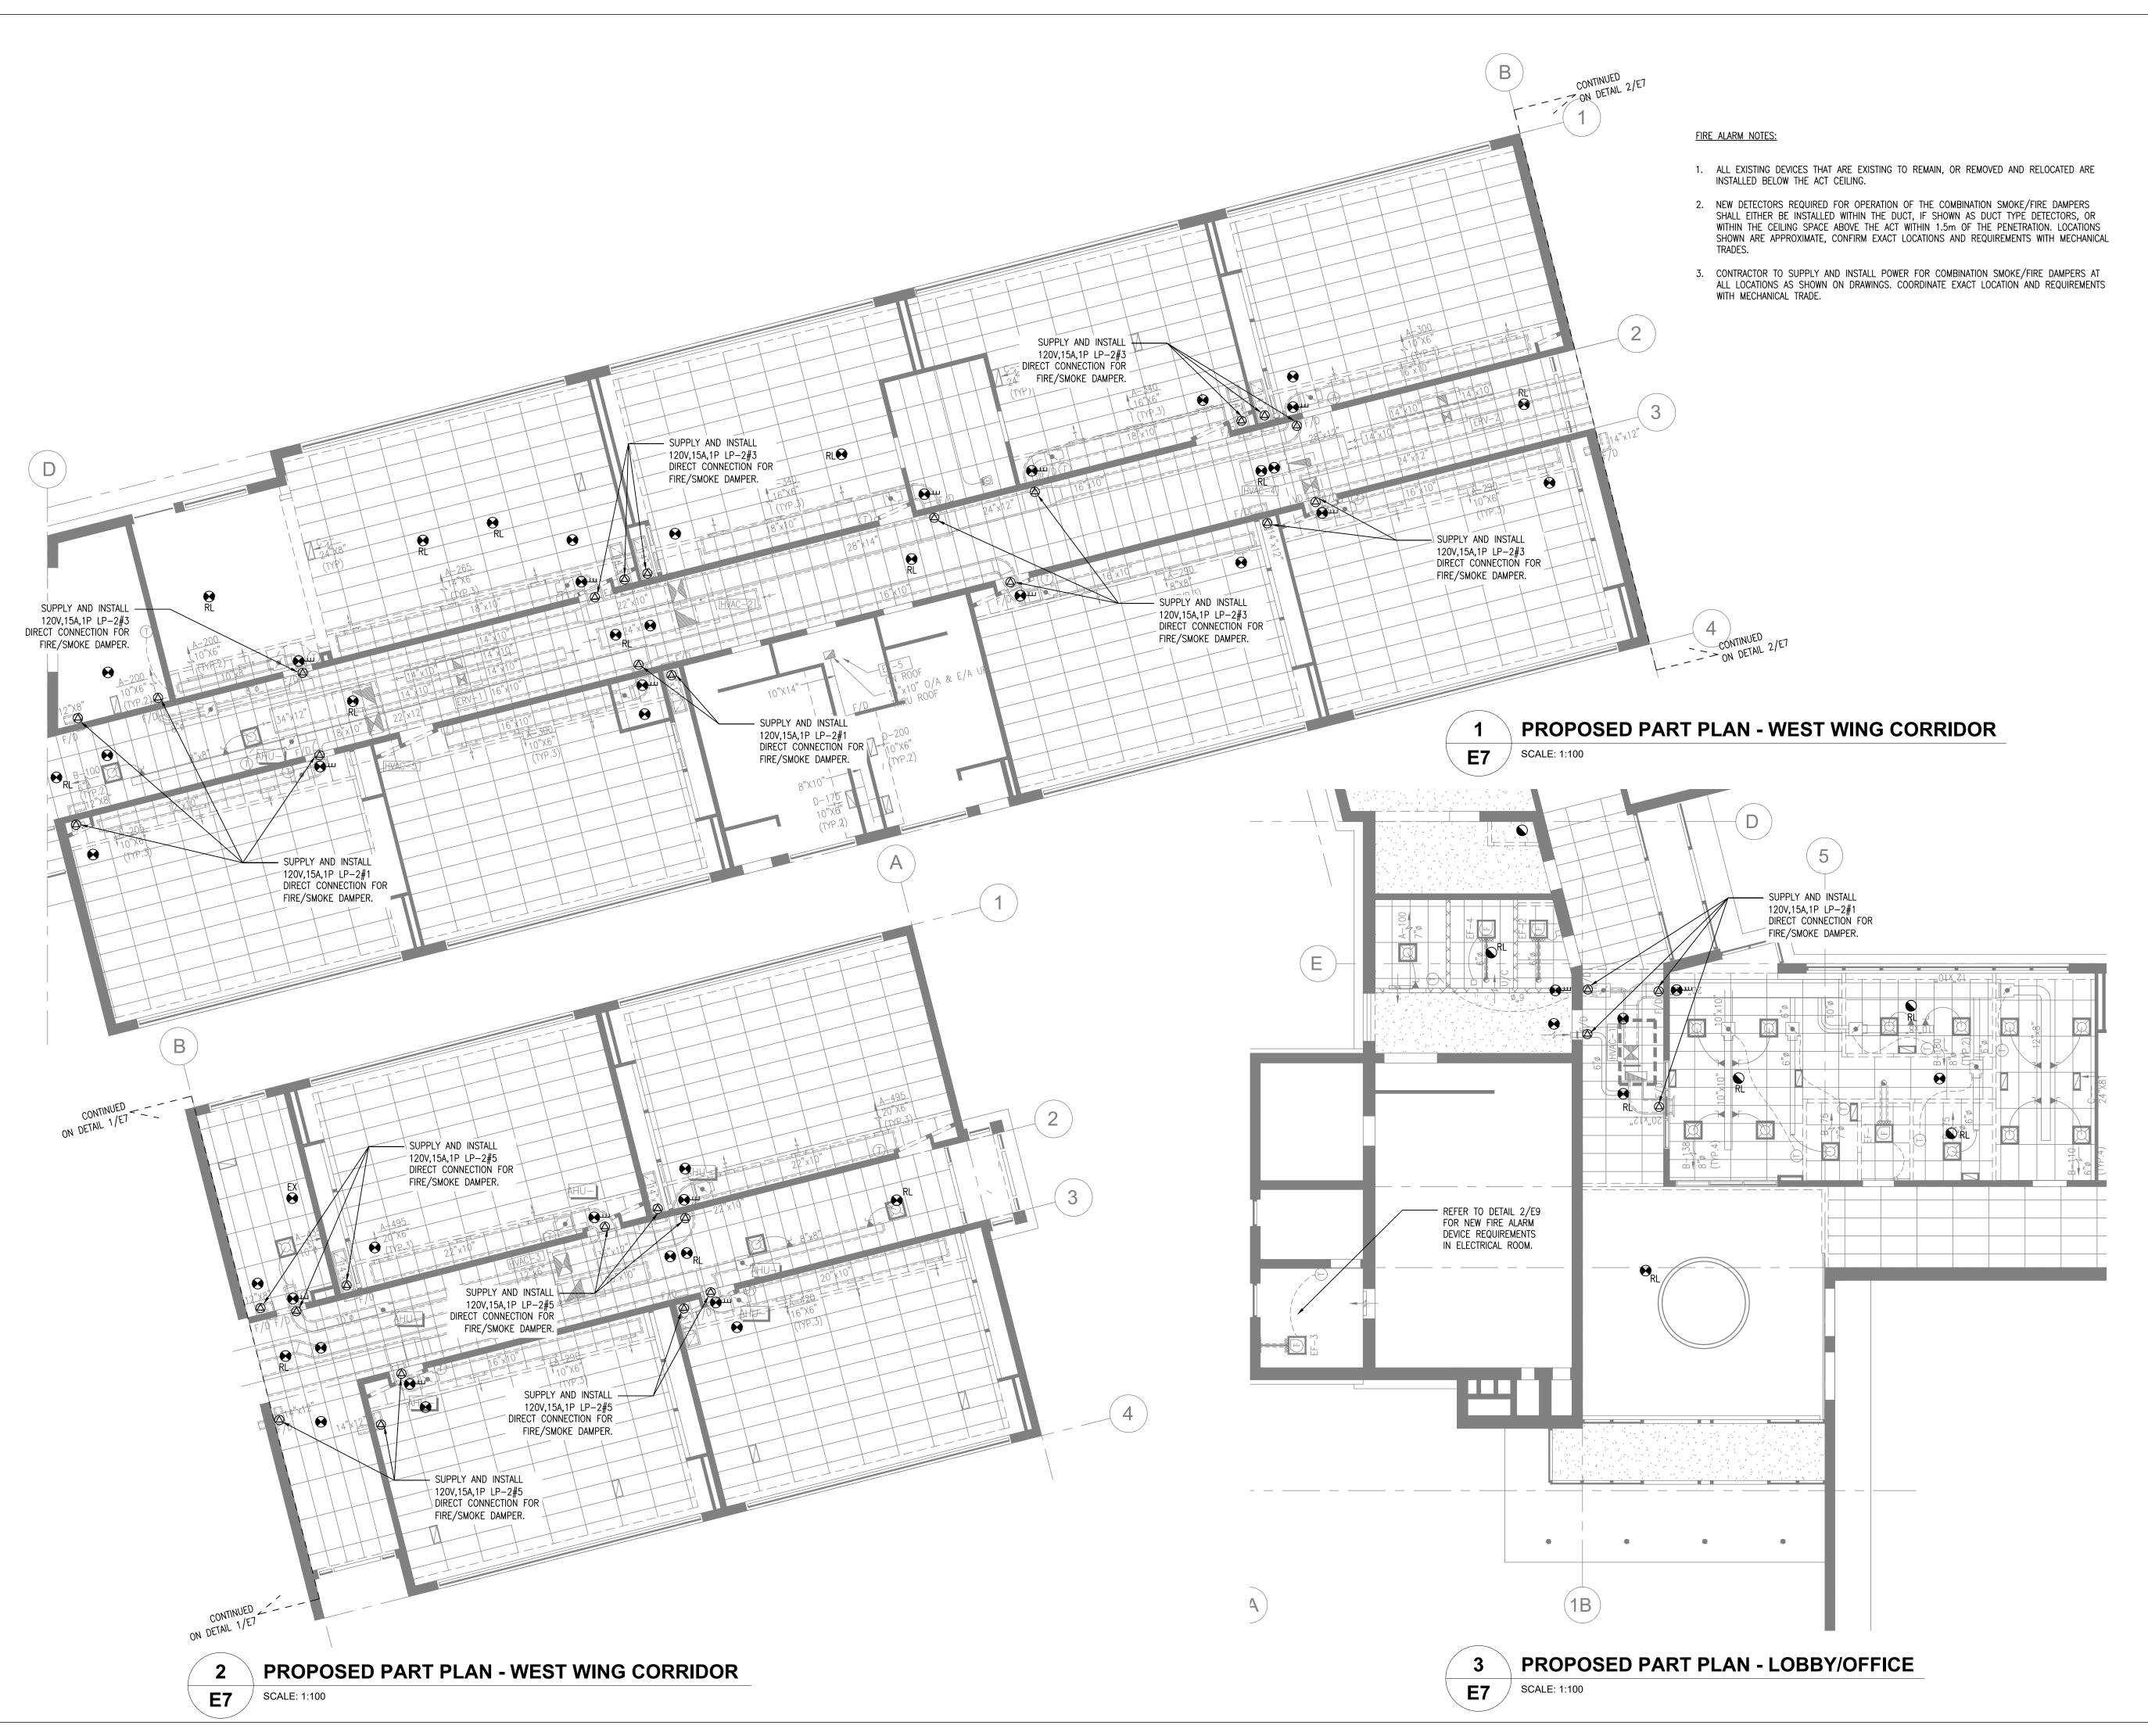

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9.	ISSUED FOR TENDER	22 FEB 15	CF

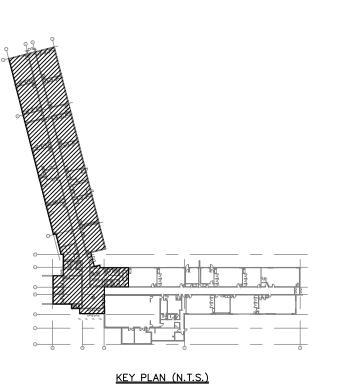
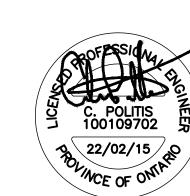
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Project Name
WRDSB - WORKSHOP

ARCHITECTURE

HVAC UPGRADES & INTERIOR RENOVATIONS

SMITHSON PUBLIC SCHOOL

150 BELLVIEW AVENUE, KITCHENER

Sheet Title


**E7** 

PROPOSED FIRE ALARM PLANS


Drawn By DB Scale As Shown
Designed By DB Date November 26, 2020

Project Number **B20-349.02A**Sheet Number

nber Revision

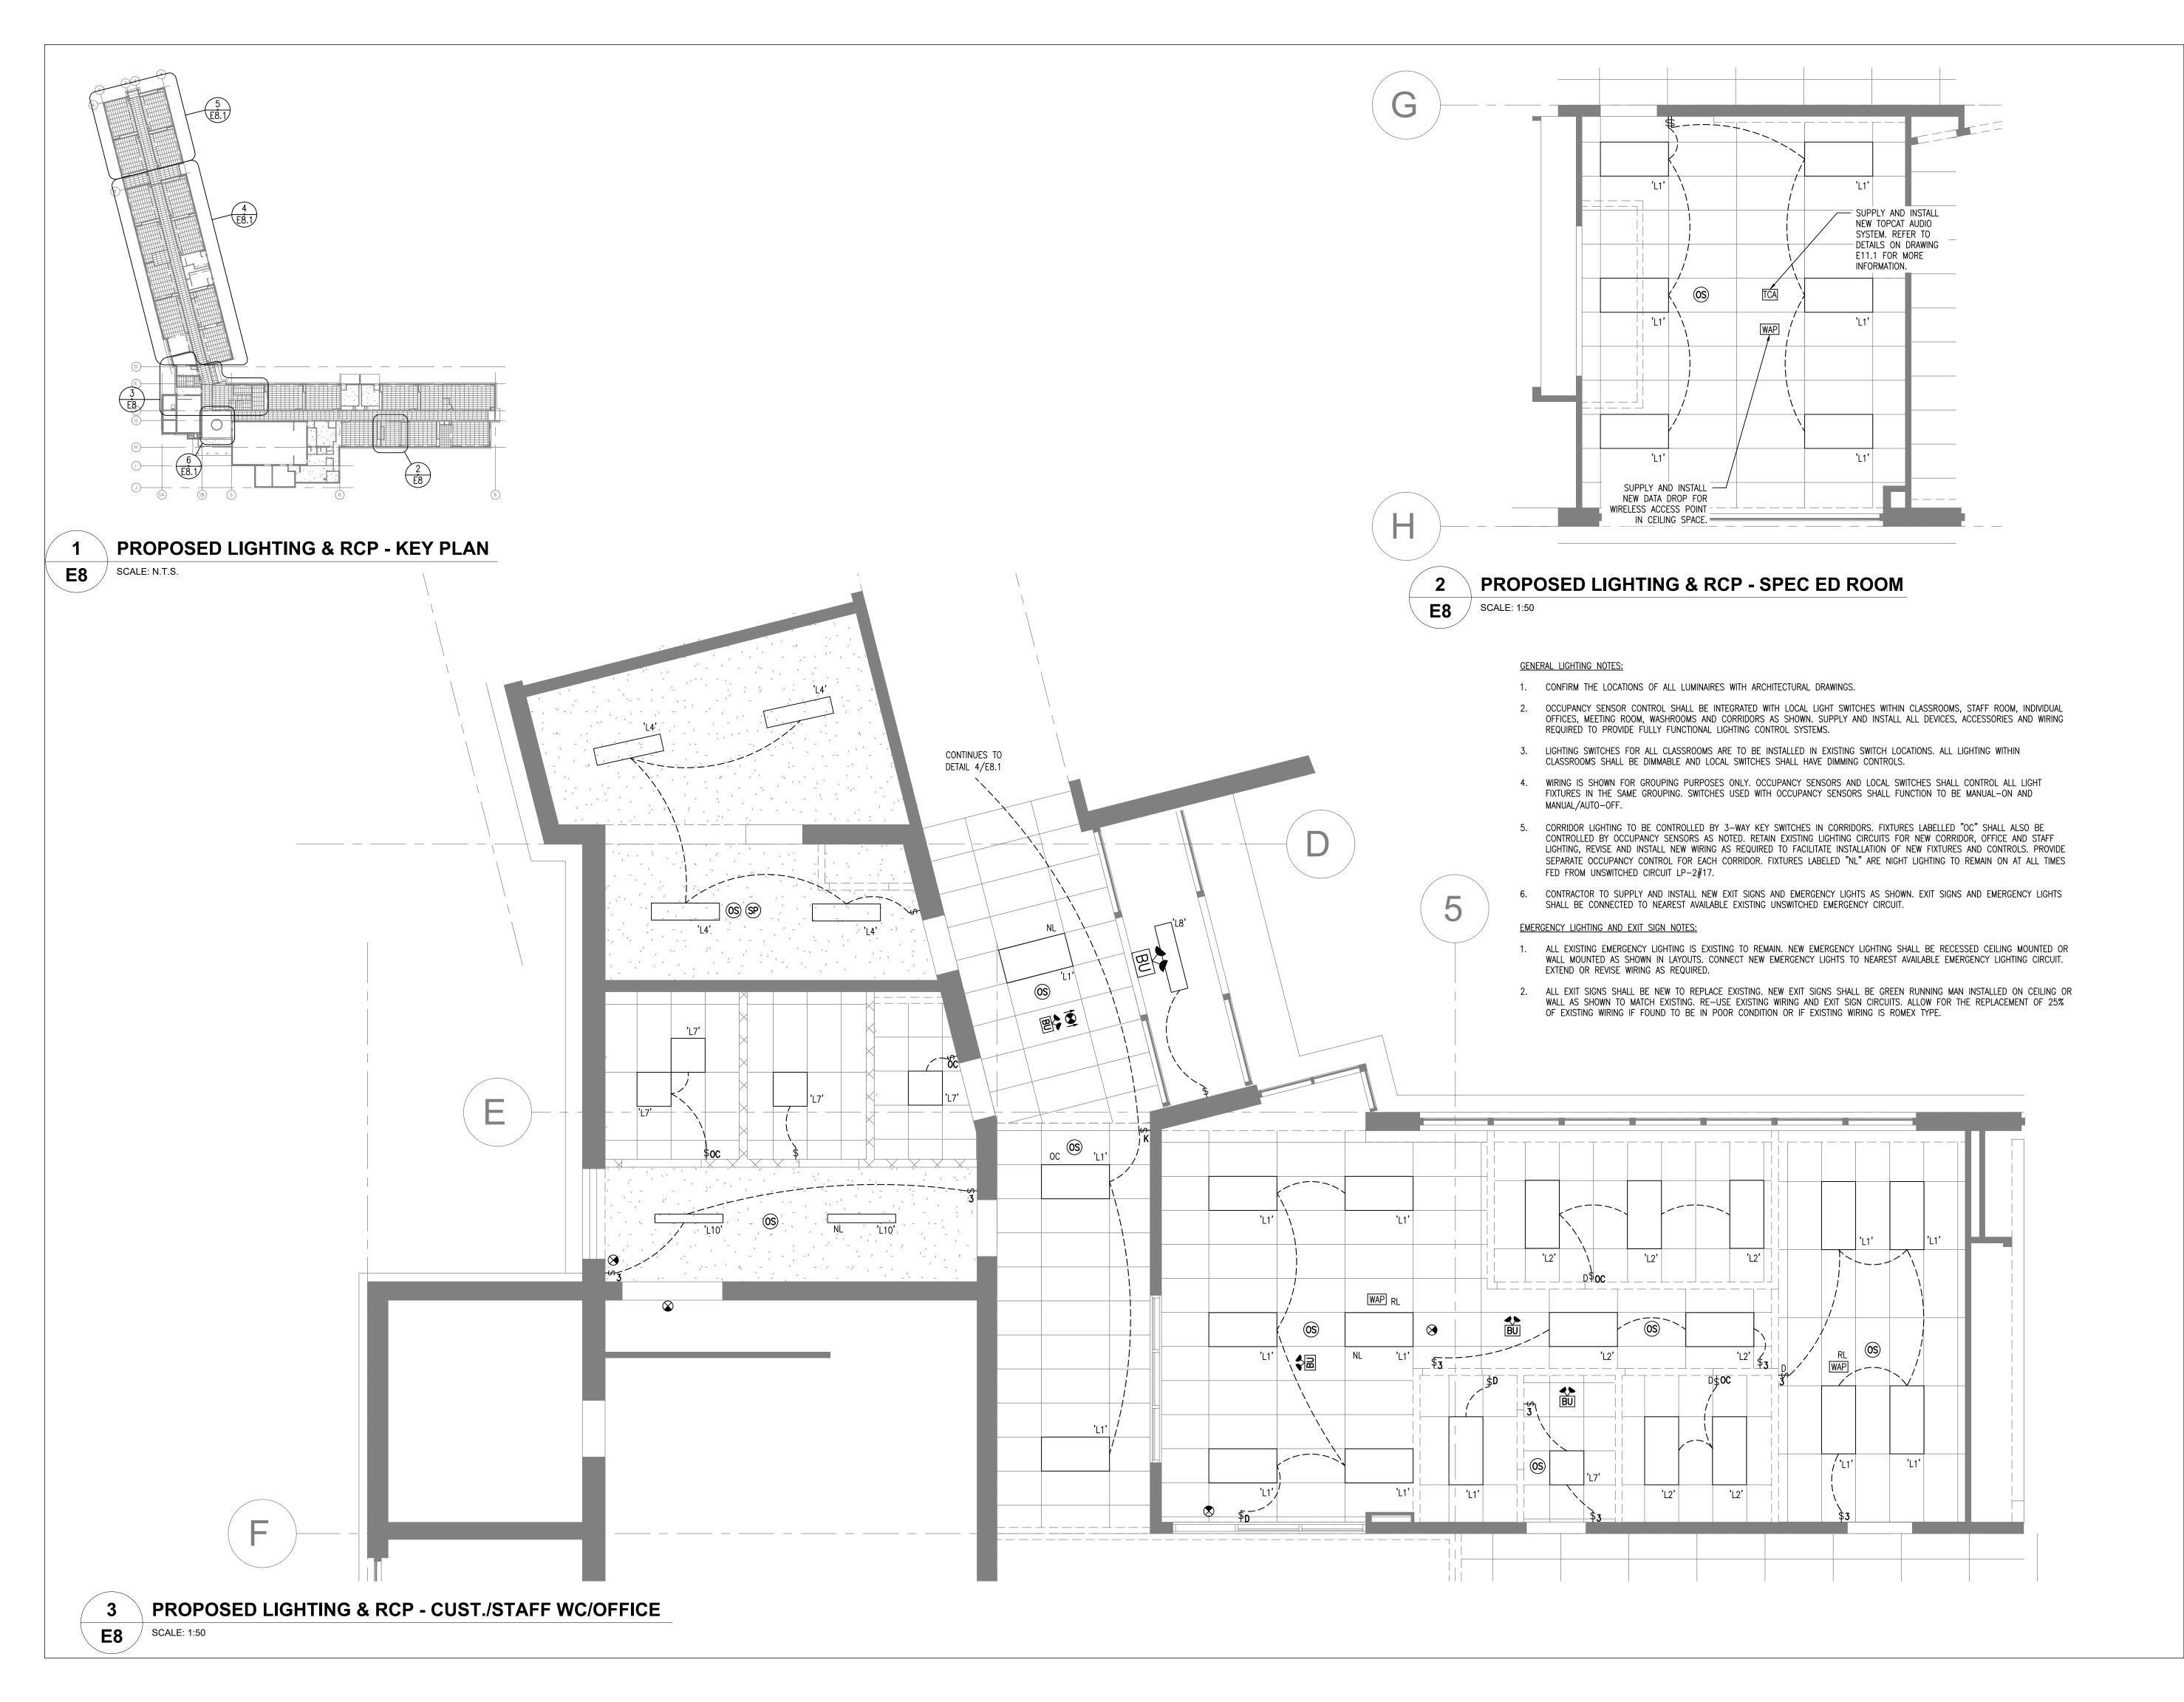

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KEY PLAN (N.T.S.)

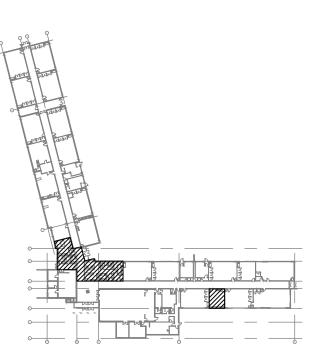

	9.	ISSUED FOR TENDER	22 FEB 15	СР
	8.	ISSUED FOR PERMIT	22 FEB 03	СР
	7.	ISSUED FOR 90% REVIEW	22 JAN 21	DB
,	6.	ISSUED FOR 90% REVIEW	21 DEC 03	DB
	5.	ISSUED PERMIT / TENDER	21 MAY 11	СР
	No.	Revision	Date	Ву



BOLD Tel: 416-556-0766 Fax: 1-866-876-5758

Bold Engineering Inc.

2778 Dufferin Street, Suite 104 Toronto, Ontario, M6B 3R7

Revision

engineering www.boldengineering.ca

Project Name

WRDSB - WORKSHOP
ARCHITECTURE
HVAC UPGRADES & INTERIOR RENOVATIONS

SMITHSON PUBLIC SCHOOL 150 BELLVIEW AVENUE, KITCHENER

BU BELLVIEW AVENUE, KITC

Sheet Title


# PROPOSED LIGHTING \* REFLECTED CEILING PLANS

Drawn By DB Scale As Shown
Designed By DB Date November 26, 2020


Sheet Number

Project Number B20-349.02A

E8

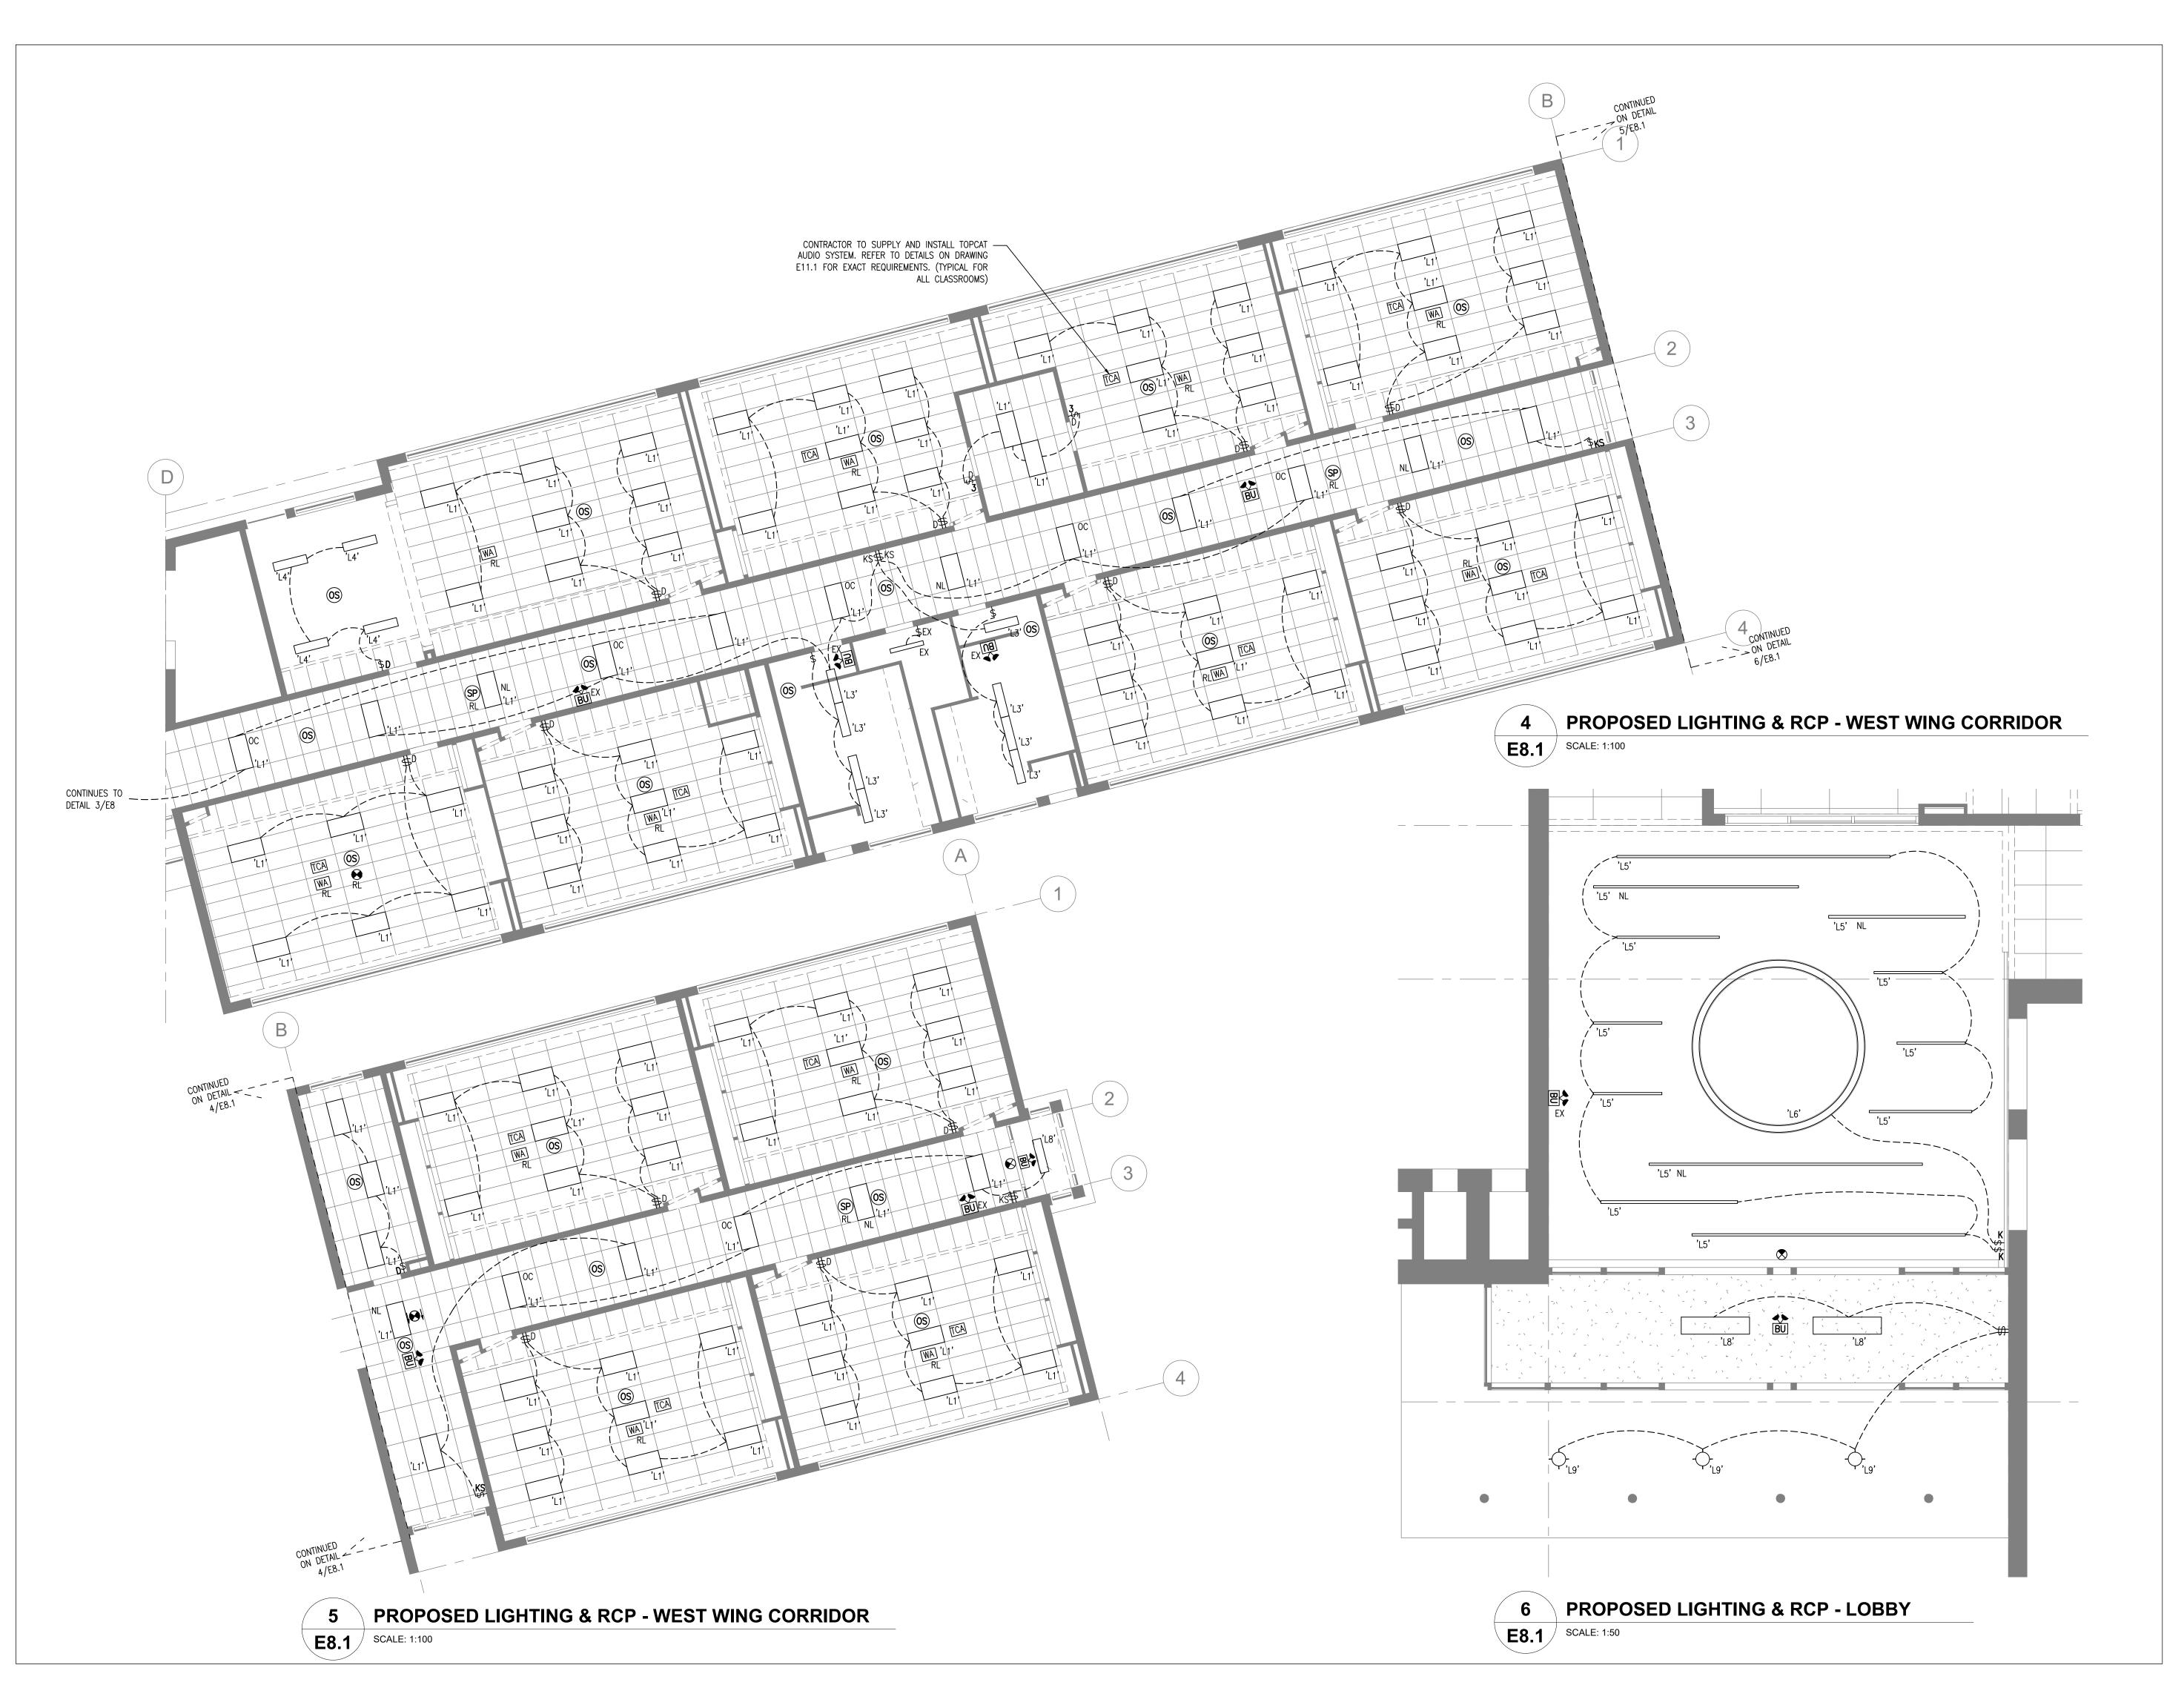

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Project Name

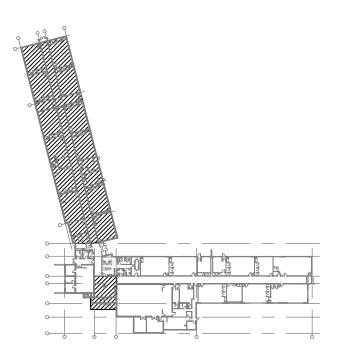WRDSB - WORKSHOP ARCHITECTURE HVAC UPGRADES & INTERIOR RENOVATIONS

SMITHSON PUBLIC SCHOOL 150 BELLVIEW AVENUE, KITCHENER

Sheet Title PROPOSED LIGHTING &


REFLECTED CEILING PLANS Drawn By DB Scale As Shown

Designed By DB Date November 26, 2020 Project Number **B20-349.02A** 

Sheet Number

E8.1


Revision

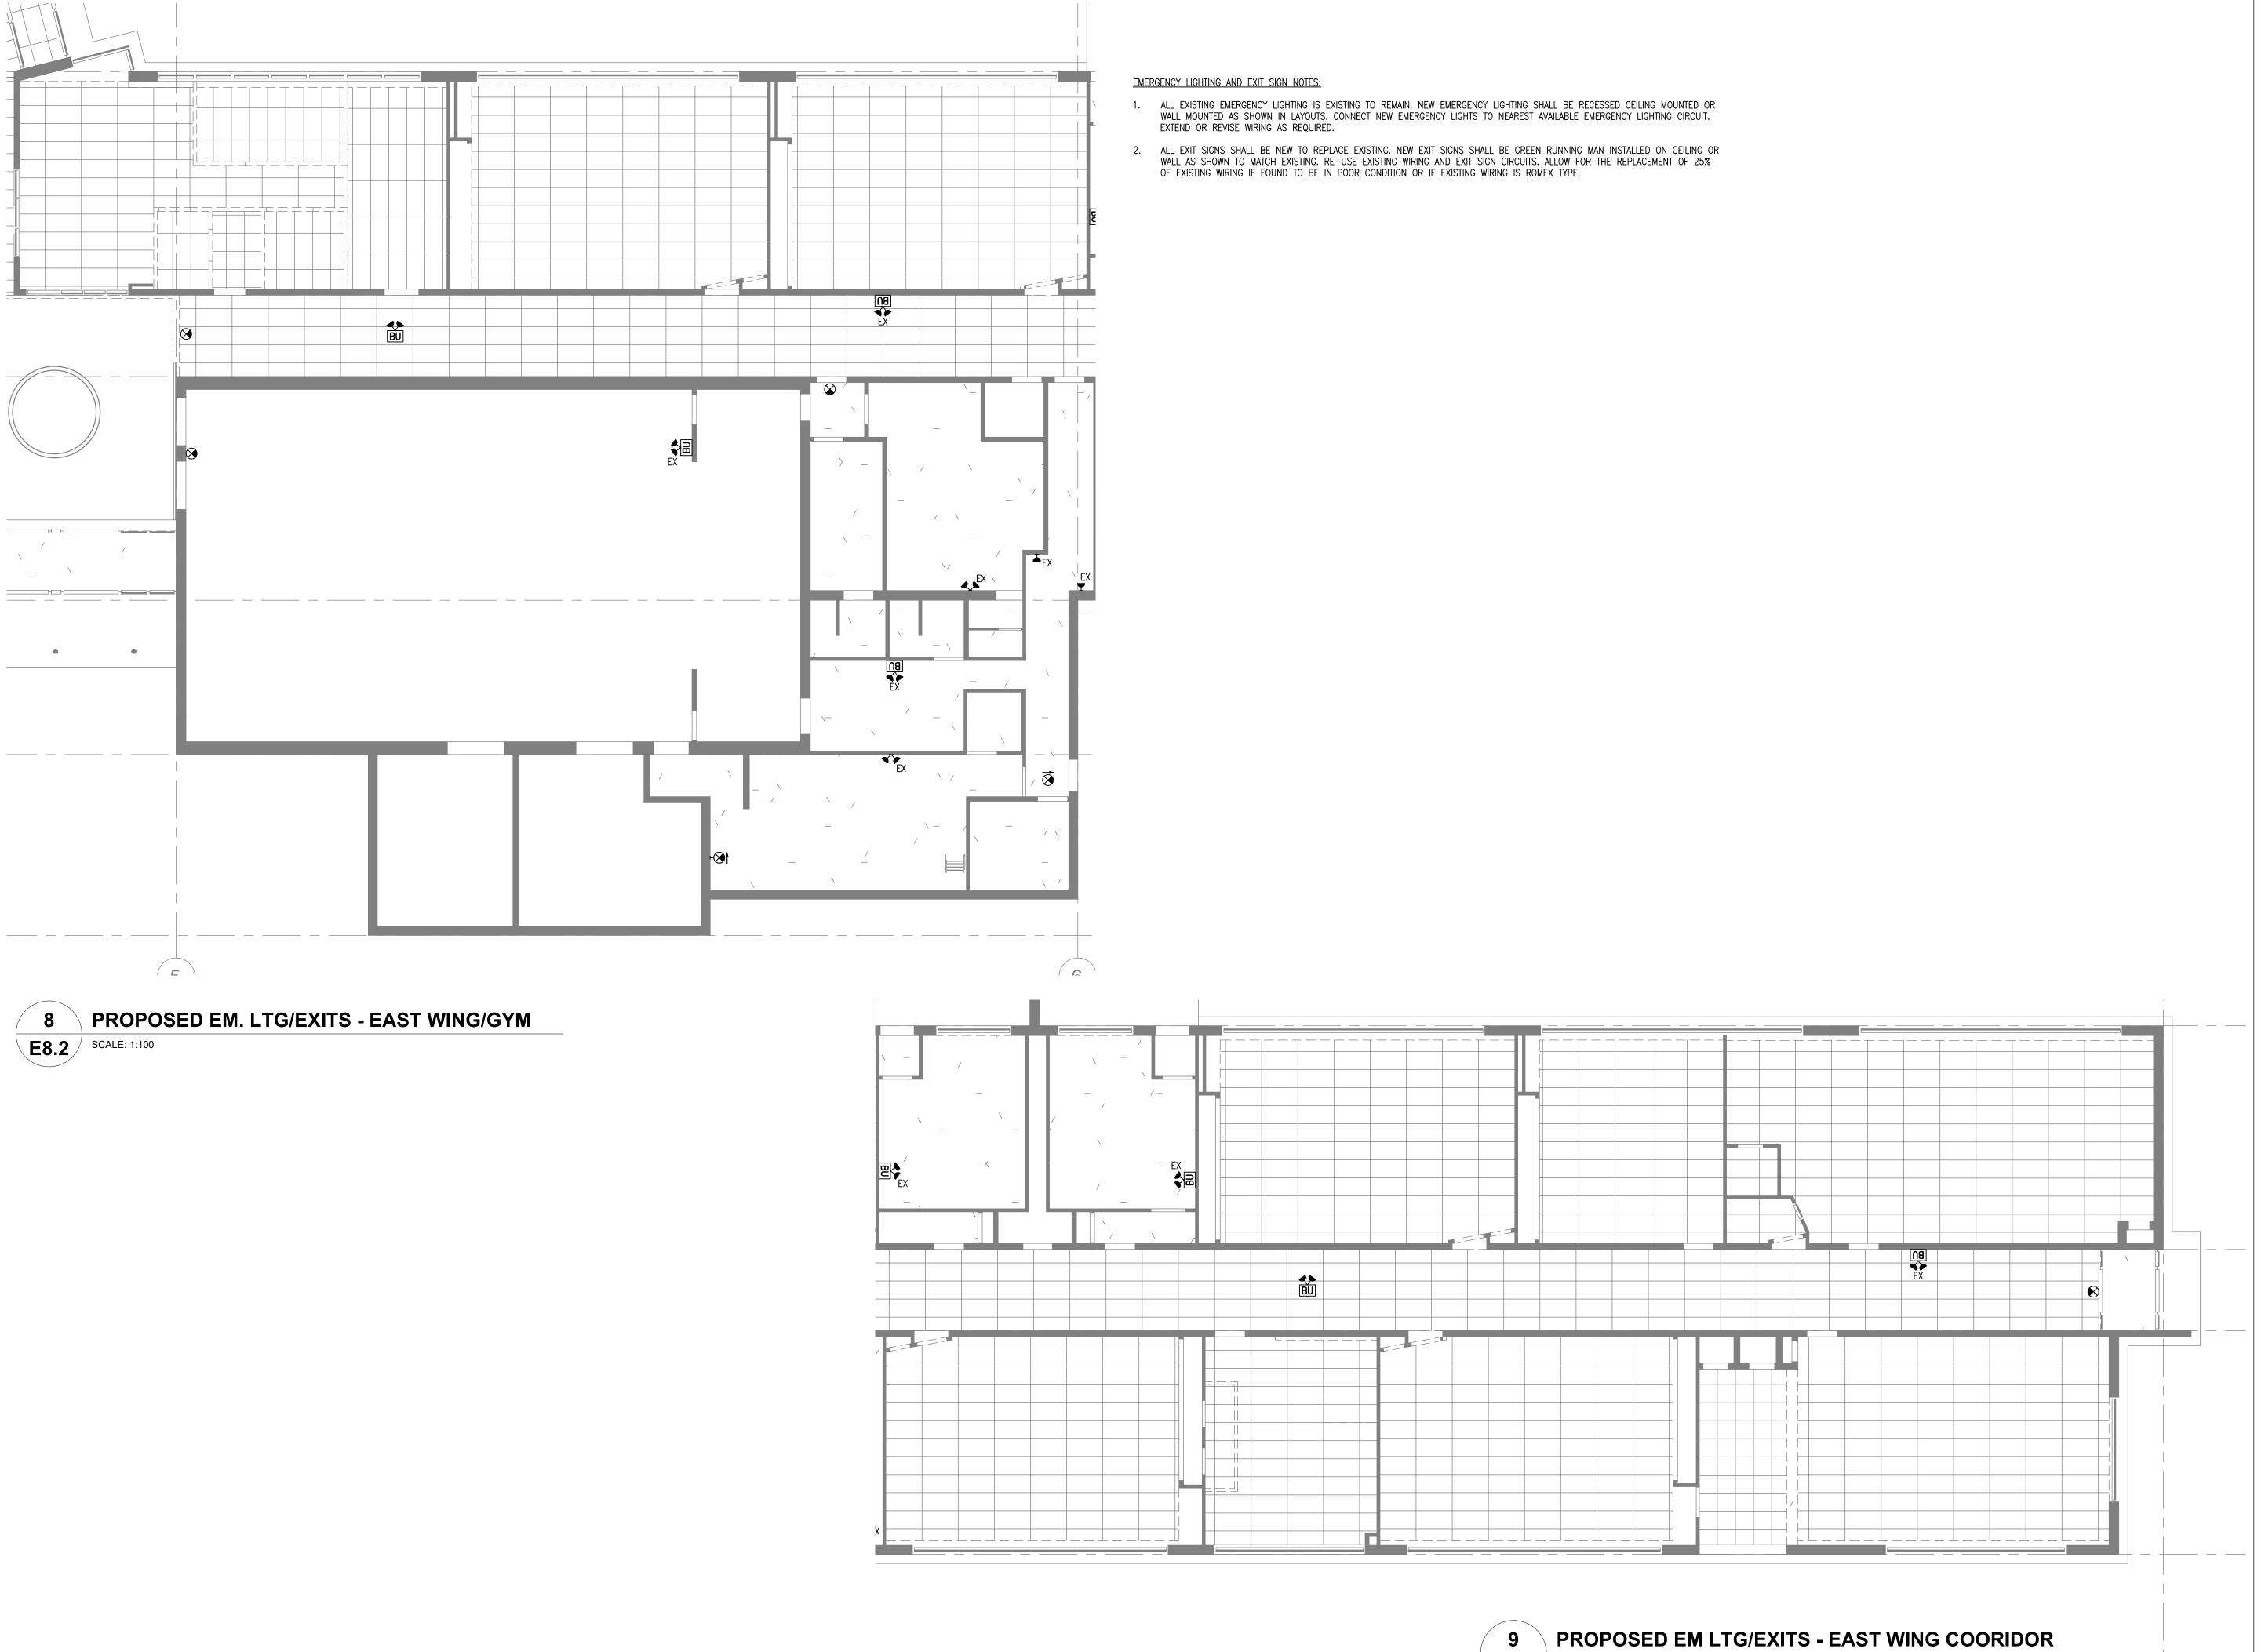


**E8.2** SCALE: 1:100

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Project Name WRDSB - WORKSHOP ARCHITECTURE

HVAC UPGRADES & INTERIOR RENOVATIONS SMITHSON PUBLIC SCHOOL

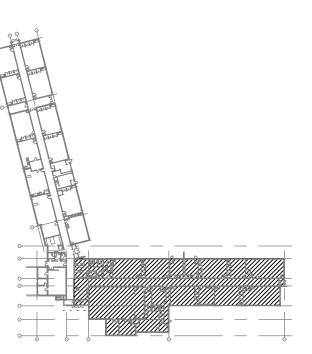150 BELLVIEW AVENUE, KITCHENER


Sheet Title

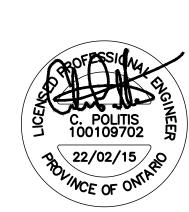PROPOSED EMERGENCY LTG & EXIT SIGN PLANS - EAST WING

Drawn By DB Scale As Shown Designed By DB Date November 26, 2020


Project Number **B20-349.02A** Sheet Number

E8.2

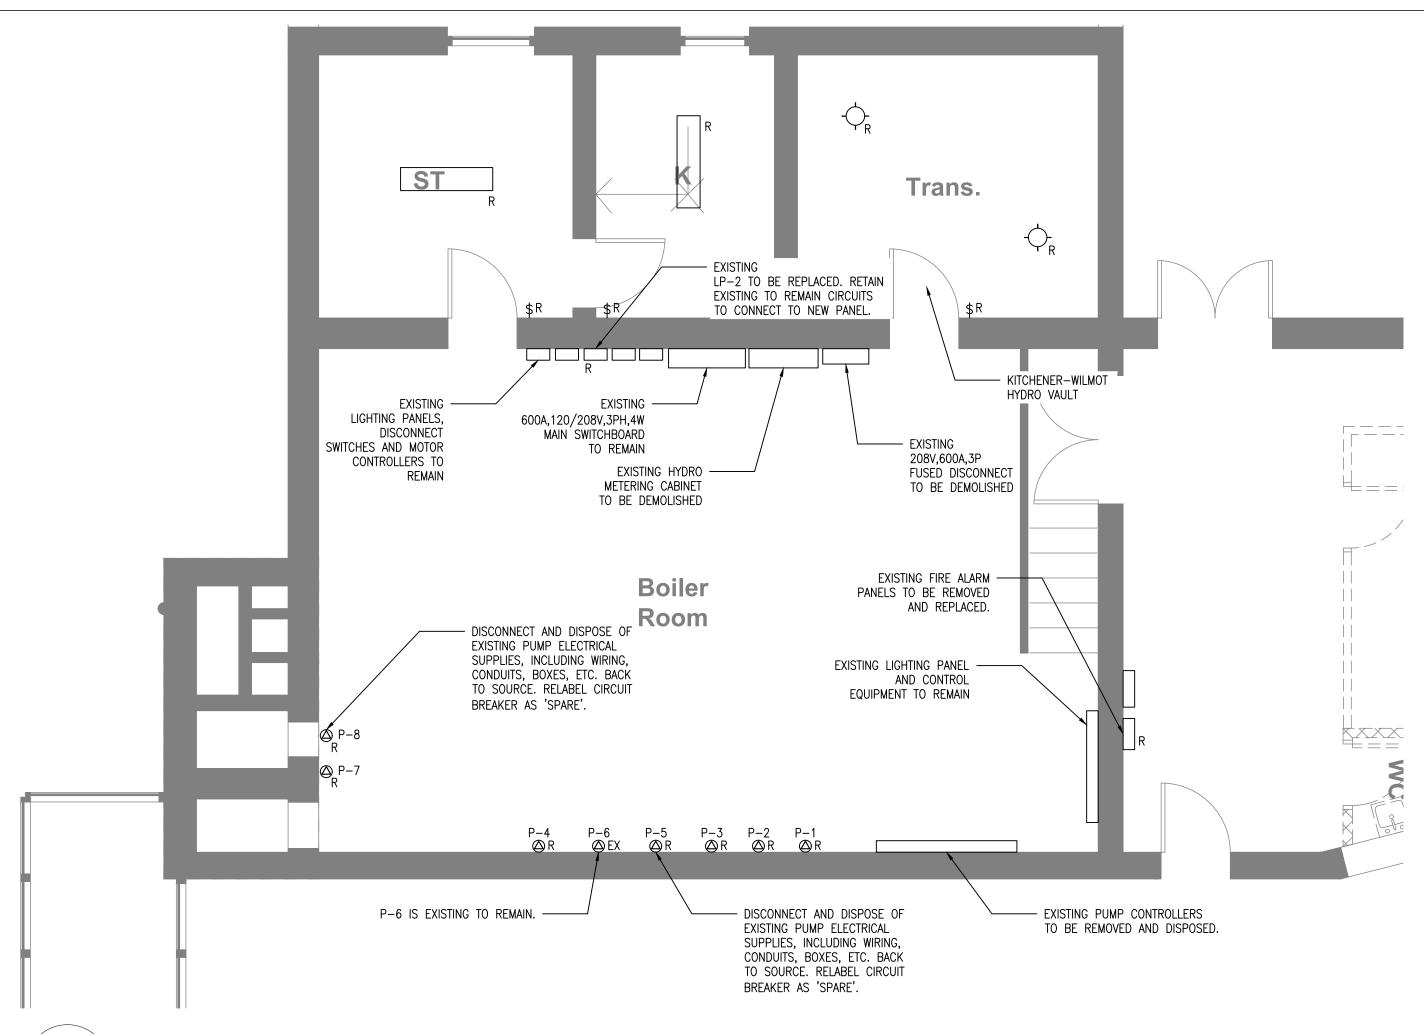

## **EXISTING/DEMOLITION EQUIPMENT LAYOUT - BOILER ROOM**

/ SCALE: 1:50

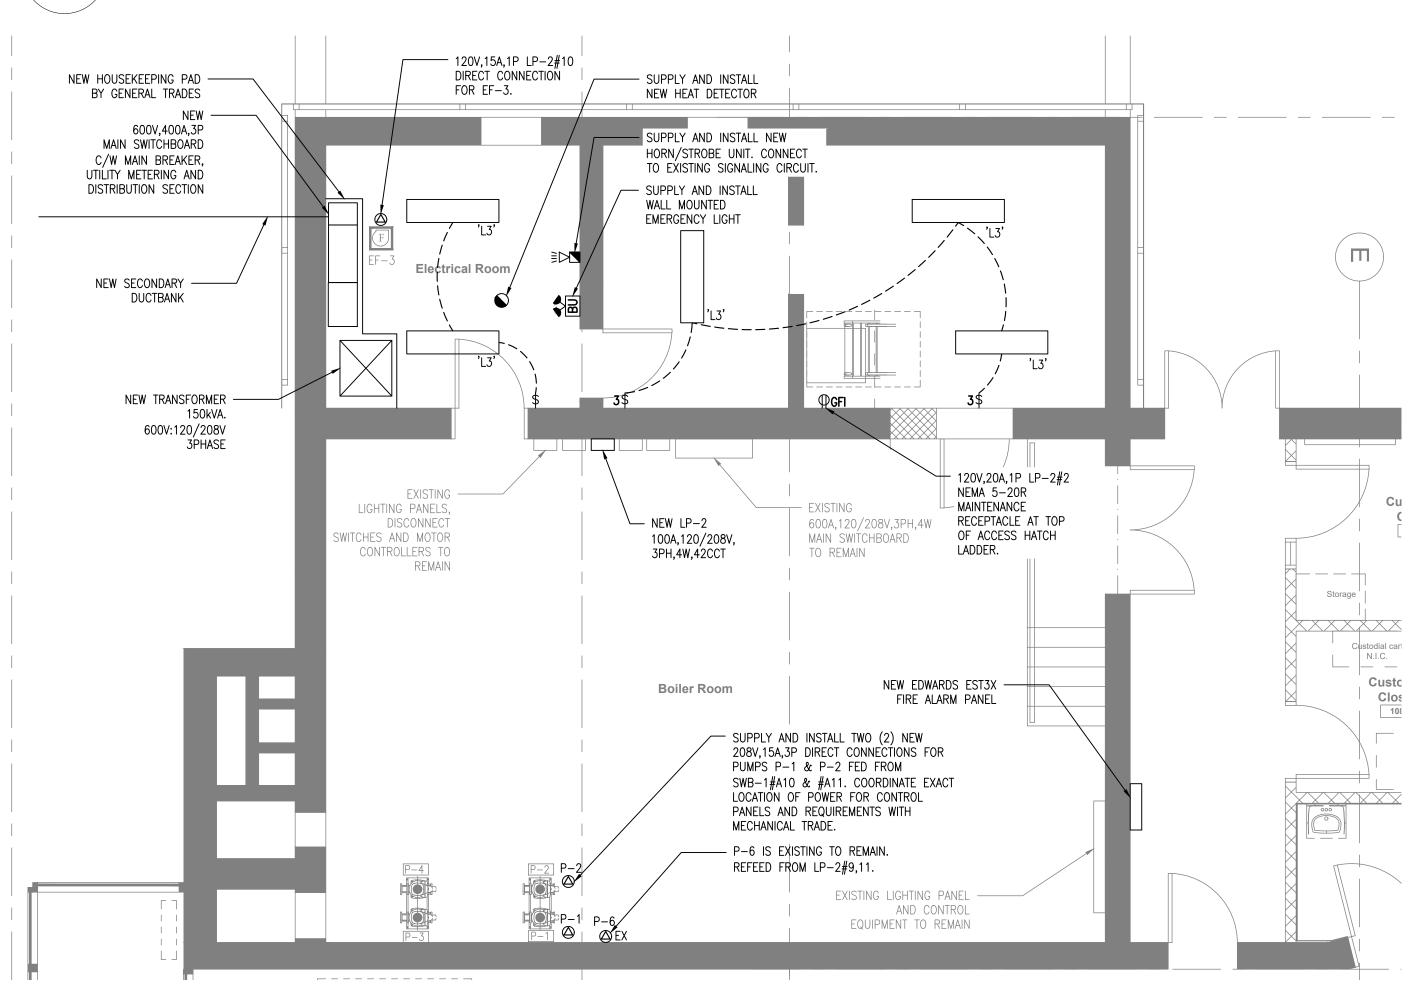

## PROPOSED EQUIPMENT LAYOUT - BOILER ROOM


**E9** / SCALE: 1:50

### FIRE ALARM SCOPE OF WORK:

- 1) CONTRACTOR TO REMOVE AND DISPOSE OF EXISTING EDWARDS FIRESHIELD PLUS FIRE ALARM CONTROL PANEL AND ASSOCIATED ANNUNCIATOR. CONTRACTOR TO RETAIN ALL EXISTING CONVENTIONAL INITIATING DEVICE CIRCUITS AND ALL SIGNALING DEVICE CIRCUITS FOR NEW PANEL.
- 2) CONTRACTOR TO SUPPLY AND INSTALL NEW EDWARDS EST3X FIRE ALARM PANEL AND ANNUNCIATOR AT EXISTING PANEL LOCATIONS. CONTRACTOR TO INTEGRATE EXISTING INITIATING DEVICES ON CONVENTIONAL ZONES, AND EXISTING SIGNALING
- 3) CONTRACTOR TO SUPPLY AND INSTALL NEW CARDS FOR EST3X PANEL IN ORDER TO PICK UP EXISTING CONVENTIONAL ZONES. SUPPLY AND REVISE EXISTING END OF LINE DEVICES FOR EXISTING CONVENTIONAL ZONES WITH NEW AS NEEDED TO MATCH NEW PANEL REQUIREMENTS.
- 4) CONTRACTOR TO SUPPLY AND INSTALL ALL NEW ADDRESSABLE DEVICES AS SHOWN ON LAYOUT DRAWINGS AND SUPPLY AND INSTALL NEW ADDRESSABLE LOOP TO FIRE ALARM PANEL TO PICK UP ALL NEW DEVICES.
- 5) CONTRACTOR TO REMOVE AND RE-INSTALL ALL EXISTING INITIATING AND SIGNALING DEVICES MARKED AS 'RE/RE' AT NEW LOCATIONS MARKED AS 'RL'. REVISE AND/OR EXTEND EXISTING WIRING AS REQUIRED TO SUIT NEW LOCATIONS AND TO FACILITATE ARCHITECTURAL AND MECHANICAL ALTERATIONS.
- 6) CONTRACTOR SHALL REMOVE AND DISPOSE OF ALL EXISTING FIRE ALARM BELL/STROBE COMBINATION DEVICES AND SUPPLY AND INSTALL NEW HORN/STROBE DEVICES IN EXISTING LOCATIONS. ALL NEW HORN/STROBE DEVICES SHALL MATCH EXISTING VISUAL AND AUDIO PATTERNS.
- 7) CONTRACTOR TO SUPPLY AND INSTALL NEW ADDRESSABLE DUCT SMOKE DETECTORS AT LOCATIONS SHOWN FOR INITIATING THE COMBINATION FIRE/SMOKE DAMPERS. COORDINATE EXACT LOCATION AND REQUIREMENTS WITH MECHANICAL TRADE. DUCT SMOKE DETECTORS SHALL BE INSTALLED WITHIN 1.5m HORIZONTALLY OF THE DUCT IN THE FIRE SEPARATION DOWNSTREAM OF THE COMBINATION FIRE AND SMOKE DAMPER. SUPPLY AND INSTALL 120V,15A,1P DIRECT CONNECTIONS AT EACH FIRE & SMOKE DAMPER LOCATION AS SHOWN.
- 8) CONTRACTOR SHALL SUPPLY AND INSTALL NEW ADDRESSABLE MODULES AT EACH COMBINATION FIRE AND SMOKE DAMPER LOCATION. CONFIRM EXACT QUANTITIES AND LOCATIONS WITH MECHANICAL TRADE. MODULES SHALL BE EQUIPPED WITH A TROUBLE AND OUTPUT RELAY FOR MONITORING AND INITIATING THE SMOKE DAMPERS. PROGRAM FIRE RELAY MODULE TO CLOSE THE SMOKE DAMPER UPON SIGNAL FROM THE ASSOCIATED SMOKE DETECTORS.
- 9) SUPPLY AND INSTALL ACCESS DOORS AS REQUIRED FOR DAMPER/MODULE INSPECTION AND TESTING. COORDINATE WITH ARCHITECTURAL TRADE.
- 10) CONTRACTOR SHALL SUPPLY AND INSTALL AN ALARM CONTACT AND WIRING FROM THE FACP TO EACH ROOFTOP HVAC UNIT FOR AUTOMATIC SHUTDOWN UPON ACTIVATION OF ANY ASSOCIATED SMOKE DETECTORS. CONFIRM EXACT REQUIREMENTS WITH MECHANICAL TRADE.
- 11) CONTRACTOR TO SUPPLY AND INSTALL A SET OF DRY CONTACTS WITHIN FACP FOR BAS NOTIFICATION. CONFIRM EXACT REQUIREMENTS WITH BAS SYSTEM SUPPLIER.
- 12) CONTRACTOR TO SUPPLY AND INSTALL WIRING, DEVICES AND ACCESSORIES TO PROVIDE MONITORING OF COMBINATION FIRE AND SMOKE DAMPER ACTUATOR POWER SUPPLY CIRCUITS LP-2#1,3,5 WHICH SHALL PROVIDE A TROUBLE SIGNAL UPON
- 13) CONTRACTOR SHALL MAINTAIN EXISTING CALL SIGNAL TO FIRE ALARM DEPARTMENT AND INTEGRATE WITH NEW PANEL.
- 14) RETAIN THE SERVICES OF TROY LIFE & SAFETY LTD. (CONTACT CALEB JOHNSON 519-807-4489, CALEB.JOHNSON@TROYLFS.COM) TO TEST, VERIFY AND COMMISSION THE NEW FIRE ALARM PANEL, DEVICES, SIGNALING AND CONTROLS. PROGRAMMING AND COMMISSIONING OF FACP SHALL BE INCLUDED AS PART OF THIS CONTRACT.
- 15) RFTAIN THE SERVICES OF A WRDSB APPROVED QUALIFIED LIFE SAFFTY TESTING AGENCY TO COMPLETE CAN/ULC \$1001

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Project Name

WRDSB - WORKSHOP ARCHITECTURE **HVAC UPGRADES & INTERIOR RENOVATIONS** 

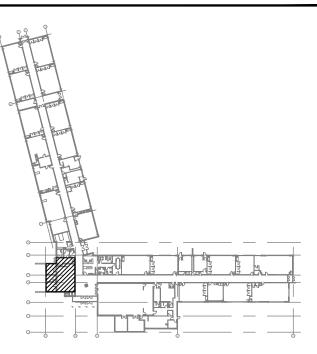SMITHSON PUBLIC SCHOOL

150 BELLVIEW AVENUE, KITCHENER

Sheet Title


## ELECTRICAL AND BOILER ROOM LAYOUTS

Drawn By DB Scale As Shown Designed By DB Date November 26, 2020

Sheet Number


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**E9** 



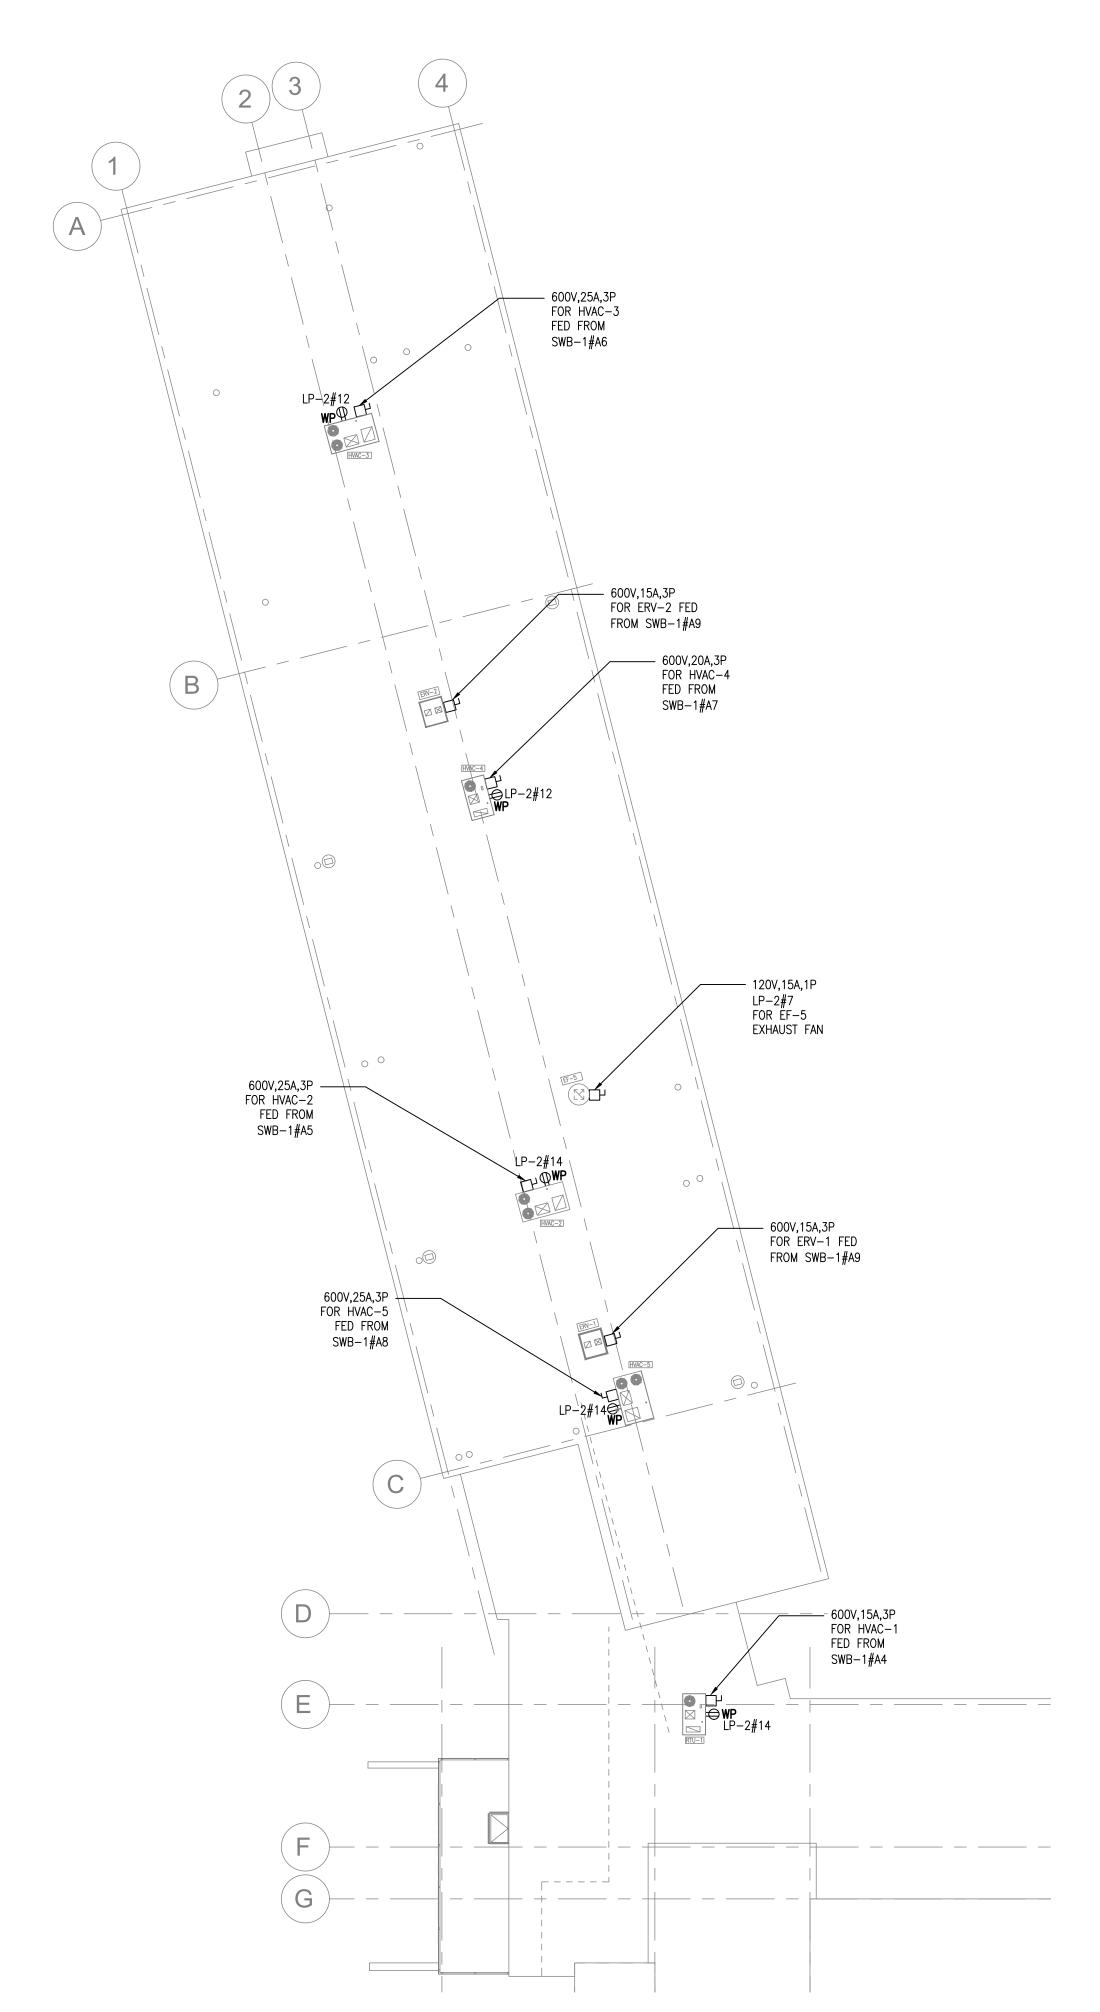

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Project Name WRDSB - WORKSHOP ARCHITECTURE

HVAC UPGRADES & INTERIOR RENOVATIONS SMITHSON PUBLIC SCHOOL

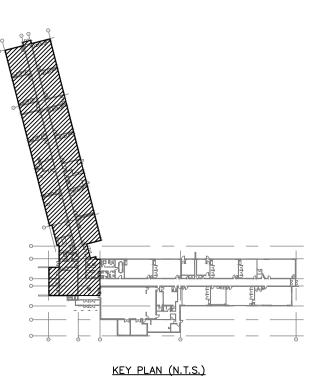150 BELLVIEW AVENUE, KITCHENER Sheet Title


## PROPOSED ROOFTOP POWER PLAN

Drawn By DB Scale As Shown Designed By DB Date November 26, 2020 Project Number **B20-349.02A** 

Sheet Number

Revision

E10

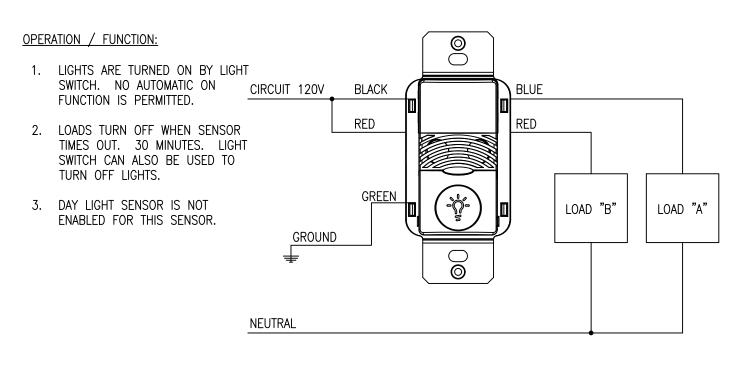

# 1 WALL SWITCH OCCUPANCY SENSOR DETAIL E11 SCALE: N.T.S.

LINE {

## AUTOMATIC MODE OPERATION:

- . WHEN SENSOR ACTIVATES LOAD TURNS ON.
- 2. LOAD TURNS OFF WHEN SENSOR TIMES OUT.

### OPERATION / FUNCTION:

- 1. LIGHTS ARE TURNED ON BY LIGHT SWITCH. NO AUTOMATIC ON FUNCTION IS PERMITTED.
- 2. LOADS TURN OFF WHEN SENSOR TIMES OUT. 30 MINUTES. LIGHT SWITCH CAN ALSO BE USED TO TURN OFF LIGHTS.
- 3. WHERE DIMMER SWITCH IS REQUIRED, PLEASE CONNECT AS PER MANUFACTURER'S INSTRUCTIONS.
- 4. DAY LIGHT SENSOR IS NOT ENABLED FOR THIS SENSOR.





END VIEW

**FLOOR BOX DETAIL** 



POWER CONDUIT

**E11** SCALE: N.T.S.

& WIRING



CIRCUIT

DIMMING

POWER/RELAY

LOW VOLTAGE

SWITCH

E11 / SCALE: N.T.S.

DIMMER/CONTROL





FIXTURE


----- LINE VOLTAGE WIRING

- — — CONTROL CABLING

OCCUPANCY SENSOR WITH DIMMING DETAIL


---- 0-10V DIMMING WIRING

7 EXISTING PHONE BACKBOARD
E11 SCALE: N.T.S.

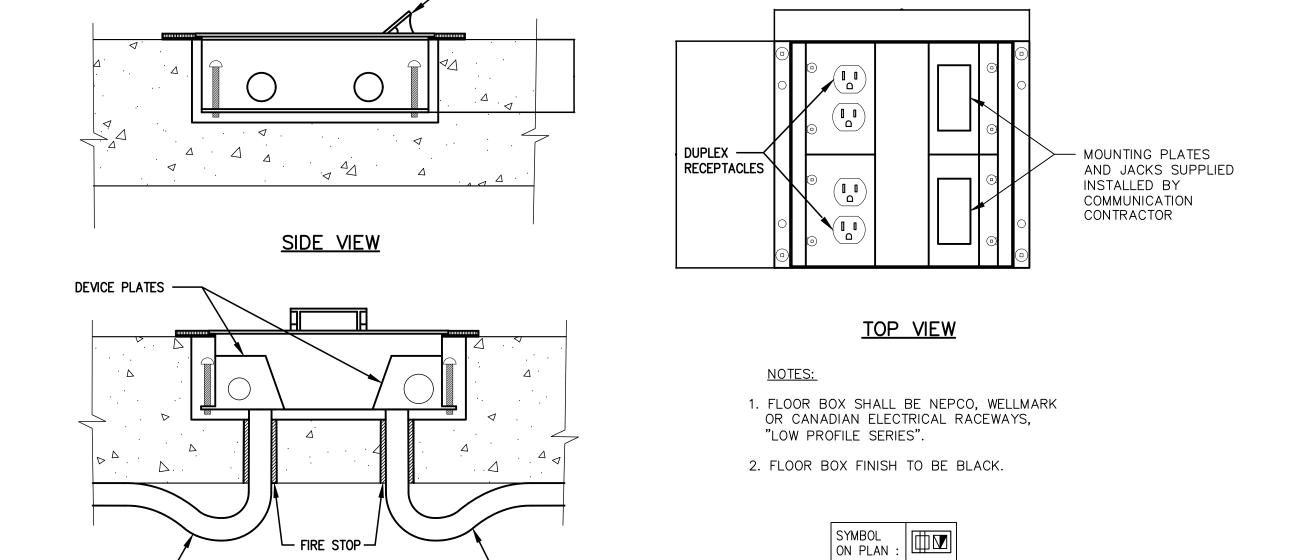

- 1"(25mm) COMUNICATION


CONDUIT UNLESS OTHERWISE

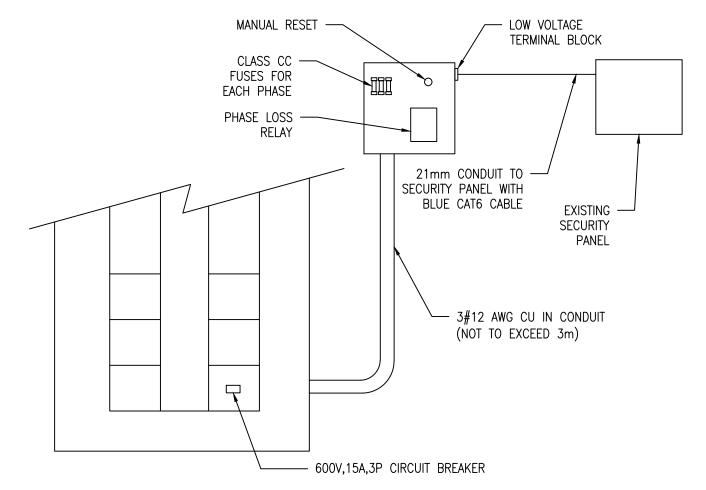


### PHASE LOSS RELAY REQUIREMENTS:

- 1. SUPPLY AND INSTALL 250mm x 250mm x 150mm BOX, PHASE LOSS RELAY (EATON D65VMLS600 OR EQUIVALENT) AND ACCESSORIES AS SHOWN. LABEL ON COVER STATING: "PHASE LOSE RELAY. CONTACT MONITORING COMPANY BEFORE DE—ENERGIZING".
- 2. MOUNT RELAY ON DIN RAIL AND SUPPLY AND INSTALL CLASS CC FUSING WITHIN BOX. SUPPLY AND INSTALL 2-#18 AWG WIRES FROM OUTPUT CONTACT TO LOW VOLTAGE TERMINAL STRIP ON EXTERIOR OF BOX. WHEN PHASE IS LOST, THE CONTACT SHALL OPEN. SUPPLY AND INSTALL 21mm CONDUIT FROM LOW VOLTAGE TERMINAL BLOCK TO SECURITY PANEL COMPLETE WITH BLUE CAT6 CMP CABLE. FINAL TERMINATIONS BY SECURITY SUBCONTRACTOR
- 3. SUPPLY AND INSTALL NORMALLY CLOSED PUSHBUTTON ON FRONT OF BOX TO MANUALLY RESET THE RELAY. PUSHBUTTON SHALL BE FLUSH WITH THE BOX AND SHALL BE LABELED "MANUAL RESET".
- 4. ADJUST UNDERVOLTAGE TO MINIMUM, UNBALANCE TO MAXIMUM AND TRIP DELAY TO MAXIMUM TO AVOID NUISANCE TRIPPING.



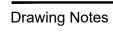

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Project Name

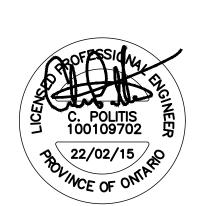WRDSB - WORKSHOP
ARCHITECTURE
HVAC UPGRADES & INTERIOR RENOVATIONS
SMITHSON PUBLIC SCHOOL

150 BELLVIEW AVENUE, KITCHENER

Sheet Title

**ELECTRICAL DETAILS** 

Drawn By DB Scale As Shown

Designed By DB Date November 26, 2020


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Project Number **B20-349.02A**Sheet Number Revision


E11


TOPCAT AUDIO AND TV REQUIREMENTS:

- 1. TOPCAT AUDIO SYSTEM SHALL BE SUPPLIED AND INSTALLED BY CONTRACTOR. SUPPLY AND INSTALL OF TV IS NOT PART OF ELECTRICAL CONTRACTOR SCOPE OF WORK.
- 2. ALL LOCATIONS FOR TV AND AV EQUIPMENT AND OUTLETS WITHIN CLASSROOMS IS APPROXIMATE. CONTRACTOR TO VERIFY AND RECOMMEND EXACT LOCATIONS BASED ON SITE CONDITIONS AND SUBMIT TO CONSULTANT FOR REVIEW AND APPROVAL.




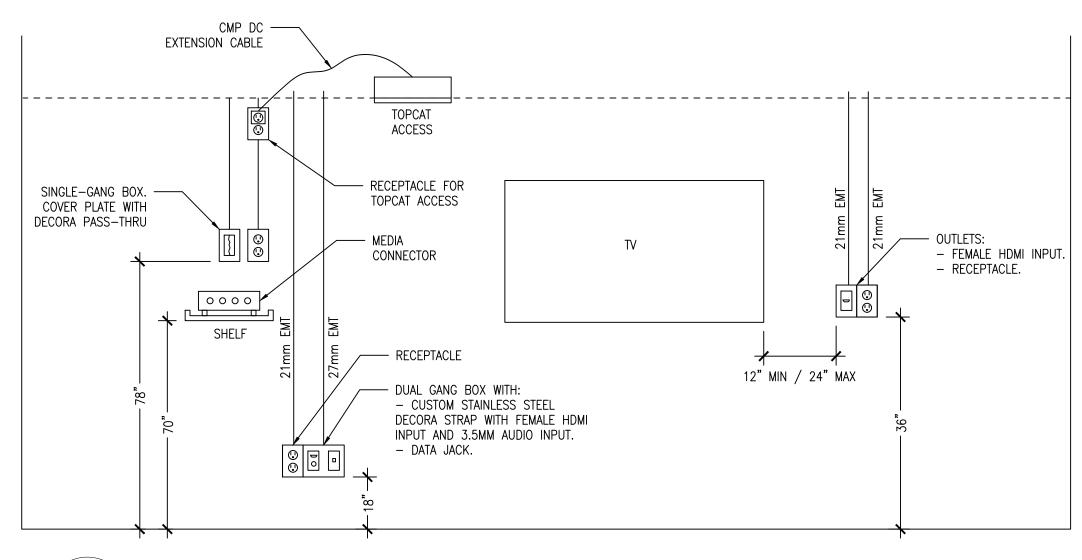

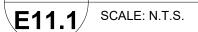

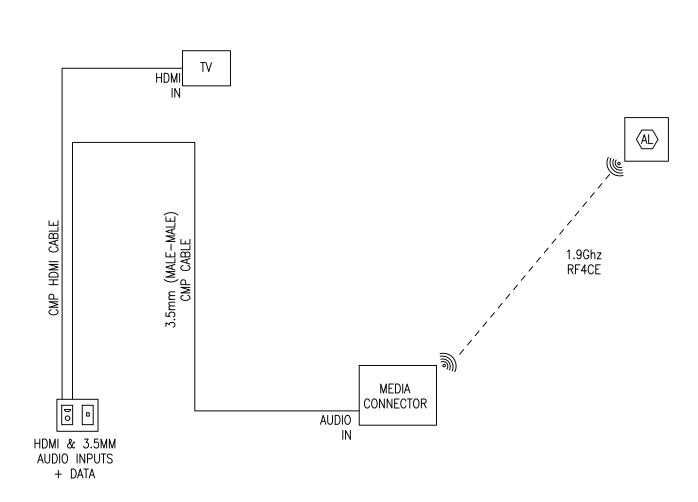

**TOPCAT CABLING SCHEMATIC E11.1** SCALE: N.T.S.

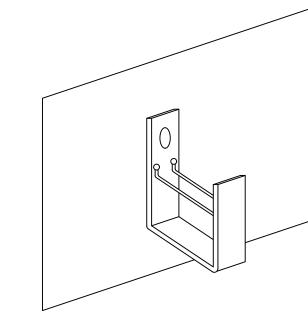

- 1. INCLUDE CABLE RETAINERS WITH HANGER.
- 2. HANGERS SHALL BE WALL MOUNTED WHERE POSSIBLE. WHEN NOT POSSIBLE, UNITS SHALL BE SUSPENDED FROM STRUCTURE WITH THREADED ROD.
- 3. CORRIDOR MOUNTED HANGERS SHALL BE IN-LINE. MAXIMUM SPACING TO
- 4. COORDINATE INSTALLATION OF HANGERS WITH MECHANICAL TRADE TO AVOID CONFLICTS.
- 5. INSTALLATION OF POWER CABLES WITHIN HANGERS IS NOT PERMITTED.
- 6. J-HOOKS TO BE EATON BCH64 OR APPROVED EQUIVALENT.



## J-HOOK INSTALLATION DETAIL

**E11.1** SCALE: N.T.S.

## **SYSTEM DESCRIPTION**

- 1. Lightspeed TopCat Access is an all-in-one, ceiling-mount classroom audio system. A typical assistive listening system will include speakers, an integrated amplifier and a wireless audio receiver/transmitter.
- 2. The TopCat assistive listening system shall include the following features and components:
  - a. A two-way hybrid speaker system with an exciter technology sound panel and low frequency cone driver.
  - b. Cross over technology to deliver high speech intelligibility and full range sound with
  - even distribution throughout the classroom.
  - c. Pendant-style microphones for whole classroom instruction, team-teaching or student
  - d. Wireless Media Connector to integrate with and wirelessly transmit all classroom multimedia to be played.
  - e. Devices communicate using wireless Access Technology (1.9Ghz + RF4CE).
  - f. Suitable for use in return air plenums.

## **PRODUCTS**

- 1. Typical Classrooms
- a. Assistive listening equipment manufactured by Lightspeed for a typical classroom (approximately 75 m<sup>2</sup>) shall consist of the following:
- i One (1) Model No. TCA
  - Topcat ceiling-mounted wireless audio base station
  - Plug-in power adapter
- 50' plenum rated DC power cable kit
- Hybrid speaker system consisting of exciter sound panel plus low frequency
  - Panel Size: 13.75" x 6.75"
  - Cone Driver Size: 5.25"
- Impedance: 8 Ω
- Power Handling: 25W
- (1) Tone control inside cabinet
- Audio Input: (1) 3.5mm inside cabinet • Dimensions (W x D x H): 610 x 305 x 94mm
- ii Two (2) Model No. FM
- Flexmike pendant-style wireless microphone
- AA NiMH rechargeable battery pack
- Lavaliere cord
- Audio distortion: <1%</li>
- Integrated microphone type: uni-directional electret Audio input: (1) 3.5mm
- Earbud output: (1) 3.5mm
- Push button volume control: +/- 6dB (total range = 12 dB)
- Power: on/off/mute button
- Battery run time: 8 hours
- Dimensions (L x W x H): 74 x 28 x 25mm
- iii One (1) Model No. FMCC Cradle charger for two Flexmikes
- Plug-in power adapter
- iv One (1) Model No. Media connector
- Wireless audio transmitter/receiver to integrate with classroom audio sources and send/receive the wireless signal to the Topcat system in the ceiling
- Plug-in power adapter • Audio Inputs: (4) 3.5mm stereo jacks connect to classroom audio sources
- Audio Outputs: (2) 3.5mm jack with volume control
- (1) Audio input volume control
- (1) Audio output volume control
- (1) Power button with LED
- (1) Tone control
- Dimensions (W x D x H): 193 x 104 x 28mm
- v One (1) wall-mounted, single shelf.
- Glass shelf.
- Black colour.



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9.	ISSUED FOR TENDER	22 FEB 15	СР
8.	ISSUED FOR PERMIT	22 FEB 03	СР
7.	ISSUED FOR 90% REVIEW	22 JAN 21	DB
6.	ISSUED FOR 90% REVIEW	21 DEC 03	DB
5.	ISSUED PERMIT / TENDER	21 MAY 11	СР
No.	Revision	Date	Ву



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engineering www.boldengineering.ca

Project Name

WRDSB - WORKSHOP ARCHITECTURE **HVAC UPGRADES & INTERIOR RENOVATIONS** 

SMITHSON PUBLIC SCHOOL 150 BELLVIEW AVENUE, KITCHENER

Sheet Title

ELECTRICAL DETAILS

Drawn By DB Scale As Shown Designed By DB Date November 26, 2020

Sheet Number

Revision

E11.1